

Steel Building Systems, Inc.

22618 County Road 40 Obrien, FL 32071 (000) 111-2222 (333) 444-5555 (fax)

BUILDING LOADS /	DESCRIPTION:				
WIDTH: 61.33 LE		— HEIGHT: <u>18.54 / 18.54</u> TO PLANS)	SITE CLASS:		
•		<u> </u>	OCCUPANCY	CATEGORY:	II - Normal
THIS STRUCTURE IS DES AND APPLIED AS REQUIR			SEISMIC DES	IGN CATEGORY:	_В
THE CONTRACTOR IS TO WITH THE REQUIREMENTS	· · · · · · · · · · · · · · · · · ·				
ROOF DEAD LOAD:		OF PANELS & PURLINS)			
COLLATERAL LOAD:	_5.0 PSF	SNOW EXPOSURE:	1.0000		
ROOF LIVE LOAD:	_20.0_ PSF	WIND EXPOSURE:			
ROOF SNOW LOAD:		INTERNAL PRESSURE COE	FF.:		
GROUND SNOW LOAD:			-0.18		
BASIC WIND SPEED:	118 MPH	SPECTRAL RESPONSE COL	EFF.	MAPPED SPE	CTRAL RESPONSE ACC
SEISMIC ZONE:	_B	Sds	0.10	Ss	0.09
THERMAL FACTOR:	1.20	Sd1		St	0.05
IMPORTANCE FACTORS:		DESIGN BASE SHEAR, V:			
WIND LOAD	1.00	EXPANDED FORMULA	0.667*le	*Fa*Ss*W/R	
SNOW LOAD	1.00	LONGITUDINAL	3.51		
SEISMIC LOAD	1.00	TRANSVERSE	3.64		
GENERAL NOTES: 1) MATERIALS :	MINIMUM	YIELD: YIELD: YIELD:	······································	em has been electror and sealed by K	

HOT ROLLED BAR 50.0000 ksi MIN. No. 83601 STRUCTURAL STEEL SHEET 50.0000 ksi MINE. STRUCTURAL STEEL PLATE 50.0000 ksi MIN.⁻ COLD FORMED SHAPES 57.0000 ksi MIN. Fy = 60.0000 ksi MINWALL SHEETING **ROOF SHEETING** 60.0000 ksi MIN. Á307 & A325 THE METAL BUILDING MANUFACTURER RESERVES THE RIGHT TO SUBSTITUTE THE ABOVE MATERIALS WITH EQUAL OR BETTER MATERIAL

* McDonough using a Digital Kyle McDonough
Signature and date. Printed copies of this document are not and the signature must be verified on any electronic copies.

18:26:28 -05'00'

- 2) BOLT TIGHTENING REQUIREMENTS: ALL HIGH STRENGTH BOLTS ARE A325 UNLESS NOTED OTHERWISE. HIGH STRENGTH BOLTS SHALL BE TIGHTENED BY THE TURN OF THE NUT METHOD IN ACCORDANCE WITH THE LATEST EDITION AISC "SPECIFICATION FOR STRUCTURAL JOINTS USING ASTM A325 OR A490 BOLTS". A325 BOLTS SHALL BE INSTALLED WITH OUT WASHERS WHEN TIGHTENED BY THE "TURN OF THE NUT" METHOD. ALL BOLTED CONNECTIONS, FOR SHEAR/BEARING CONNECTION TYPE WITH BOLT THREADS EXCLUDED FROM THE SHEAR PLANE SHALL BE SNUG TIGHT ONLY.
- 3) ALL STRUCTUAL STEEL TO RECEIVE A RUST INHIBITIVE PRIMER. THIS PAINT IS NOT INTENDED FOR LONG TERM EXPOSURE TO THE ELEMENTS.

ROOF PANELS:	
COLOR:	White
WALL PANELS:	
COLOR:	Charcoal Gray
TRIM COLORS:	
CABLE:	NEED SIG 200
CORNER:	NEED SIG 200
EAVE:	NEED SIG 200
FRAMED OPENINGS:	NEED SIG 200
LINER PANELS:	
COLOR:	N/A
LINER TRIM:	
COLOR:	N/A



EW RAF WIND: WALL GIRT: 90 180 150 PURL LIVE: **PURL WIND:** WALL PANEL: 60 ROOF PANEL LIVE: 60 ROOF PANEL WIND: 60 RF HORIZONTAL: RF VERTICAL: WIND BENT: ly signed by seis: 50

considered signed and sealed Date: 2024.11.20

<u>IMPORTANT NOTE: FINAL DETAILING, FABRICATION, AND DELIVERY DATE OF THIS PROJECT</u> CANNOT BE COMPLETED UNTIL THE SIGNED APPROVALS ARE RETURNED TO THE METAL BUILDING MANUFACTURER.

2	11/1/24	FOR AB UPDATE / PERMITS
1	10/25/24	FOR APPROVAL / PERMITS
NO.	DATE	ISSUE

Lake City Equipment PROJECT:

JOB NUMBER: 24-404

PANELS:	
	White
ANELS:	
	Charcoal Gray
OLORS:	
	NEED SIG 200
	NEED SIG 200
	NEED SIG 200
OPENINGS:	NEED SIG 200
PANELS:	
	N/A
RIM:	

9TH ED.)

DRAWINGS.

APPROVAL NOTES

THE FOLLOWING CONDITIONS APPLY IN THE EVENT THAT THESE DRAWINGS ARE USED AS APPROVAL DRAWINGS: IT IS IMPERATIVE THAT ANY CHANGES TO THESE DRAWINGS BE MADE IN CONTRASTING INK (PREFERABLY RED INK), HAVE ALL INSTANCES OF CHANGE CLEARLY INDICATED, AND BE LEGIBLE AND UNAMBIGUOUS. A SIGNATURE AND DATE IS REQUIRED ON ALL PAGES. MANUFACTURER RESERVES THE RIGHT TO RE—SUBMIT DRAWINGS WITH EXTENSIVE OR COMPLEX CHANGES REQUIRED TO AVOID MISFABRICATION. THIS MAY IMPACT THE DELIVERY SCHEDULE. APPROVAL OF THESE DRAWINGS INDICATES CONCLUSIVELY THAT THE METAL BUILDING SYSTEM MANUFAACTURER HAS CORRECTLY INTERPRETED THE CONTRACT REQUIREMENTS, AND FURTHER CONSTITUTES AGREEMENT THAT THE BUILDING AS DRAWN WITH INDICATED CHANGES REPRESENTS THE TOTAL OF THE MATERIALS TO BE SUPPLIED BY MANUFACTURER. ANY CHANGES NOTED ON THHE DRAWINGS NOT IN COMFORMANCE WITH THE TERMS AND REQUIREMENTS OF THE CONTRACT BETWEEN MANUFACTURER AND ITS CUSTOMER ARE NOT BINDING ON MANUFACTURER UNLESS SUBSEQUENTLY SPECIFICALLY ACKNOWLEDGED AND AGREED TO IN WRITING BY CHANGE ORDER OR SEPARATE DOCUMENTATION. MANUFACTURER RECONGNIZES THAT RUBBER STAMPS ARE ROUTINELY USED FOR INDICATING APPROVAL, DISAPPROVAL, REJECTION, OR MERE REVIEW OF THE DRAWINGS SUBMITTED. HOWEVER, MANUFACTURER DOES NOT ACCEPT CHANGES OR ADDITIONS TO CONTRACTURAL TERMS AND CONDITIONS THAT MAY APPEAR WITH USE OF A STAMP OR SIMILIAR INDICATIOIN OF APPROVAL, DISAPPROVAL, ETC. SUCH LANGUAGE APPLIED TO MANUFACTURER'S DRAWINGS BY THE CUSTOMER, ARCHITECT, ENGINEER, OR ANY OTHER PARTY WILL BE CONSIDERED AS UNACCEPTABLE ALTERNATIONS TO THESE DRAWING NOTES, AND WILL NOT ALTER THE CONTRACTUAL RIGHTS AND OBLIGATIONS EXISTING BETWEEN MANUFACTURER AND ITS CUSTOMER

BUILDER / CONTRACTOR RESPONSIBILITIES

IT IS THE RESPONSIBILITY OF THE BUILDER/CONTRACTOR TO INSURE THAT ALL PROJECT

PLANS AND SPECIFICATIONS COMPLY WITH THE APPLICABLE REQUIREMENTS OF ANY GOVERNING BUILDING AUTHORITIES. THE SUPPLYING OF SEALED ENGINEERING DATA AND DRAWINGS FOR THE METAL BUILDING SYSTEM DOES NOT IMPLY OR CONSTITUTE AN AGREEMENT THAT THE METAL BUILDING SYSTEM MANUFACTURER OR ITS DESIGN ENGINEER IS ACTING AS THE ENGINEER OF RECORD OR DESIGN PROFESSIONAL FOR A CONSTRUCTION THE CONTRACTOR MUST SECURE ALL REQUIRED APPROVALS AND PERMITS FROM THE

APPROPRIATE AGENCY AS REQUIRED. APPROVAL OF THE METAL BUILDING SYSTEM MANUFACTURER'S DRAWINGS AND CALCULATIONS INDICATE THAT THE METAL BUILDING SYSTEM MANUFACTURER CORRECTLY INTERPRETED AND APPLIED THE REQUIREMENTS OF THE

CONTRACT DRAWINGS AND SPECIFICATIONS. (SECT. 4.2.1 AISC CODE OF STANDARD PRACTICES, 9TH ED.) WHERE DISCREPANCIES EXIST BETWEEN THE METAL BUILDING SYSTEM MANUFACTURER'S STRUCTURAL STEEL PLANS AND THE PLANS FOR OTHER TRADES, THE STRUCTURAL STEEL PLANS SHALL GOVERN. (SECT. 3.3 AISC CODE OF STANDARD PRACTICE

THE CONTRACTORS AND ENGINEERS OTHER THAN THE METAL BUILDING SYSTEM

ALL BRACING AS SHOWN AND PROVIDED BY THE METAL BUILDING SYSTEM MANUFACTURER FOR THIS BUILDING IS REQUIRED AND SHALL BE INSTALLED BY THE

MANUFACTURER'S ENGINEER UNLESS SPECIFICALLY INDICATED

ERECTOR AS A PERMANENT PART OF THE STRUCTURE.

7.9.1 AISC CODE OF STANDARD PRACTICE, 9TH ED.)

GALVALUME SHOULD BE AVOIDED.

DESIGN CONSIDERATIONS OF ANY MATERIALS IN THE STRUCTURE WHICH ARE NOT

FURNISHED BY THE METAL BUILDING SYSTEM MANUFACTURER ARE THE RESPONSIBILITY OF


THE CONTRACTOR IS RESPONSIBILE FOR ALL ERECTION OF STEEL AND ASSOCIATED WORK IN COMPLIANCE WITH THE METAL BUILDING SYSTEM MANUFACTURER "FOR CONSTRUCTION"


TEMPORARY SUPPORTS, SUCH AS TEMPORARY GUYS, BRACES, FALSE WORK, CRIBBING OR OTHER ELEMENTS REQUIRED FOR THE ERECTION OPERATION WILL BE DETERMINED AND FURNISHED AND INSTALLED BY THE ERECTOR. THESE TEMPORARY SUPPORTS WILL SECURE THE STEEL FRAMING, OR ANY PARTLY ASSEMBLIED STEEL FRAMING, AGAINST LOADS COMPARABLE IN INTENSITY TO THOSE FOR WHICH THE STRUCTURE WAS DESIGNED, RESULTING FROM WIND, SEISMIC FORCES AND ERECTION OPERATIONS, BUT NOT THE LOADS RESULTING FROM THE PERFORMANCE OF WORK BY OR THE ACTS OF OTHERS, NOR SUCH UNPREDICTABLE LOADS AS THOSE DUE TO TORNADO, EXPLOSION, OR COLLISION. (SECT.

WARNING: IN NO CASE SHOULD GALVALUME STEEL PANELS BE USED IN CONJUNCTION WITH LEAD OR COPPER. BOTH LEAD AND COPPER HAVE HARMFUL CORROSION EFFECTS ON

THE ALUMINUM ZINC ALLOY COATING WHEN THEY ARE USED IN CONTACT WITH GALVALUME


STEEL PANELS. EVEN RUN-OFF FROM COPPER FLASHING, WIRING, OR TUBING ONTO

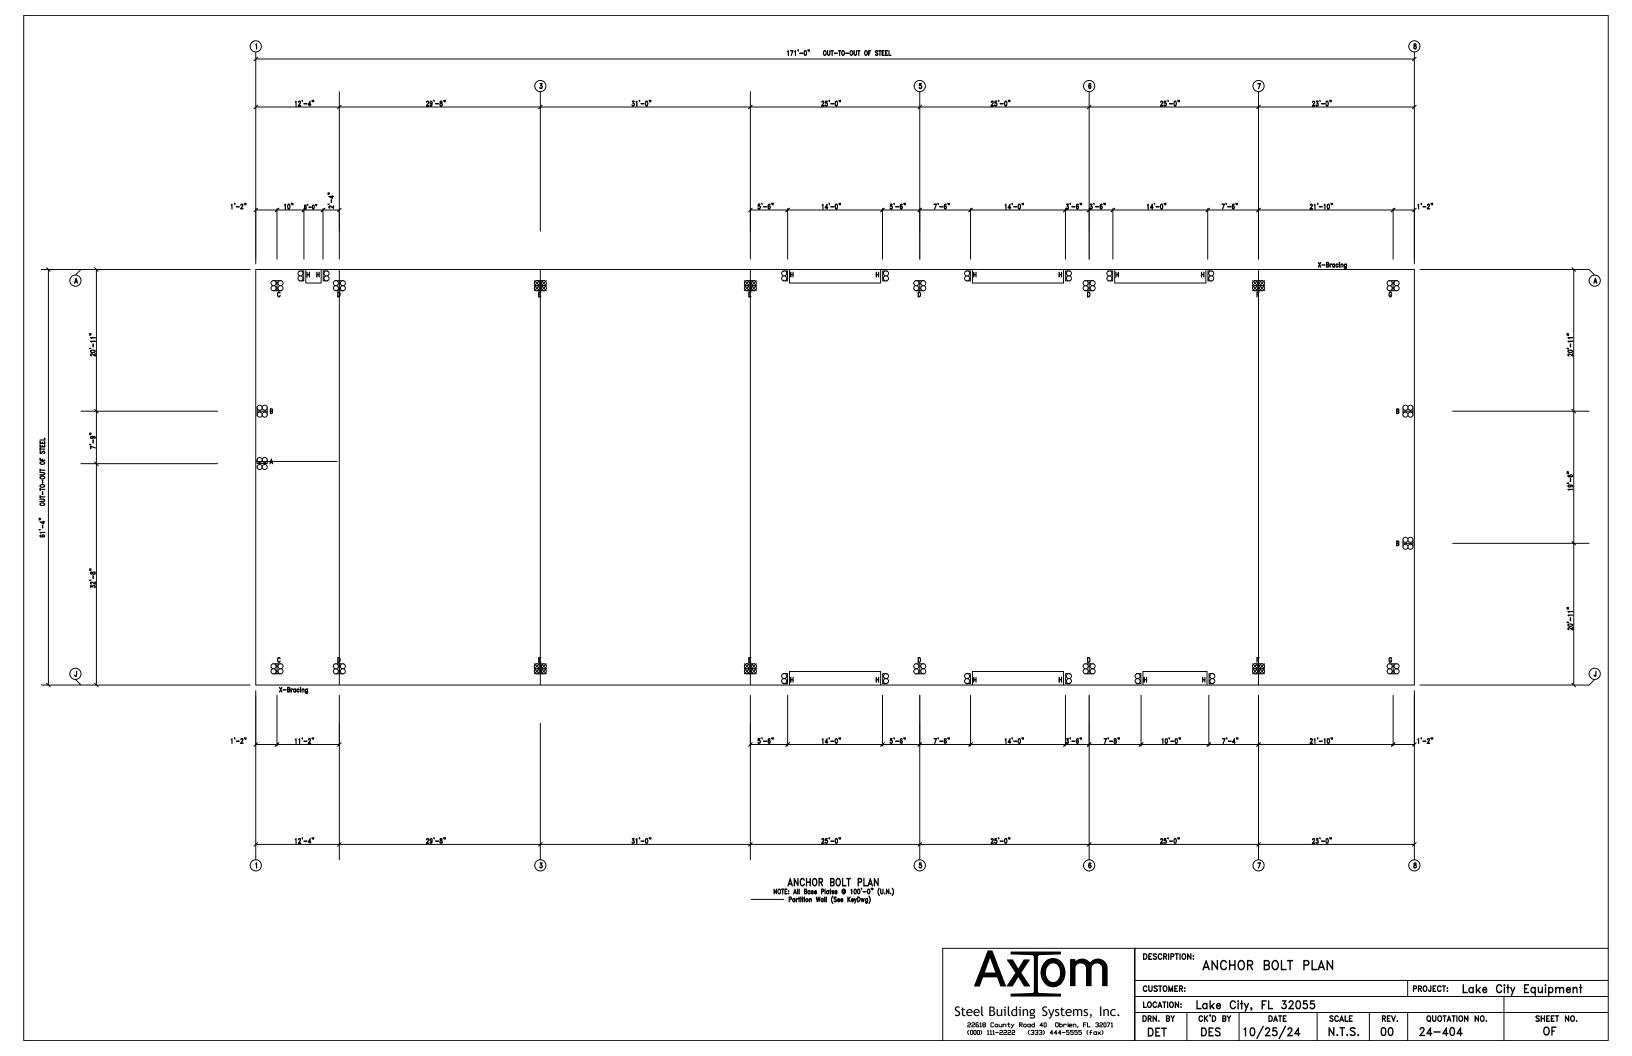


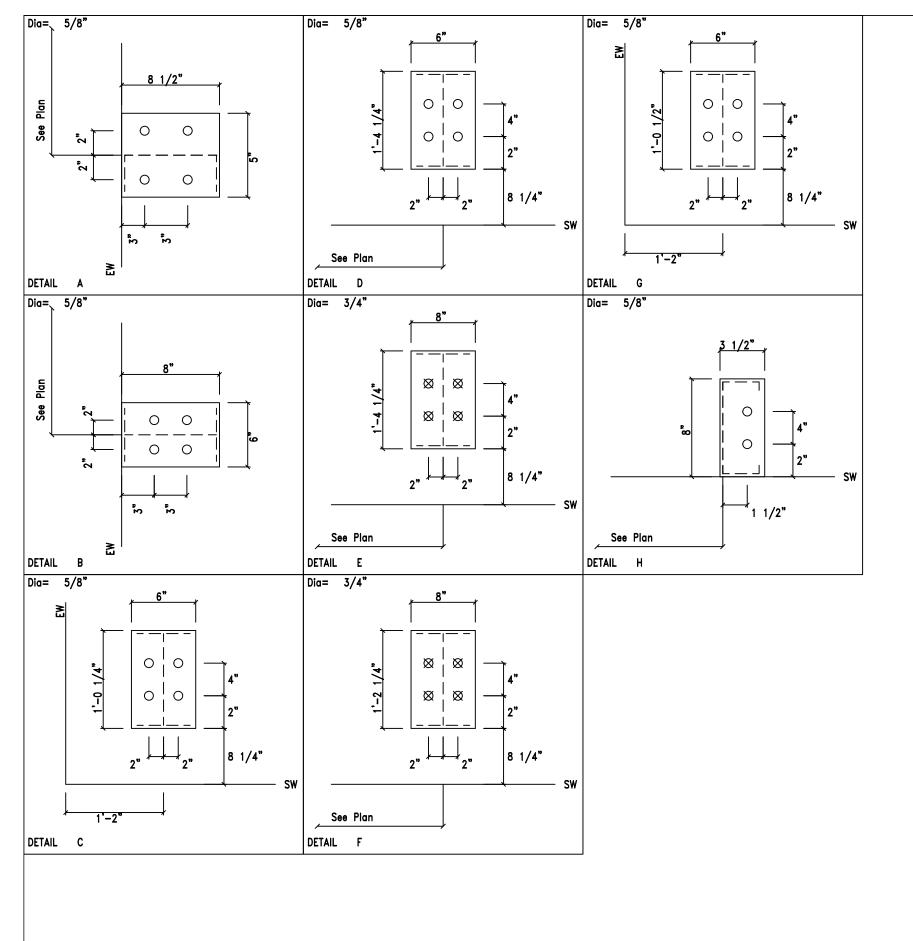




DESCRIPTIO	N: ANCH	OR BOLT DE	TAILS					
CUSTOMER:					PROJECT:	Lake (City Equipment	
LOCATION:	Lake Ci	ity, FL 32055						
DRN. BY	CK'D BY	DATE	SCALE	REV.	QUOTAT	ION NO.	SHEET NO.	
DET	DES	10/25/24	N.T.S.	00	24-40	4	OF	

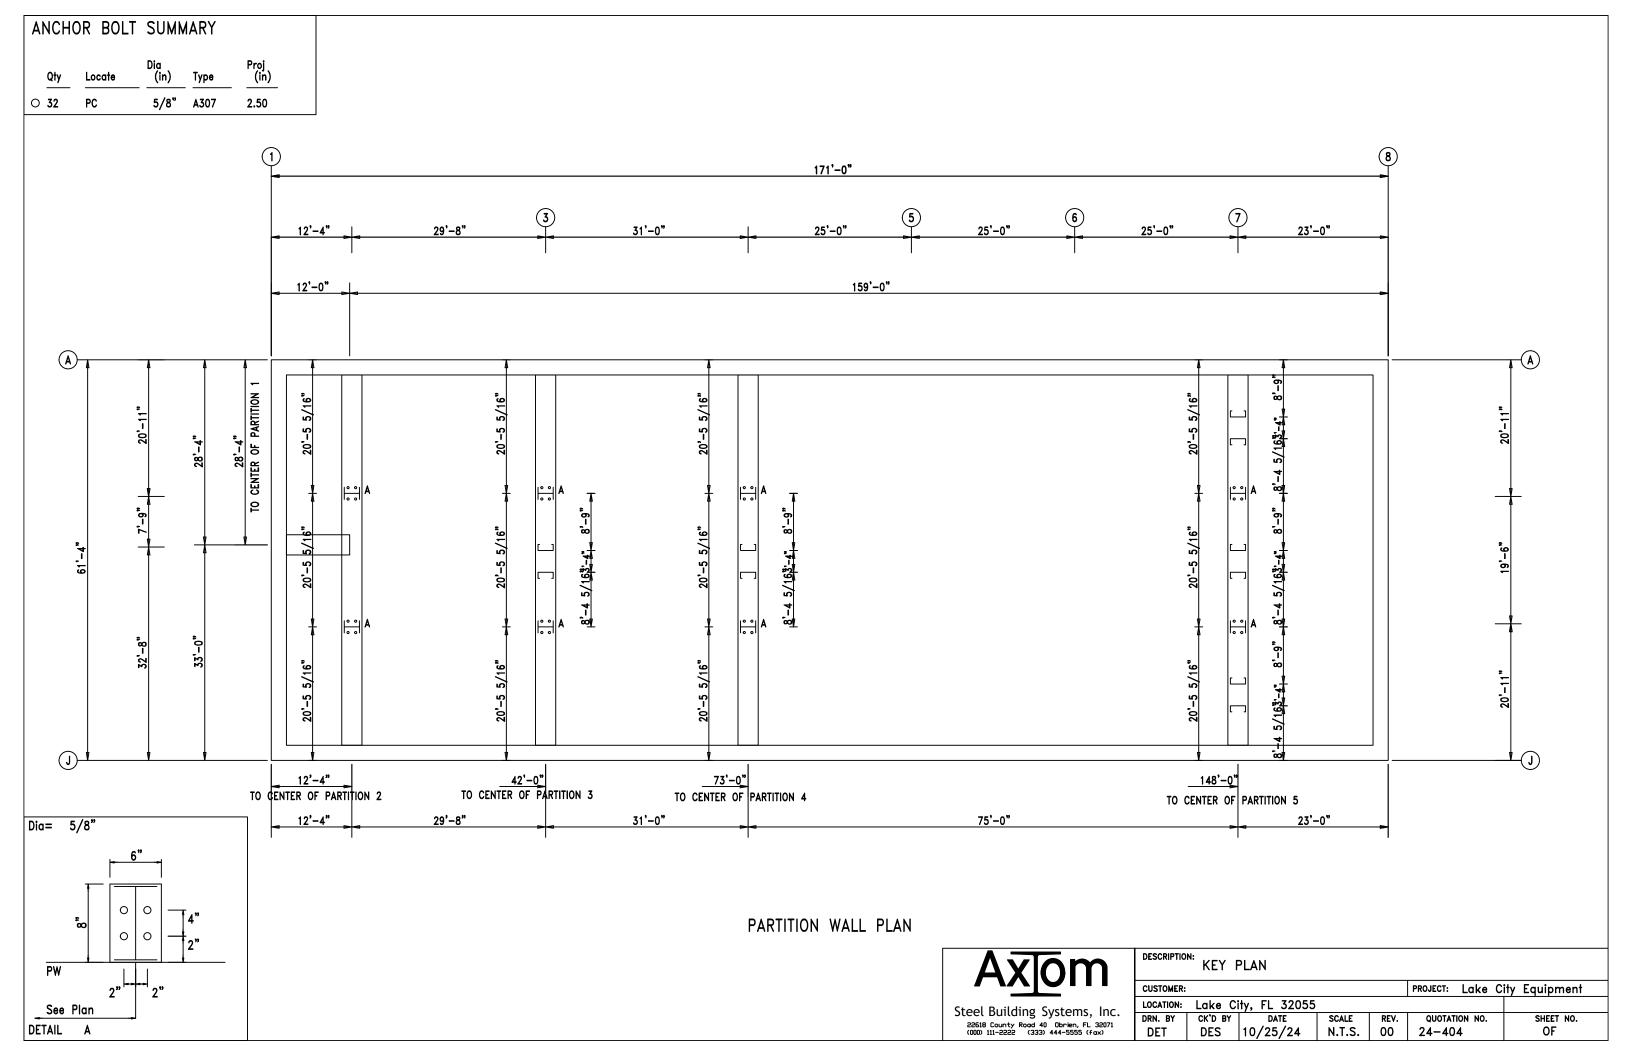

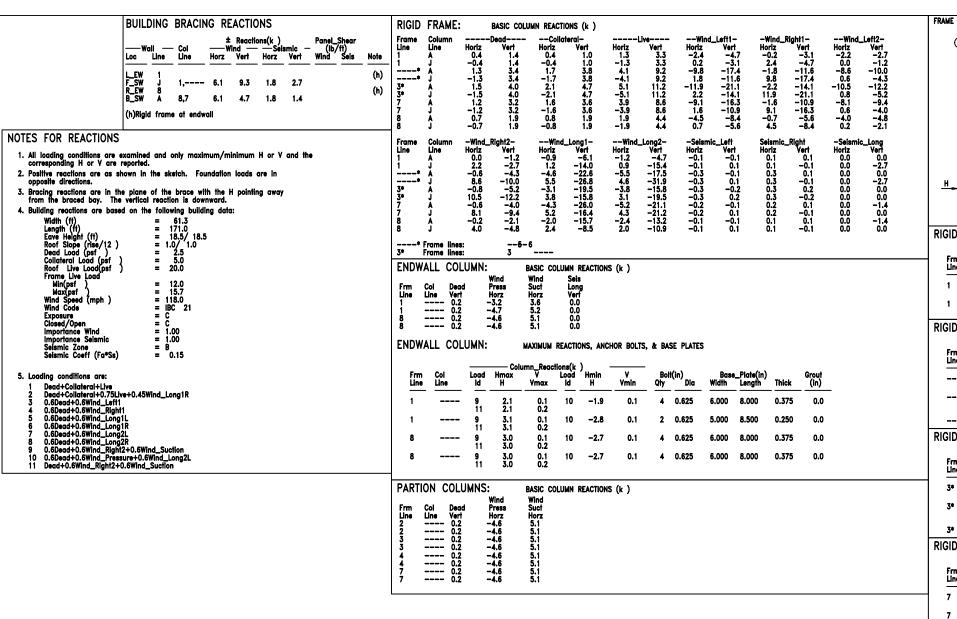

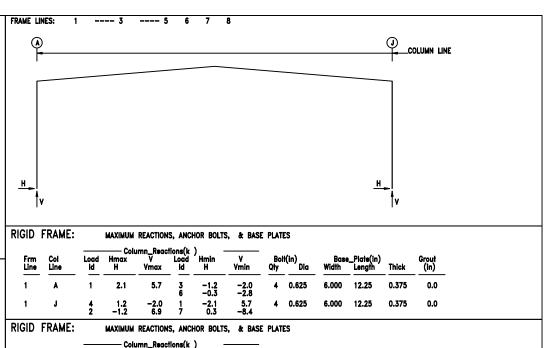

run	COI	LUUU	miliux		Loud	пини		DUI	KIII)	DUST	-Ligia/iii)		Giodi
Line	Line	_ <u>ld</u> _	H	Vmax_	_ <u>ld</u>	H	Vmin	Qty	` Dia	Width	Length	Thick	(in)
	-* A	1	7.1	16.4	3 6	-5.1 -2.0	-8.4 -11.6	4	0.625	6.000	16.25	0.625	0.0
	_* J	4	5.1 -7.1	-8.4 16.4	1 7	-7.1 2.0	16.4 -17.1	4	0.625	6.000	16.25	0.625	0.0
	-* Frame	lines:	5-6										
RIGID	FRAME	:	MAXIMUM	REACTION	IS, ANCI	HOR BOLT	S, & BAS	E PLATI	ES				
Frm Line	Col Line	Load Id	Col Hmax H	umn_Read V Vmax	tions(k Load Id) Hmin H	V Vmin	Bol:	t(in) Dia	Base Width	_Plate(in) Length	Thick	Grout (in)

Line	Line	ld_	. 	Vmax	. <u>Id</u>	_ 	Vmin	Qty	Dia .	Width	Length	_ Thick	(in)	
3*	A	1	8.7	19.9	3	-6.2	-10.2	4	0.750	8.000	16.25	0.500	0.0	
3*	J	1	6.2 -8.7	-10.2 19.9	14	-8.7 6.2	19.9 -10.2	4	0.750	8.000	16.25	0.500	0.0	
3*	Frame li	ines:	3 -											
RIGID	FRAME:		MAXIMUM	REACTIONS	S, ANCI	OR BOLTS	, & BAS	E PLATI	ES					


KIGID	FRAME:		MAXIMUM	REACTION	IS, ANCI	OR BOLT	S, & BASI	E PLATI	ES				
Frm Line	Col Line	Load Id	Hmax H	umn_Read V Vmax	tions(k Load Id) Hmin H	V Vmin	Boli Qiy	l(in) Dia	Base Width	_Plate(in) Length	Thick	Grout (in)
7	A	1	6.7	15.4	3 5	-4.8 -1.9	-7.9 -13.7	4	0.750	8.000	14.25	0.500	0.0
7	J	4	4.8 -6.7	-7.9 15.4	1 8	-6.7 1.9	15.4 -10.8	4	0.750	8.000	14.25	0.500	0.0

RIGID	FRAME:		MAXIMUM	REACTION	S, ANC	HOR BOLT	S, & BAS	E PLATI	ES				
Frm Line	Col Line	Load Id	Hmax H	umn_Reac V Vmax	tions(k Load Id	Hmin H	V Vmin	Bol Qty	l(in) Dia	Base Width	_Plate(in) Length	Thick	Grout (in)
8	A	1	3.3	8.2	3 5	-2.3 -0.8	-3.9 -8.3	4	0.625	6.000	12.50	0.375	0.0
8	J	4	2.3 -3.3	-3.9 8.2	1 8	-3.3 0.8	8.2 -5.4	4	0.625	6.000	12.50	0.375	0.0

ANCH	OK ROLI	SUMMA	AKT		
Qty	Locate	Dia (in)	Туре	Bend Len (in)	Proj (in)
O 28 O 16 O 40 Ø 24	Jamb Endwall Frame Frame	5/8* 5/8* 5/8* 3/4*	A307 A307 A307	3.00 3.00	2.50 2.50 2.50



DESCRIPTION: ANCHOR BOLT REACTIONS										
CUSTOMER:					PROJECT: Lake C	ity Equipment				
LOCATION:	Lake Ci	ity, FL 32055								
DRN. BY	CK'D BY	DATE	SCALE	REV.	QUOTATION NO.	SHEET NO.				
DET	DES	10/25/24	N.T.S.	00	24-404	OF				

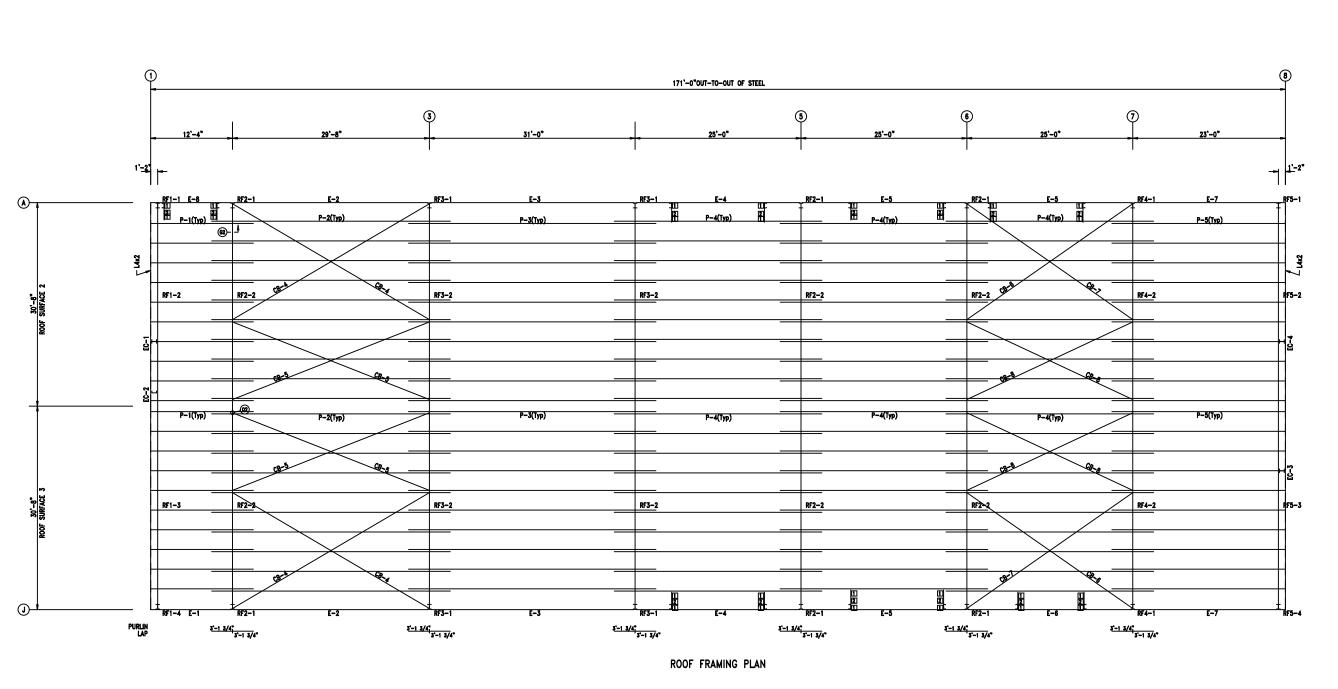


MEMBER 1	TABLE	
ROOF PLA	N	
MARK	PART	LENGTH
P-1	8X25Z16	15'-5 1/2"
P−2	8X25Z16	35'-11 1/2"
P-3	8X25Z16	37'-3 1/2"
P-4	8X25Z16	31'-3 1/2"
P-5	8X25Z16	26'-1 1/2"
E-1	E085341L	12'-3 1/2"
	E085341L	12 -3 1/2 29'-7 1/2"
E-2		
E-3	E085321L	30'-11 1/2"
E-4	E085341L	24'-11 1/2"
E-5	E085341L	24'-11 1/2"
E-6	E085341L	24'-11 1/2"
E-7	E085341L	22'-11 1/2"
E-8	E085341L	12'-3 1/2"
CB-4	HW373	34'-0.3/4"
CB-5	HW373	32 ' -1 "
CB-6	HW373	29'-4 1/4"
CB-7	HW373	30'-0 1 ′ 4"
CB-8	HW373	27'-9"
	•	


CONNECTION PLATES
ROOF PLAN
DID MARK/PART
1 d1
2 JPB


Axiom


Steel Building Systems, Inc.
22518 County Road 40 Obrien, FL 32071
(000) 111-2222 (333) 444-5555 (fax)


	DESCRIPTIO	N: ROOF	FRAMING				
	CUSTOMER:					PROJECT: Lake C	ity Equipment
LOCATION: Lake City, FL 32055							
	DRN. BY	CK'D BY	DATE	SCALE	REV.	QUOTATION NO.	SHEET NO.
	DET	DES	10/25/24	N.T.S.	00	24-404	OF

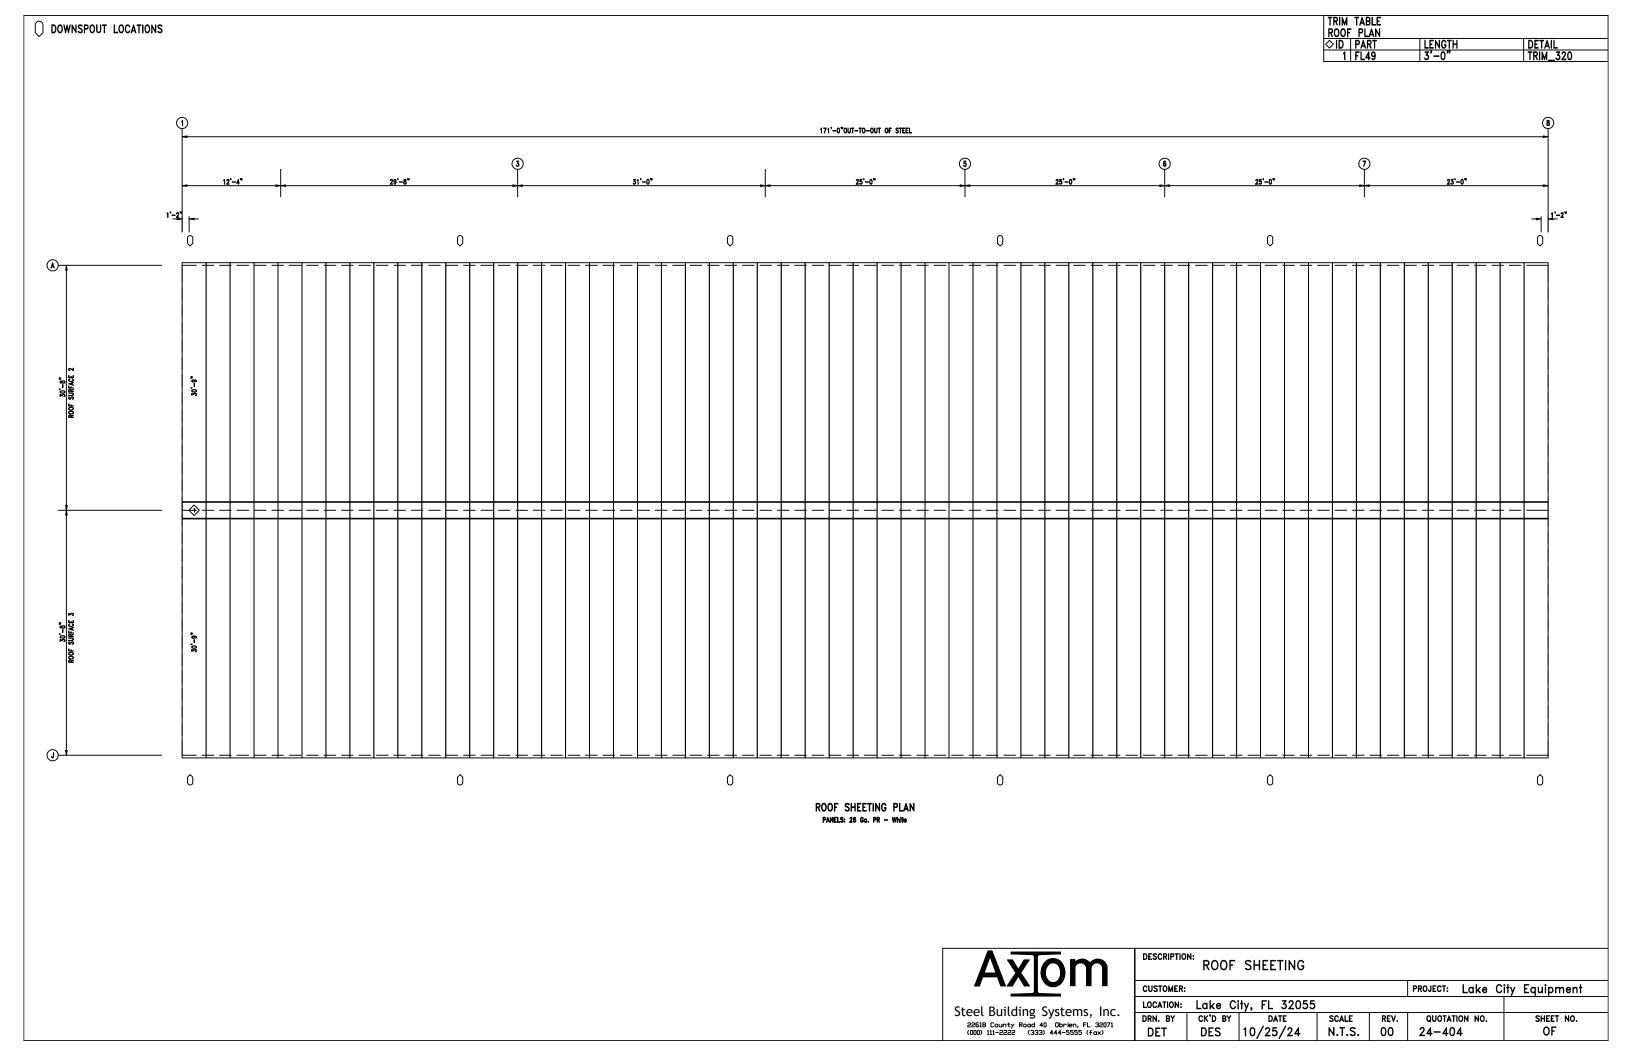


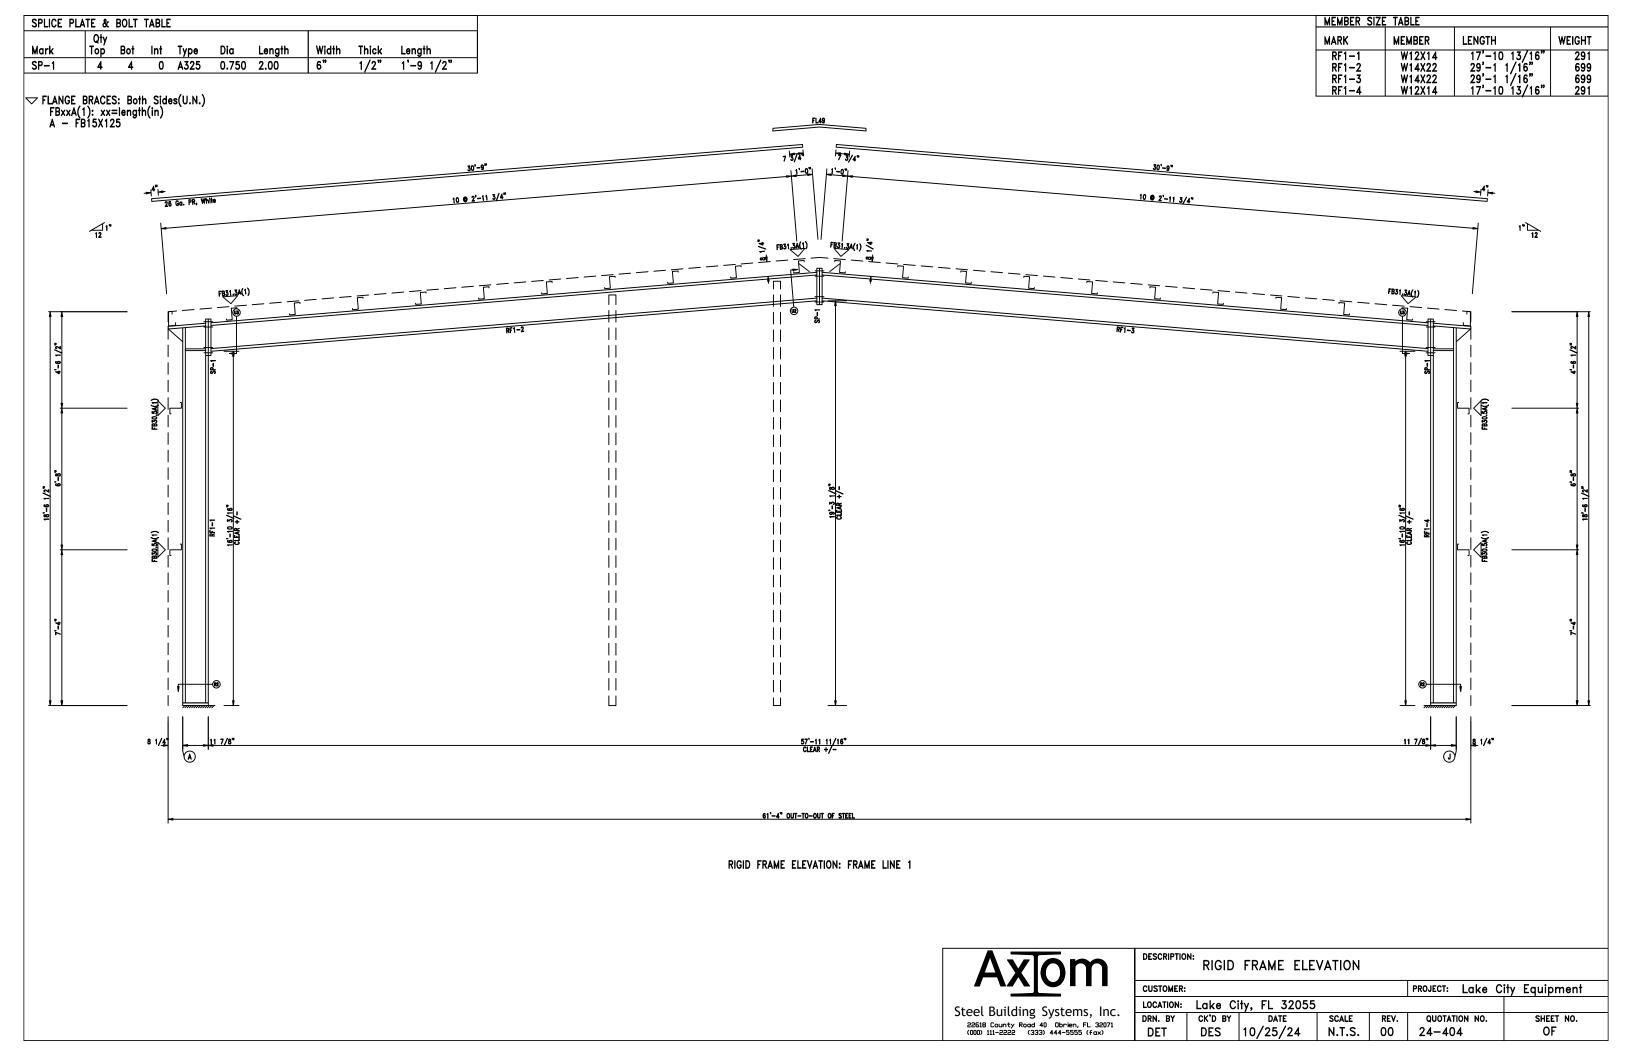


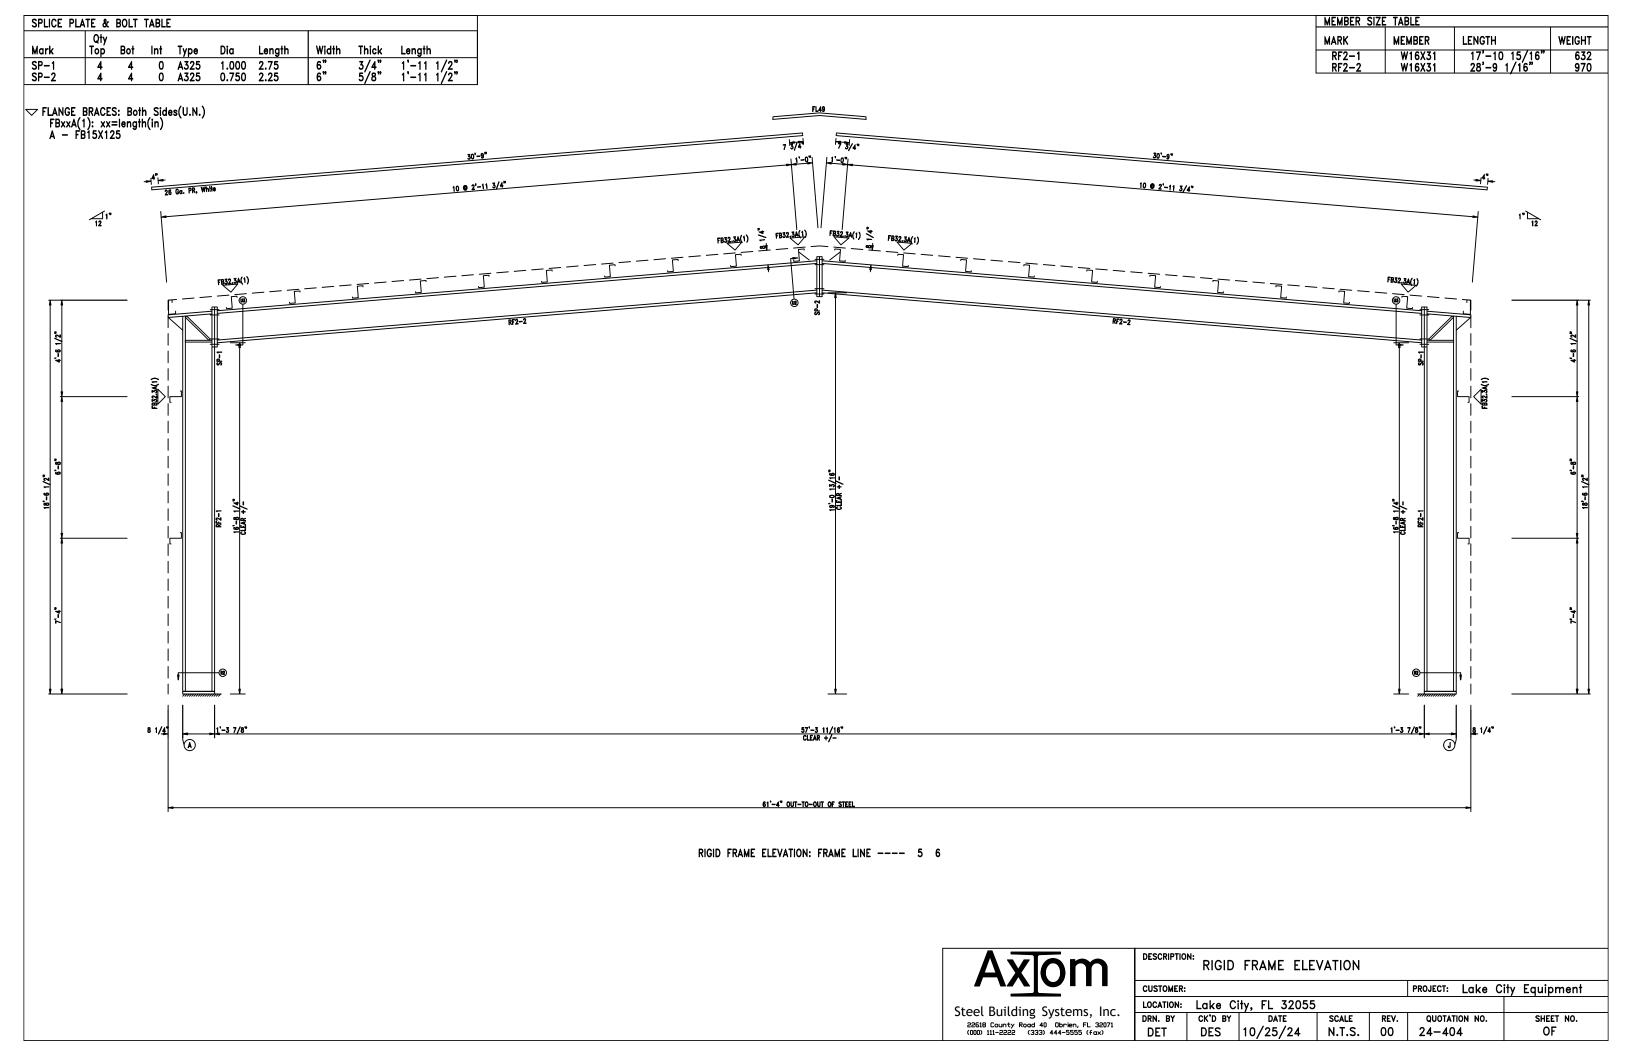


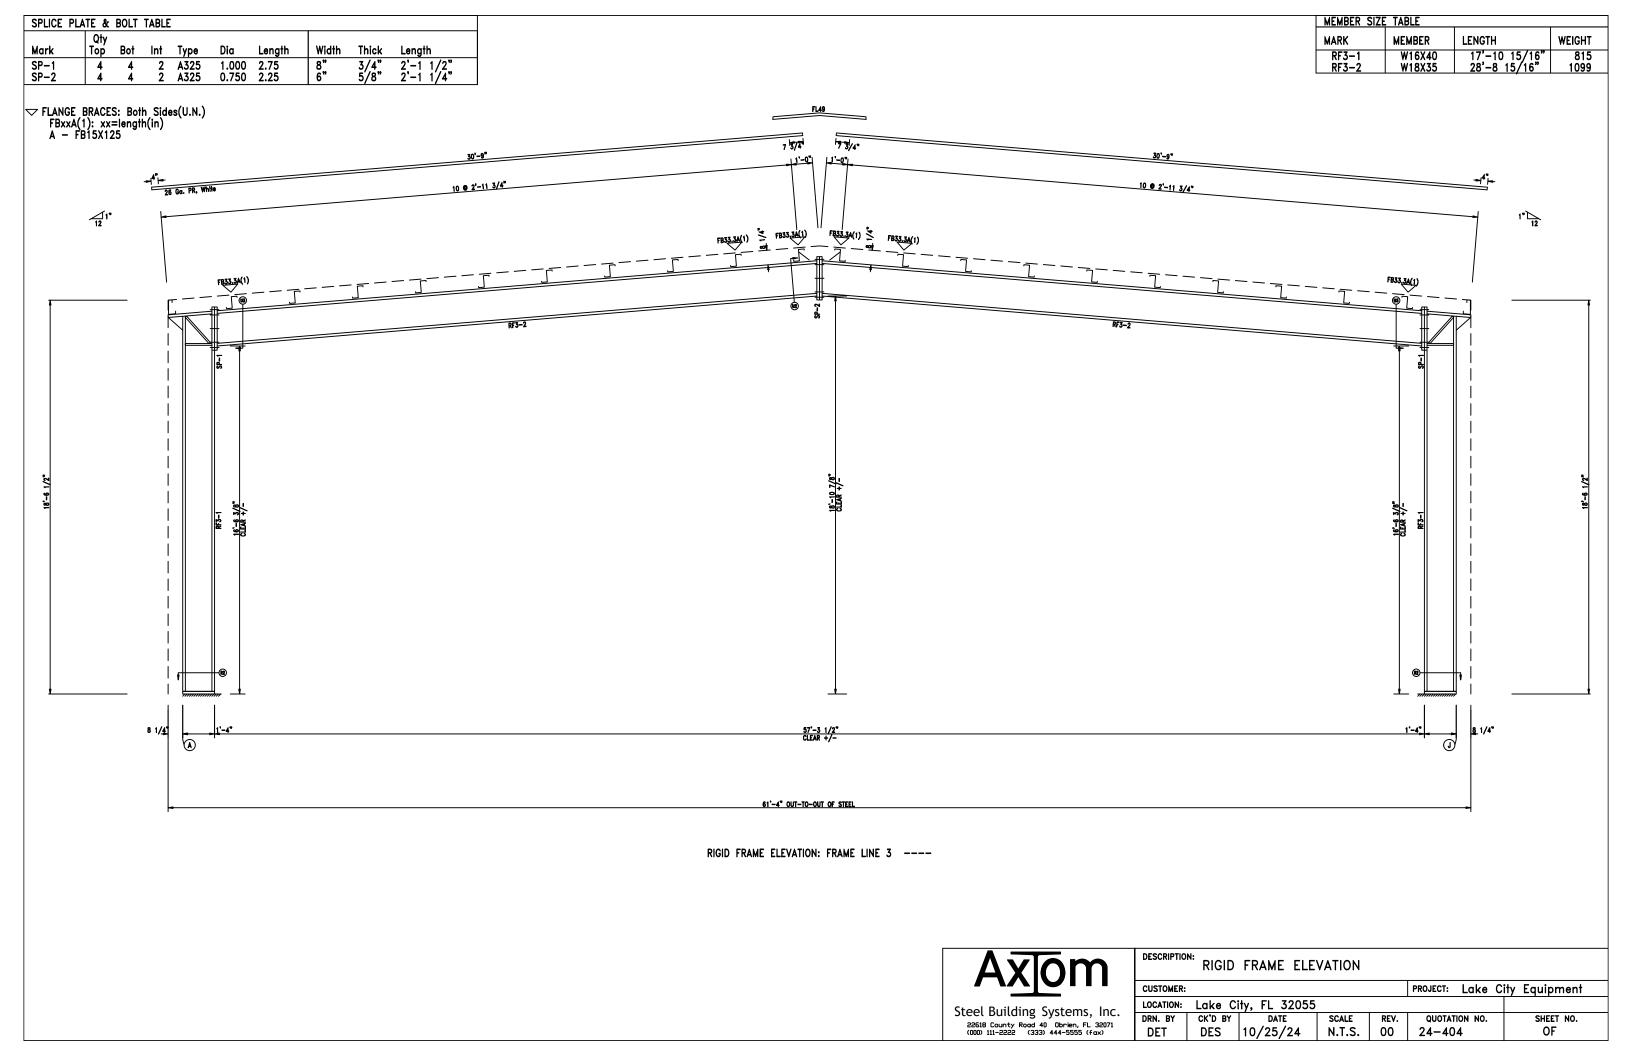

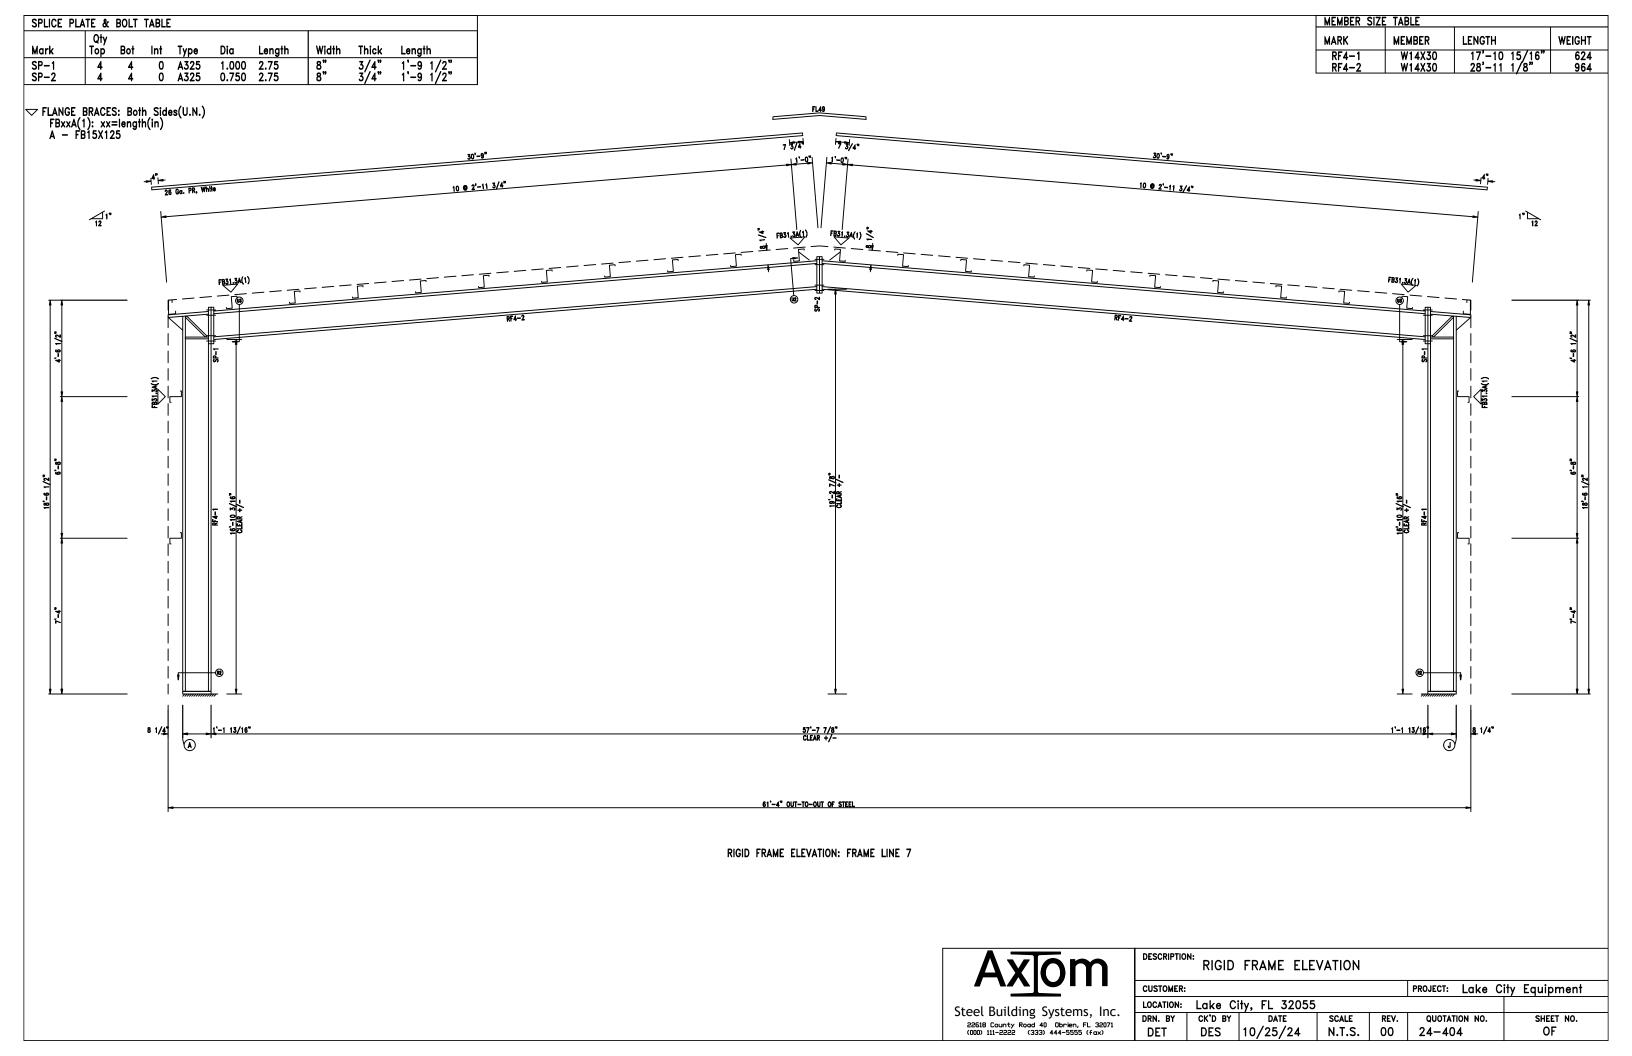

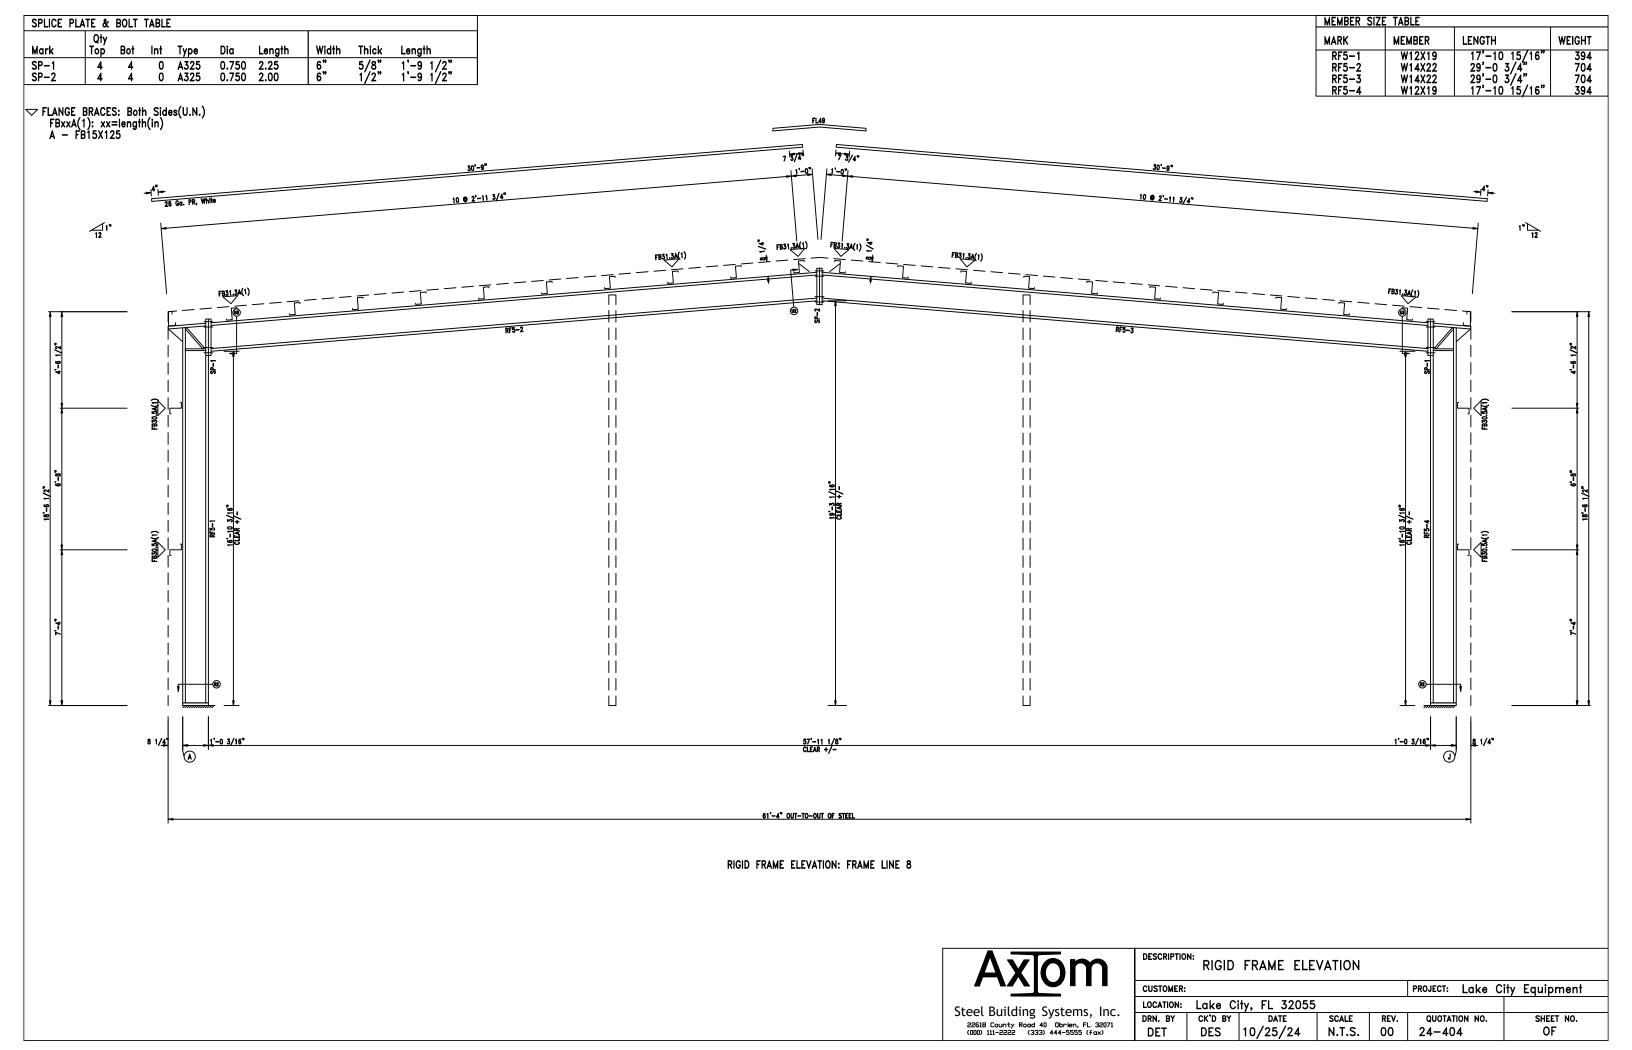

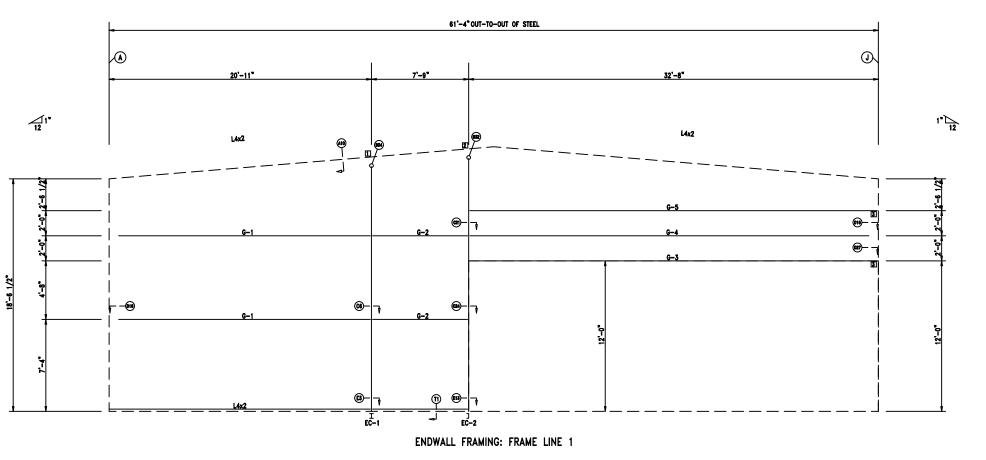

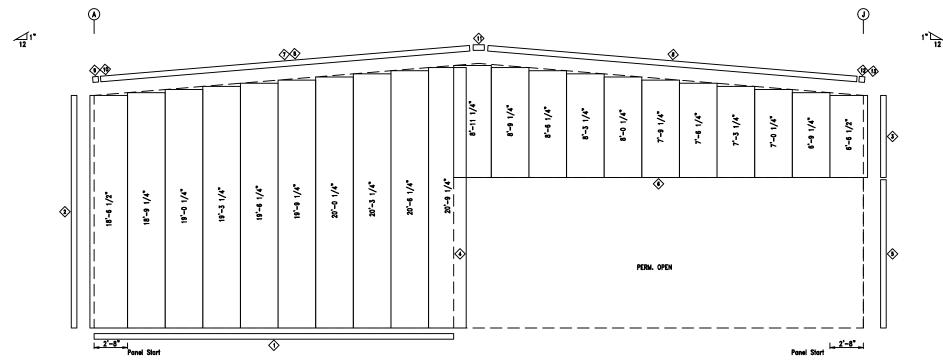

ENDWALL SHEETING & TRIM: FRAME LINE 1 PANELS: 26 Ga. PR - Charcoal Gray



DESCRIPTION: ENDWALL FRAMING							
CUSTOMER:	CUSTOMER: PROJECT: Lake City Equipment						
LOCATION:	LOCATION: Lake City, FL 32055						
DRN. BY DET	CK'D BY	DATE 10/25/24	SCALE N.T.S.	REV. 00	QUOTAT 24-40	ion no. 4	SHEET NO. OF

BOLT TABLE FRAME LINE 1 LOCATION EC-1/FRAME EC-2/FRAME

TRIM TABLE FRAME LINE 1

◇ID PART

1 FL72
2 FL835
3 FL830
4 FL23C
5 FL831
6 FL871
7 FL16
8 FL16D
9 FL16M
10 FL16A
11 FL16B
12 FL16M
13 FL16A

LENGTH
10'-2"
20'-2"
10'-2"
12'-0"
20'-2"
10'-2"
20'-2"
10'-2"
6"
1'-4"
10'-2"

MEMBER TABLE

EC-1 EC-2 G-1 G-2 G-3 G-4 G-5

MEMBER TABLE FRAME LINE 1 MARK PART EC-1 W8X10 EC-2 C8x11.5 G-1 8X25Z12 G-2 8X25Z12

8X25C16 8X25Z14 8X25Z12

| DETAIL | TRIM_74 | TRIM_198 | TRIM_198 | TRIM_239 | TRIM_198

TRIM_229 TRIM_229


LENGTH


19'-5 1/8"
20'-0 7/8"
20'-6 3/4"
7'-1"
32'-7 1/2"
32'-7 1/2"

CONNECTION PLATES
FRAME LINE 1

DID MARK/PART

1 n1
2 n2
3 d2

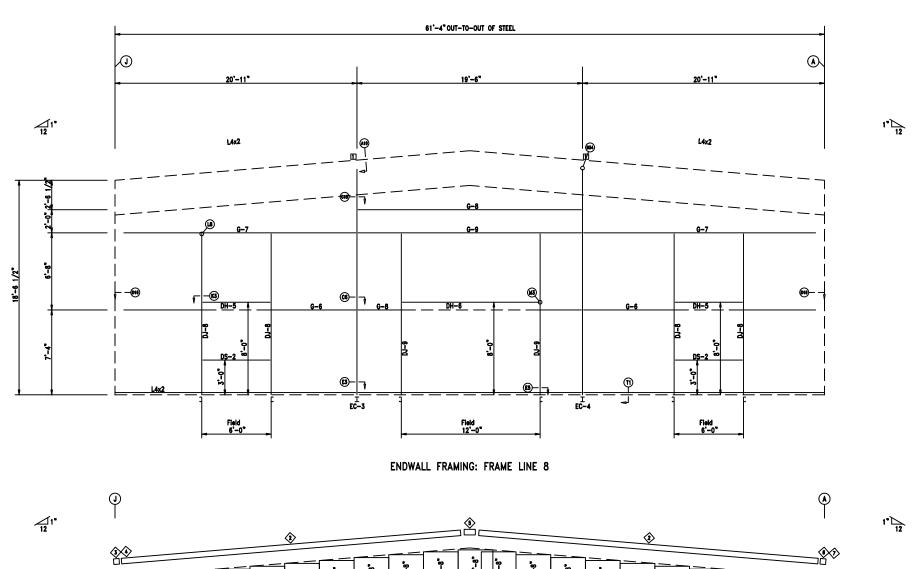

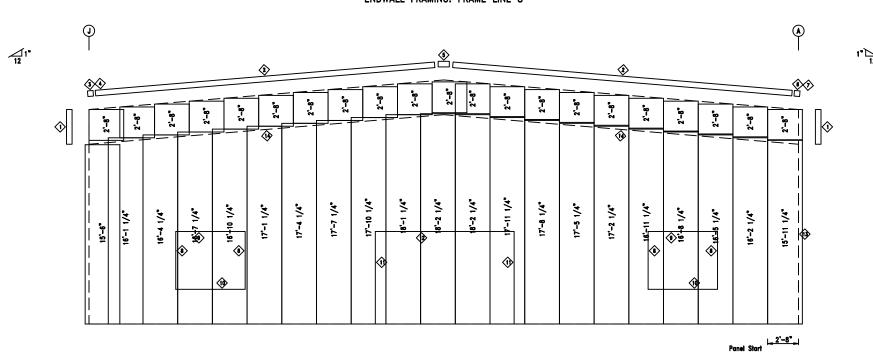

ENDWALL SHEETING & TRIM: FRAME LINE 8 PANELS: 26 Ga. PR - Charcoal Gray



SCRIPTION: ENDWALL FRAMING						
JSTOMER:				PROJECT: Lake C	ity Equipment	
CATION: Lake City, FL 32055						
N. BY	CK,D BA	DATE	SCALE	REV.	QUOTATION NO.	SHEET NO.
DET	DES	10/25/24	N.T.S.	00	24-404	OF

BOLT TABLE FRAME LINE 8 LOCATION Columns/Raf

TRIM TABLE
FRAME LINE 8

◇ID PART

1 FL830

1 FL830 2 FL16D 3 FL16M 4 FL16A 5 FL16M 7 FL16A 8 FL22 9 FL25 10 FL25 11 FL23 12 FL26B 13 FL803 14 FL287

QUAN TYPE 8 A325

LENGTH

10'-2"
20'-2"
10'-2"
6"
1'-4"
10'-2"
6"
7'-3"
7'-1"
10'-2"
12'-4"
16'-0"
10'-2"

MEMBER TABLE

MEMBER TABLE
FRAME LINE 8

MARK PART
EC-3 W8X10
EC-4 W8X10
DJ-8 8X25c1
DJ-9 8X25c1
DH-5 8X25c1
DH-6 8X25c1
DS-2 8X25c1
G-6 8X25Z1
G-7 8X35Z1
G-8 8X25Z1
G-9 8X25Z1

8X25c16 8X25c16

8X25c16 8X25c16 8X25c16

8X25Z16 8X35Z12

8X25Z16 8X25Z12

DETAIL TRIM_198 TRIM_229

TRIM_239 TRIM_232 TRIM_261 TRIM_239 TRIM_232

LENGTH

19'-5 1/8"

19'-5 1/8"

14'-0"

6'-0"

12'-0"


6'-0"


20'-6 3/4"

18'-10"

CONNECTION PLATES
FRAME LINE 8

DID MARK/PART
1 n1

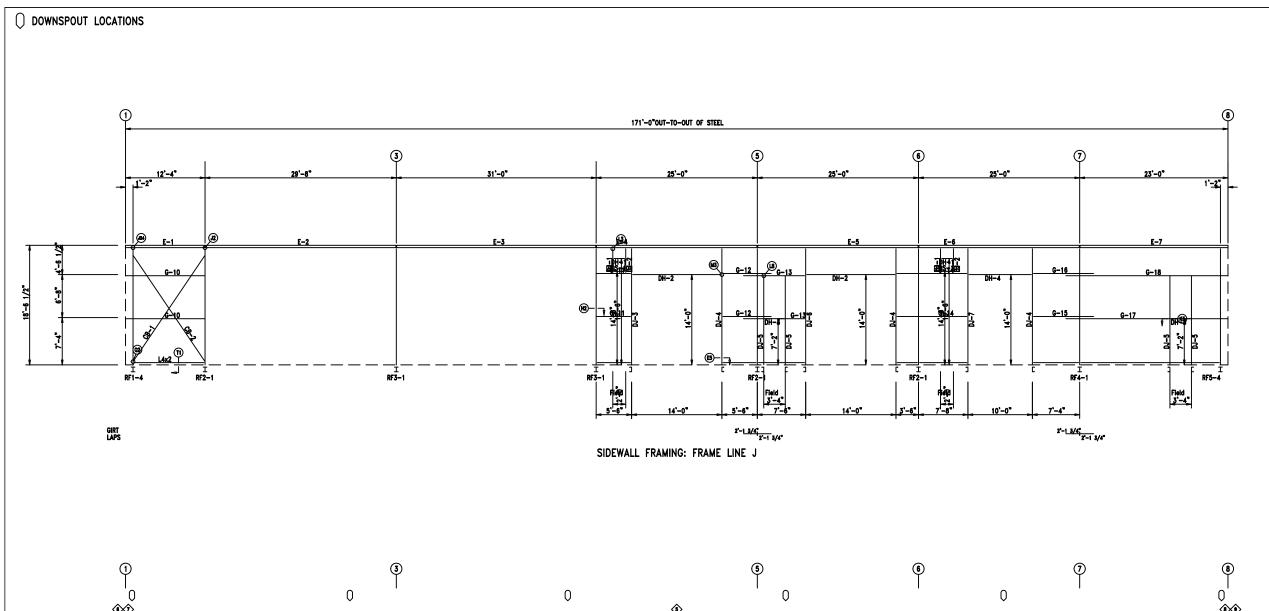

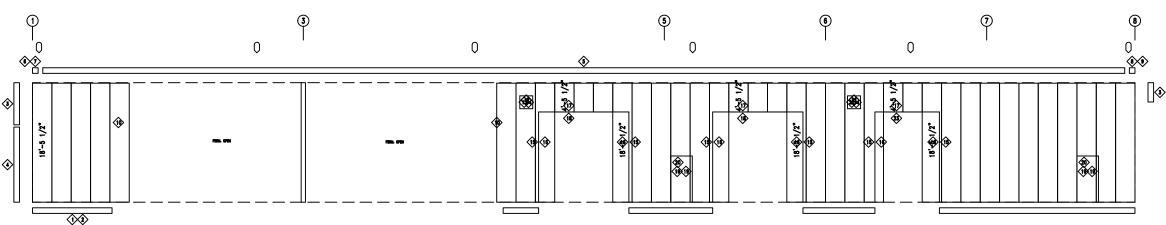

SIDEWALL SHEETING & TRIM: FRAME LINE J PANELS: 26 Ga. PR - Charcool Gray

		TABLE IE LINE J		
ı		PART	LENGTH	DETAIL
ı	1	FL72	10'-2"	TRIM_74
١	2	FL72	SCRAP	TRIM_74
١	3	FL830	10,-2"	TRIM_198
١	4	FL831	12'-0"	TRIM_198
١	5	FL831 FL18D	20',-2"	
١	6	FL18CM	10'-2" 6"	
	7	FL18A	6"	
١	8	FL18CM	10'-2"	
١	9	FL18A	6"	
١	10	FL23	10'-2" 7'-3"	TDU4 070
	11	FL22 FL22		TRIM_239
١	17	FL24	SCRAP 3'-6"	TRIM_239 TRIM_232
	1.4	FL24	3'-6"	TRIM_232
١	15	FL37	10'-2"	TRIM_242
	16	FL23C	14'-2"	TRIM_239
١	17	FL37	10'-2"	TRIM_235
	18	FL26C	14'-4"	TRIM_232
١		FL23	10'-2"	TRIM_239
	20		10'-2" 7'-1"	TRIM_232
	21	FL23	SCRAP	TRIM_239
	22		SCRAP.	TRIM_232
	23	FL26	10'-4"	TRIM_232

_		 	
	MEMBER 1	TABLE	
	FRAME LII	NE J	
	MARK	PART	LENGTH
	DJ-1	8X25c16	3'-7 3/8"
	DJ-2	8X25c16	3'-7 3'/8"
	DJ-3	8X35c14	17'-11' 1/8"
	DJ-4	8X25c16	17'-11 1/8"
	DJ-5	8X25c16	14'-0"
	DJ-6	8X25c14	17'-11 1/8"
	DJ-7	8X25c16	17'-11 1/8"
	DH-1	8X25c16	2'-0" ′
	DH-2	8X25c16	14'-0"
	DH-3	8X25c16	3'-4"
	DH-4	8X25c16	10'-0"
	DS-1	8X25c16	2'-0"
	E-1	E085341L	12'-3 1/2"
	E-2	E085341L	29'-7 1/2"
	E-3	E085321L	30'-11 1/2"
	E-4	E085341L	24'-11 1/2"
	E-4 E-5	E085341L	24'-11 1/2"
	E-6	E085341L	24'-11 1/2" 24'-11 1/2"
	E-7	E085341L	22"-11 1/2"
	G-10	8X25Z16	12'-7 1/2"
	G-11	8X25Z16	5'-6"
	G-12	8X25Z16	12'-7 1/2" 5'-6" 7'-5"
	G-13	8X25Z16	9'-5"
	G-14	8X25Z16	10'-8 1/2"
	G-15	8X25Z16	9'-3"
	G-16	8X25Z14	9'-3"
	G-17	8X25Z16	25'-1 1/2"
	G-18	8X25Z12	25'-1 1/2"
	CB-1	HW375	20'-11 1/4"
	CB-2	HW375	20'-11"

	FRAM	NECTION PLATES
İ	□ID	MARK/PART
ſ	1	£1

<u>Axiom</u>
Steel Building Systems, Inc. 22618 County Road 40 Obrien, FL 32071 (000) 111-2222 (333) 444-5555 (fax)

	DESCRIPTION: SIDEWALL FRAMING						
	CUSTOMER:					PROJECT: Lake	City Equipment
LOCATION: Lake City, FL 32055							
	DRN. BY	CK'D BY	DATE	SCALE	REV.	QUOTATION NO.	SHEET NO.
	DET	DES	10/25/24	N.T.S.	00	24-404	OF


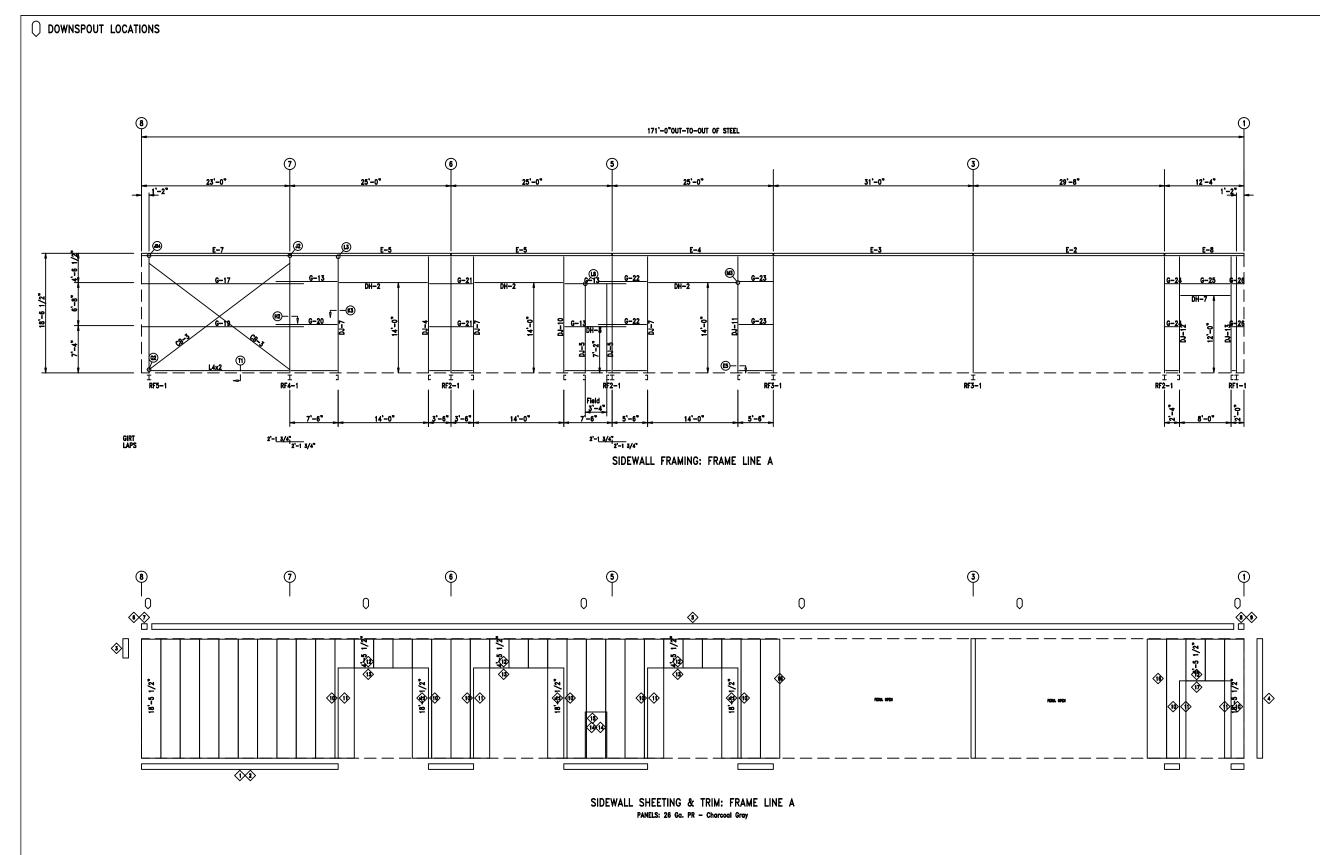


	TABLE		
	E LINE A		
◇ID_	PART	LENGTH	DETAIL
1	FL72	10'-2"	TRIM_74
2	FL72	SCRAP	TRIM_74
2 3	FL830	10'-2"	TRIM_198
4	FL835	20'-2"	TRIM_198
5	FL18D	20'-2"	_
6	FL18CM	10'-2"	
7	FL18A	6"	
8	FL18CM	10'-2"	
9	FL18A	6"	
10	FL37	10'-2"	TRIM_242
11	FL23C	14'-2"	TRIM_239
12	FL37	10'-2"	TRIM_235
13	FL26C	14'-4"	TRIM_232
14	FL23	10'-2"	TRIM_239
15	FL25	7'-1"	TRIM_232
16	FL23	10'-2"	
	FL26	10'-4"	TRIM_232


I EDAME LINE A	
FRAME LINE A	
MARK PART LENGTH	,
DJ-4 8X25c16 17'-11 1/8' DJ-5 8X25c16 14'-0"	
DJ-5 8X25c16 14'-0"	,
DJ-7 8X25c16 17'-11 1/8'	,
DJ-10 8X25c14 17'-11 1/8' DJ-11 8X35c14 17'-11 1/8'	,
DJ-11 8X35c14 17'-11 1/8'	,
DJ-12 8X25c16 17'-11 1/8'	,
DJ-13 8X25c16 17'-11 1/8'	-
DH-2 8X25c16 14'-0"	
DH-3 8X25c16 3'-4"	
DH-7 8X25c16 8'-0"	
E-2 E085341L 29'-7 1/2"	
E-3 E085321L 30'-11 1/2'	
E-4 E085341L 24'-11 1/2'	
E-5 E085341L 24'-11 1/2'	
E-7	,
E-8 E085341L 12'-3 1/2"	
G-13 8X25Z16 9'-5"	
G-17 8X25Z16 25'-1 1/2"	
G-19 8X25Z14 25'-1 1/2"	
G-20 8X25Z14 9'-5"	
G-21 8X25Z16 6'-6 1/2"	
G-22 8X25Z16 7'-5"	
G-23 8X25Z16 5'-6"	
G-24 8X25Z16 2'-5"	
G-25 8X25Z16 7'-11 1/2"	
G-26 8X25Z16 1'-9"	
CB-3 HW374 28'-2"	


	DESCRIPTIO						
	CUSTOMER:					PROJECT: Lake (City Equipment
LOCATION: Lake City, FL 32055							
	DRN. BY	CK'D BY	DATE	SCALE	REV.	QUOTATION NO.	SHEET NO.
	DET	DES	10/25/24	N.T.S.	00	24-404	OF

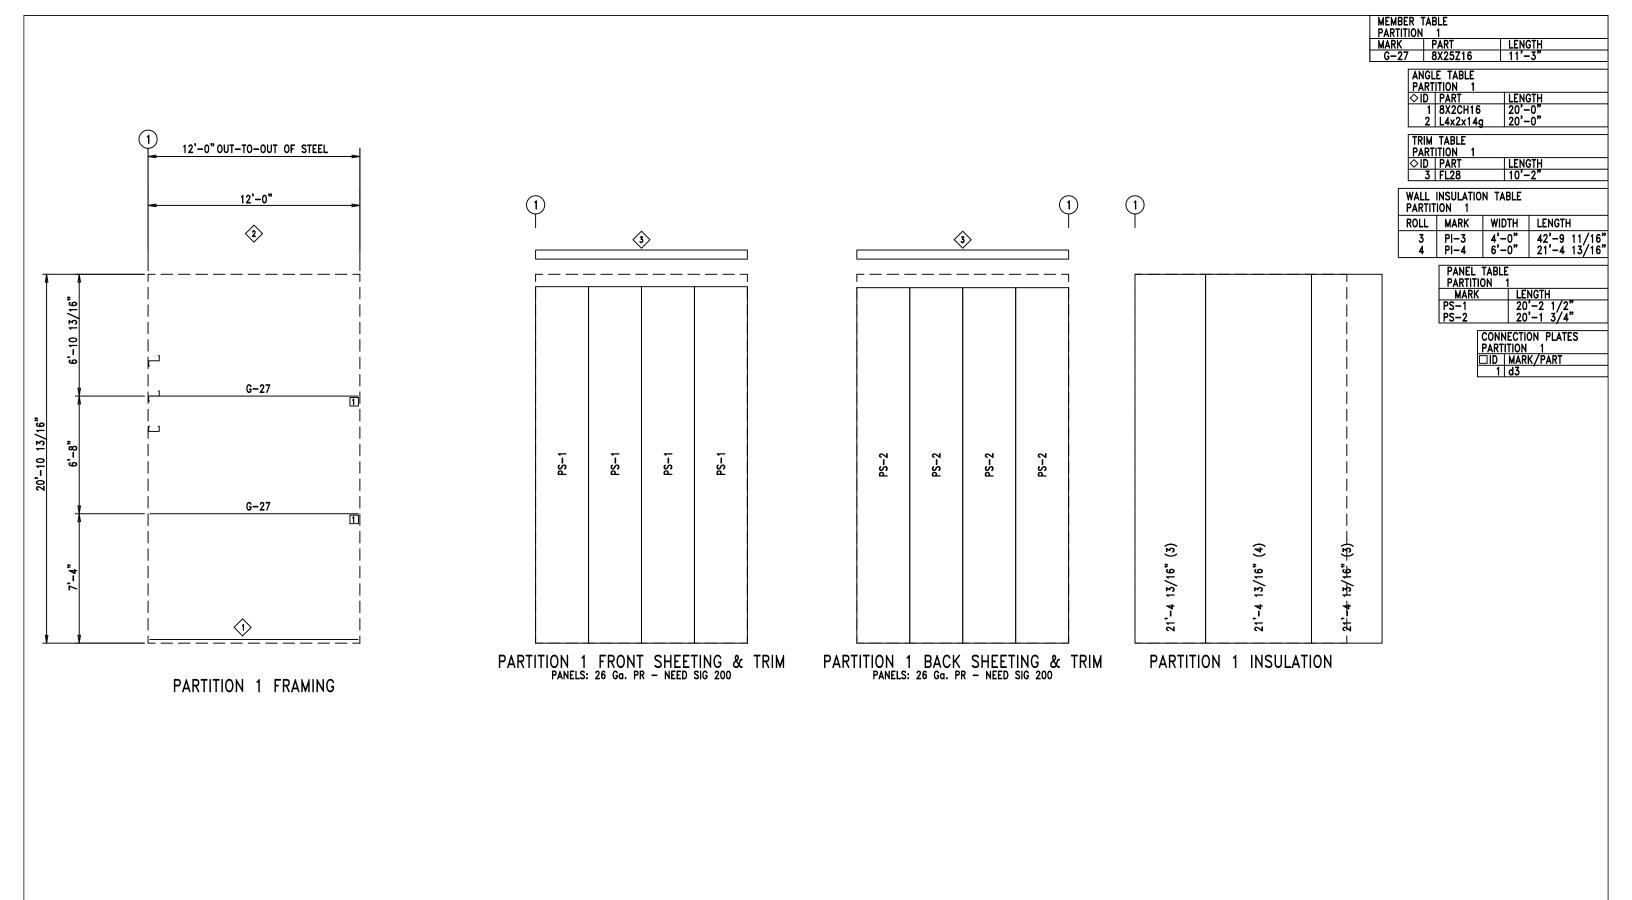


Axom
Steel Building Systems, Inc. 22518 County Road 40 Obrien, FL 32071 (0000) 111-2222 (333) 444-5555 (69x)

DESCRIPTION: PARTITION FRAMING							
CUSTOMER:					PROJECT:	Lake C	ity Equipment
LOCATION:	LOCATION: Lake City, FL 32055						
DRN. BY	CK'D BY	DATE	SCALE	REV.	QUOTAT	ION NO.	SHEET NO.
DET	DES	10/25/24	N.T.S.	00	24-40	4	OF

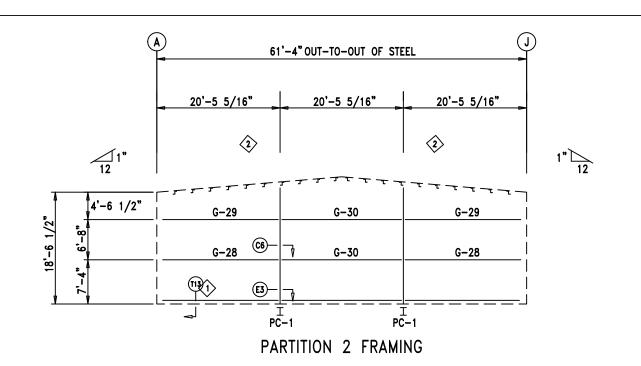

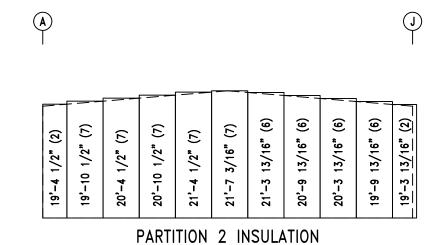

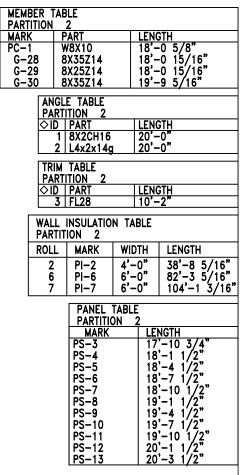


PROJECT: Lake City Equipment


SHEET NO.


OF


QUOTATION NO.

24-404

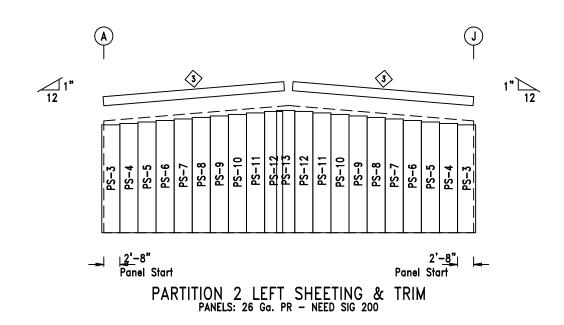


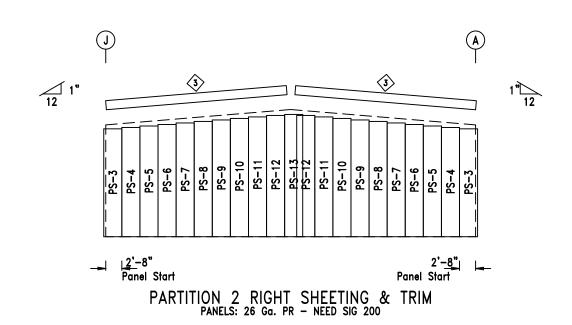


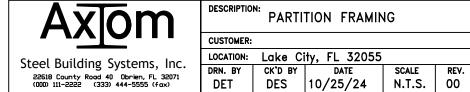

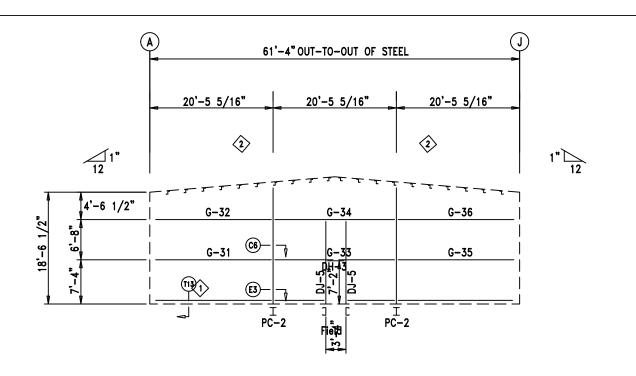

PARTITION 3 FRAMING

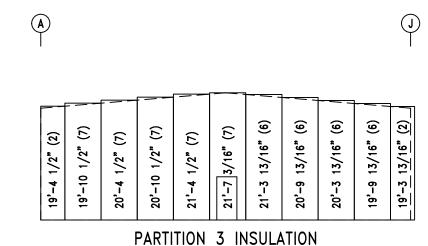


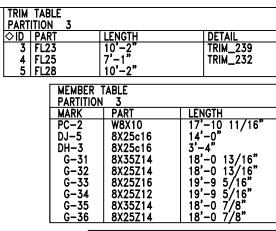


			•	
ΔN	IGI	E TABLE		
I PA	ĸι	ITION 3		
	<u> </u>	DADT	LENGTH	-
	<u> </u>	PART	LENGIA	
	1	8X2CH16	20'-0"	
- 1	_'	UNZUITIU	20, 0,	
- 1	2	L4x2x14g	120'-0"	
	_	<u> </u>	120 0	-

WALL PARTIT	INSULATIO ION 3		
ROLL	MARK	WIDTH	LENGTH
2	PI-2	4'-0"	38'-8 5/16" 82'-3 5/16"
6	PI-6	6'-0"	82'-3 5/16"
7	PI-7	6'-0"	104'-1 3/16"

PANEL TABLE	
PARTITION 3	3
MARK	LENGTH
PS-3	17'-10 3/4"
PS-4	18'-1 1 <i>/</i> 2"
PS-5	18'-4 1/2"
PS-6	18'-7 1/2"
PS-7	18'-10 1/2"
PS-8	19'-1 1/2"
PS-9	19'-4 1/2"
PS-10	19'-7 1/2"
PS-11	19'-10 1 <i>/</i> 2"
PS-12	20'-1 1/2"
PS-13	20'-3 1/2"
	•

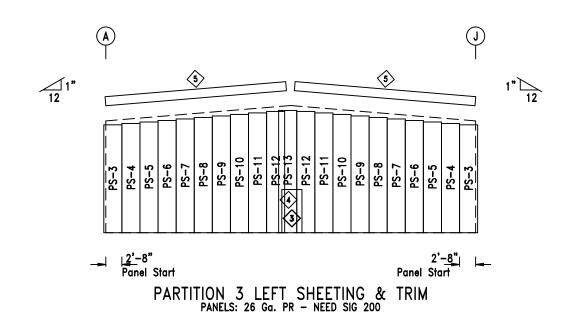


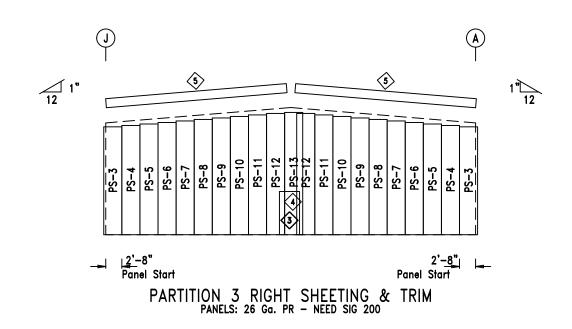


AXIOM


Steel Building Systems, Inc.
22618 County Road 40 Obrien, FL 32071
(000) 111-2222 (333) 444-5555 (fax)

PARTITION FRAMING								
CUSTOMER: PROJECT:					PROJECT: La	ıke Ci	ity Equipment	
LOCATION: Lake City, FL 32055								
DRN. BY	CK'D BY	DATE	SCALE	REV.	QUOTATION	NO.	SHEET NO.	
DET	DES	10/25/24	N.T.S.	00	24-404		OF	

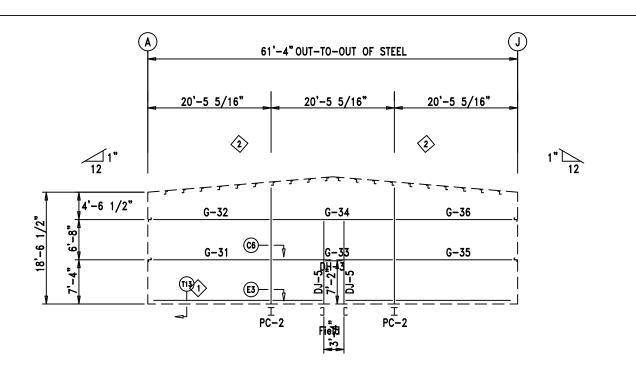

PARTITION 4 FRAMING

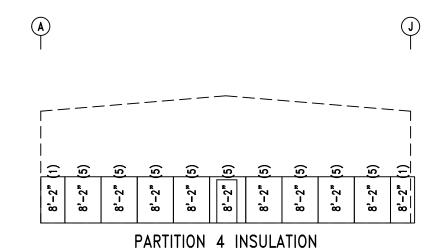

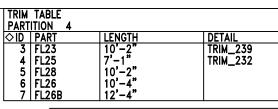



MEMBER 1		
MARK	PART	LENGTH
PC-2	W8X10	17,-10 11/16"
DJ-5	8X25c16	14'-0"
DH-3	8X25c16	3'-4"
G-31	8X35Z14	18'-0 13/16"
G-32	8X25Z14	18'-0 13/16"
G-33	8X25Z16	19'-9 5/16"
G-34	8X25Z12	19'-9 5/16"
G-35	8X35Z14	18'-0 7 <i>'</i> /8"
G-36	8X25Z14	18'-0 7 <i>'</i> /8"

ANGL PART			
♦ID	PART	LENGTH	
1	8X2CH16	20'-0"	
2	L4x2x14a	20'-0"	

WALL PARTIT	INSULATIO ION 4	N TABLE	
ROLL	MARK	WIDTH	LENGTH
1	PI-1	4'-0"	16'-4"
5	PI-5	6'-0"	73'-6"

PANEL TABLE	
PARTITION 4	,
MARK	LENGTH
PS-3	17'-10 3/4"
PS-4	18'-1 1 <i>/</i> 2"
PS-5	18'-4 1/2"
PS-6	18'-7 1 <i>/</i> 2"
PS-7	18'-10 1 <i>/</i> 2"
PS-8	19'-1 1 <i>/</i> 2"
PS-9	19'-4 1/2"
PS-10	19'-7 1/2"
PS-11	19'-10 1/2"
PS-12	20'-1 1/2"
PS-13	20'-1 1/2" 20'-3 1/2"
PS-14	7'-7 "
-	-

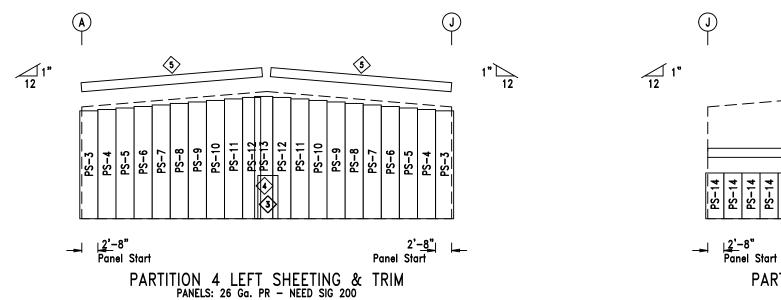

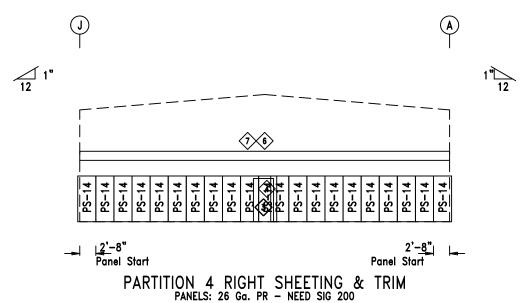



AXIOM


Steel Building Systems, Inc.


22618 County Road 40 Obrien, FL 32071
(000) 111-2222 (333) 444-5555 (fox)

DESCRIPTION: PARTITION FRAMING						
CUSTOMER:					PROJECT: Lake C	ity Equipment
LOCATION: Lake City, FL 32055						
DRN. BY	CK'D BY	DATE	SCALE	REV.	QUOTATION NO.	SHEET NO.
DET	DES	10/25/24	N.T.S.	00	24-404	OF

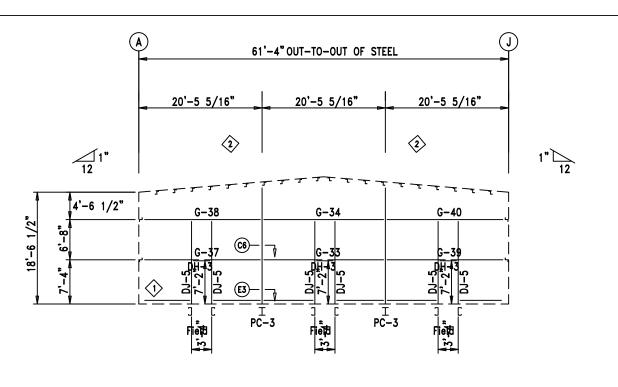

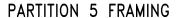

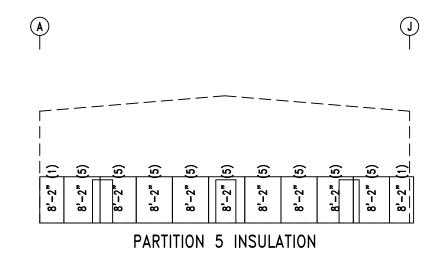

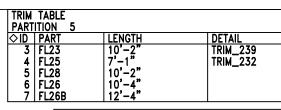



MEMBER 1	TABLE	
PARTITION	5	
MARK	PART	LENGTH
PC-3	W8X10	18'-2 11/16"
DJ-5	8X25c16	14'-0"
DH-3	8X25c16	3'-4"
G-33	8X25Z16	19'-9 5/16"
G-34	8X25Z12	19'-9_5/16"
G-37	8X25Z16	18'-3"
G-38	8X25Z12	18'-3"
G-39	8X25Z16	18'-3 1/16"
G-40	8X25Z12	18'-3 1/16"
I G-40	I ONZULIZ	10-31/10

ANGL PART	E TABLE ITION 5	•	
◇ID	PART	LENGTH	
1	8X2CH16	20'-0"	
2	L4x2x14g	20'-0"	

WALL INSULATION TABLE PARTITION 5						
ROLL	MARK	WIDTH	LENGTH			
1 5	PI-1	4'-0" 6'-0"	16'-4"			
J	FI=3	0 -0	/3 -0			

PANEL TABLE PARTITION 5	
MARK	LENGTH
PS-3	17,-10 3/4"
PS-4	18 <u>'</u> -1 1/2 <u>"</u>
PS-5	18'-4 1/2"
PS-6	18'-7 1/2"
PS-7	18'-10 1/2"
PS-8	19'-1 1/2"
PS-9	19'-4 1/2"
PS-10	19'-7 1/2"
PS-11	19'-10 1/2"
PS-12	20'-1 1/2"
PS-13	20'-1 1/2" 20'-3 1/2"
PS-14	<u>7'-7"</u>

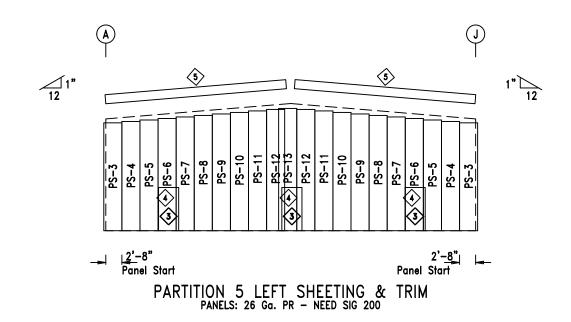


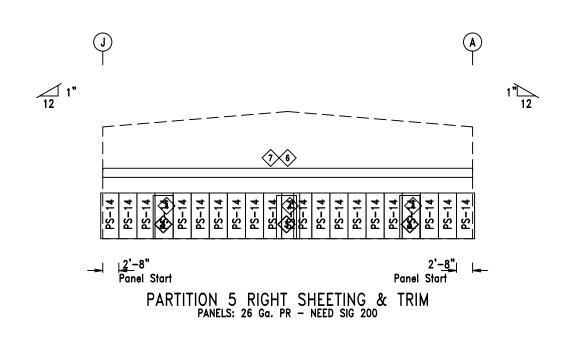


AXIOM

Steel Building Systems, Inc.
22518 County Road 40 Obrien, FL 32071
(000) 111-2222 (333) 444-5555 (fax)

DESCRIPTION: PARTITION FRAMING								
CUSTOMER:	CUSTOMER: PROJECT: Lake City Equipment							
LOCATION:	LOCATION: Lake City, FL 32055							
DRN. BY	CK'D BY	QUOTATION NO.	SHEET NO.					
DET	DES	10/25/24	N.T.S.	00	24-404	OF		

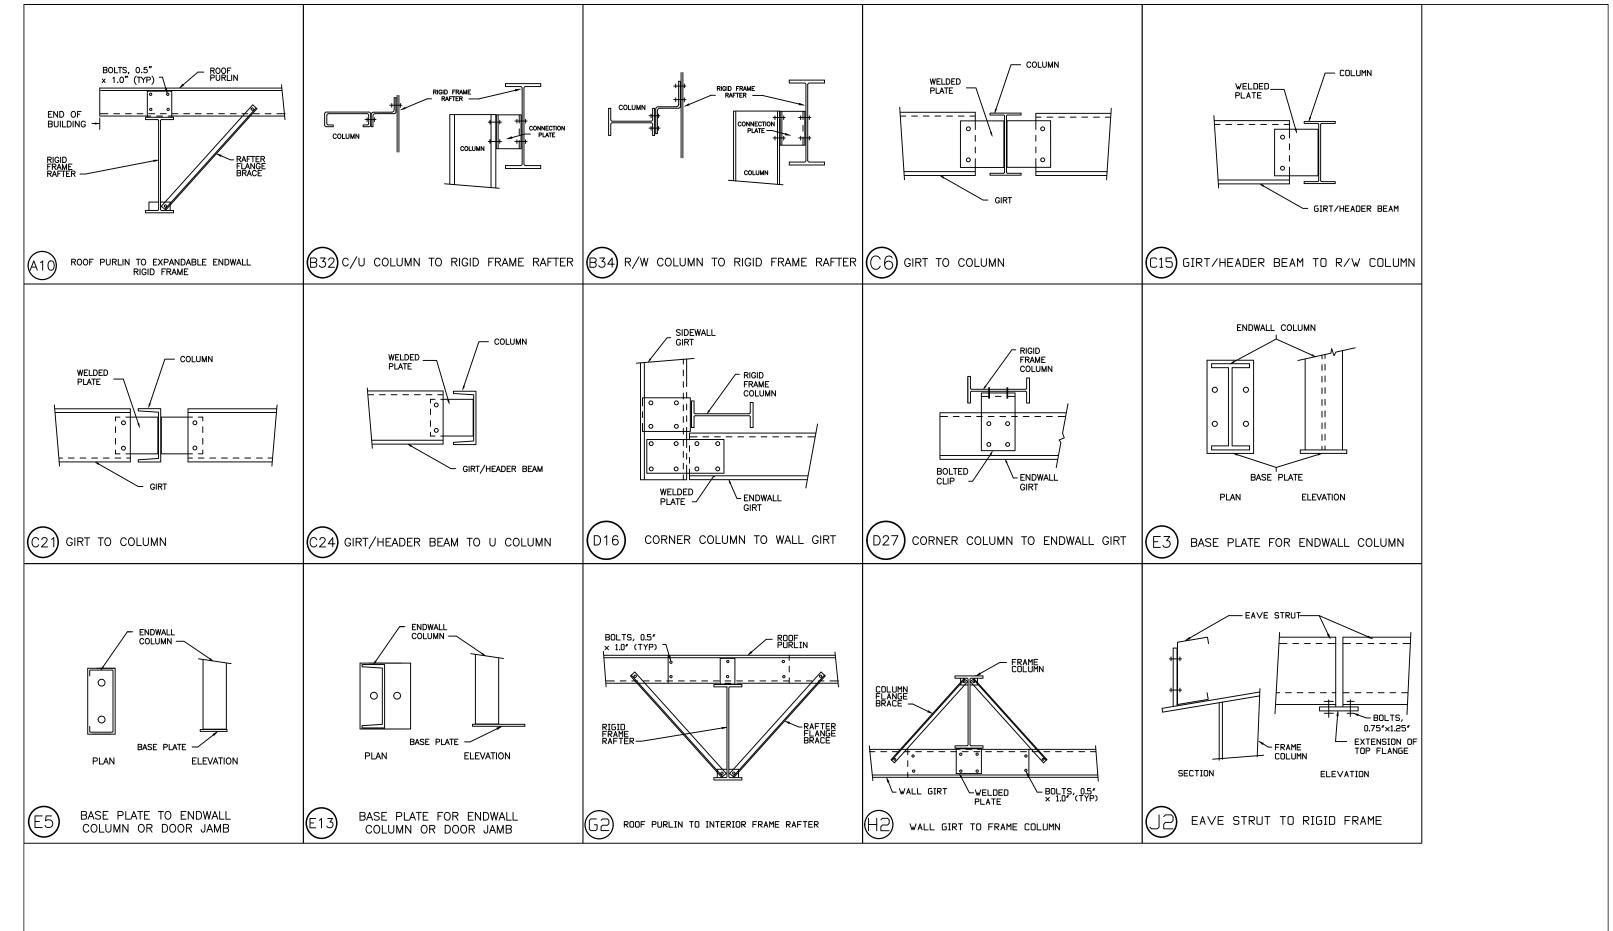



	Axlom	DETAIL DRAWINGS						
	/ <u>//</u>	CUSTOMER:				PROJECT: Lake C	ity Equipment	
	Steel Building Systems, Inc.	LOCATION: Lake City, FL 32055						
		DRN. BY	CK'D BY	DATE	SCALE	REV.	QUOTATION NO.	SHEET NO.
	(000) 111-2222 (333) 444-5555 (fax)	DET	DES	10/24/24	N.T.S.	00	24-404	OF

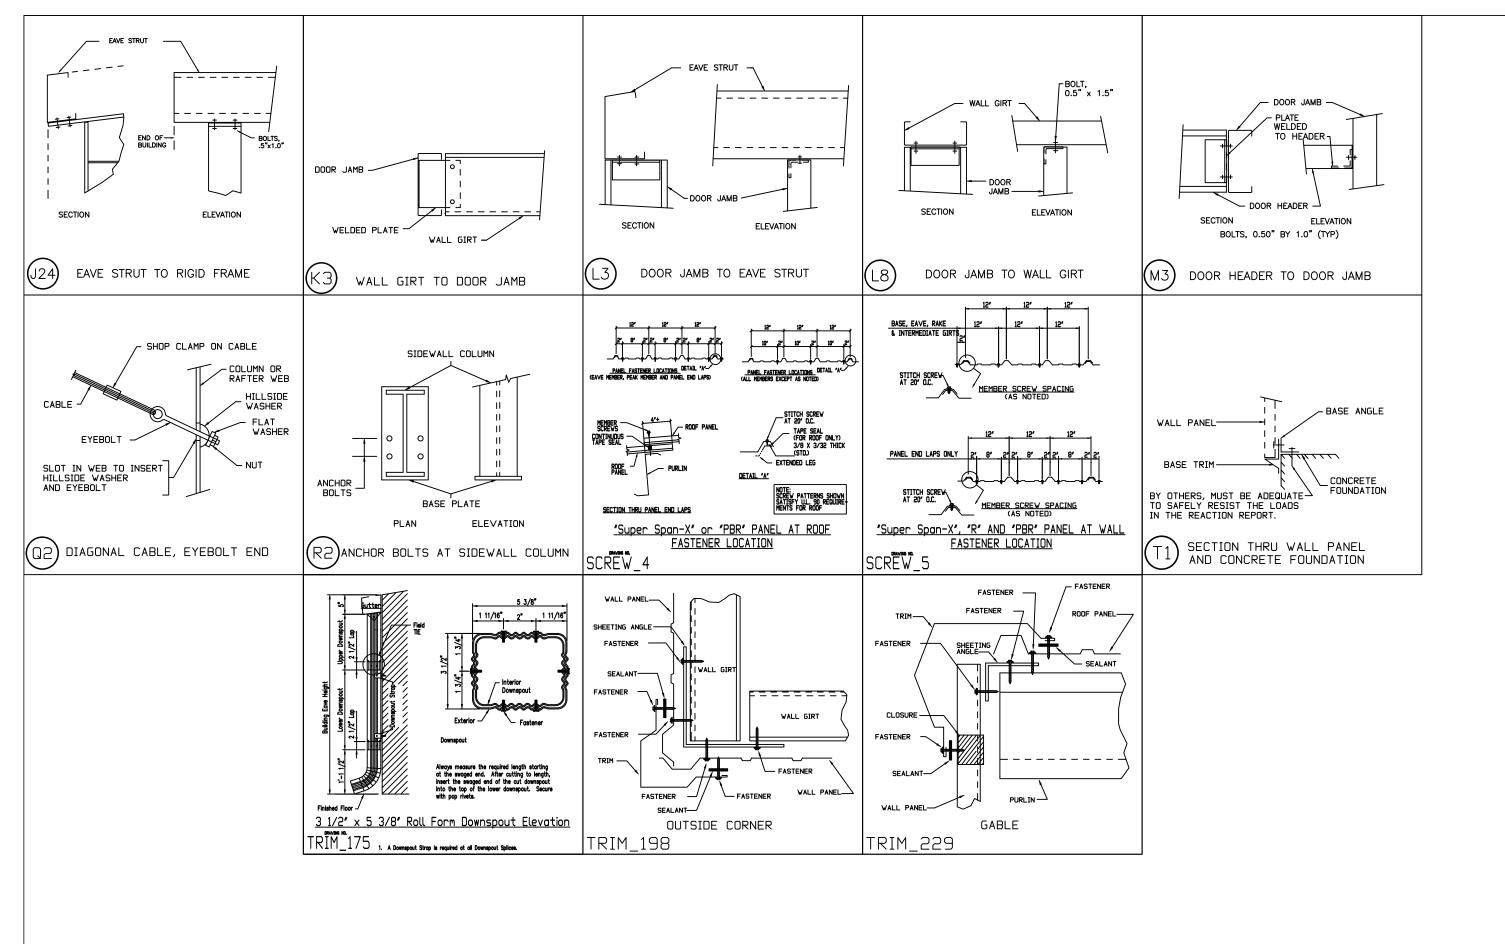

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Steel Building Systems, Inc.	LO
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22618 County Road 40 Obrien, FL 32071 (000) 111-2222 (333) 444-5555 (fax)	D

DETAIL DRAWINGS								
CUSTOMER:	CUSTOMER: PROJECT: Lake City Equipment							
LOCATION:	LOCATION: Lake City, FL 32055							
DRN. BY	CK'D BY	DATE	SCALE	REV.	QUOTAT	ION NO.	SHEET NO.	Τ
DET	DES	10/25/24	N.T.S.	00	24-40	4	OF	

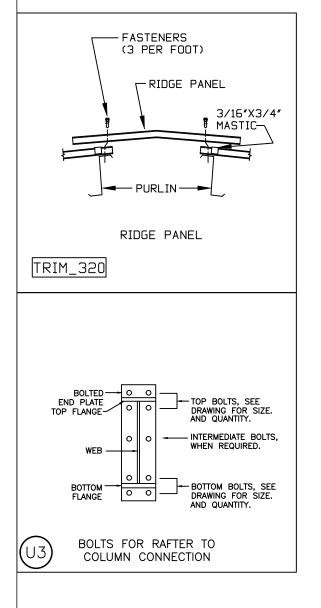

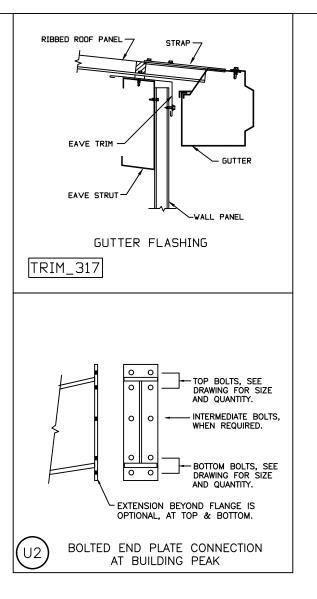



DETAIL DRAWINGS							
CUSTOMER:	CUSTOMER: PROJECT: Lake City Equipment						
LOCATION:	LOCATION: Lake City, FL 32055						
DRN. BY CK'D BY DATE SCALE REV. QUOTATION NO. SHEET NO.							
DET	DES	10/25/24	N.T.S.	00	24-404	OF	