

### SCOPE OF WORK:

TO INSTALL A ROOF MOUNTED SOLAR PHOTOVOLTAIC SYSTEM AT THE OWNER RESIDENCE LOCATED AT 525 SOUTHWEST KIRBY AVENUE, LAKE CITY, FL 32024.

SYSTEM DC RATING: 9.60 KWDC SYSTEM AC RATING: 6.97 KWAC

### **GENERAL NOTES:**

- THESE CONSTRUCTION DOCUMENTS HAVE BEEN BASED ON FIELD INSPECTIONS AND OTHER INFORMATION AVAILABLE AT THE TIME. ACTUAL FIELD CONDITIONS MAY REQUIRE MODIFICATIONS IN CONSTRUCTION DETAILS.
- CONTRACTOR HAS THE FULL RESPONSIBILITY TO CHECK AND VERIFY ALL DIMENSIONS AND EXISTING CONDITIONS. ANY DISCREPANCIES SHALL BE REPORTED TO THE ENGINEER BEFORE PROCEEDING WITH THE WORK. ANY WORK STARTED BEFORE CONSULTATION AND ACCEPTANCE BY THE ENGINEER SHALL BE THE SOLE RESPONSIBILITY OF THE CONTRACTOR AND SHALL BE SUBJECT TO CORRECTION BY THEM WITHOUT ADDITIONAL COMPENSATION.
- THE CONTRACTOR SHALL BE HELD RESPONSIBLE FOR THE PROPER INSTALLATION AND COMPLETION OF THE WORK WITH APPROVED MATERIALS.
- THE EQUIPMENT AND ALL ASSOCIATED WIRING AND INTERCONNECTION SHALL BE INSTALLED ONLY BY QUALIFIED PEOPLE. A QUALIFIED PERSON IS ONE WHO HAS SKILLS AND KNOWLEDGE RELATED TO THE CONSTRUCTION AND OPERATION OF THE ELECTRICAL EQUIPMENT AND INSTALLATIONS AND HAS RECEIVED SAFETY TRAINING TO RECOGNIZE AND AVOID THE HAZARDS INVOLVED. (NEC 690.4(C), NEC 2017).
- NEW CONDUIT ROUTING SHOWN IS ESSENTIALLY SCHEMATIC.
  CONTRACTOR SHALL LAY OUT RUNS TO SUIT FIELD CONDITIONS
  AND THE COORDINATION REQUIREMENTS OF OTHER TRADES.
- ARRAY WIRING SHOULD NOT BE READILY ACCESSIBLE EXCEPT TO QUALIFIED PERSONNEL.
- THE AC DISCONNECT MUST BE ACCESSIBLE TO QUALIFIED UTILITY PERSONNEL, BE LOCKABLE, AND BE A VISIBLE-BREAK SWITCH.



	SHEET INDEX						
CS-0	COVER SHEET & BOM						
E-1	STRING LAYOUT & SIGNAGE						
E-2	ELECTRICAL DIAGRAM & CALCS.						
E-3+	EQUIPMENT SPECIFICATIONS						

### **GOVERNING CODES**

2020 FFPC (7TH EDITION)

2018 NFPA 1 (FIRE CODE)

NAL FLECTRICAL COR

2017 NATIONAL ELECTRICAL CODE

2020 FLORIDA BUILDING CODE (7TH EDITION)

AUTHORITY HAVING JURISDICTION (AHJ): COUNTY OF COLUMBIA

BILL OF MATERIALS							
EQUIPMENT QTY DESCRIPTION							
SOLAR PV MODULE	24	Q.PEAK DUO BLK ML-G10+ 400					
MICROINVERTER	24	ENPHASE IQ8PLUS-72-2-US					
JUNCTION BOX	1	JUNCTION BOX, NEMA 3R, UL LISTED					
COMBINER BOX	1	ENPHASE IQ COMBINER 4/4C W/ IQ ENVOY (X-IQ-AM1-240-4)					
AC DISCONNECT	1	60A NON FUSED AC DISCONNECT, 240V, NEMA 3R, UL LISTED					
POWER PERFECT BOX	1	(ES1PN), 120V/240V, NEMA 3X					





ORLANDO, FL 32826 1 (407) 988-0273

SEAN VASQUEZ
RESIDENCE
PROJECT # P-0065775
525 SOUTHWEST KIRBY AVENUE
LAKE CITY, FL 32024

SIGNATURE WITH SEAL

REVISIONS

DESCRIPTION DATE REV

Drawn by: A.A.

02/01/2023

e: SHEET NAME


COVER SHEET & BOM

CS-0

SHEET NUMBER

2023.02.02 13:25:06 -05'00'

THIS ITEM HAS BEEN DIGITALLY SIGNED AND SEALED BY OMAR TIRADO ON THE DATE ADJACENT TO THE SEAL. PRINTED COPIES OF THIS DOCUMENT ARE NOT VCONSIDERED SIGNED AND SEAL, AND THE SIGNATURE MUST BE VERIFIED ON ANY ELECTRONIC COPIES

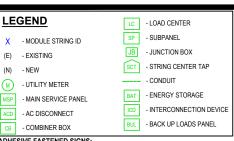

ADHESIVE FASTENED SIGNS:

- ANSI Z535.4-2011 PRODUCT SAFETY SIGNS AND LABELS, PROVIDES GUIDELINES FOR SUITABLE FONT SIZES, WORDS, COLORS, SYMBOLS, AND LOCATION REQUIREMENTS FOR LABELS. NEC 110.21(B)(1).
- THE LABEL SHALL BE OF SUFFICIENT DURABILITY TO WITHSTAND THE ENVIRONMENT INVOLVED, NEC 110.21(B)(3).
- ADHESIVE FASTENED SIGNS MAY BE ACCEPTABLE IF PROPERLY ADHERED. VINYL SIGNS SHALL BE WEATHER RESISTANT.
- ALL LABELS AND MARKINGS FOR PHOTOVOLTAIC SYSTEMS WILL BE REFLECTIVE AND MEET ALL REQUIREMENTS.

 $ext{ ilde{1}}$  WARNING  $extstyle{2}$ 

DO NOT TOUCH TERMINALS ERMINALS ON BOTH THE LINE AND LOAD SIDES MAY BE ENERGIZED IN THE OPEN POSITION

EMERGENCY RESPONDER SOLAR PV SYSTEM EQUIPPED

ED AC OUTPUT CURRENT 29.0 A
INAL OPERATING AC VOLTAGE 240 V

**RAPID SHUTDOWN SWITCH FOR SOLAR PV SYSTEM** 

1 WARNING A DUAL POWER SOURCE

SOURCES: UTILITY GRID AND PV SOLAR ELECTRIC SYSTEM

! WARNING!

! WARNING!

LABEL LOCATION: COMBINER BOX/ EMT ENCLOSURES/ AC DISCONNECT/

PER CODE: NEC 2017, 690.13(B)

RAPID SHUTDOWN (AC DISCONNECT) PER CODE: NEC 690.56 (C)(1) & NFPA1 11.12.2.1.1.1.1.1.1.12.2.1.4 SHALL BE REFLECTIVE, WITH ALL LETTERS CAPITALIZED AND HAVING A MINIMUM HEIGHT OF 3/8 IN. (9.5 MM), IN WHITE ON RED BACKGROUND.

LABEL LOCATION: CONDUIT/ RACEWAY/ ENCLOSURES/ COMBINER BOX/ AC DISCONNECT PER CODE: NEC2017, 690.31(G)(3)(4)

LABEL LOCATION: AC DISCONNECT/ BREAKER/ POINTS OF CONNECTION PER CODE: NEC2017, 690.13(B)

PER CODE: NEC2017, 690.54

(AC DISCONNECT) PER CODE: NEC 690.58 (C)(3)

LABEL LOCATION:
POINT OF INTERCONNECTION
PER CODE: NEC 2017, 705.12(B)

RESIDENCE

9


FRONT


LABEL LOCATION: POINT-OF-INTERCONNECTION OR AT MAIN SERVICE DISCONNECT (MSP) PER CODE: NEC 705.12(B)(2)(3)(b)

LABEL LOCATION:
ANY ELECTRICAL PANEL THAT IS FED BY
BOTH THE UTILITY AND THE PHOTOVOLTAIC SYSTEM (AC DISCONNECT, MSP) PER CODE: NEC 705.12(B)(2)(3)(C)



THIS ITEM HAS BEEN DIGITALLY SIGNED AND SEALED BY OMAR TIRADO ON THE DATE ADJACENT TO THE SEAL. PRINTED COPIES OF THIS DOCUMENT ARE NOT CONSIDERED SIGNED AND SEAL, AND THE SIGNATURE MUST BE VERIFIED ON ANY ELECTRONIC COPIES

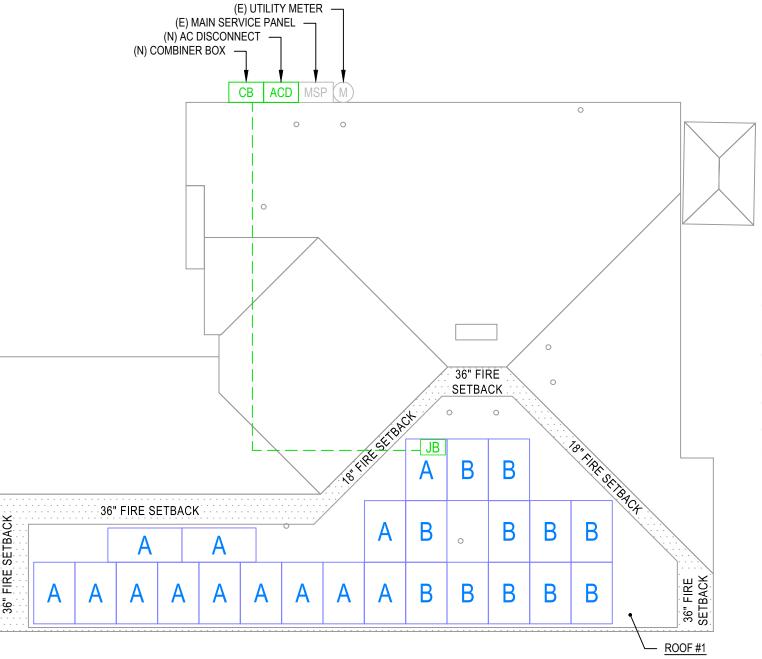

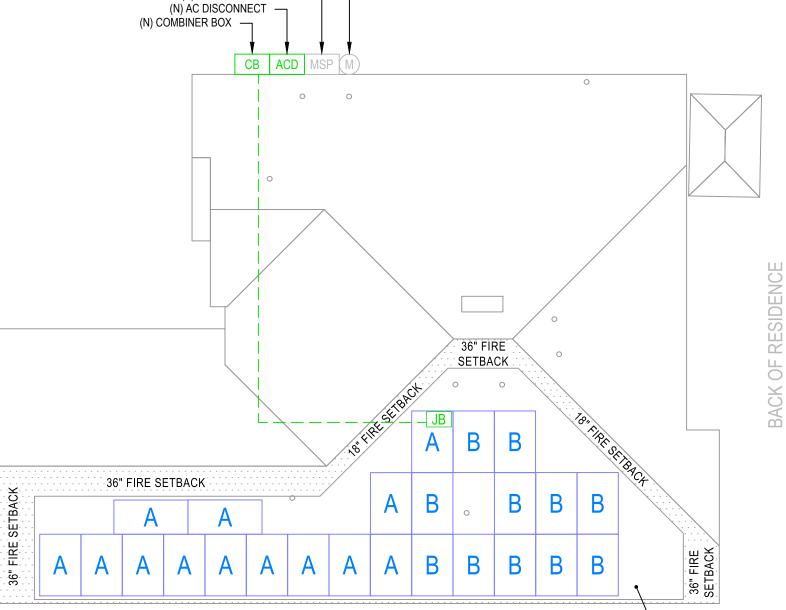

ROOF PLAN WITH STRING LAYOUT E-1

ATLANTIC KEY ENERGY LLC 12600 CHALLENGER PARKWAY SUITE 200 ORLANDO, FL 32826 1 (407) 988-0273 SOUTHWEST KIRBY AVENUE PROJECT # P-0065775 LAKE CITY, FL 32024 SEAN VASQUEZ RESIDENCE 525 SIGNATURE WITH SEAL

REVISIONS DESCRIPTION DATE REV Drawn by:

SHEET NAME

STRING LAYOUT & **SIGNAGE** SHEET NUMBER

02/01/2023

E-1

ID	INITIAL CONDUCTOR LOCATION	FINAL CONDUCTOR LOCATION	М	IIN. CONDUCTOR SIZE (AWG)	MIN. DIA CONDUIT SIZE (IN.)	# OF PARALLEL CIRCUITS	CURRENT-CARRYING CONDUCTORS IN CONDUIT	OCPD (A)		MIN. EGC SIZE (AWG)	TEMP. FAC		CONDUIT FILL FACTOR	CONT. CURRENT (A)	MAX. CURRENT (A)	BASE AMP. (A)	DERATED AMP. (A)	TERM. AMP. RATING (A)	LENGTH (FT)	VOLTAGE DROP (%)
1	STRING A	JUNCTION BOX	12	Q CABLE	N/A	1	2	N/A	6	BARE COPPER	0.76	55°C	N/A	15.73	19.66	30	N/A	N/A	55.00	0.58
2	STRING B	JUNCTION BOX	12	Q CABLE	N/A	1	2	N/A	6	BARE COPPER	0.76	55°C	N/A	13.31	16.64	30	N/A	N/A	42.00	0.92
3	JUNCTION BOX	COMBINER BOX	10	THWN-2 COPPER	0.75 LTNM	2	4	20	10	THWN-2 COPPER	0.76	55°C	0.8	15.73	19.66	40	24.3	35	53.00	0.86
4	COMBINER BOX	AC DISCONNECT	8	THWN-2 COPPER	0.75 LTNM	1	3	N/A	10	THWN-2 COPPER	0.96	34°C	1	29.04	36.30	55	52.8	35	5.00	0.09
5	AC DISCONNECT	MSP	8	THWN-2 COPPER	0.75 LTNM	1	3	40	10	THWN-2 COPPER	0.96	34°C	1	29.04	36.30	55	52.8	35	5.00	0.09



ATLANTIC KEY ENERGY LLC 12600 CHALLENGER PARKWAY SUITE 200

ORLANDO, FL 32826 1 (407) 988-0273

Lumio \*

SEAN VASQUEZ
RESIDENCE
PROJECT # P-0065775
SOUTHWEST KIRBY AVENUE
LAKE CITY, FL 32024

525

SIGNATURE WITH SEAL

REVIS	SIONS	
DESCRIPTION	DATE	REV
Orawn by:		A.A

02/01/2023

**LEGEND** 

(E) - EXISTING (N) - NEW

-5°C

34°C

1.0"

55°C

NOTE:
1. LTNM OR EQUIVALENT TYPE CONDUIT

RECORD LOW TEMP

CONDUIT HEIGHT

AMBIENT TEMP. (HIGH TEMP. 2%)

CONDUCTOR TEMP. RATE (ROOF)

DESIGN TEMPERATURE SPECIFICATIONS


SHEET NAME

ELECTRICAL LINE

DIAGRAM & CALCS.

SHEET NUMBER

E-2

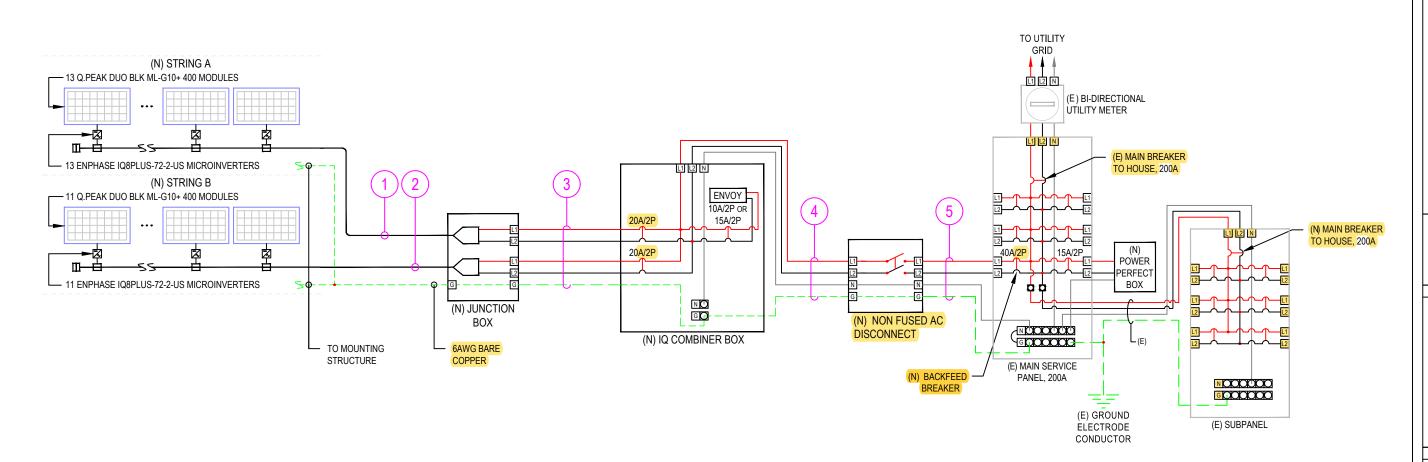




THIS ITEM HAS BEEN DIGITALLY SIGNED AND SEALED BY OMAR TIRADO ON THE DATE ADJACENT TO THE SEAL. PRINTED COPIES OF THIS DOCUMENT ARE NOT CONSIDERED SIGNED AND SEAL, AND THE SIGNATURE MUST BE VERIFIED ON ANY ELECTRONIC COPIES

1 ELECTRICAL LINE DIAGRAM
E-2 SCALE: NTS

ELECTRICAL LINE DIAGRAM

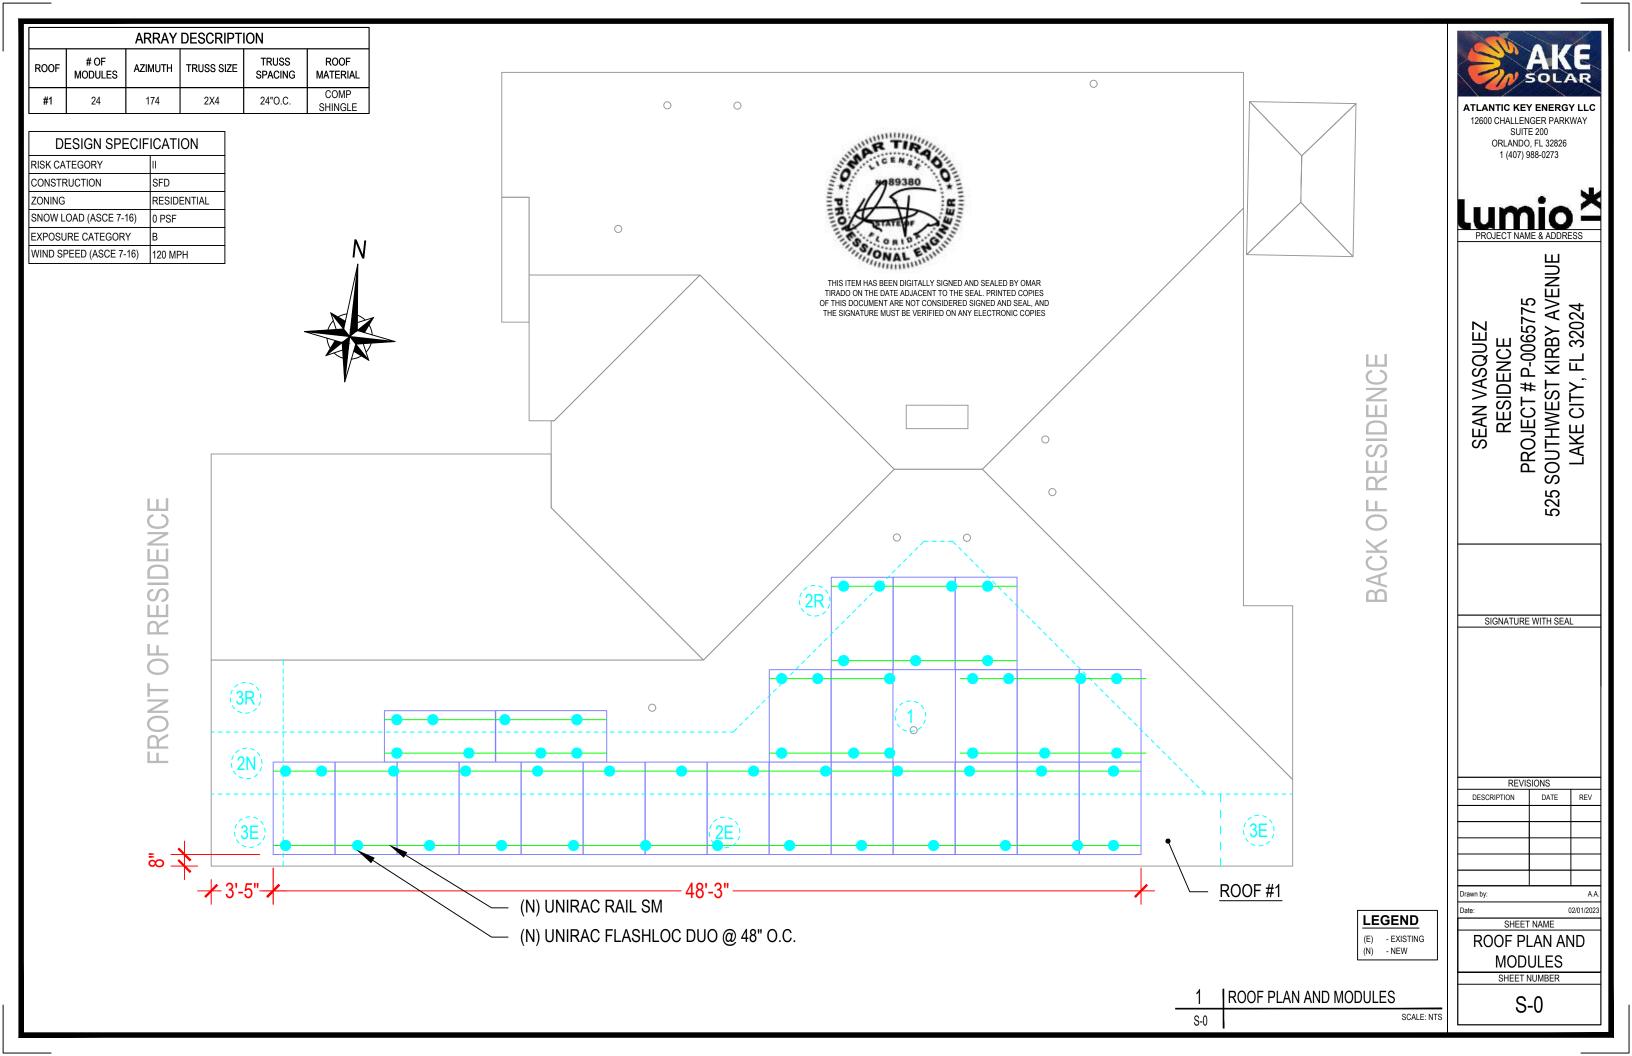

# FLASHLOC™ DUO

THE MOST VERSATILE DIRECT TO DECK ATTACHMENT



**FLASH**LOC™ **DUO** is the most versatile direct to deck and rafter attachment for composition shingle and rolled comp roofs. The all-in-one mount installs fast — no kneeling on hot roofs to install flashing, no prving or cutting shingles, no pulling nails. Simply drive the required number of screws to secure the mount and inject sealant into the base. **FLASH**LOC's patented TRIPLE SEAL technology preserves the roof and protects the penetration with a permanent pressure seal. Kitted with two rafter screws, sealant and hardware for maximum convenience (deck screws sold separately). Don't just divert water, LOC it out!







### PROTECT THE ROOF

Install a high-strength waterproof attachment without lifting, prying or damaging shingles.

APRIL2021\_FLASHLOCDUO\_V1



### **LOC OUT WATER**

technology delivers a 100% waterproof connection.




### HIGH-SPEED INSTALL

With an outer shield 1 contour-conforming gasket
2 and pressurized sealant chamber 3 the Triple Seal
sealant into the port 4 to create a permanent pressure

## FASTER INSTALLATION. 25-YEAR WARRANTY.

FOR QUESTIONS OR CUSTOMER SERVICE VISIT UNIRAC.COM OR CALL (505) 248-2702

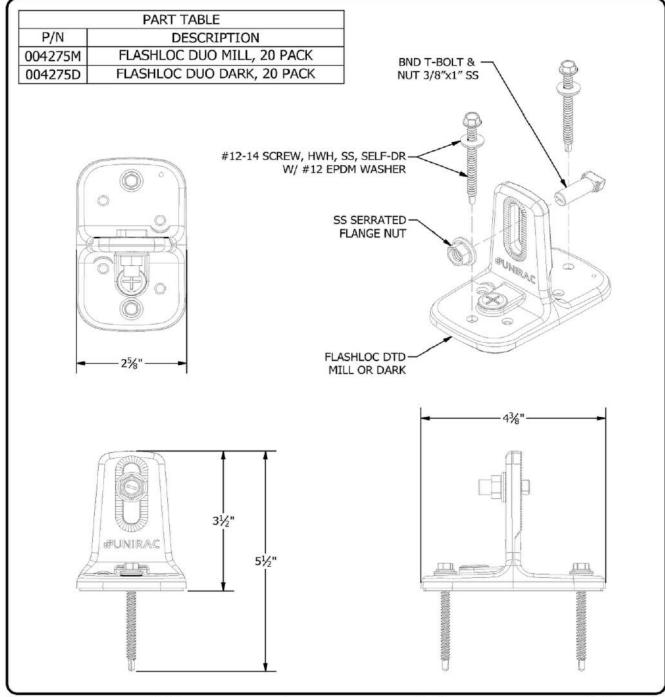



1411 BROADWAY BLVD. NE ALBUQUERQUE, NM 87102 USA PHONE: 505.242.6411 WWW.UNIRAC.COM

PRODUCT LINE: SOLARMOUNT DRAWING TYPE: ASSEMBLY DETAIL FLASHLOC DUO KI DESCRIPTION: 4/29/2021 REVISION DATE:

DRAWING NOT TO SCALE ALL DIMENSIONS ARE NOMINAL

PRODUCT PROTECTED BY ONE OR MORE US PATENTS LEGAL NOTICE

FL-A04 SHEET

**SPECIFICATIONS** 

SHEET NUMBER

ATLANTIC KEY ENERGY LLC 12600 CHALLENGER PARKWAY SUITE 200 ORLANDO, FL 32826 1 (407) 988-0273 PROJECT # P-0065775 SOUTHWEST KIRBY AVENUE SEAN VASQUEZ

RESIDENCE LAKE CITY, FL

SIGNATURE WITH SEAL

REVISIONS DESCRIPTION DATE REV

SHEET NAME **EQUIPMENT** 

02/01/2023

S-1

# SOLARMOUNT



**SOLARMOUNT** defined the standard in solar racking. Features are designed to get installers off the roof faster. Our grounding & bonding process eliminates copper wire and grounding straps to reduce costs. Systems can be configured with standard or light rail to meet your design requirements at the lowest cost possible. The superior aesthetics package provides a streamlined clean edge for enhanced curb appeal, with no special brackets required for installation.









System grounding through Enphase microinverters and trunk cables Light Rail is Fully Compatible with all SM Components



Featuring Google Map Capabilities within U-Builder

# **FAST INSTALLATION. SUPERIOR AESTHETICS**

OPTIMIZED COMPONENTS . VERSATILITY . DESIGN TOOLS . QUALITY PROVIDER

# **SOLAR**MOUNT

# **#UNIRAC**


## **OPTIMIZED COMPONENTS** INTEGRATED BONDING & PRE-ASSEMBLED PARTS

labor time. Our new grounding & bonding process eliminates copper wire and grounding straps or bonding jumpers to reduce costs. Utilize the micromverter mount with a wire

### ONE PRODUCT - MANY APPLICATIONS

Quickly set modules flush to the roof or at a desired tilt angle. Change module to outperform your projects financial and aesthetic aspirations

Save time by creating a user profile, and recall preferences and projects automatically when you log in. You will enjoy the ability to share projects with customers: there's no

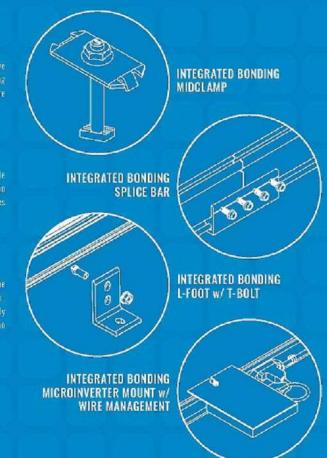



## UNIRAC CUSTOMER SERVICE MEANS THE HIGHEST LEVEL OF PRODUCT SUPPORT



TECHNICAL SUPPORT





CERTIFIED QUALITY PROVIDER







## **BANKABLE WARRANTY**

Don't leave your project to chance. Unitac has the financial strength to back our products and reduce your risk. Have peace quality. SOLARMOUNT is covered by a twenty five (25) year

PROTECT YOUR REPUTATION WITH QUALITY RACKING SOLUTIONS BACKED BY ENGINEERING EXCELLENCE AND A SUPERIOR SUPPLY CHAIN

ATLANTIC KEY ENERGY LLC 12600 CHALLENGER PARKWAY SUITE 200

ORLANDO, FL 32826 1 (407) 988-0273



PROJECT # P-0065775 SOUTHWEST KIRBY AVENUE SEAN VASQUEZ RESIDENCE LAKE CITY, FL

SIGNATURE WITH SEAL

REVISIONS DESCRIPTION DATE

02/01/202 SHEET NAME


**EQUIPMENT SPECIFICATIONS** 

> SHEET NUMBER S-2

## Q.PEAK DUO BLK ML-G10+ SERIES

### ■ Mechanical Specification

Format	74.0 in × 413 in × 1.26 in (including frame) (1879 mm × 1045 mm × 32 mm)
Weight	48.5 lbs (22.0 kg)
Front Cover	0:13 in (3.2 mm) thermally pre-siressed glass with anti-reflection technology
Back Cover	Composite film
Frame	Black anadised aluminium
Cell	6 × 22 monocrystalline Q.ANTUM solar half cells
Junction box	2.09-3.98 in ×1.26-2.36 in × 0.59-0.71 in (53-101 mm × 32-60 mm × 15-18 mm), IP67, with bypass diodes
Cable	4 mm² Solar cable; (+) ≥ 49.2 in (1250 mm), (-) ≥ 49.2 in (1250 mm)
Connector	Staubii MC4; IP68

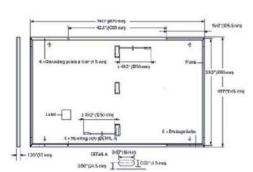

### ■ Electrical Characteristics

P	OWER CLASS			385	390	395	400	405
М	NIMUM PERFORMANCE AT STANDARD	TEST CONDITIONS, ST	C! (POWER TOLERA)	NCE+5W/-OW)				
	Power at MPP <sup>4</sup>	Prop	[W]	385	390	395	400	405
**	Short Circuit Current <sup>1</sup>	lsc	(A)	11.04	11.07	11.10	11,14	11.17
mu	Open Circuit Voltage <sup>1</sup>	Voc	(V)	45.19	45.23	45.27	45.3	45.34
in the	Current at MPP	I <sub>spe</sub>	[A]	10.59	10.65	10.71	10.77	10,83
2	Voltage at MPP	Vser	[V]	36,36	36.62	36,88	37,13	37.39
	Efficiency <sup>1</sup>	n	[96]	≥19.6	≥19.9	≥20.1	≥20.4	≥20.6

### MINIMUM PERFORMANCE AT NORMAL OPERATING CONDITIONS, NIMOT?

	Power at MPP	Page	[W]	288.8	292.6	296,3	3001	303.8
E	Short Circuit Current	l <sub>sc</sub>	[A]	8,90	8.92	8.95	8.97	9.00
Ĕ	Open Circuit Voltage	Voc	(V)	42.62	42.65	42.69	42.72	42.76
ž	Current at MPP	l <sub>upp</sub>	[A]	8.35	8.41	8.46	8.51	8.57
	Voltage at MPP	V <sub>MP</sub>	[V]	34.59	34.81	35.03	35.25	35.46

"Measurement tolerances P<sub>mp</sub> ±3%; I<sub>sc</sub>: V<sub>oc</sub> ±5% at STC: 1000 W/m², 25±2°C, AM 1.5 according to IEC 60904.3 • <sup>2</sup>800 W/m², NMOT, spectrum AM 1.5


### **Qcells PERFORMANCE WARRANTY**

At least SR % of nominal power during first year. Thereafter max 0.5% degradation per year. At least 93.5% of nominal power up to 10 years. At least 86% of nominal power up to 25 years.

All data within measurement tolerances. Full warrantes in accordance with the warranty erms of the Qcells sales organisation of your respective

"Standard terms of guarantee for the 5 PV companies with the highest production capacity in 2021 (Fatherary 2021)

### PERFORMANCE AT LOW IRRADIANCE

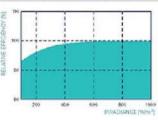

Typical module performance under low irradiance conditions in comparison to STC conditions (25°C, 1000Wm²).

TEMPERATURE COEFFICIENTS							
Temperature Coefficient of I <sub>sc</sub>	а	[%/K]	+0.04	Temperature Coefficient of V <sub>oc</sub>	β	[%/K]	-0.27
Temperature Coefficient of Purp	Y	[%/K]	-0.34	Naminal Module Operating Temperature	NMOT	[F]	109±5.4

### ■ Properties for System Design

Maximum System Voltage	Vovs	[N]	1000 (IEC)/1000 (UL)	PV module classification	Class II
Maximum Series Fuse Rating		[A DC]	20	Fire Rating based on ANSI/UL 61730	TYPE 2
Max. Design Load, Push/Pull <sup>2</sup>		[lbs/ff <sup>2</sup> ]	75 (3600 Pa) / 55 (2660 Pa)	Permitted Medule Temperature	-40°F up to +185°F
May Tost Load Push / Pull <sup>3</sup>		fibs/#	113 (5400 Pa) / 84 (4000 Pa)	on Cantinuous Duty	(-40°C up to +85°C)

See Installation Manual

### Qualifications and Certificates

UL 61730, CE-compliant, Quality Controlled PV - TUV Pheinland, IEC 612:15(2016, IEC 61730; 2016, U.S. Patent No. 9:893,215 (solar cells).









### *<u>acells</u>*

### IQ8 and IQ8+ Microinverters

IMPUT DATA (DC)		108-60-5-02	109PLUS-72-2-US			
Commonly used module pairings*	w	235 - 350	235 - 440			
Module compatibility		60-cell/120 half-cell	60-cell/120 half-cell and 72-cell/144 half-cell			
MPPT voltage range	v	27 - 37	29 - 45			
Operating range	v	25 - 48	25 - 58			
Min/max start voltage	v	30 / 48	30 / 58			
Max input DC voltage	v	50	60			
Max DC current* [module isc]	А		15			
Overvoltage class DC port			1			
DC port backfeed current	mA		0			
PV array configuration		Ix l'Ungrounded array; No additional DC side protectio	n required; AC side protection requires max 20A per branch circuit			
OUTPUT DATA (AC)		108-60-2-05	108PLUS-72-2-US			
Peak output power	VA	245	300			
Max continuous output power	VA	240	290			
Nominal (L-L) voltage/range <sup>3</sup>	V	2	40 / 211 - 264			
Max continuous output current	А	1.0	1.21			
Nominal frequency	Hz		60			
Extended frequency range	Hz		50 - 68			
Max units per 20 A (L-L) branch circu	it*	16	13			
Total harmonic distortion			€5%			
Overvoltage class AC port			ш			
AC port backfeed current	mA		30			
Power factor setting			1.0			
Grid-tied power factor (adjustable)		O.85 les	ading - 0.85 lagging			
Peak efficiency	%	97.5	97.6			
CEC weighted efficiency	%	97	97			
Night-time power consumption	m/A		60			
HECHANICAL DATA						
Ambient temperature range		-40°C to +	60°C (-40°F to +140°F)			
Relative humidity range		496 to	100% (condensing)			
DC Connector type			MC4			
Dimensions (HxWxD)		212 mm (8.3") x 175 mm (6.9") x 30.2 mm (1.2")				
Weight		1.08 kg (2.38 lbs)				
Cooling		Natural	convection - no fans			
Approved for wet locations			Yes			
Acoustic noise at 1 m			<60 dBA			
			222			

CA Rule 21 (UL 1741-SA), UL 62109-1, UL1741/IEEE1547, FCC Part 15 Class B, ICES-0003 Class B, CAN/CSA-C22.2 NO. 107.1-01 Certifications This product is UL Listed as PV Rapid Shut Down Equipment and conforms with NEC 2014, NEC 2017, and NEC 2020 section 690.12 and C22.1-2018 Rule 64-218 Rapid Shutdown of PV Systems, for AC and DC conductors, when installed according to manufacturer's instructions.

Class II double-insulated, corrosion resistant polymeric enclosure

NEMA Type 6 / outdoor

(1) No enforced DC/AC ratio. See the compatibility calculator at https://link.enphase.com/ module-compatibility (2) Maximum continuous input DC current is 10.6A (3) Nominal voltage range can be extended beyond nominal if required by the utility. (4) Limits may vary. Refer to local requirements to define the number of microinverters per branch in your area.

Environ, category / UV exposure rating

IQ8SP-DS-0002-01-EN-US-2021-10-19

ATLANTIC KEY ENERGY LLC 12600 CHALLENGER PARKWAY

SUITE 200 ORLANDO, FL 32826 1 (407) 988-0273



PROJECT # P-0065775 5 SOUTHWEST KIRBY AVENUE LAKE CITY, FL 32024 SEAN VASQUEZ RESIDENCE 525

SIGNATURE WITH SEAL

REVISIONS DESCRIPTION DATE REV

02/01/2023

SHEET NAME **EQUIPMENT SPECIFICATIONS** 

SHEET NUMBER

E-3

### Enphase IQ Combiner 4/4C

MODEL NUMBER						
IQ Combiner 4 (X IQ-AM1 240-4)	Q Combiner 4 with Emphase IQ Gateway printed circuit board for Integrated revenue grade PV production metering (ANS 0.12.20 4/-0.5%) and consumption monitoring (4/-2.5%). Includes a silver solar shield to match the IQ Battery system an IQ System Controller 2 and to deflect heat.					
IQ Combiner 4C (X-IQ-AM1-240-4C)	IQ Combiner 4C with Enphase IQ Gateway printed circuit board for integrated revenue grade PV production metering (ANSI C12.20 */-0.5%) and consumption monitoring (*/-2.5%). Includes Enphase Mobile Connect cellular modem (CELLMODEM-MT-06-SP-05), a plug-and-play industrial-grade cell modem for systems up to 60 microinverters. (Available in the US, Canada, Mexico, Puerto Rico, and the US Virgin Islands, where there is adequate cellular service in the installation area.) Includes a silver solar shield to match the IQ Battery and IQ System Controller, and to deflect hea					
ACCESSORIES AND REPLACEMENT PARTS	(not included, order separately)					
Ensemble Communications Kit COMMS-CELLMODEM-M1-D6 CELLMODEM-M1-06-SP-05 CELLMODEM-M1-06-AT-05	- Includes COMMS-KIT-01 and CELLMODEM-M1-06-SP-05 with 5-year Sprint data plan for Ensemble sites - 40 based LTE-M1 cellular modem with 5-year Sprint data plan - 40 based LTE-M1 cellular modem with 5-year AT&T data plan					
Circuit Breakers BRK-10A-2-240V BRK-15A-2-240V BRK-20A-2P-240V BRK-15A-2P-240V-B BRK-20A-2P-240V-B	Supports Eaton BR210, BR215, BR220, BR230, BR240, BR250, and BR260 circuit breakers. Circuit breaker, 2 pole, 10A, Eaton BR210 Circuit breaker, 2 pole, 15A, Eaton BR215 Circuit breaker, 2 pole, 20A, Eaton BR220 Circuit breaker, 2 pole, 15A, Faton BR2158 with hold down kit support Circuit breaker, 2 pole, 20A, Eaton BR2208 with hold down kit support					
EPLC-61	Power line carrier (communication bridge pair), quantity - one pair					
XA-SOLARSHIELD-ES	Replacement solar shield for IQ Combiner 4/4C					
XA-PLUG-120-3	Accessory receptacle for Power Line Carrier in 1Q Combiner 4/4C (required for EPLC-01)					
XA-ENV-PC8A-3	Replacement IQ Gateway printed circuit board (PCB) for Combiner 4/4C					
X-IQ-NA-HD-125A	Hold down kit for Eaton elicult breaker with screws.					
ELECTRICAL SPECIFICATIONS						
Rating	Continuous duty					
System voltage	120/240 YAC, 60 Hz					
Eafon BR series busbar rating	125 A					
Max. continuous current rating	65A					
Max. continuous current rating (input from PV/storage)	64 A					
Max. fuse/circuit rating (output)	90 A					
Branch circuits (solar and/or storage)	Up to four 2-pole Eaton BR series Distributed Generation (DG) breakers only (not included)					
Max. total branch circuit breaker rating (input)	80A of distributed generation / 95A with IQ Gateway breaker included					
Production metering CT	200 A solid core pre-installed and wired to IQ Gateway					
Consumption monitoring CT (CT-200-SPLIT)	A pair of 200 A split core current transformers					
MECHANICAL DATA						
Dimensions (WxHxD)	37.5 x 49.5 x 16.8 cm (14.75" x 19.5" x 6.63"). Height is 21.06" (53.5 cm) with mounting brackets.					
Weight	7.5 kg (16.5 lbs)					
Ambient temperature range	-40° C10 +46° C (-40° to 115° F)					
Cooling	Natural convection, plus heat shield					
Enclosure environmental rating	Outdoor, NRTL-certified, NEMA type 3R, polycarbonate construction					
Wire sizes	20 A to 50 A breaker inputs: 14 to 4 AWG copper conductors 60 A breaker branch input; 4 to 1/0 AWG copper conductors Main lug combined output: 10 to 2/0 AWG copper conductors Neutral and ground: 14 to 1/0 copper conductors Always follow local code requirements for conductor sizing.					
Altitude	To 2000 meters (6,560 feet)					
INTERNET CONNECTION OPTIONS						
Integrated Wi-Fi	802.11b/g/n					
Cellular	CELLMODEM-M1-D6-SP-05, CELLMODEM-M1-06-AT-05 (4G based LTE-M1 cellular modern). Note that an Enphase Mobile Connect cellular modern is required for all Ensemble installations.					
Ethernet	Optional, 802.3, Cat5E (or Cat 6) UTP Ethernet cable (not included)					
COMPLIANCE						
Compliance, Q Combiner	UL 1741, CAN/CSA C22.2 No. 107.1, 47 CFR, Part 15, Class B, ICES 003 Production metering: ANSI C12.20 accuracy class 0.5 (PV production) Consumption metering: accuracy class 2.5					
Compliance, IQ Gateway	UL 60601-1/CANGSA 22.2 No. 61010-1					

To learn more about Enphase offerings, visit enphase.com
© 2021 Enphase Energy, All rights reserved, Enphase, the Enphase logo, IQ Combiner 4/4C, and other names are trademarks of Enphase Energy, Inc. Data subject to change. 10-21-2021



12600 CHALLENGER PARKWAY SUITE 200 ORLANDO, FL 32826 1 (407) 988-0273

SEAN VASQUEZ
RESIDENCE
PROJECT # P-0065775
525 SOUTHWEST KIRBY AVENUE
LAKE CITY, FL 32024

SIGNATURE WITH SEAL

REVISIONS DESCRIPTION DATE REV

02/01/2023

SHEET NAME **EQUIPMENT** 

**⊖** ENPHASE.

**SPECIFICATIONS** SHEET NUMBER

E-4