




STEM WALL FOOTING SCALE: 1/2" = 1'-0"

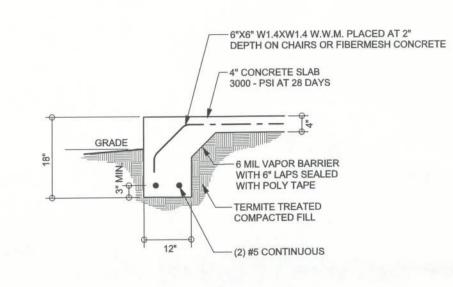


## MONOLITHIC FOOTING SCALE: 1/2" = 1'-0"

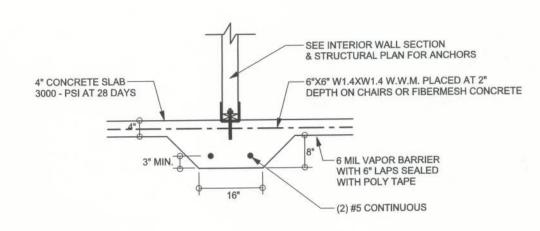

F2 INTERIOR BEARING FOOTING S-2 SCALE: 1/2" = 1'-0"

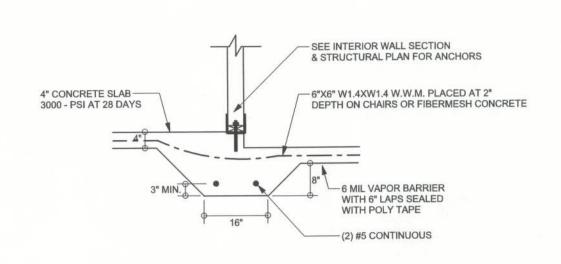

INTERIOR BEARING STEP FOOTING S-2 SCALE: 1/2" = 1'-0"

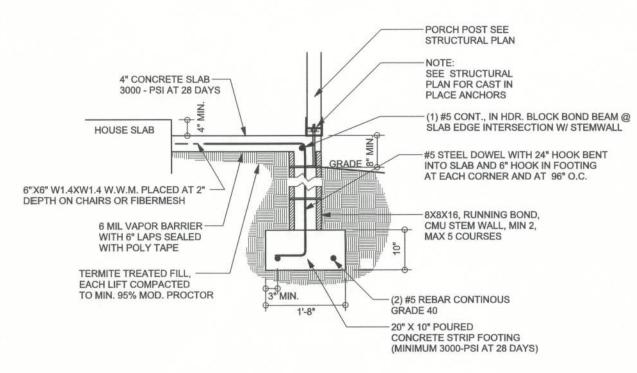


ALT. STEM WALL PORCH FOOTING S-2 SCALE: 1/2" = 1'-0"

## TALL STEM WALL TABLE


The table assumes 60 ksi reinforcing bars with 6" hook in the footing and bent 24" into the reinforced slab at the top. The vertical steel is to be placed toward the tension side of the CMU wall (away from the soil pressure, within 2" of the exterior side of the wall). If the wall is over 8' high, add Durowall ladder reinforcement at 16"OC vertically or a horizontal bond beam with 1#5 continuous at mid height. For higher parts of the wall 12" CMU may be used with reinforcement as shown in the table below.

STEMWALL HEIGHT (FEET)	UNBALANCED BACKFILL HEIGHT	VERTICAL REINFORCEMENT FOR 8" CMU STEMWALL (INCHES O.C.)			VERTICAL REINFORCEMENT FOR 12" CMU STEMWALL (INCHES O.C.)		
		#5	#7	#8	#5	#7	#8
3.3	3.0	96	96	96	96	96	96
4.0	3.7	96	96	96	96	96	96
4.7	4.3	88	96	96	96	96	96
5.3	5.0	56	96	96	96	96	96
6.0	5.7	40	80	96	80	96	96
6.7	6.3	32	56	80	56	96	96
7.3	7.0	24	40	56	40	80	96
8.0	7.7	16	32	48	32	64	80
8.7	8.3	8	24	32	24	48	64
9.3	9.0	8	16	24	16	40	48

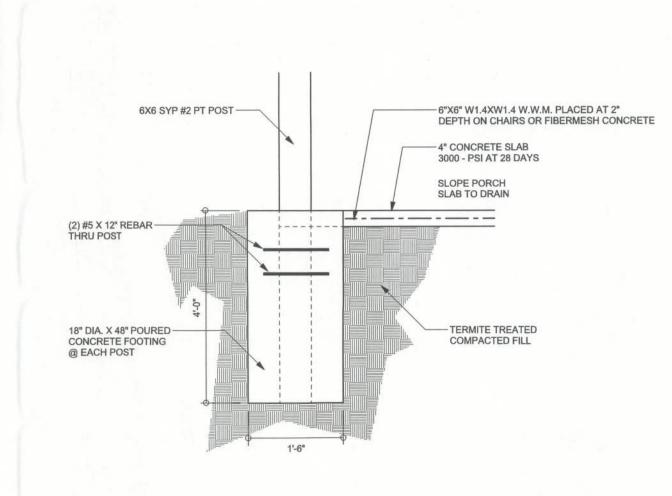

(F15) CARPORT POST FOUNDATION S-2 SCALE: 1/2" = 1'-0"

FLOOR PLAN FOR ACTUAL DIMENSIONS

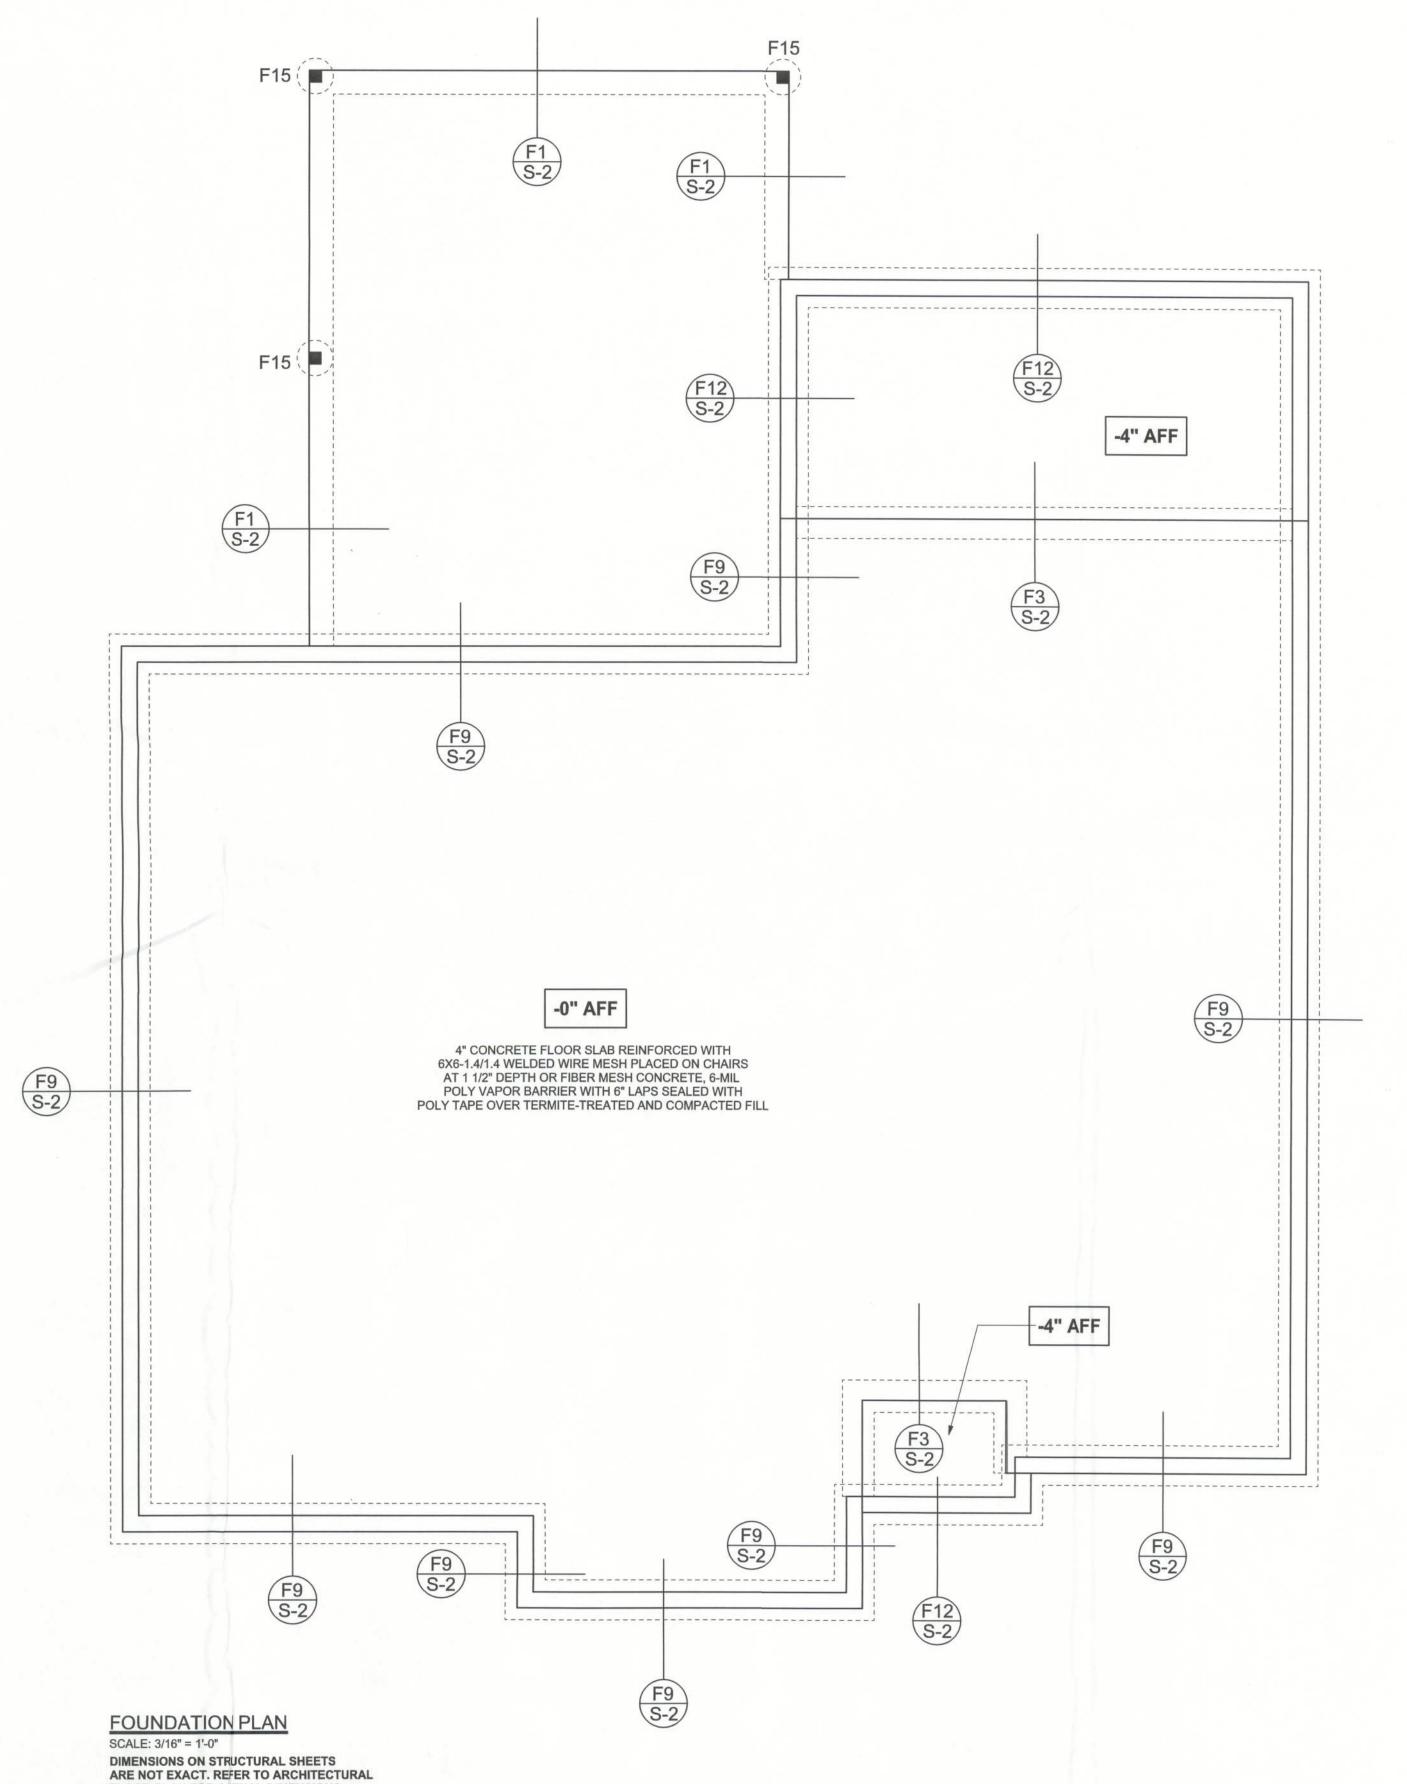

REVISIONS 4Feb10

WINDLOAD ENGINEER: Mark Disosway, PE No.53915, POB 868, Lake City, FL 32056, 386-754-5419 DIMENSIONS: Stated dimensions supercede scaled

dimensions. Refer all questions to Mark Disosway, P.E. for resolution. Do not proceed without clarification. COPYRIGHTS AND PROPERTY RIGHTS: Mark Disosway, P.E. hereby expressly reserves its common law copyrights and property right in these instruments of service. This document is not to be reproduced, altered or copied in any form or manner without first the express written permission and consent of Mark Discourse.

of Mark Disosway. CERTIFICATION: I hereby certify that I have examined this plan, and that the applicable portions of the plan, relating to wind engineering comply with section R301.2.1, florida building code residential 2007, to the best of my knowledge.

LIMITATION: This design is valid for one building, at specified location.

Bryan Zecher Construction

Crews Residence

ADDRESS: Columbia County, FL

Mark Disosway P.E. P.O. Box 868 Lake City, Florida 32056 Phone: (386) 754 - 5419 Fax: (386) 269 - 4871

PRINTED DATE: April 27, 2010 STRUCTURAL BY: DRAWN BY:

FINALS DATE: 27Apr10

David Disosway

JOB NUMBER: 1004060

> **S-2** OF 3 SHEETS

DRAWING NUMBER