### FLORIDA BUILDING CODE

### Compliance Summary

#### TYPE OF CONSTRUCTION

Roof: Gable Construction, existing 2x6 Rafters @ 24" O.C. & Wd.Trusses Walls: Existing Norwegian Brick Floor: Existing 4" Thk Concrete Slab

#### Foundation: Existing ROOF DECKING

Material: 1/2" CD Plywood or 7/16" O.S.B. Sheet Size: 48"x96" Sheets Perpendicular to Roof Framing Fasteners: 8d Common Nails per schedule on sheet 4

#### HURRICANE UPLIFT CONNECTORS

Rafter Anchors: Simpson H2.5a @ Ea. Truss End (Typ. U.O.N.) Wall Tension: All Thread Rod per Plan, sheet 3 Post Anchor: Simpson ABU44 Beam to Post: Simpson PC44 / EPC44

#### FOOTINGS AND FOUNDATIONS

Footing: Existing

ALL WIND LOADS ARE IN ACCORDA FLORIDA BUILDING CODE	를 하고 있었다. 물리가 있었다면 경기를 가고 있다. 그 경기 전하면 경기 하는 나를 하는 것 같아 나를 하는 것이다.
BASIC WIND SPEED:	130 MPH
JIND IMPORTANCE FACTOR (1):	1 = 1.00
UILDING CATAGORY:	CATAGORY II
IND EXPOSURE:	"B"
ITERNAL PRESSURE COEFFICIENT:	+/- Ø.18
WFRS PER TABLE 16092A (FBC 2010) ESIGN WIND PRESSURES:	ROOF: - 322 PSF WALLS: + 26.8 PSF EAVES: + 45.1 PSF

L		27	BUILDING O		CLADDING = 300', EXP	
	ZONE	AREA	Yult 110 MPH	Yult 120 MPH	Yult 130 MPH	Yult 140 MPH
	1 1 1	10 20 50	12.0 / -19.9 11.4 / -19.4 10.0 / -18.6	14.9 / -23.7 13.6 / -23.0 11.9 / -22.2	17.5 / -27.8 16.0 / -27.0 13.9 / -26.0	203 / -323 185 / -31.4 16.1 / -302
T 10 2T	2 2 2	10 20 50	12.5 / -34.7 11.4 / -31.9 10.0 / -282	14.9 / -41.3 13.6 / -38.0 11.9 / -33.6	17.5 / -48.4 16.0 / -44.6 13.9 / -39.4	203 / -563 185 / -51.7 16.1 / -45.7
ROOF	3 3 3	10 20 50	12.5 / -51.3 11.4 /-47.9 10.0 / -43.5	14.9 / -61.0 13.6 / -57.1 11.9 / -51.8	17.5 / -71.6 16.0 / -67.0 13.9 / -60.8	203 / -83.1 185 / -77.7 16.1 / -70.5
1	4 4 4	10 20 50	21.8 / -23.6 20.8 / -22.6 19.5 / -21.3	25.9 / -34.7 24.7 / -26.9 23.2 / -25.4	30.4 / -33.0 29.0 / -31.6 27.2 / -29.8	35.3 / -382 33.7 / -36. 31.6 / -34.6
MALL	555	10 20 50	21.8 / -29.1 20.8 / -27.2 19.5 / -24.6	25.9 / -34.7 24.7 / -32.4 23.2 / -29.3	30.4 /-40.7 29.0 / -38.0 27.2 / -34.3	35.3 / -47.2 33.7 / -44.6 31.6 / -39.8

#### HEIGHT & EXPOSURE ADJUSTMENT COEFFICIENTS FOR BUILDING COMPONENTS & CLADDING

BLDG HEIGHT	EXPOSURE "B"	EXPOSURE "C"	EXPOSURE
15	1.00	1.21	1.47
20	1.00	129	1.55
25	1.00	1.35	161
30	1.00	1.40	166

### PROJECT INFORMATION / NOTES:

## DESIGN VALUES/LOADS & CODES

WIND DESIGN SPEED: 110 MPH, UNLESS NOTED OTHERWISE

### SOIL DESIGN STATEMENT:

FOOTING DESIGN IS BASED UPON 1500PSF SOIL BEARING PRESSURE PRO-VIDED BY CLEAN SAND, GRAVEL OR STONE. OTHER SOIL CONDITIONS Ie: CLAY, HIGH LEVEL OF ORGANICS OR OTHER UNDESIRABLE SOILS SHALL REQUIRE FOUNDATION MODIFACATIONS.

LIVE LOADS: 1st FLOOR: 40PSF, 2nd FLOOR: 30PSF, ROOF: AS DETERMINED BY SHAPE FACTORS APPLIED TO THE WIND FORCE GENERATED BY THE DESIGN WIND SPEED.

BUILDING CODE: 2004 FLORIDA RESIDENTIAL BUILDING CODE

ELECTRICAL CODE: NATIONAL ELECTRICAL CODE - LATEST LIFE SAFETY: NFPA-101 - LATEST

### CONSTRUCTION DOCUMENTS


THE CUSTOMER IS RESPONSIBLE FOR DELIVERING THE REQUIRED SETS OF CONSTRUCTION DOCUMENTS TO THE PERMIT ISSUING AUTHORITIES, FOR THE ISSUANCE OF CONSTRUCTION PERMITS. THE CONTRACTOR SHALL REVIEW THE CONSTRUCTION DOCUMENTS AND VERIFY ALL DIMENSIONS. ANY DIS-CREPANCIES SHALL BE REPORTED TO THE ARCHITECT PRIOR TO THE COMMENCEMENT OF ANY WORK OR FABRACATION OF ANY MATERIALS.

### DO NOT SCALE OFF THESE PLANS


AMPLE DIMENSIONS ARE SHOWN ON THE PLANS TO LOCATE ALL ITEMS. SIMPLE ARITHMETIC MAY BE USED TO DETERMINE THE LOCATIONS OF THOSE ITEMS NOT DIMENSIONED.

# CHANGES TO FINAL PLAN SETS


PLEASE DO NOT MAKE ANY STRUCTURAL CHANGES TO THESE PLANS WITHOUT CONSULTING WITH THE ARCHITECT. THE OWNER SHALL ASSUME ANY AND ALL LIABILITY FOR STRUCTURAL DAMAGE RESULTING FROM CHANGES MADE TO THE PLANS OR BY SUBSTITUTION OF MATERIALS DIFFERENT FROM SPECIFICATION ON THE PLANS.

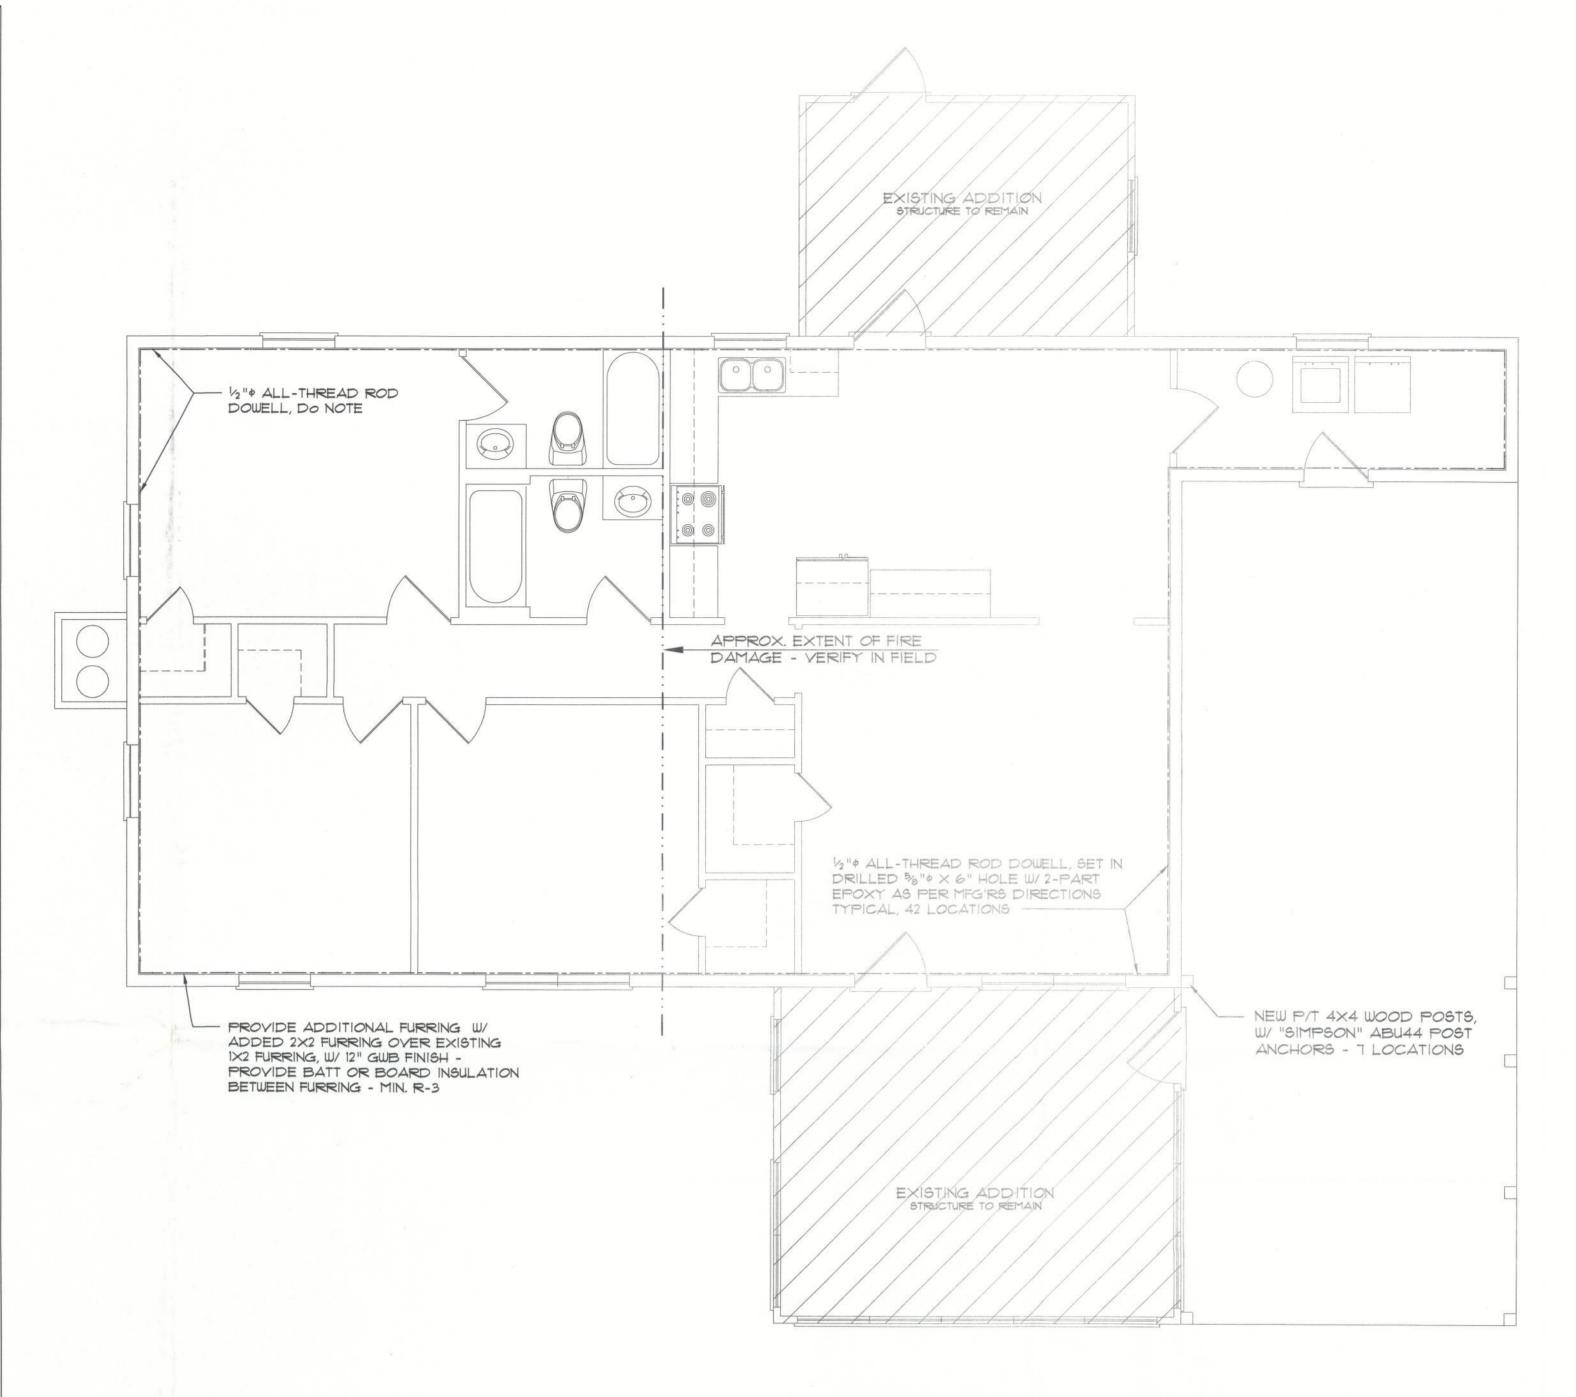


# WALL REINFORCING PLAN SCALE: 1/4" = 1'-0"

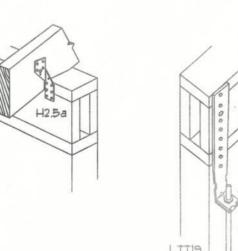




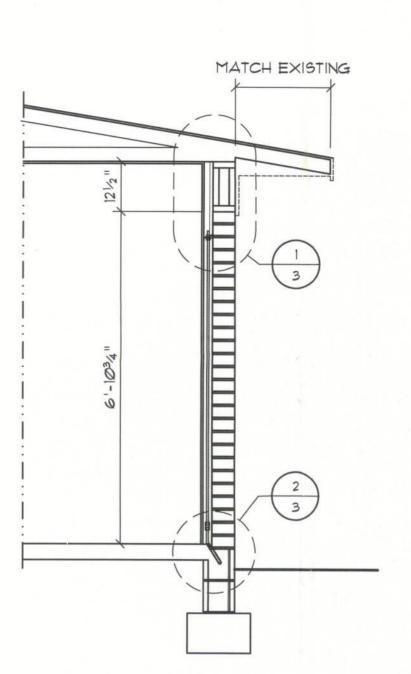

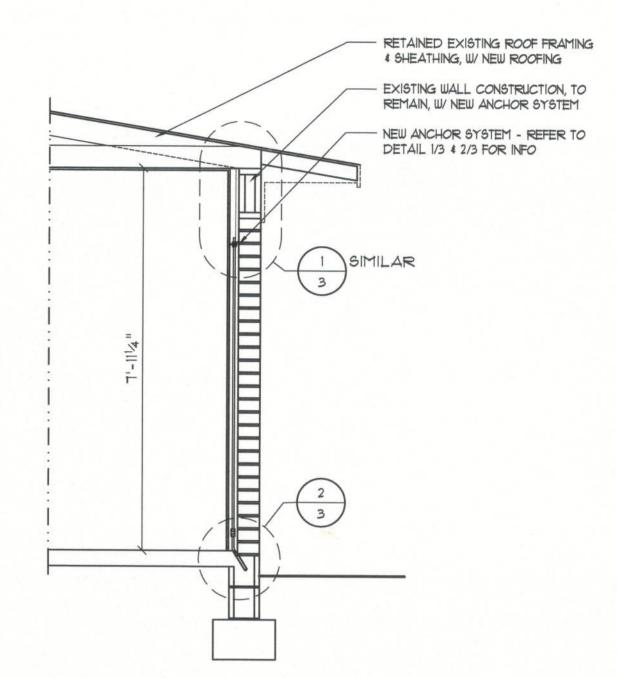


WALL SECTION SCALE: 1/2" = 1'-0"



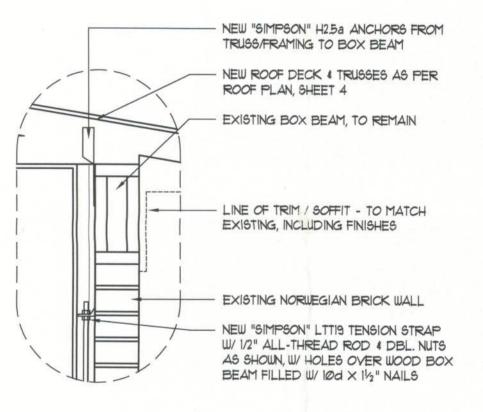



DETAIL SCALE: 1" = 1'-0"

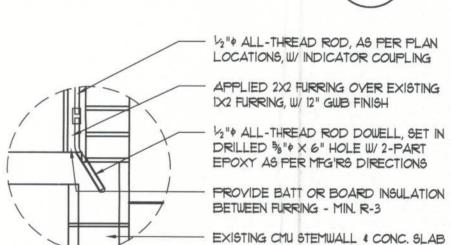



DETAIL SCALE: 1" = 1'-0"

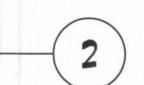

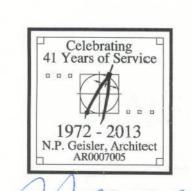

U 25 Am 2013



FILE: 2K1325	FIRE DAMAGE RESTORATION & REMODEL By Bryan Zecher Construction	SHEET:
DATE: 24APR2O13	by Bryan Zecher Construction	CAD FILE: ZFD-WS
DRAWN: NPG	NICHOLAS	REV:
CHECK: NPG	PAUL GEISLER  1758 NW Brown Road Lake City, FL 32055 N.C.A.R.B. Certified 386/365-4355	REV: