

December 31, 2020

Mr. Thomas Campbell Florida Department of Business and Professional Regulation 2601 Blair Stone Road, Building C Tallahassee, Florida 32399-6563

RE: Plan Approval

Graceland Portable Buildings

Plan # GPB SLB-20

Dear Mr. Campbell,

Pursuant to the requirements of the Department of Business & Professional Regulation, the above referenced documents have been reviewed for compliance with:

2020 Florida Building Code, 7th Edition 2017 National Electrical Code (NFPA-70) Florida Product Approval Rule 61G20-3.006 (FAC)

All mandatory comments have been satisfied and plans are approved for construction by a currently approved modular building manufacturer.

These documents were reviewed for only what is to be constructed in the factory. Any work performed at the site, such as the foundation, is under the authority and jurisdiction of the local Building Official.

Third Party Agency approval in no way alleviates the builder/manufacturer from complying with all the applicable codes, which may or may not be identified in this review. Approval also does not preclude the local building official from requiring work be performed that was not previously reviewed, approved, and constructed under the State of Florida's Manufactured (Modular) Building Program to make the building, code compliant, for the intended use.

A signed and sealed set of plans are maintained on file with Top Line Engineering, LLC.

If you require my assistance in any way, please do not hesitate to contact me.

Thank you.

Respectfully.

William E. Neary, III Business Partner

Top Line Engineering, LLC

BILL.TLE@vahoo.com

*** Please note: Any questions regarding local permitting should be directed to the Manufacturer. The Manufacturer's contact information can be found in the title block of the plans.

2020 FBC, 7th Edition 2017 NATIONAL ELECTRICAL CODE (NFPA-70)
RESIDENTIAL LAWN STORAGE
GRACELAND PORTABLE BUILDINGS
TOP LINE ENGINEERING, LLC
SLB-2020
V-B
В
NO
UTILITY
1
150 MPH – EXPOSURE: C 3 SECOND GUST
0 HOUR
40PSF/10PSF
20PSF/10PSF
R-0, R-0, R-0
1
719 SQ-FT
NO

GENERAL NOTES:

- 1. FOUNDATION PLANS ARE NOT PART OF THIS PLAN SET AND ARE GOVERNED BY LOCAL JURISDICTION.
- 2. BUILDINGS ARE APPROVED FOR RESIDENTIAL LAWN STORAGE ONLY.
- 3. THIS BUILDING IS EXEMPT FROM THE FECC PER SECTIONS R101.4.2.4, R402.1.
- 4. REFER TO TIE DOWN DETAILS FOR PROPER INSTALLATION REQUIREMENTS TO MEET CODE.
- 5. ALL LUMBER FOR CONSTRUCTION WILL BE #2 SYP EXCEPT AS NOTED.
- 6. GUTTERS SHALL BE SITE INSTALLED PER THE LOCAL AUTHORITY HAVING JURISDICTION AND PERMITTING REQUIREMENTS.
- 7. ALL WINDOWS AND DOORS TO MEET THE MINIMUM SPECIFICATIONS PER THE APPROVED PLANS AND THE FLORIDA BUILDING CODE.

- 8. IN ACCORDANCE WITH FBC 1609.1.2, "STORAGE SHEDS THAT ARE NOT DESIGNED FOR HUMAN HABITATION AND THAT HAVE A FLOOR AREA OF 720 SQUARE FEET OR LESS AR NOT REQUIRED TO COMPLY WITH THE MANDATORY WINDBORNE DEBRIS IMPACT STANDARDS OF THIS CODE".
- 9. IN ACCORDANCE WITH FBC 1010.1.1, EXCEPTION (10.), BUILDINGS THAT ARE 400 SQ FT OR LESS AND THAT ARE INTENDED FOR USE IN CONJUCTION WITH ONE— AND TWO—FAMILY RESIDENCES ARE NOT SUBJECT TO THE DOOR HEIGHT AND WIDTH REQUIREMENTS OF THIS CODE. STRUCTURES 400 SQ—FT OR MORE SHALL HAVE AN 80" MINIMUM DOOR.
- 10. IN ACCORDANCE WITH FLORIDA STATUTE 553.80 (1)D, LAWN STORAGE BUILDINGS AND STORAGE SHEDS BEARING THE INSIGNIA OF APPROVAL OF THE DEPARTMENT ARE NOT SUBJECT TO 553.842 (FLORIDA PRODUCT APPROVALS) BUT SHALL MEET THE DESIGN WIND LOAD REQUIREMENTS OF THE 2020 FBC 7TH EDITION.
- 11. FLAT METAL SCRAPS CAN BE BENT AROUND STRUCTURAL MEMBERS OF WALL STUDS, TRUSSES, CHORDS, ETC. TO HELP SECURE THESE MEMBERS, PROVIDED THAT THE ADDED BEND DOES NOT INTERFERE WITH ANY OF THE EXISTING BREAKS/BENDS IN THE STRAP.
- 12. AS PER FBC SECTION 1626.1 EXCEPTION (F): STORAGE SHEDS THAT ARE NOT DESIGNED FOR HUMAN HABITATION AND THAT HAVE A FLOOR AREA OF LESS THAN 720 SQUARE FEET OR LESS ARE NOT REQUIRED TO COMPLY WITH THE MANDATORY WINDBORNE DEBRIS IMPACT STANDARDS OF THIS CODE.
- 13. COMPONENTS/CLADDING ARE IN COMPLIANCE WITH THE 2020 FBC 7TH EDITION.
- 14. SHEDS LOCATED IN FLOOD HAZARD AREAS MUST COMPLY WITHT HE LOCAL FLOOD ZONE REGULATIONS.
- 15. IF A WALL IS FRAMED FOR FUTURE HVAC UNITS THAT SHALL BE APPROVED BY THE AHJ AND SHALL COMPLY WITH LOCAL REQUIREMENTS FOR PERMITTING.
- 16. WINDOWS AND DOORS INSTALLED BY THE CUSTOMER THAT SHALL BE APPROVED BY THE AHJ AND SHALL COMPLY WITH LOCAL REQUIREMENTS FOR PERMITTING.

- 17. HVHZ COMPONENTS FOR SHEDS REQUIRE THAT INSTALLATION BE PER MANUFACTURER'S INSTRUCTIONS.
- 18. STRUCTURES ARE DESIGNED FOR LOCATIONS WITH A SURFACE ROUGHNESS CATEGORY B AND A TOPOGRAPHICAL FACTOR OF 1.0. STRUCTURES SHOULD NOT BE USED IN OTHER LOCATIONS.
- 19. STRUCTURES SHOULD HAVE METAL ROOF OR OPTIONAL 25 YEAR RATED FIBERGLASS/ASPHALT SHINGLES.
- 20. ALL STUDS, RAFTERS, COLLAR TIES, AND TRUSS CHORDS ARE SPF #2, U.N.O.
- 21. ALL EXTERIOR WOOD IS TO BE PRESSURE TREATED.
- 22. ALL ROOF DECKING IS TO BE $\frac{7}{6}$ " O.S.B.
- 23. ALL SIDING IS TO BE %" P.T. T-III PLYWOOD OR DURATEMP.
- 24. ALL FLOOR JOISTS ARE TO BE P.T. SYP #2.
- 25. ALL EXTERIOR NAILS ARE TO BE HOT DIPPED GALVANIZED.
- 26. ALL FLOOR DECKING IS TO BE %" P.T. PLYWOOD.
- 27. ALL SKIDS ARE TO BE 4x6 P.T. SYP, RATED FOR GROUND CONTACT.
- 29. THE STRUCTURE HAS BEEN DESIGNED TO RESIST LOADS AS A COMPLETED STRUCTURE ONLY. APPLICATION OF CONSTRUCTION LOADS TO THE PARTIALLY COMPLETED STRUCTURE SHALL BE CONSIDERED BY THE CONTRACTOR AND INCLUDED IN THE DESIGN OF SHORING, BRACING, FORM WORK, AND OTHER SUPPORTING ELEMENTS PROVIDED FOR CONSTRUCTION OF THE STRUCTURE.
- 29. NO FIELD SUPERVISION OR CONSTRUCTION ADMINISTRATION HAS BEEN PROVIDED BY THE ENGINEER.
- 30. DRAWINGS SHALL NOT BE SCALED FOR DIMENSIONS.
- 31. DIFFERENTIAL PRESSURE: WINDOWS & DOORS = +/-25PSF

BUILDING SIZES:

8' WIDTH
8'x12'
10' WIDTH
10'x12'
10'x16'
12' WIDTH**
14'x28'
14'x32'
12' WIDTH**
**NOTE:(11'-2 ACTUAL)
14' WIDTH*
14' WIDTH*
14'x20'
14'x24'
14'x28'
14'x32'
14'x32'
14'x36'

12'x12' 12'x16' 12'x20' 12'x24' 12'x28' 12'x32'

12'x40'

Plans
Reviewed
for Code
Compliance

INDEX OF SHEETS:

S-O-SLB - COVER SHEET

S-OA-SLB - GENERAL NOTES (CONT.)

S-1-SLB - FOUNDATION PLAN (NOT USED) S-2-SLB - UPLIFT ANCHORAGE (NOT USED)

S-3-SLB - FRAMING PLAN

S-4-SLB - BUILDING SECTIONS S-5-SLB - ELEVATIONS

S-6-SLB - NAIL PATTERN S-7-SLB - DETAILS

S-8-SLB - DETAILS

NOT APPROVED FOR HVHZ


ITEMS BY OTHERS:

THE FOLLOWING ITEMS ARE NOT PROVIDED BY RAILROAD CONSULTANTS, PLLC AND ARE TO BE DESIGNED BY OTHERS IF APPLICABLE AND ARE TO BE SUPPLIED AND INSTALLED BY OTHERS. THESE ITEMS MAY BE SUBJECT TO LOCAL JURISDICTION APPROVAL. RAILROAD CONSULTANTS, PLLC IS NOT RESPONSIBLE THESE ITEMS.

1. RAMPS, STAIRS, AND GENERAL ACCESS

*** Please note: Any questions regarding local permitting should be directed to the Manufacturer.

The Manufacturer's contact information can be found in the title block of the plans.

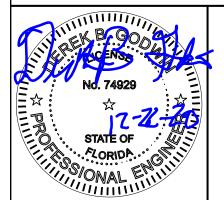

SHEET APPROVAL STAMP

TIE TOP LINE ENGINEERING, LLC
STRUCTURAL ENGINEERS

William E. Neary, III

SMP-51, SMI-79, ICC 5185040

10649 Oakview Pointe Terrace

Gotha, Florida 34734

SIDE LOFTED BARN--FL--V=150MPH--FBC 2020



RAILROAD CONSULTANTS, PLLC 213 UPTOWN SQUARE MURFREESBORO, TN 37129 PHONE: (615) 663-1142



GRACELAND PORTABLE
BUILDINGS, LLC
267 RELIHAN STREET
PEARSON, GA 31642
PHONE: (888) 472-2304
REVISION:

PROJECT NO: 4061001FL

DATE: 12-22-20

DRAWN BY: JMG

CHECKED BY: DBG

03

S-O-SLE

SHEET NUMBER


GENERAL NOTES (CONT.)

32. HARDIE OR LP LAP SIDE OR EQUAL (8-1/4", 7" EXPORSURE/REVEAL) INSTALLED OVER 7/16" OSB ARE ACCEPTABLE ALTERNATES TO THE ORIGINAL DESIGN FOR ALL STRUCTURES AND THEY MEET OR EXCEED ALL APPLICABLE BUILDING CODES.


DESIGN CRITERIA:

- 1. DEAD LOADS: LOFT: 5 PSF
- 2. LIVE LOADS: LOFT: 10 PSF
- 3. SNOW LOADS:
 GROUND SNOW LOAD, Pg=25psf
 FLAT ROOF SNOW LOAD, Pf=20psf
 SNOW EXPOSURE FACTOR, Ce=1.2
 SNOW LOAD IMPORTANCE FACTOR, I=0.8
 THERMAL FACTOR, Ct=1.2
- 4. WIND LOADS:

 BASIC WIND SPEED, V=150 MPH
 RISK CATEGORY = I
 WIND EXPOSURE B
 C&C ROOF-ZONE 1=23.3, -37.0 psf
 C&C ROOF-ZONE 2=23.3, -64.5 psf
 C&C ROOF-ZONE 3=23.3, -95.4 psf
 C&C WALL-ZONE 4=40.5, -43.9 psf
 C&C WALL-ZONE 5=40.5, -54.2 psf
- 5. SEISMIC LOADS: THIS STRUCTURE IS EXEMPT FROM SEISMIC DESIGN PER EXEMPTION 3 OF ASCE 7-16, SECTION 11.1.2

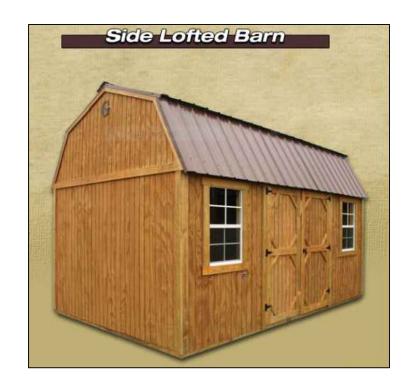

NOT APPROVED FOR HVHZ

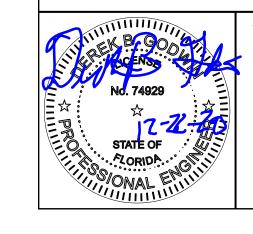

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<u>TAWIF</u>

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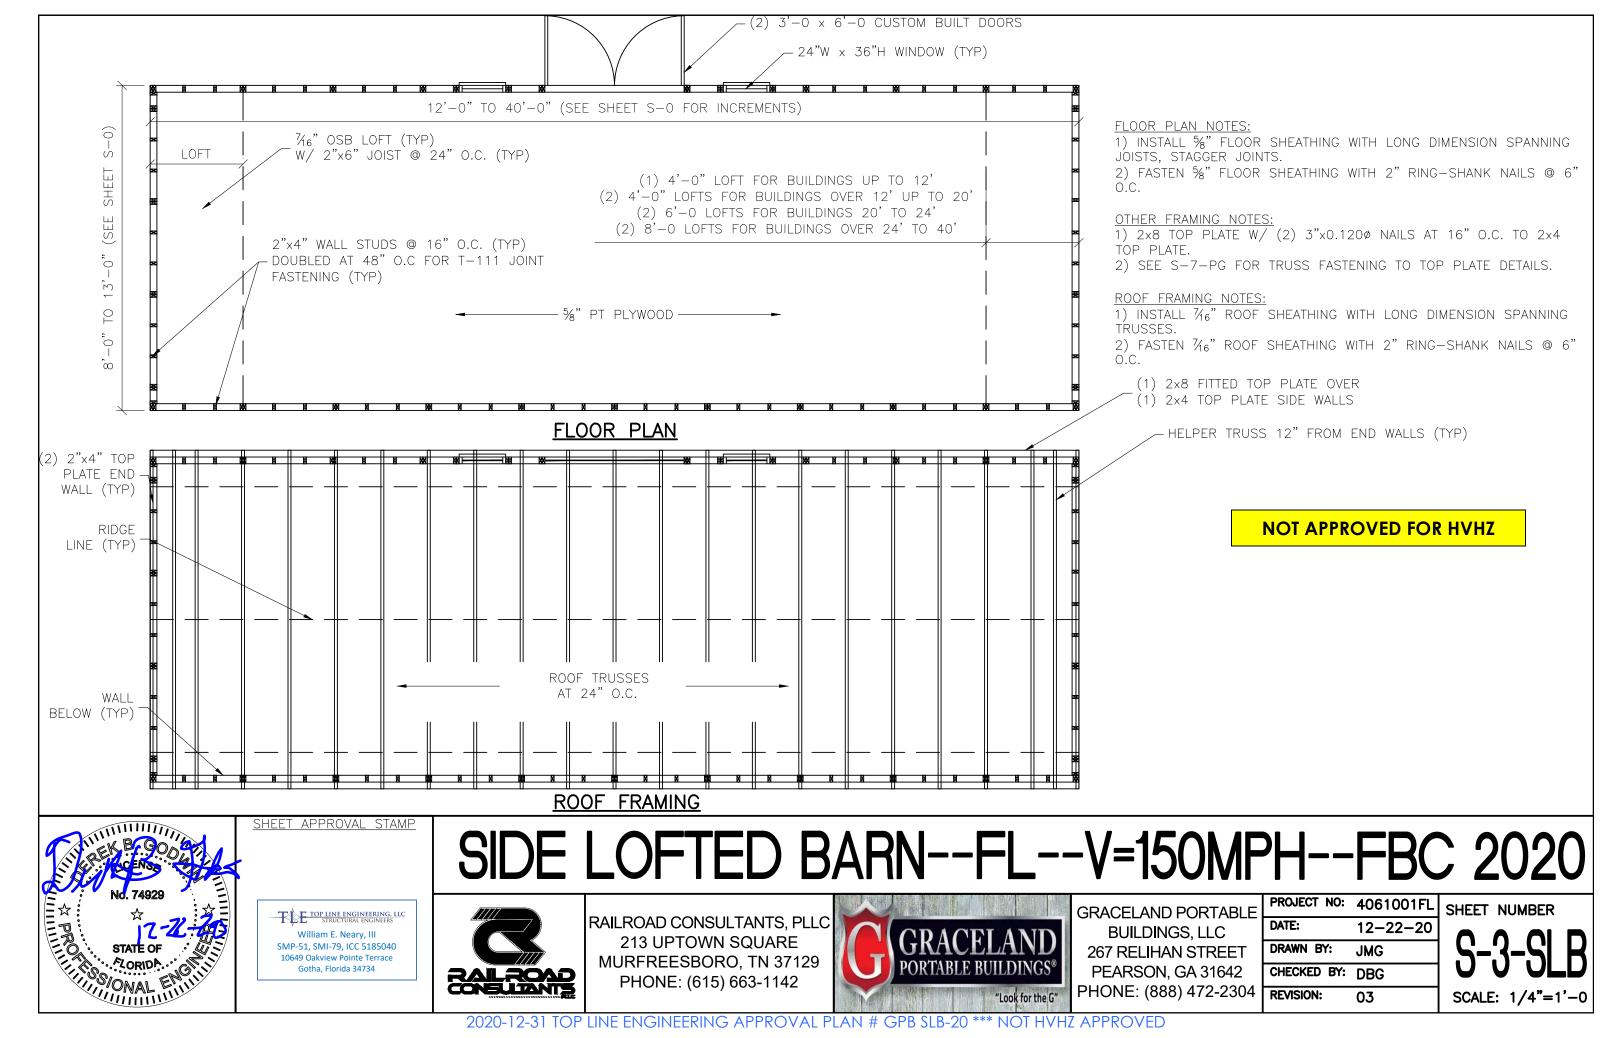
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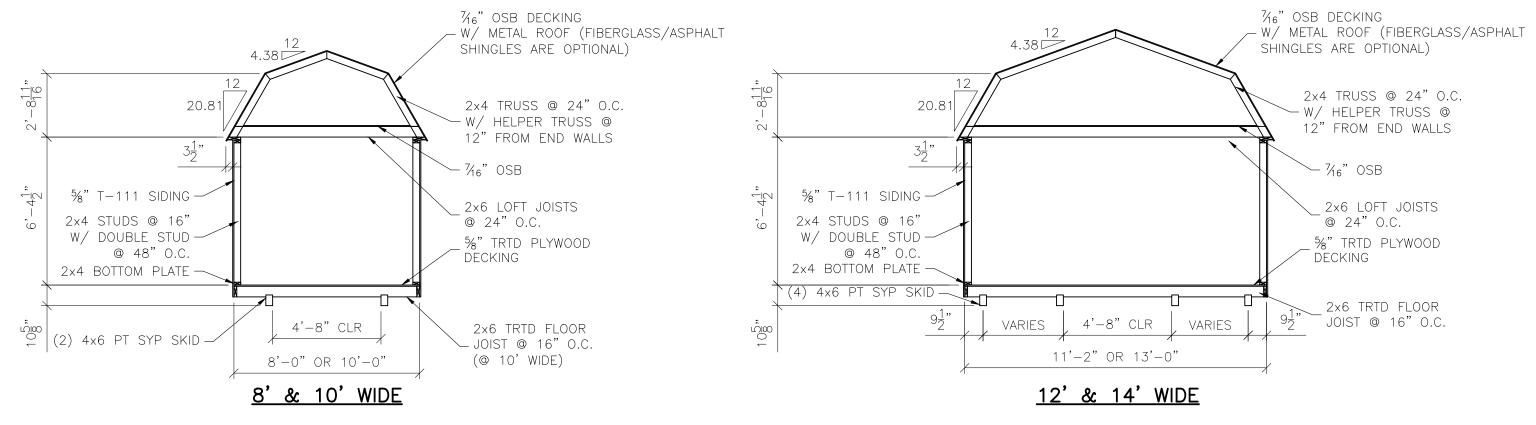
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SHEET NUMBER

S-OA-SLB






BUILDING SECTIONS

NOT APPROVED FOR HVHZ

NOTES:

- 1) FOR METAL GAUGE OF ROOF DECKING SEE S-5-SLB.
- 2) FOR MFGR AND SIZE OF TRUSS MENDING PLATES SEE S-7-SLB.
- 3) FOR BOTTOM PLATE & SKID FASTENING SEE S-8-SLB.
- 4) FOR WALL SHEATHING FASTENING SEE S-6-SLB.

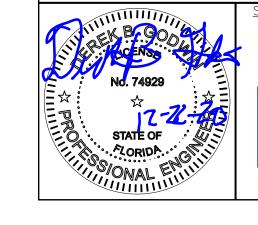

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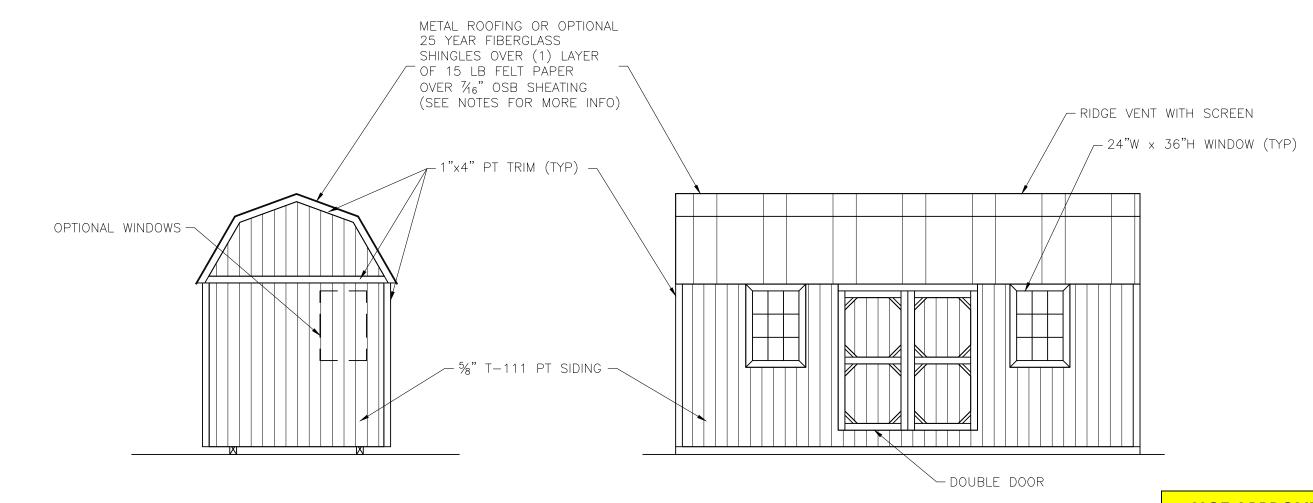
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03

SHEET NUMBER

S-4-SLB

SCALE: 1/4"=1'-0




NOT APPROVED FOR HVHZ

SIDE WALL ELEVATION

ROOFING AND UNDERLAYMENT NOTES:

- 1) PROVIDE A RIDGE VENT TYPICAL WITH INSECT SCREEN.
- 2) METAL ROOFING SHALL BE 29 GAUGE METAL IN ACCORDANCE WITH ASTM A 924 OR ASTM A 924M OVER OSB SHEATHING.
- 3) PROVIDE 29 GAUGE RIDGE CAP, EAVE TRIM AND RAKE TRIM.
- 4) INSTALL AND FASTEN METAL ROOFING PER MANUFACTURER'S INSTRUCTIONS FOR WIND LOADING.
- 5) OPTIONAL SHINGLES SHALL BE IN ACCORDANCE WITH ASTM D 7158 TYPE H OR ASTM D 3161F TYPICAL.
- 6) INSTALL 1 LAYER OF 15 LB ROOFING FELT, START WITH A 19" WIDE STRIP PARALLEL WITH AND STARTING AT EAVES FASTENED SECURELY TO HOLD IN PLACE. START AT EAVE WITH A 38" WIDE SHEET WITH OVERLAPPING SUCCESSIVE SHEETS BY 19". FASTEN UNDERLAYMENT WITH CORROSION-RESISTANT FASTENERS PER MAUFACTURER'S INSTRUCTIONS AND SPACED A MAXIMUM OF 36" APART.
- 7) FASTEN 1"x4" PT TRIM W/ (2) 8d NAILS @ 24" O.C.

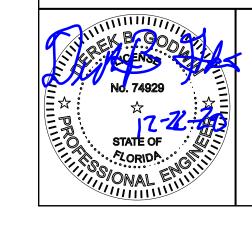

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END WALL ELEVATION

SIDE LOFTED BARN--FL--V=150MPH--FBC 2020

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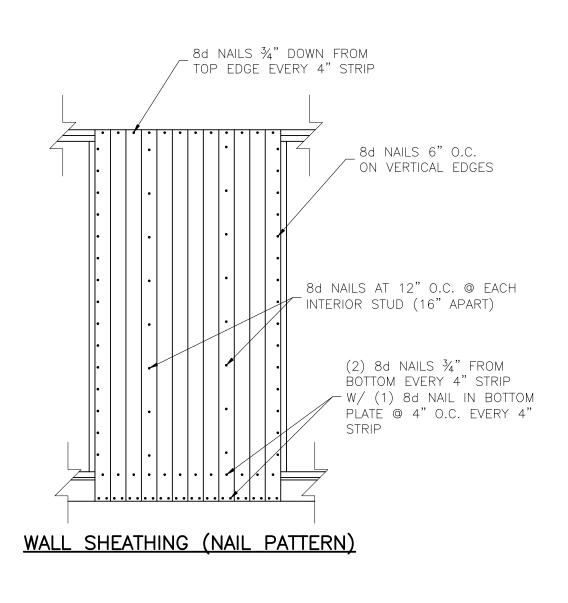
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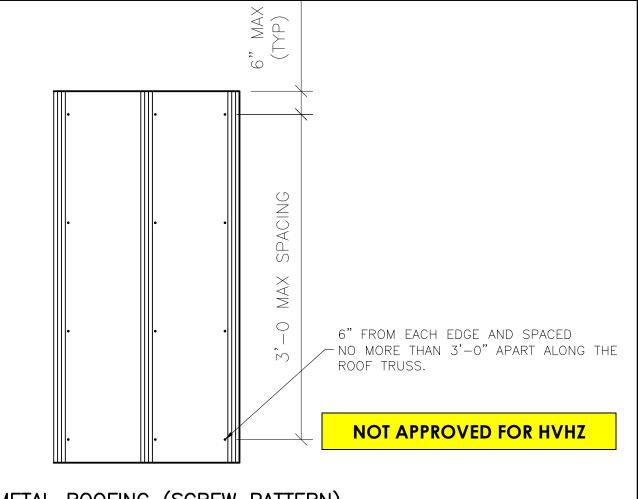
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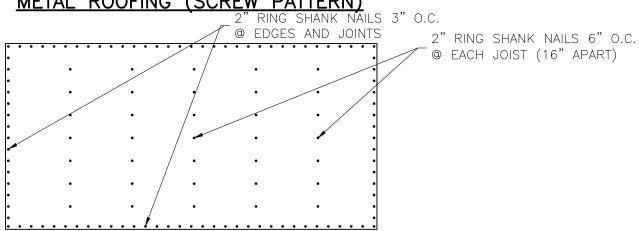
RAILROAD CONSULTANTS, PLLC

PHONE: (888) 472-2304 REVISION:






METAL ROOFING (SCREW PATTERN)



FLOOR SHEATHING (NAIL PATTERN)

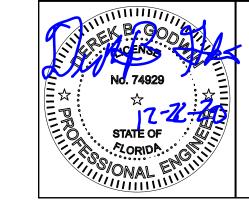

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SIDE LOFTED BARN--FL--V=150MPH--FBC 2020 RAILROAD CONSULTANTS, PLLC

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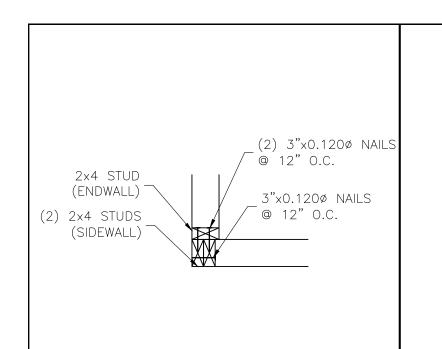
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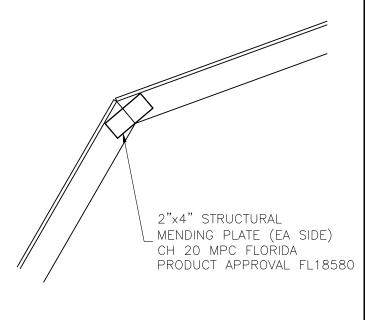
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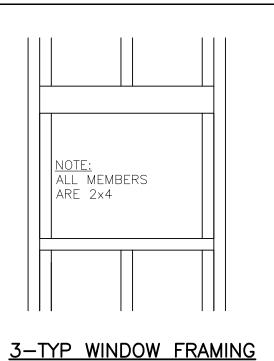
03

SHEET NUMBER

SCALE: 1/2"=1







TRUSS TO WALL CONNECTION SIMPSON H2.A W/ (5)8d 1-1/2" NAILS EACH END OF CLIP (NOT SHOWN) (4) 3"x0.120¢ NAILS TOÉ-NAILED TO TOP PLATE @ EA TRUSS (3) 3"x0.120¢ NAILS TOP PLATE TO EACH STUD -(6 TOTAL) 2x4 AT CORNERS (6) 3"x0.120¢ NAILS ONLY (TYP) 2 EACH ROW 2x4 STUDS NOTE: INSTALL H2.5A PER MANUFACTURE'S RECOMMENDATIONS 4-CORNER & WALL DETAIL

1-CORNER DETAIL


NOT APPROVED FOR HVHZ

2-TRUSS SPLICE DETAIL

2x4 ROOF TRUSS @ 24" O.C. -7/6" ROOF SHEATHING 1"x4" TRIM (SEE ELEVATIONS) 2x4 (NOT SHOWN FOR CLARITY) @ 16" O.C W/ (5) 3"x0.120ø (5) 3"x0.120¢ NAILS 2x6 NAILS TO TRUSS AND TO TRUSS TYPICAL EACH END TOP PLATE (2x4 IS FLAT (1) 3"x0.120ø NAIL @ 8" O.C. AND VERTICAL AGAINST 2x6 TOE-NAILED TO END WALL) TOP PLATE 5%" T-111 OR DURATEMP SHEATHING -

2x8 ₋ TOP PLATE $(2)2\times4 \text{ w}/\frac{1}{2}$ " SPACER HEADER FOR OPENINGS (2) 2x4(2) 3"x0.120¢ NAILS LESS THAN 48" WIDE HEADER TOE-NAILED HEADER TO W/ SPACER DBL STUD (2) 2x4 TOP PLATE W/½" SPACER HEADER FOR OPENINGS (1) 2x4 HEADER BETWEEN 48" & 72" 2x4 TOP PLATE (2) 2x6 W/ %" SPACER HEADER FOR OPENINGS 72" OR WIDER CRIPPLE 2x4 STUD - NAIL TO STUD W/ 3"x0.120ø NAILS AT 8" O.C. FOR 12' HIGH OR GREATER SIDEWALLS. A 48" MAX OPENING IS ALLOWED. 6-TYP DOOR FRAMING

5-END WALL DETAIL

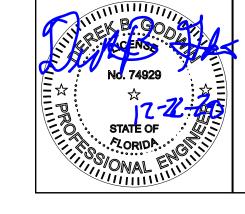

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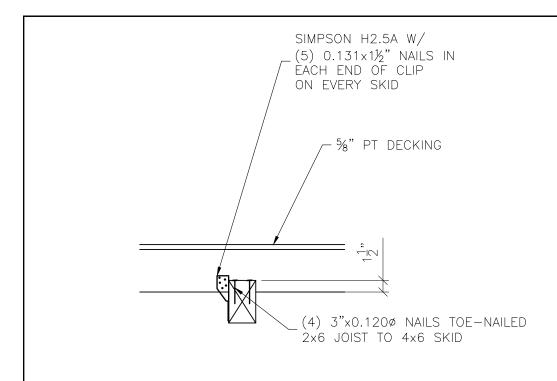
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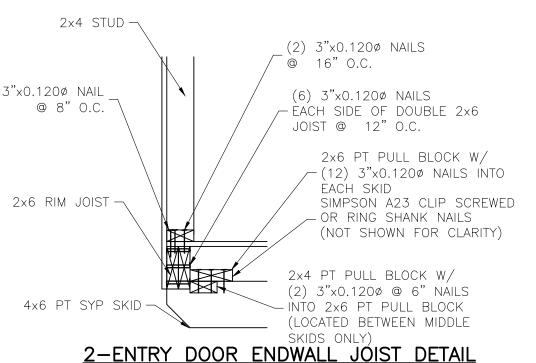
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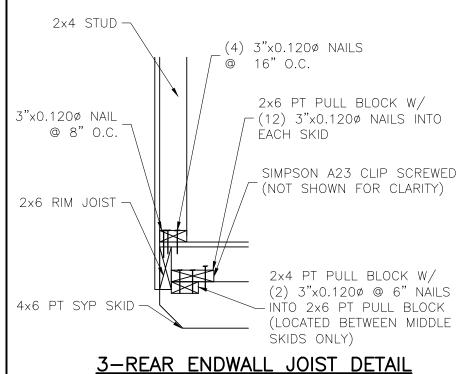
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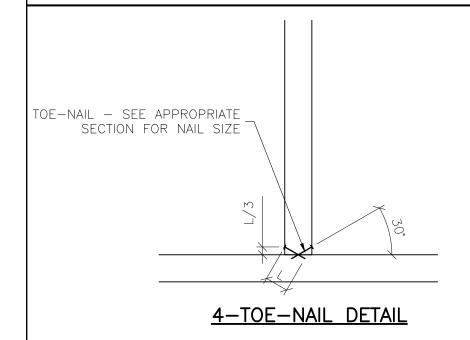
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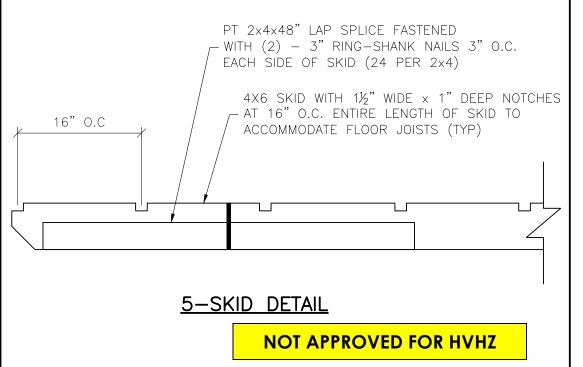



1-INNER & OUTER SKID DETAIL @ EVERY JOIST









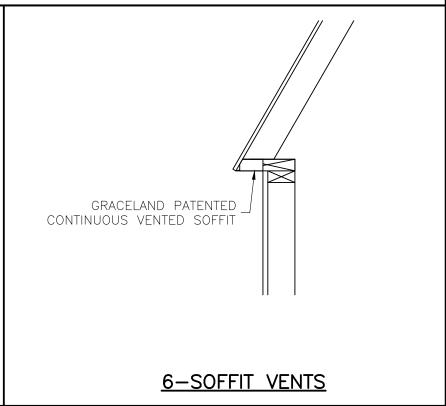

No. 74929 A TORIDA NO. 74919 STATE OF A CORIDA NO. 74919 NO. 74929

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SIDE LOFTED BARN--FL--V=150MPH--FBC 2020



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S-8-SLB

SCALE: 1"=1"