


TYPICAL DESIGN WALL SCTION

NON - STRUCTURAL DAT.

SCALE: 1" = 1'- 0"

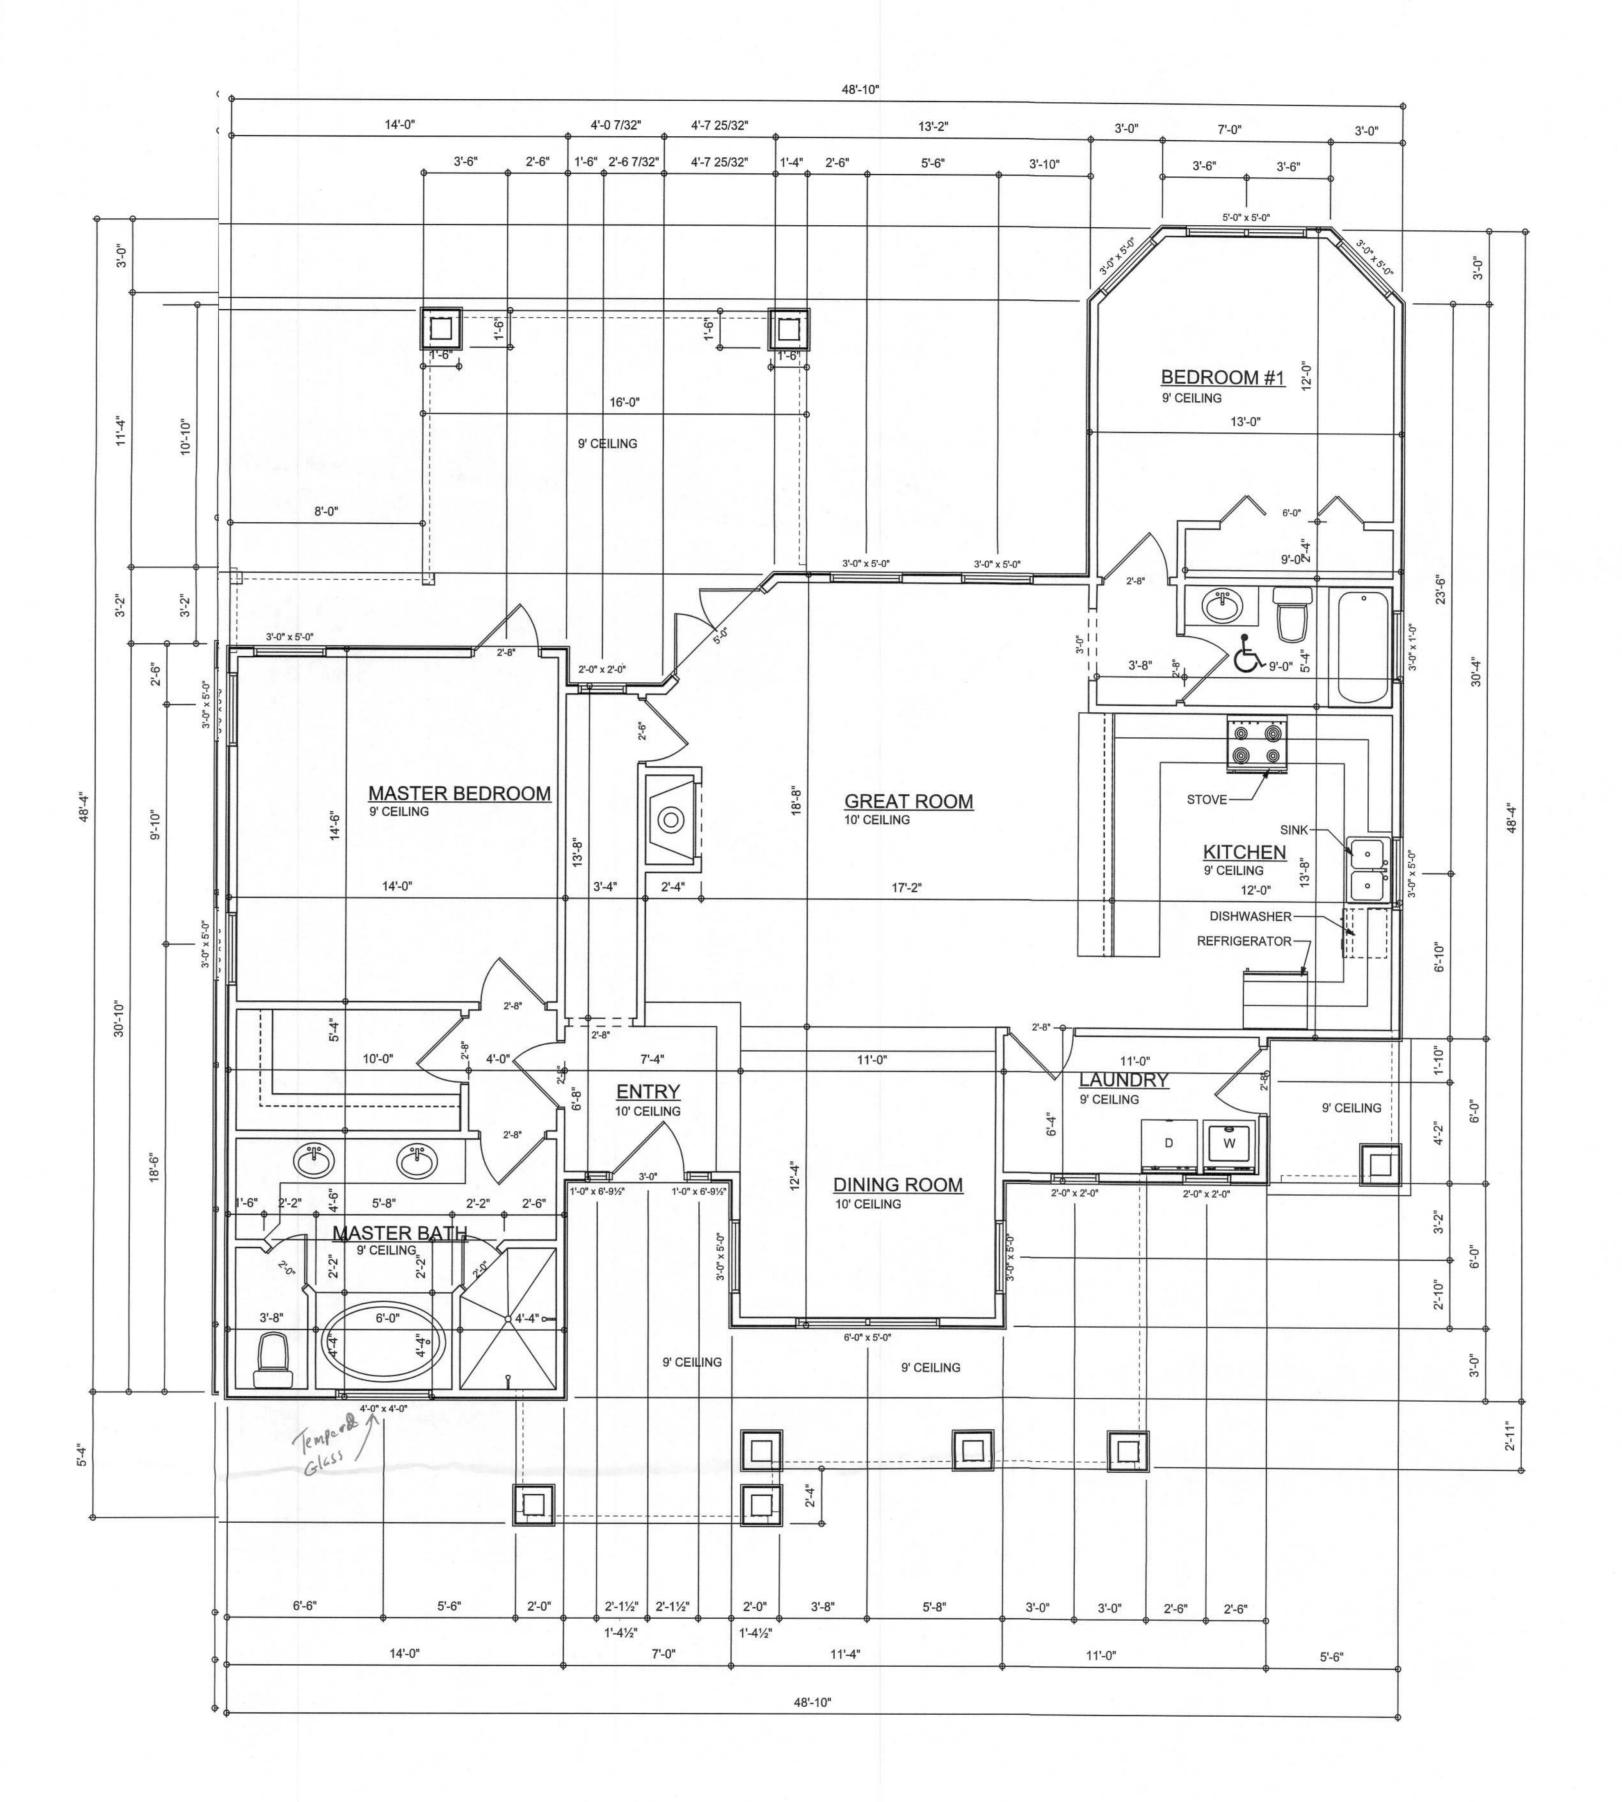

AREA SUMMARY

LIVING AREA	1418	S.F.	
PORCH AREA	557	S.F.	
TOTAL AREA	1975	S.F.	

REVISIONS

SOFTPIAN ARCHITECTURAL DESIGN SOFTWARE

Josh Sparks Construction

Ben & Anne Sparks

ADDRESS: Country Court Lake City, Florida 32024

PRINTED DATE:
October 13, 2010

DRAWN BY: CHECKED BY:
Ben Sparks

DESIGNED BY:

JOB NUMBER: 108031 DRAWING NUMBER

> **2** OF 3 SHEETS

REVISIONS

SOFTP AN


ELECTRICAL PLAN NOTES

- E -1 WIRE ALL APPLIANCES, HVAC UNITS AND OTHER EQUIPMENT PER MANUF. SPECIFICATIONS.
- E -2 CONSULT THE OWNER FOR THE NUMBER OF SEPERATE TELEPHONE LINES TO BE INSTALLED.
- E -3 ALL INSTALLATIONS SHALL BE PER NAT'L. ELECTRIC CODE.
- E -4

 ALL SMOKE DETECTORS SHALL BE 120V W/ BATTERY
 BACKUP OF THE PHOTOELECTRIC TYPE, AND SHALL
 BE INTERLOCKED TOGETHER. INSTALL INSIDE AND
 NEAR ALL BEDROOMS.
- E -5

 TELEPHONE, TELEVISION AND OTHER LOW VOLTAGE
 DEVICES OR OUTLETS SHALL BE AS PER THE OWNER'S
 DIRECTIONS, & IN ACCORDANCE W/ APPLICABLE
 SECTIONS OF NEC-LATEST EDITION.
- E -6 ELECTRICAL CONT'R SHALL BE RESPONSIBLE FOR THE DESIGN & SIZING OF ELECTRICAL SERVICE AND CIRCUITS.
- E -7 ENTRY OF SERVICE (UNDERGROUND OR OVERHEAD)
 TO BE DETERMINED BY POWER COMPANY.
- E -8 ALL BEDROOM RECEPTACLES SHALL BE AFCI (ARC FAULT CIRCUIT INTERRUPT)
- E -9 ALL OUTLETS TO BE LOCATED ABOVE BASE FLOOD ELEVATION
- A SERVICE DISCONNECT WITH OVER CURRENT PROTECTION SHALL BE INSTALLED OUTSIDE OF THE BUILDING, ON THE LOAD SIDE OF THE METER, AT THE PLACE ELECTRIC CONDUCTORS ENTER THE BUILDING.
- SERVICE ENTRANCE CONDUCTORS MAY NOT BE LOCATED INSIDE OF THE OF THE BUILDING WITHOUT SPECIAL APPROVAL OF THE BUILDING OFFICIAL
- E -11 CARBON MONOXIDE ALARMS SHALL BE REQUIRED WITHIN 10'
 OF ALL ROOMS FOR SLEEPING PURPOSES IN BUILDINGS HAVING A FOSSIL-FUEL-BURNING HEATER OR APPLIANCE, A FIREPLACE, OR ATTACHED GARAGE.

	ELECTRICAL LEGENI				
	CEILING FAN (PRE-WIRE FOR LIGHT KIT)				
QD.	DOUBLE SECURITY LIGHT 2X4 FLUORESCENT LIGHT FIXTURE				
0	RECESSED CAN LIGHT				
- ♦	BATH EXAUST FAN WITH LIGHT				
₩	BATH EXAUST FAN				
- -	LIGHT FIXTURE				
Ф	DUPLEX OUTLET				
Ф	220v OUTLET				
Фан	GFI DUPLEX OUTLET				
•	SMOKE DETECTOR				
\$	WALL SWITCH				
\$3	3 WAY WALL SWITCH				
\$ 4	4 WAY WALL SWITCH				
∯ _{WP/GFI}	WATER PROOF GFI OUTLET				
∇	PHONE JACK				
0	TELEVISION JACK				
•	GARAGE DOOR OPENER				
•	CARBON MONOXIDE ALARM				

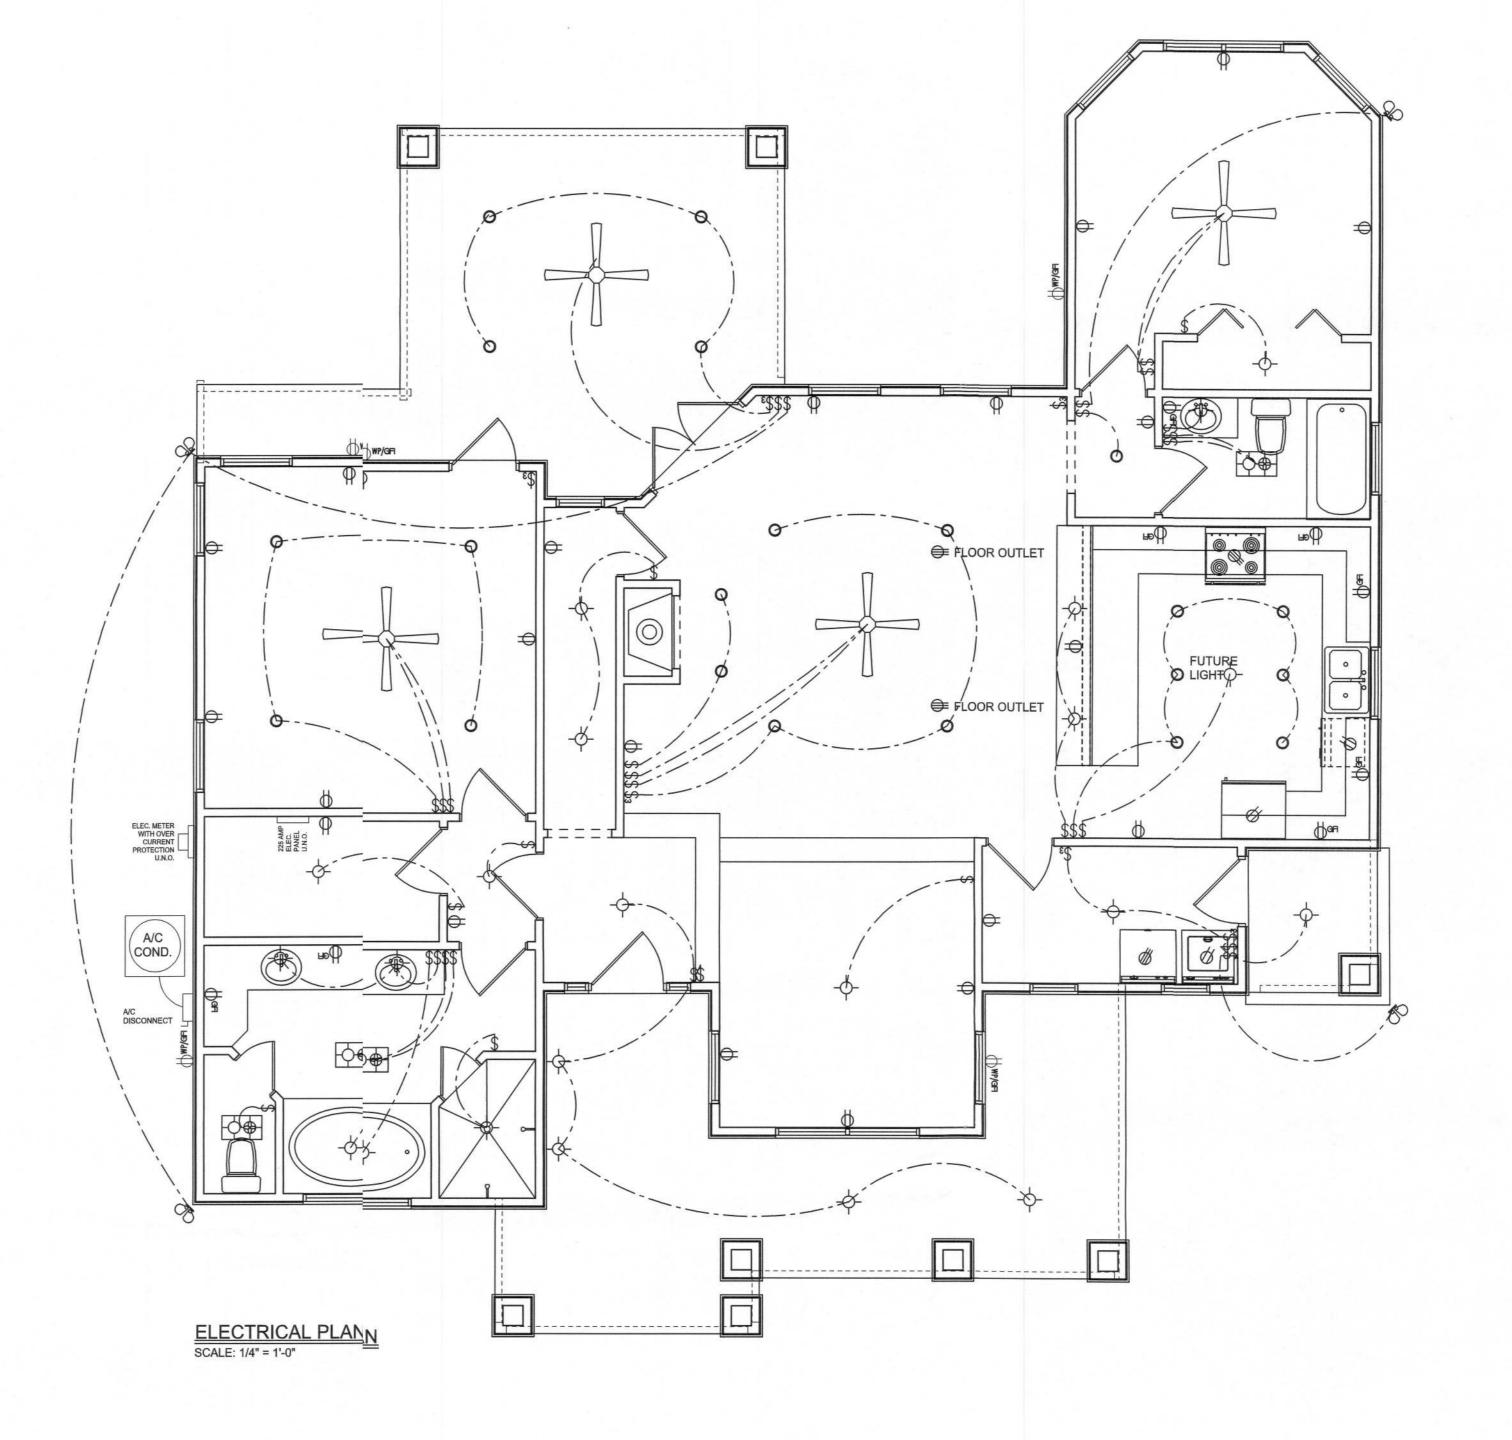

Josh Syarks
Construction

Ben & Anne Spaks

ADDÆSS: CountryCourt Lake City, Fbrida 32024

PRINTEDDATE:
October 1′, 2010
DRAWN BY: CHECKED BY:

DESIGNID E


31 / Jan / 08


JOB NUMBER:

Ben Sparks


108/31
DRAWING NUMBER

OF 3 SHEETS

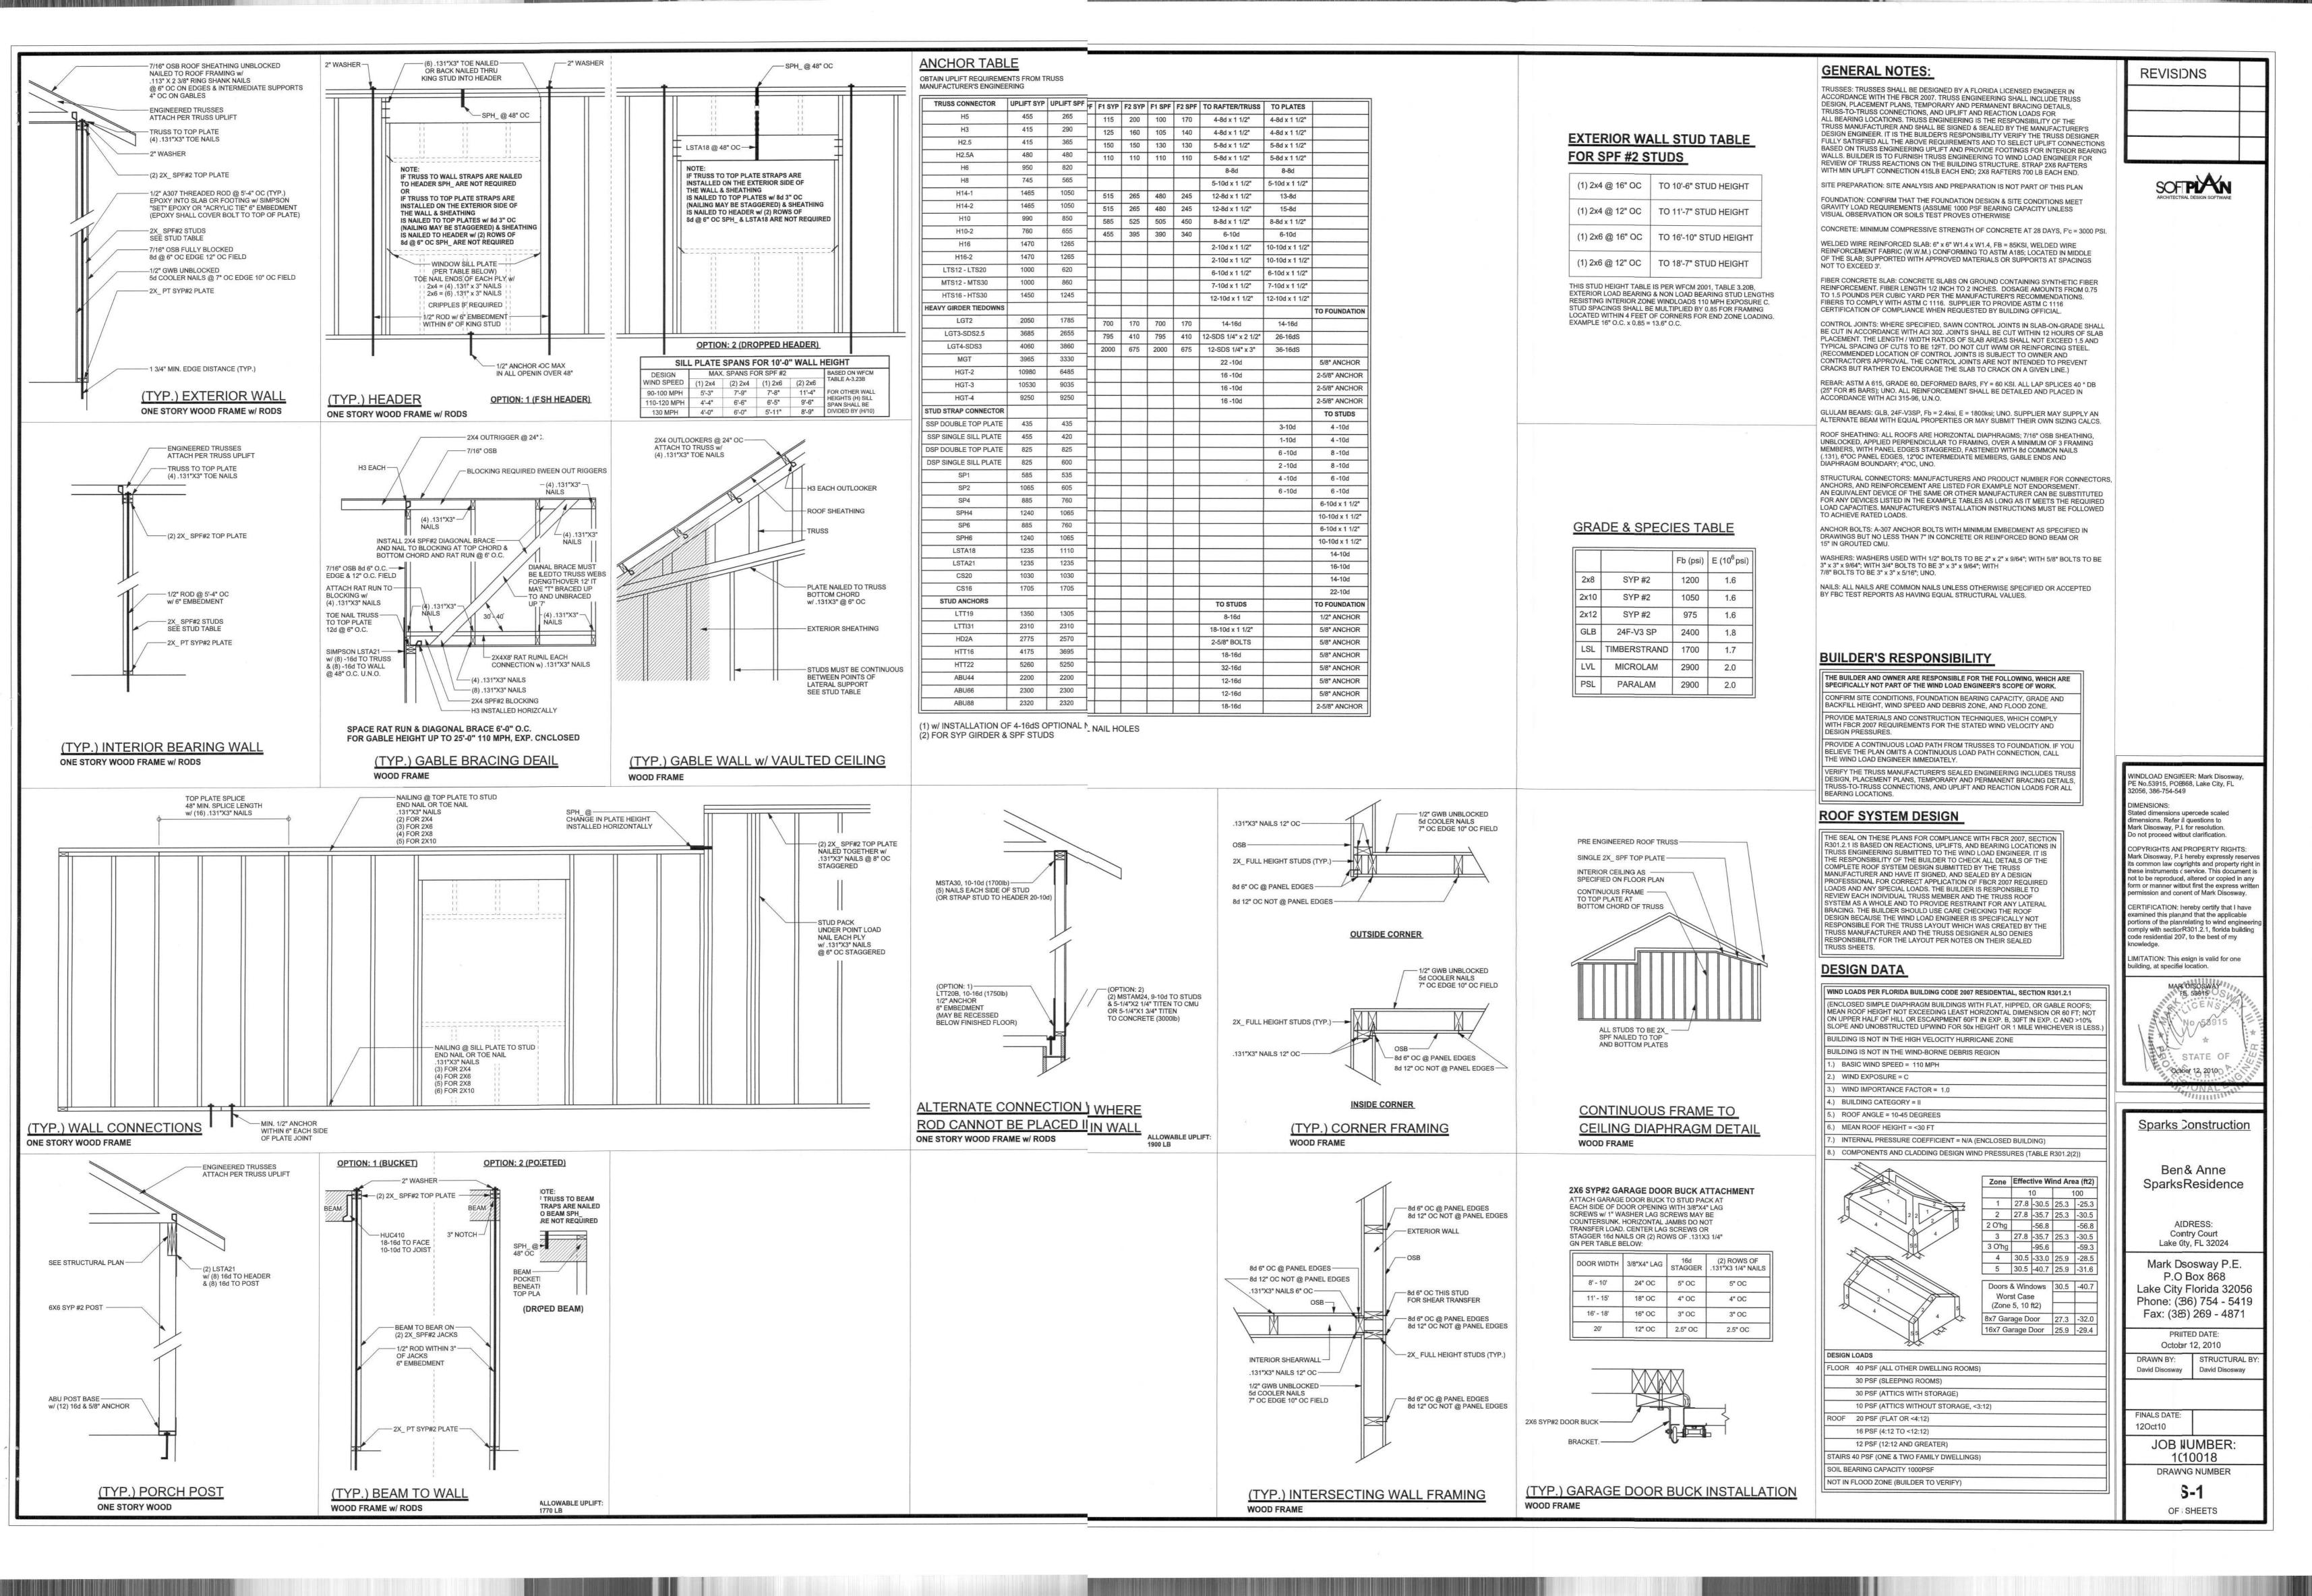

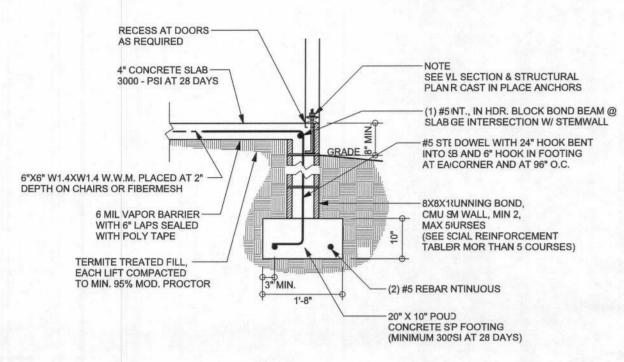

F9 STEM WALL FOOTING SCALE: 1/2" = 1'-0"

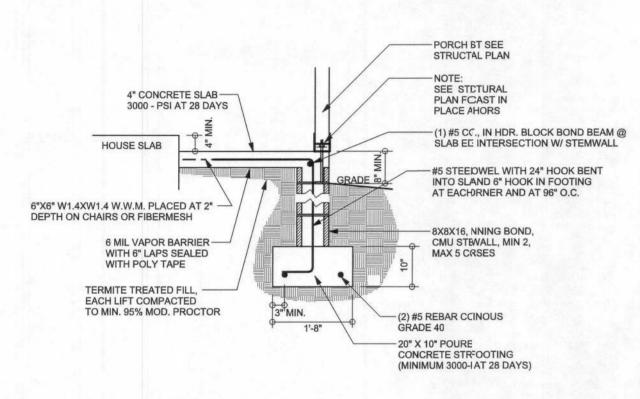


F12 STEM WALL PORCH FOOTIG SCALE: 1/2" = 1'-0"

TALL STEM WALL TABLE

The table assumes 60 ksi reinforcing bars with 6" hook in the footing and bent 24" into the reinforced slab at the top. The vertical steel is to be placed toward the tension side of the CMU wall (away from the soil pressure, within 2" of the exterior side of the wall). If the wall is over 8' high, add Durowall ladder reinforcement at 16"OC vertically or a horizontal bond beam with 1#5 continuous at mid height. For higher parts of the wall 12" CMU may be used with reinforcement as shown in the table below.

STEMWALL UNBALANCED HEIGHT BACKFILL (FEET) HEIGHT	BACKFILL	VERTICAL REINFORCEMENT FOR 8" CMU STEMWALL (INCHES O.C.)			VERTICAL REINFOEMENT FOR 12" CMU STWALL (INCHES O.		
	#5	#7	#8	#5	#7	#8	
3.3	3.0	96	96	96	96	96	96
4.0	3.7	96	96	96	96	96	96
4.7	4.3	88	96	96	96	96	96
5.3	5.0	56	96	96	96	96	96
6.0	5.7	40	80	96	80	96	96
6.7	6.3	32	56	80	56	96	96
7.3	7.0	24	40	56	40	80	96
8.0	7.7	16	32	48	32	64	80
8.7	8.3	8	24	32	24	48	64
9.3	9.0	8	16	24	16	40	48

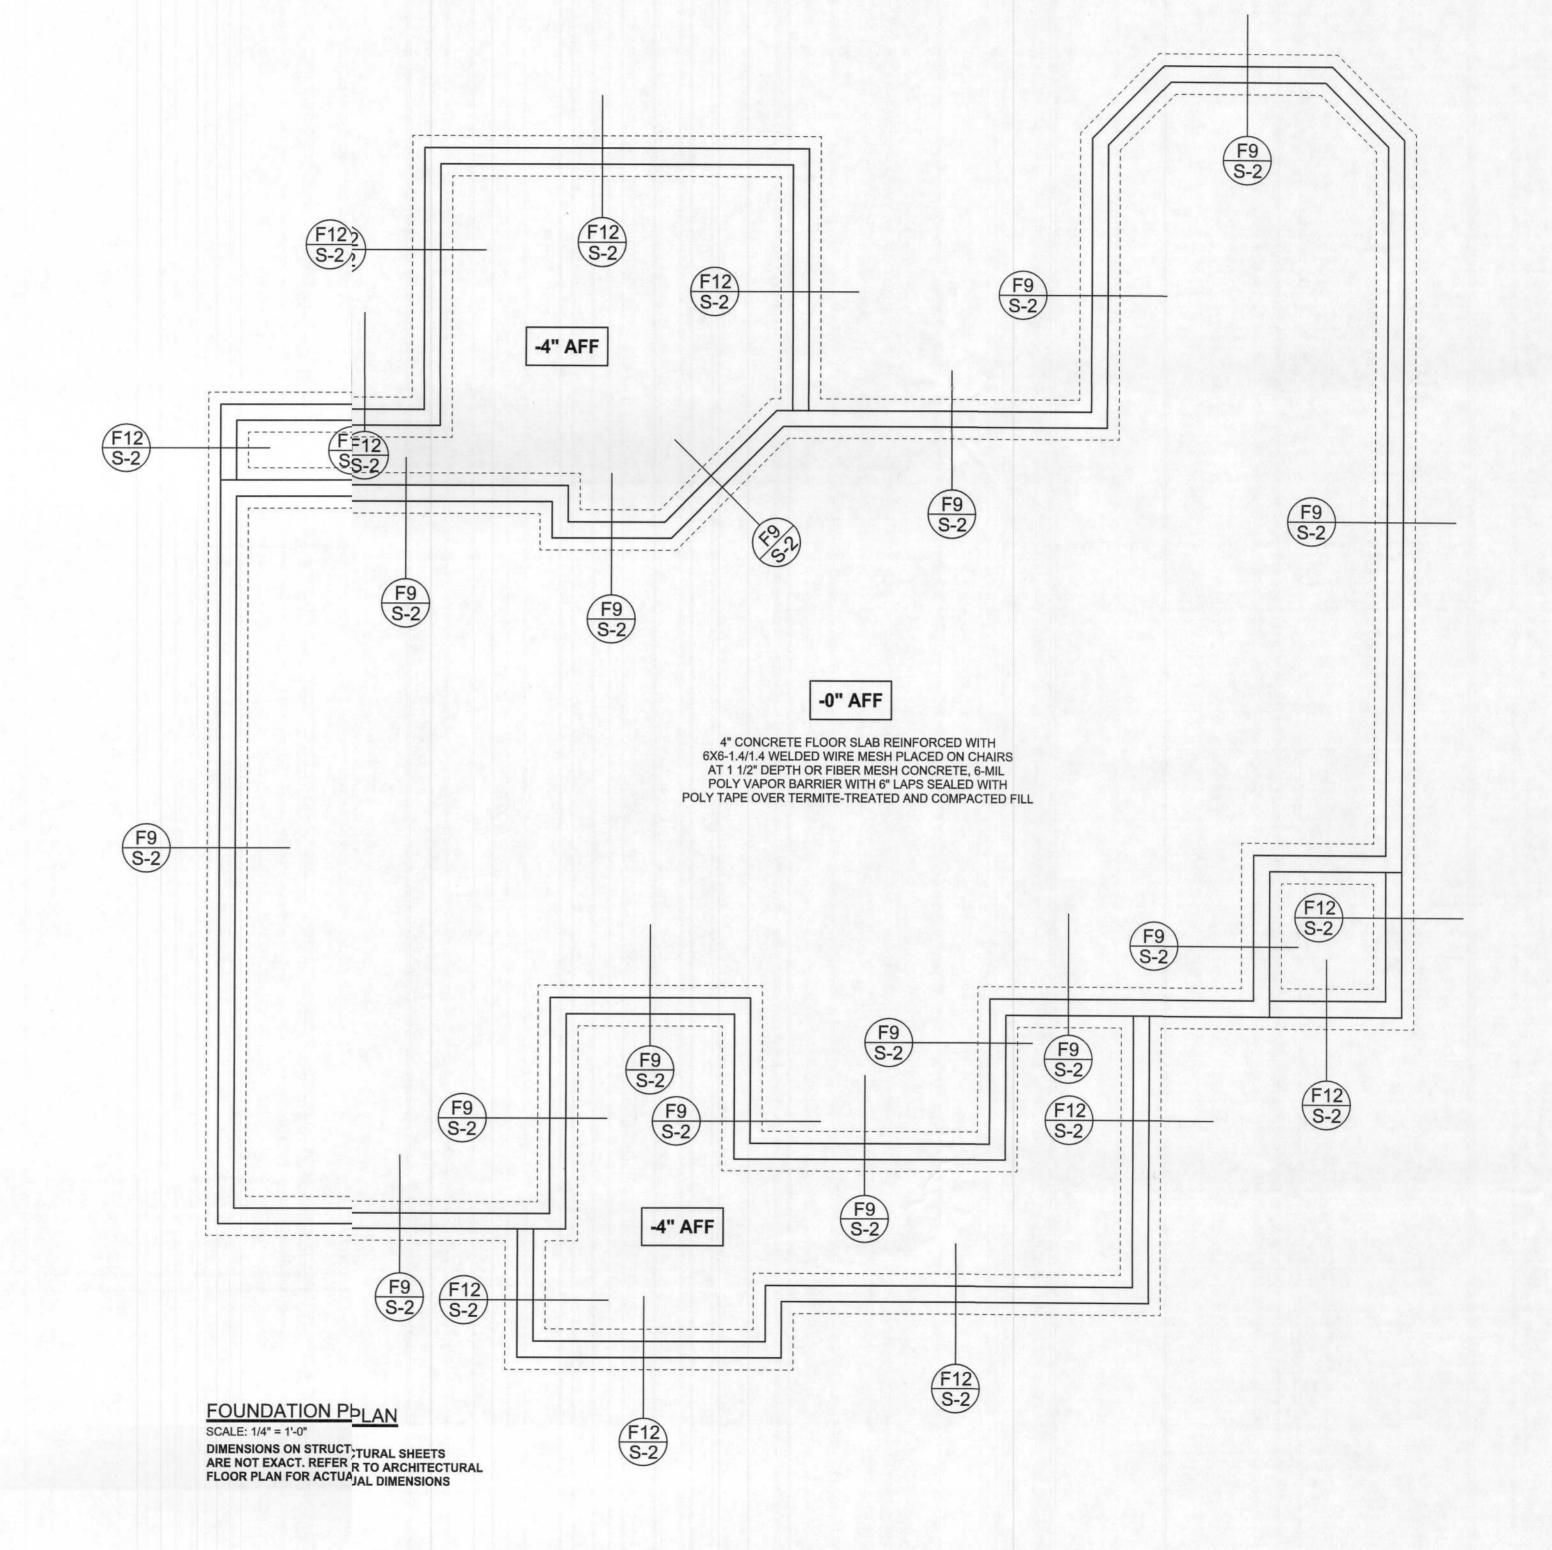

REVISIONS


SOFTPXN ARCHITECTURAL DBIGN SOFTWARE

WINDLOAD ENGINEERMark Disosway, PE No.53915, POB 868, ake City, FL 32056, 386-754-5419

Stated dimensions superede scaled dimensions. Refer all questions to Mark Disosway, P.E. for esolution. Do not proceed without carification. COPYRIGHTS AND PROPERTY RIGHTS:

COPYRIGHTS AND PROPERTY RIGHTS:
Mark Disosway, P.E. herby expressly reserves
its common law copyrighs and property right in
these instruments of sence. This document is
not to be reproduced, altred or copied in any
form or manner without fst the express written
permission and consent f Mark Disosway. CERTIFICATION: I herely certify that I have examined this plan, and hat the applicable portions of the plan, relating to wind engineering comply with section R30.2.1, florida building code residential 2007, tohe best of my

LIMITATION: This designs valid for one building, at specified location.

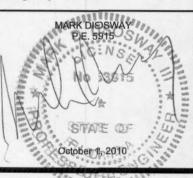

Sparks Construction

Ben & Anne Sparks Residence

ADDRISS: CountryCourt Lake City, IL 32024

Mark Disosway P.E. P.O. Box 868 Lake City, Florida 32056 Phone: (386)754 - 5419 Fax: (386) 269 - 4871


PRINTEDDATE: October 12 2010

DRAWN BY: STRUCTURAL BY David Disosway David Disosway

FINALS DATE: 12Oct10

> JOB NUMBER: 1010)18 DRAWING JUMBER


> > OF 3 SH:ETS

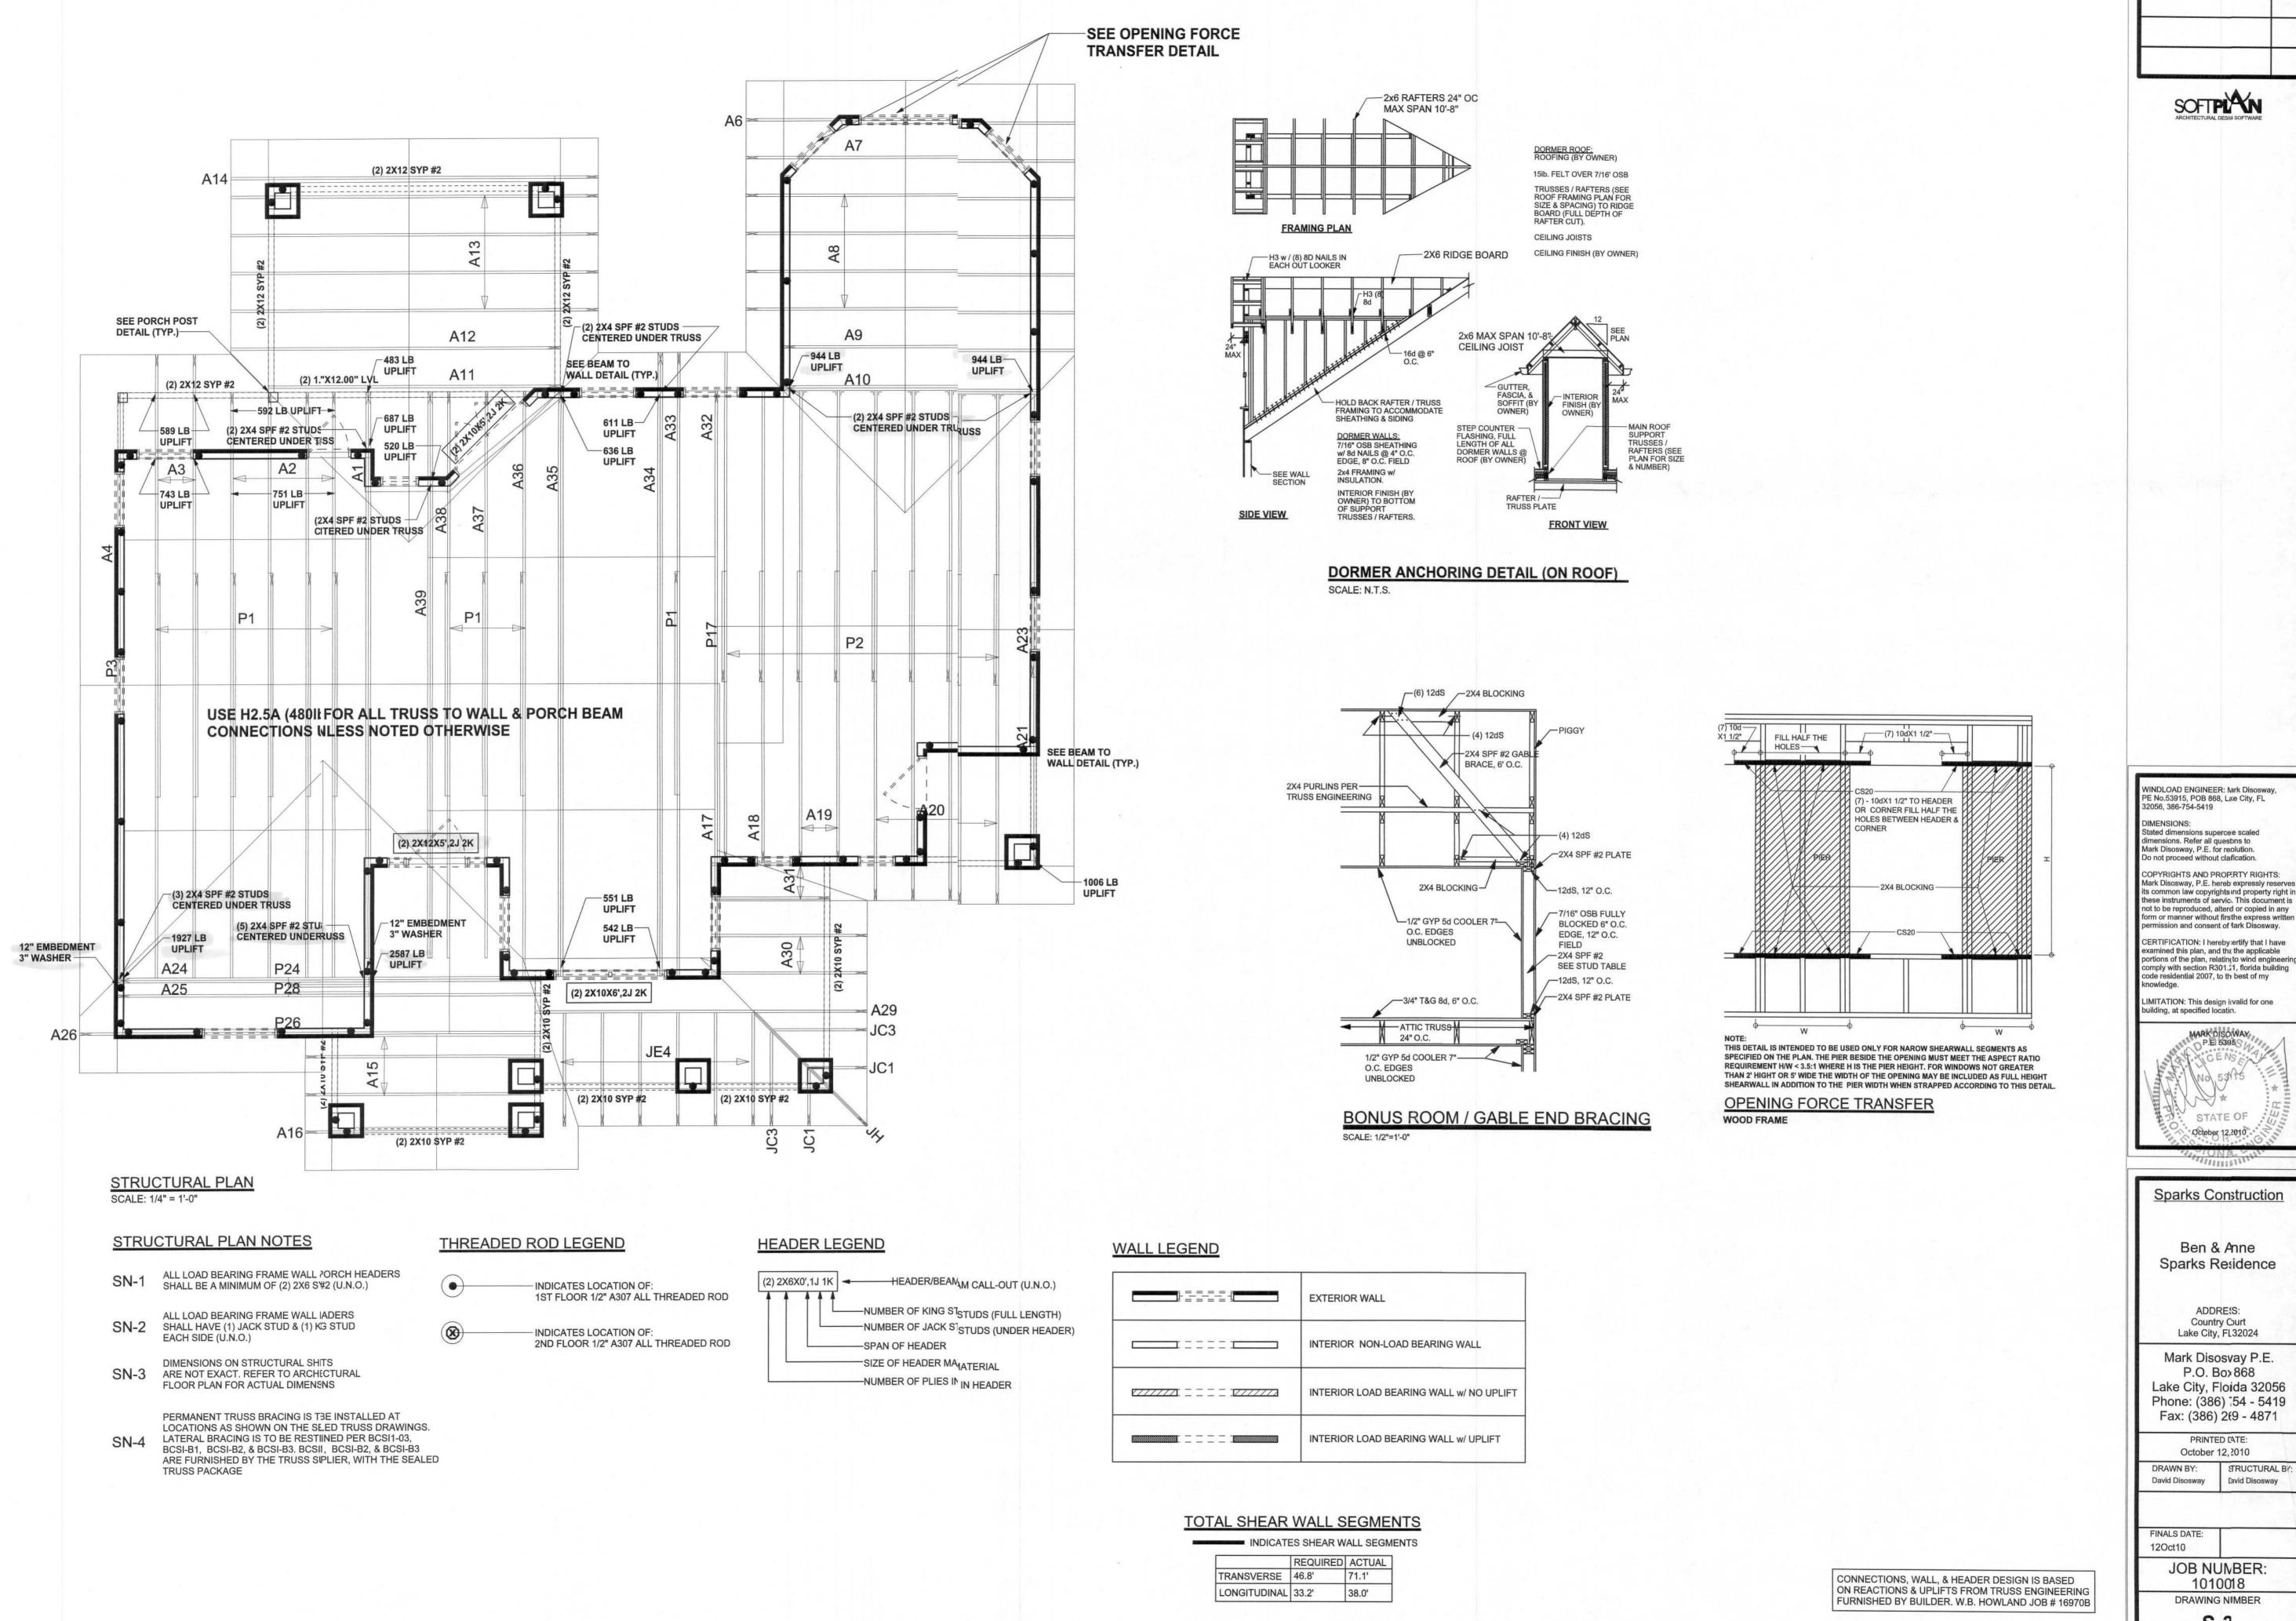

REVISIONS

COPYRIGHTS AND PROPERTY RIGHTS: Mark Disosway, P.E. hereb expressly reserves

these instruments of servic. This document is not to be reproduced, alterd or copied in any form or manner without firsthe express written permission and consent of lark Disosway. CERTIFICATION: I hereby:ertify that I have

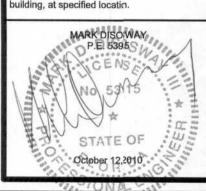

S-3 OF 3 SHE:TS