


AMERICAN TOWER'S


AMERICAN TOWER®

ATC SITE NAME: FALLING CREEK FL ATC SITE NUMBER: 24516 T-MOBILE SITE NAME: 175 AT 110 BOOMER T-MOBILE SITE NUMBER: 9JK0218A SITE ADDRESS: 1334 HUNTSVILLE CHURCH RD LAKE CITY, FL 32055-7044

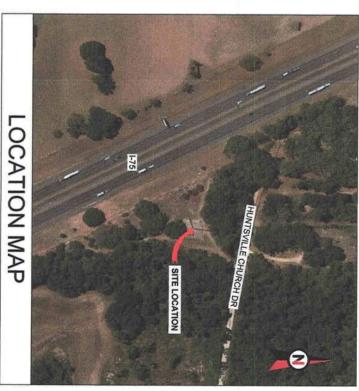

T-MOBILE AMENDMENT PLAN ANCHOR_PHASE 3 CONFIGURATION

Know what's below. Call before you dig.	UTILITY COMPANIES POWER COMPANY: SUWANNEE VALLEY ELECTRIC COOPERATIVE, FL PHONE: 800,447,4509 TELEPHONE COMPANY: AT&T - EFT PHONE: 877,438,0041			CITY/COUNTY ORDINANCES EXPOSURE CATEGORY: C RISK CATEGORY: II		2020 FLORIDA BUILDING CODE, 7TH EDITION ANSI/TIA-222-H 7TH EDITION FLORIDA FIRE PREVENTION CODE (NFPA 70)	THESE CODES.	FOLLOWING CODES AS ADOPTED BY THE LOCAL GOVERNMENT AUTHORITIES, NOTHING IN THESE PLANS IS	ALL WORK SHALL BE PERFORMED AND MATERIALS INSTALLED IN ACCORDANCE WITH THE CURRENT EDITIONS OF THE	COMPLIANCE CODE
PROPERTY OWNER: MARGARET H PETTIGREW 1334 HUNTSVILLE CHURCH RD LAKE CITY, FL 32055-7044	AMERICAN TOWER 10 PRESIDENTIAL WAY WOBURN, MA 01801 ENGINEER: JEREMY SHARIT JSharil@smweng.com SMW ENGINEERING GROUP INC. 158 BUSINESS CENTER DR. BIRMINGHAM, AL. 35244 JOB# 22-5239	PROJECT TEAM TOWER OWNER: APPLICANT:			GROUND ELEVATION: 154' AMSL	GEOGRAPHIC COORDINATES: LATITUDE: 30.25068859	COUNTY: COLUMBIA	LAKE CITY, FL 32055-7044	SITE ADDRESS:	PROJECT SUMMARY
TAKE 1-75 TO EXIT 82, LAKE CITY, TO 90 EAST. GO 2.6 MILES, THERE WILL BE A SIGN TO TURN TO THE ARMORY. TURN LEFT THERE ON LAKE JEFFERY RD GO, 8.6 MILES FROM 90 TAKE A LEFT ON HUNTSVILLE CHURCH ROAD. GO UNTIL IT DEAD ENDS AT 1-75. SITE IS ON THE LEFT.	A. NO SANITARY SEWER, POTABLE WATER OR TRASH DISPOSAL IS REQUIRED. 5. HANDICAP ACCESS IS NOT REQUIRED. 6. THE PROJECT DEPICTED IN THESE PLANS QUALIFIES AS AN ELIGIBLE FACILITIES REQUEST ENTITLED TO EXPEDITED REVIEW UNDER 47 U.S.C. § 1455(A) AS A MODIFICATION OF AN EXISTING WIRELESS TOWER THAT INVOLVES THE COLLOCATION, REMOVAL, AND/OR REPLACEMENT OF TRANSMISSION EQUIPMENT THAT IS NOT A SUBSTANTIAL CHANGE UNDER CFR § 1.61000 (B)(7).	THE FACILITY IS UNMANNED. A TECHNICIAN WILL VISIT THE SITE APPROXIMATELY ONCE A MONTH FOR ROUTINE INSPECTION AND MAINTENANCE. THE PROJECT WILL NOT RESULT IN ANY SIGNIFICANT LAND	PROJECT NOTES		723	(2) 1.99" HYBRID IRUNKS, AND (1) //8" COAX CABLE TO REMAIN	EXISTING (3) ANTENNAS, (1) MW ANTENNA, (2) 1-5/8" COAX CABLES,	TOWER WORK: INSTALL (3) ANTENNAS	THE PROPOSED PROJECT INCLUDES MODIFYING GROUND BASED AND TOWER MOUNTED EQUIPMENT AS INDICATED PER BELOW:	PROJECT DESCRIPTION
		R-602	E-501	C-502	C-401	C-101	G-002	G-001	SHEET NO:	
	Signal Collision of Expression of the Collision of Expression of the Collision of the Colli	SUPPLEMENTAL DEP	GROUNDING DETAILS SUPPLEMENTAL	EQUIPMENT SPECIFICATIONS	ANTENNA INFORMATION & SCHEDULE	DETAILED SITE PLAN TOWER ELEVATION	GENERAL NOTES	TITLE SHEET	DESCRIPTION:	SHEET INDEX
			_		-	- -	-	-	REV:	
			04/28/22	04/28/22	04/28/22	04/28/22	04/28/22	04/28/22	DATE:	
			ZDS	ZDS	ZDS	ZDS	ZDS	ZDS	BY:	

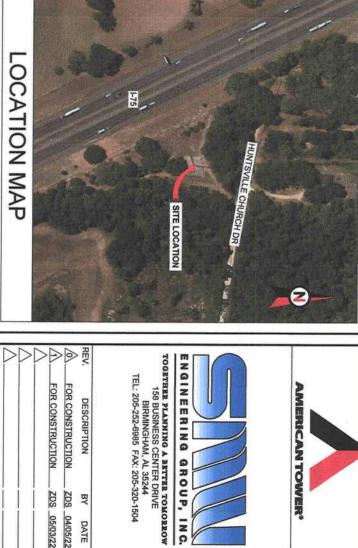

FOR CONSTRUCTION


ZDS 04/05/22 ZDS 05/03/22

FOR CONSTRUCTION

DESCRIPTION

ВΥ

DATE

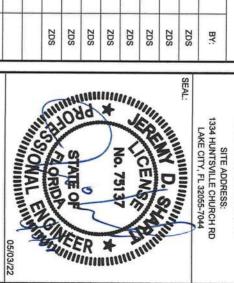

175 AT 110 BOOMER

T-MOBILE SITE NAME:

ATC SITE NAME: FALLING CREEK FL

ATC SITE NUMBER: 24516

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T	
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C	D

9JK0218A	CUSTOMER #: 9JK0218A
CUSTOMER ID: 175 AT 110 BOOMER	CUSTOMER ID:
13973819_G3	ATC JOB NO:
04/05/22	DATE DRAWN:

G-001 SHEET NUMBER:

TITLE SHEET

REVISION:

GENERAL CONSTRUCTION NOTES:

- OWNER FURNISHED MATERIALS, T-MOBILE "THE COMPANY" WILL PROVIDE AND THE CONTRACTOR WILL INSTALL
- BTS EQUIPMENT FRAME (PLATFORM) AND ICEBRIDGE SHELTER (GROUND BUILD/CO-LOCATE ONLY)
- AC/TELCO INTERFACE BOX (PPC)
 ICE BRIDGE (CABLE TRAY WITH COVER) (GROUND BUILD/CO-LOCATE ONLY, GC
 TO FURNISH AND INSTALL FOR ROOFTOP INSTALLATION)
- TOWERS, MONOPOLES
 TOWER LIGHTING

- - GENERATORS & LIQUID PROPANE TANK
 ANTENNA, STANDARD BRACKETS, FRAMES AND PIPES FOR MOUNTING
 ANTENNAS (INSTALLED BY OTHERS)
 TRANSMISSION LINE
 TRANSMISSION LINE JUMPERS
 TRANSMISSION LINE CONNECTORS WITH WEATHERPROOFING KITS
 TRANSMISSION LINE GROUND KITS
 TRANSMISSION LINE GROUND KITS

26.

- HOISTING GRIPS BTS EQUIPMENT
- 'n 2. THE CONTRACTOR IS RESPONSIBLE TO PROVIDE ALL OTHER MATERIALS FOR THE COMPLETE INSTALLATION OF THE SITE INCLUDING, BUT NOT LIMITED TO, SUCH MATERIALS, AS FENCING, STRUCTURAL STEEL SUPPORTING SUB-FRAME FOR PLATFORM, 28. ROOFING LABOR AND MATERIALS, GROUNDING RINGS, GROUNDING WIRES, COPPER-CLAD OR XIT CHEMICAL GROUND ROOFS), BUSS BARS, TRANSFORMERS AND DISCONNECT SWITCHES WHERE APPLICABLE, TEMPORARY ELECTRICAL POWER, CONDUIT, LANDSCAPING COMPOUND STONE, CRAVES, CORE DRILLING, SLEEPERS AND RUBBER MATTING, REBAR, CONCRETE CAUSSONS, PADS AND/DORR AUGER MOUNTS, MISCELLANEOUS FASTENERS, CABLE TRAYS, NON-STANDARD ANTENNA FRAMES AND ALL OTHER MATERIAL AND LABOR REQUIRED TO COMPLETE THE LOB ACCORDING TO THE DRAWMINGS AND SECCIFICATIONS, IT IS THE POSSITION OF THOSILE TO APPLY FOR PERMITTING AND CONTRACTOR RESPONSIBLE FOR PICKUP AND PAYMENT OF REQUIRED PERMITTING AND CONTRACTOR RESPONSIBLE FOR PICKUP AND PAYMENT OF REQUIRED
- ALL WORK SHALL CONFORM TO ALL CURRENT APPLICABLE FEDERAL, STATE, AND LOCAL CODES, INCLUDING ANSIEIA/TIA-222, AND COMPLY WITH ATC CONSTRUCTION SPECIFICATIONS.
- CONTRACTOR SHALL CONTACT LOCAL 811 FOR IDENTIFICATION OF UNDERGROUND UTILITIES PRIOR TO START OF CONSTRUCTION.

30.

- CONTRACTOR SHALL BE RESPONSIBLE FOR COORDINATING ALL REQUIRED INSPECTIONS.
- ALL DIMENSIONS TO, OF, AND ON EXISTING BUILDINGS, DRAINAGE STRUCTURES, AND SITE IMPROVEMENTS SHALL BE VERIFIED IN FIELD BY CONTRACTOR WITH ALL DISCREPANCIES REPORTED TO THE ENGINEER.
- DO NOT CHANGE SIZE OR SPACING OF STRUCTURAL ELEMENTS.
- DETAILS SHOWN ARE TYPICAL; SIMILAR DETAILS APPLY TO SIMILAR CONDITIONS UNLESS OTHERWISE NOTED.
- THESE DRAWINGS DO NOT INCLUDE NECESSARY COMPONENTS FOR CONSTRUCTION SAFETY WHICH SHALL BE THE SOLE RESPONSIBILITY OF THE CONTRACTOR.
- CONTRACTOR SHALL BRACE STRUCTURES UNTIL ALL STRUCTURAL ELEMENTS NEEDED FOR STABILITY ARE INSTALLED, THESE ELEMENTS ARE AS FOLLOWS: LATERAL BRACING, ANCHOR BOLTS, ETC.
- CONTRACTOR SHALL DETERMINE EXACT LOCATION OF EXISTING UTILITIES, GROUNDS DRAINS, DRAIN PIPES, VENTS, ETC. BEFORE COMMENCING WORK.
- INCORRECTLY FABRICATED, DAMAGED, OR OTHERWISE MISFITTING OR NONCONFORMING MATERIALS OR CONDITIONS SHALL BE REPORTED TO THE TAMOBILE REP PRIOR TO REMEDIAL ACTION ORRECTURE, ACTION, ANY SUCH REMEDIAL ACTION SHALL REQUIRE WRITTEN APPROVAL BY THE T-MOBILE REP PRIOR TO PROCEEDING.
- 13. EACH CONTRACTOR SHALL COOPERATE WITH THE T-MOBILE REP, AND COORDINATE HIS WORK WITH THE WORK OF OTHERS.
- 4 CONTRACTOR SHALL REPAIR ANY DAMAGE CAUSED BY CONSTRUCTION OF THIS PROJECT TO MATCH EXISTING PRE-CONSTRUCTION CONDITIONS TO THE SATISFACTION OF THE T-MOBILE CONSTRUCTION MANAGER.
- ALL CABLE/CONDUIT ENTRY/EXIT PORTS SHALL BE WEATHERPROOFED DURING INSTALLATION USING A SILICONE SEALANT.

15

- WHERE EXISTING CONDITIONS DO NOT MATCH THOSE SHOWN IN THIS PLAN SET, CONTRACTOR SHALL NOTIFY THE T-MOBILE REP AND ENGINEER OF RECORD IMMEDIATELY.
- 16.
- 17. CONTRACTOR SHALL ENSURE ALL SUBCONTRACTORS ARE PROVIDED WITH A COMPLETE AND CURRENT SET OF DRAWINGS AND SPECIFICATIONS FOR THIS PROJECT.
- 18. CONTRACTOR SHALL REMOVE ALL RUBBISH AND DEBRIS FROM THE SITE AT THE END OF EACH DAY.
- 19. CONTRACTOR SHALL COORDINATE WORK SCHEDULE WITH AMERICAN TOWER CORPORATION (ATC) AND TAKE PRECAUTIONS TO MINIMIZE IMPACT AND DISRUPTION OF OTHER OCCUPANTS OF THE FACILITY.
- 20. CONTRACTOR SHALL FURNISH T-MOBILE AND AMERICAN TOWER CORPORATION (ATC) WITH A PDF MARKED UP AS-BUILT SET OF DRAWINGS UPON COMPLETION OF WORK.
- 21. PRIOR TO SUBMISSION OF BID, CONTRACTOR SHALL COORDINATE WITH T-MOBILE REP TO DETERMINE WHAT, IF ANY, ITEMS WILL BE PROVIDED. ALL ITEMS NOT PROVIDED SHALL BE PROVIDED AND INSTALLED BY THE CONTRACTOR. CONTRACTOR WILL INSTALL ALL ITEMS PROVIDED.
- ALL COAXIAL CABLE GROUNDING KITS ARE TO BE INSTALLED ON STRAIGHT RUNS OF

23 PRIOR TO SUBMISSION OF BID, CONTRACTOR SHALL COORDINATE WITH TAMOBILE REP TO DETERMINE IF ANY PERMITS WILL BE OBTAINED BY CONTRACTOR, ALL REQUIRED PERMITS NOT OBTAINED BY TAMOBILE MUST BE OBTAINED, AND PAID FOR, BY THE CONTRACTOR,

COAXIAL CABLE (NOT WITHIN BENDS)

CONTRACTOR SHALL INSTALL ALL SITE SIGNAGE IN ACCORDANCE WITH T-MOBILE SPECIFICATIONS AND REQUIREMENTS.

23.

- 24. CONTRACTOR SHALL SUBMIT ALL SHOP DRAWINGS TO T-MOBILE FOR REVIEW AND APPROVAL PRIOR TO FABRICATION.
- 25.
- ALL EQUIPMENT SHALL BE INSTALLED ACCORDING TO MANUFACTURER'S SPECIFICATIONS AND LOCATED ACCORDING TO TAMOBILE SPECIFICATIONS, AND AS SHOWN IN THESE PLANS.
- THE CONTRACTOR SHALL SUPERVISE AND DIRECT THE PROJECT DESCRIBED HEREIN. THE CONTRACTOR SHALL BE SOLELY RESPONSIBLE FOR ALL THE CONSTRUCTION MEANS, METHODS, TECHNIQUES, SEQUENCES AND PROCEDURES AND FOR COORDINATING ALL PORTIONS OF THE WORK UNDER THE CONTRACT.
- CONTRACTOR SHALL NOTIFY T-MOBILE REP A MINIMUM OF 48 HOURS IN ADVANCE OF POURING CONCRETE OR BACKFILLING ANY UNDERGROUND UTILITIES, FOUNDATIONS OR SEALING ANY WALL, FLOOR OR ROOF PENETRATIONS FOR ENGINEERING REVIEW AND

27.

- 28. CONTRACTOR SHALL BE RESPONSIBLE FOR SITE SAFETY INCLUDING COMPLIANCE WITH ALL APPLICABLE OSHA STANDARDS AND RECOMMENDATIONS AND SHALL PROVIDE ALL NECESSARY SAFETY DEVICES INCLUDING PPE AND PPM AND CONSTRUCTION DEVICES SUCH AS WELDING AND FIRE PREVENTION, TEMPORARY SHORING, SCAFFOLDING, TRENCH BOXES/SLOPING, BARRIERS, ETC.
- 29. THE CONTRACTOR SHALL PROTECT AT HIS OWN EXPENSE, ALL EXISTING FACILITIES AND SUCH OF HIS NEW WORK LIABLE TO INJURY DURING THE CONSTRUCTION PERIOD. ANY DAMAGE CAUSES BY WEGLECT ON THE PART OF THIS CONTRACTOR OR HIS REPRESENTATIVES, OR BY THE ELEMENTS DUE TO NEGLECT ON THE PART OF THIS CONTRACTOR OR HIS REPRESENTATIVES, EITHER TO THE EXISTING WORK, OR TO HIS WORK OR THE WORK OF THE CONTRACTOR, SHALL BE REPAIRED AT HIS EXPENSE TO THE OWNER'S SATISFACTION.
- ALL WORK SHALL BE INSTALLED IN A FIRST CLASS, NEAT AND WORKMANLIKE MANNER BY MECHANICS SKILLED IN THE TRADE INVOLVED. THE QUALITY OF WORKMANSHIP SHALL BE SUBJECT TO THE APPROVAL OF THE TANDEILE REP. ANY WORK FOUND BY THE T-MOBILE REP TO BE OF INFERIOR QUALITY AND/OR WORKMANSHIP SHALL BE REPLACED AND/OR REWORKED AT CONTRACTOR EXPENSE UNTIL APPROVAL IS
- 31. IN ORDER TO ESTABLISH STANDARDS OF QUALITY AND PERFORMANCE, ALL TYPES OF MATERIALS LISTED HERRINAFTER BY MANUFACTURER'S NAMES ANDIOR MANUFACTURER'S CATALOG NUMBER SHALL BE PROVIDED BY THESE MANUFACTURERS AS SPECIFIED.
- 32 T-MOBILE FURNISHED EQUIPMENT SHALL BE PICKED-UP AT THE T-MOBILE WAREHOUSE, NO LATER THAN 48HR AFTER BEING NOTIFIED INSURED, STORED, UNCRATE, PROTECTED AND INSTALLED BY THE CONTRACTOR WITH ALL APPURTENANCES REQUIRED TO PLACE THE EQUIPMENT IN OPERATION, READY FOR USE, THE CONTRACTOR SHALL BE RESPONSIBLE FOR THE EQUIPMENT AFTER PICKING IT UP.
- 33. T-MOBILE OR HIS ARCHITECT/ENGINEER RESERVES THE RIGHT TO REJECT ANY EQUIPMENT OR MATERALS WHICH, IN HIS OWN OPINION ARE NOT IN COMPLIANCE WITH THE CONTRACT DOCUMENTS, ETHER BEFORE OR AFFER RISTALLATION AND THE EQUIPMENT SHALL BE REPLACED WITH EQUIPMENT CONFORMING TO THE REPLACED WITH EQUIPMENT CONFORMING TO THE REPLACED WITH CONFORMING TO THE CONTRACT DOCUMENTS BY THE CONTRACTOR AT NO COST TO T-MOBILE OR THEIR ARCHITECT/ENGINEER.

SPECIAL CONSTRUCTION ANTENNA INSTALLATION NOTES:

WORK INCLUDED:

- ANTENNA AND COAXIAL CABLES ARE FURNISHED BY T-MOBILE UNDER A SEPARATE CONTRACT, THE CONTRACTOR SHALL ASSIST ANTENNA INSTALLATION CONTRACTOR IN TERMS OF COORDINATION AND SITE ACCESS. ERECTION SUBCONTRACTOR SHALL BE RESPONSIBLE FOR THE PROTECTION OF PERSONNEL.
- INSTALL ANTENNAS AS INDICATED ON DRAWINGS AND T-MOBILE SPECIFICATIONS.
- Ü INSTALL GALVANIZED STEEL ANTENNA MOUNTS AS INDICATED ON DRAWINGS.
- D. INSTALL FURNISHED GALVANIZED STEEL OR ALUMINUM WAVEGUIDE.
- im CONTRACTOR SHALL PROVIDE FOUR (4) SETS OF SWEEP TESTS USING ANRITZU-PACKARD 87/3B RF SCALAR NETWORK ANALYZER, SUBMIT FREQUENCY DOMAIN REFLECTOMETRE/PBQT TESTS RESULTS TO THE PROJECT HANAGER. SWEEP TESTS SHALL BE AS PER ATTACHED RES "MINIMUM FIELD TESTING RECOMMENDED FOR ANTENNA AND HELIJAX COAXIAL CABLE SYSTEMS" DATED 105/83. TESTING SHALL BE REFEGRANED BY AN INDEPENDENT TESTING SERVICE AND BE BOUND AND SUBMITTED WITHIN ONE WEEK OF WORK COMPLETION.
- INSTALL COAXIAL CABLES AND TERMINATING BETWEEN ANTENNAS AND EQUIPMENT FER MANUFACTURER'S RECOMMENDATIONS, WEATHERPROOF ALL CONNECTIONS BETWEEN THE ANTENNA AND EQUIPMENT PER MANUFACTURER'S REQUIREMENTS, TERMINATE ALL COAXIAL CABLE THREE (3) FEET IN EXCESS OF ENTRY PORT LOCATION UNLESS OTHERWISE STATED.
- ALL EXTERIOR #6 GREEN GROUND WIRE "DAISY CHAIN" CONNECTIONS AGE TO BE WEATHER SEALED WITH RPS CONNECTORS/SPLICE WEATHERPROOFING KIT #221213 OR EQUAL.



ENGINEERING GROUP, INC.

TOGETHER PLANNING A BETTER TOMORROW
158 BUSINESS CENTER DRIVE
BIRMINGHAM, AL 35244
TEL: 205-252-8985 FAX: 205-320-1504

ATC SITE NUMBER: 24516

FOR CONSTRUCTION FOR CONSTRUCTION

ZDS 05/03/22 ZDS 04/05/22 ΥВ

DESCRIPTION

DATE

ATC SITE NAME: FALLING CREEK FL

175 AT 110 BOOMER T-MOBILE SITE NAME:

SITE ADDRESS: 1334 HUNTSVILLE CHURCH RD LAKE CITY, FL 32055-7044

SEAL:

NO. 75137

NO. 75137

AD STATE OF THE PROPERTY OF 105/03/22 05/03/22

T. Mobile

GENERAL NOTES

CUSTOMER ID: 175 AT 110 BOOMER CUSTOMER #: 9JK0218A

DATE DRAWN: 04/05/22 ATC JOB NO: 13973819_G3

G-002 SHEET NUMBER:

REVISION:

ALL DISCREPANCIES FROM WHAT IS SHOWN ON THESE CONSTRUCTION DRAWINGS SHALL BE COMMUNICATED TO ATC ENGINEERING IMMREDIATELY FOR CORRECTION OR RE-DESIGN. FAILURE TO COMMUNICATE DIRECTLY WITH ATC ENGINEERING OR ANY CHANGES FROM THE DESIGN CONDUCTED WITHOUT PRIOR APPROVAL FROM ATC ENGINEERING SHALL BE THE SOLE

SITE PLAN NOTES:

- THIS SITE PLAN REPRESENTS THE BEST PRESENT KNOWLEDGE AVAILABLE TO THE ENGINEER AT THE TIME OF THIS DESIGN. THE CONTRACTOR SHALL VISIT THE SITE PRIOR TO CONSTRUCTION AND VERIFY ALL EXISTING CONDITIONS RELATED TO THE SCOPE OF WORK FOR THIS PROJECT.
- ICE BRIDGE, CABLE LADDER, COAX PORT, AND COAX CABLE ARE SHOWN FOR REFERENCE ONLY. CONTRACTOR SHALL CONFIRM THE EXACT LOCATION OF ALL PROPOSED AND EXISTING EQUIPMENT AND STRUCTURES DEPICTED ON THIS PLAN, BEFORE UTILIZING EXISTING CABLE SUPPORTS, COAX PORTS, INSTALLING NEW PORTS OR ANY OTHER EQUIPMENT, CONTRACTOR SHALL VERIFY ALL ASPECTS OF THE COMPONENTS MEET THE ATC SPECIFICATIONS.
- THIS PROJECT INCLUDES NO INSTALL OR MODIFICATION AT GRADE.

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GENERATOR GENERATOR RECEPTACAL HAND HOLE, VAULT DISCONNECT METER BOLLARD CELL SITE CABINET CHAINLINK FENCE TELCO POWER POLE KENTROX BOX GROUNDING TEST WELL AUTOMATIC TRANSFER SWITCH **TRANSFORMER** JIGHTING CONTROL EGEND


PROPOSED CABLE LENGTH:

- 1. ESTIMATED LENGTH OF PROPOSED CABLE IS 320.
 ESTIMATED LENGTH OF CABLE WAS PROVIDED BY CUSTOMER OR CALCULATED BY ADDING THE RAD CENTER AND THE DISTANCE FROM THE SHELTER ENTRY PLATE TO THE TOWER (ALONG THE ICE BRIDGE) AND A SAFETY FACTOR MEASUREMENT OF 15% (OF THE TWO PREVIOUS VALUES), CDS DEFER TO GREATEST CABLE LENGTH.

 2. ROUTE PROPOSED CABLES ALONG SAME PATH AS EXISTING CABLES AND IN ACCORDANCE WITH STRUCTURAL ANALYSIS. WHERE POSSIBLE UTILIZE EXISTING CABLE SUPPORT STRUCTURES AS PROVIDED FOR CARRIER TO ADEQUATELY SECURE CABLES, USING EITHER APPROPRIATELY SIZED STAINLESS STEEL SNAP-INS OR MOUNTING HARDWARE AND BRACKETS AS SPECIFIED BY CABLE SUPPORT STRUCTURES. OTHERWISE, ATTACH CABLES TO HORIZONTAL OR DIAGONAL TOWER MEMBERS USING PROPOSED STAINLESS STEEL ADAPTERS (DO NOT ATTACH TO TOWER LEG).

(IN FEET)
1 UNIT = 10 FEET

GRAPHIC SCALE

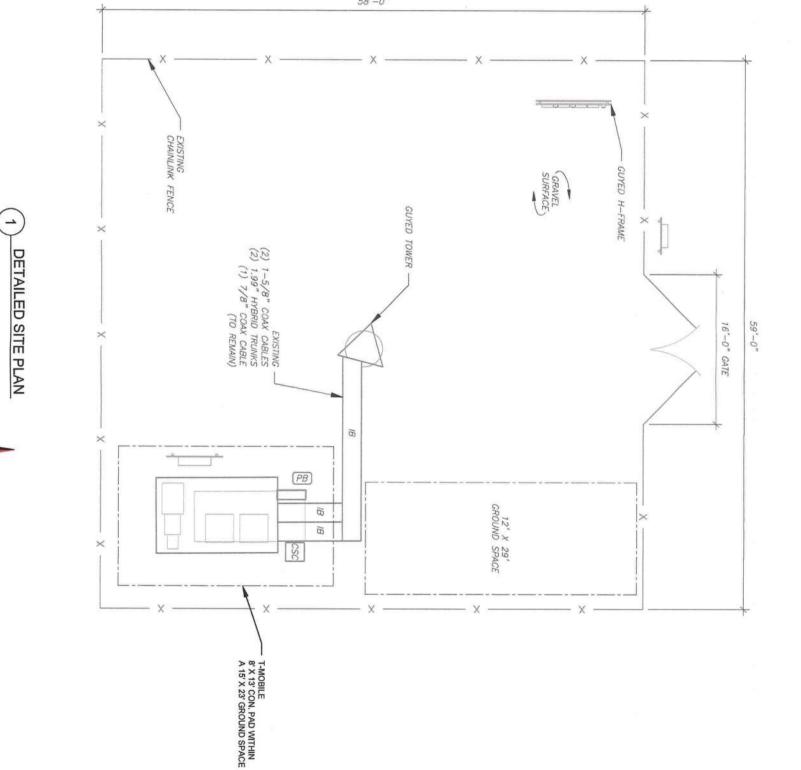



REVISION:

DATE DRAWN: 04/05/22

ATC JOB NO: 13973819_G3

CUSTOMER ID: 175 AT 110 BOOMER


CUSTOMER #: 9JK0218A TOGETHER PLANNING A BETTER TOMORROW
158 BUSINESS CENTER DRIVE
BIRMINGHAM, AL 35244
TEL: 205-252-6985 FAX: 205-320-1504 ENGINEERING GROUP, INC. T. Mobile FOR CONSTRUCTION FOR CONSTRUCTION SITE ADDRESS: 1334 HUNTSVILLE CHURCH RD LAKE CITY, FL 32055-7044 175 AT 110 BOOMER ATC SITE NAME: FALLING CREEK FL DESCRIPTION T-MOBILE SITE NAME: ATC SITE NUMBER: 24516 ZDS 05/03/22 ZDS 04/05/22 05/03/22 DATE

P P R

AMERICAN TOWER

SITE PLAN NOTES:

- CONTRACTOR TO VERIFY THERE IS NO LIVE AAV FIBER RUNNING THROUGH EXISTING DEAD EQUIPMENT. IF SO, THIS WILL NEED TO BE RERUN THROUGH CONDUIT PRIOR TO REMOVING DEAD 2G (8201 CABS) EQUIPMENT.
- ALL OPEN PORTS NEED TO BE SEALED / WEATHERPROOFED PROPERLY
- ALL UNNEEDED / EXCESS EQUIPMENT AND GARBAGE TO BE REMOVED FROM EQUIPMENT AREA DISPOSE OF MATERIALS PROPERLY OFF SITE.

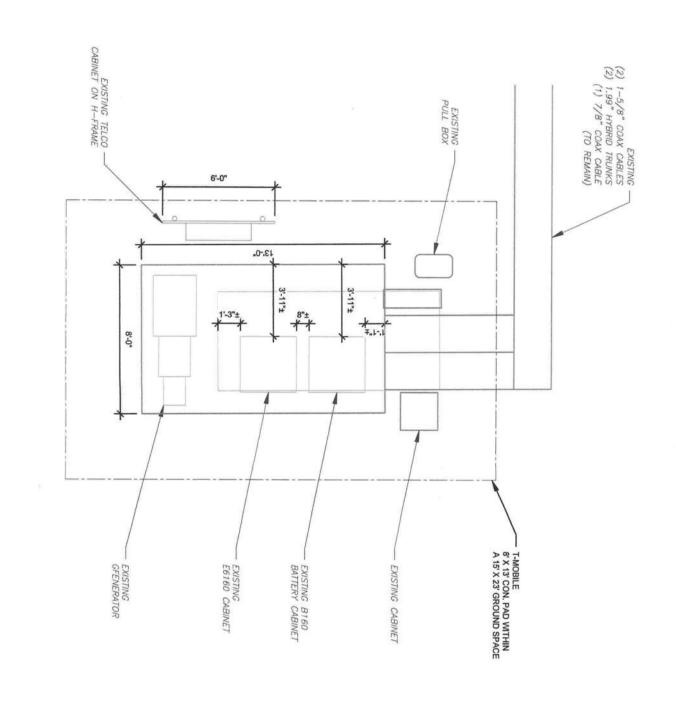

EXISTING GROUND EQUIPMENT LAYOUT


GRAPHIC SCALE

(IN FEET)
1 UNIT = 5 FEET

C-102

SHEET NUMBER:

REVISION:

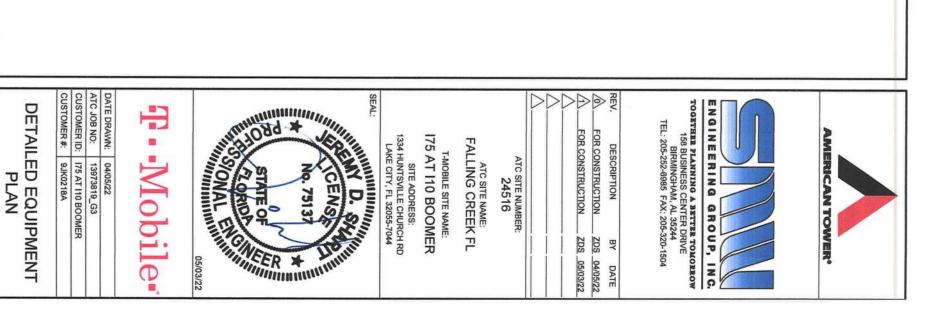

C-407 C-407 PROPOSED T-MOBILE EQUIPMENT (2) 1-5/8" COAX CABLES
(2) 1.99" HYBRID TRUNKS
(1) 7/8" COAX CABLE
(1) 7/8" (TO REMAIN) PROPOSED -SECTOR MOUNT (SABRE #C10857001C) (1 PER SECTOR) (TYP. 3) TOP OF EXISTING TOWER ELEV 300' TOP OF EXISTING HIGHEST APPURTENANCE ELEV 310' TOWER ELEVATION
SCALE: N.T.S. EXISTING TOWER RAD CENTER @ 250' T-MOBILE MW ANTENNA RAD CENTER @ 175' OF BASE PLATE TOWER NOTE:

1. IT IS THE CONTRACTOR'S RESPONSIBILITY TO CONFIRM WITH THE PROJECT MANAGER THAT THEY HAVE THE MOST RECENT VERSION OF THE STRUCTURAL ANALYSIS BEFORE COMMENCING WORK, EXISTING AND PROPOSED TOWER APPURTENANCES, MOUNTS, AND ANTENNAS ARE SHOWN BASED ON THE STRUCTURAL ANALYSIS.

2. WHERE APPLICABLE, ALL NEW ANTENNAS, EQUIPMENT, MOUNTS, CABLING, ETC. SHALL BE PAINTED/SOCKED TO MATCH EXISTING EQUIPMENT IN ACCORDANCE WITH FAA, JURISDICTION, AND/OR OTHER LOCAL REQUIPMENTS.

3. ROUTE PROPOSED CABLES ALONG SAME PATH AS EXISTING CABLE SUPPORT STRUCTURES AS EXISTING CABLE SUPPORT STRUCTURES AS PROVIDED FOR CARRIER TO ADEQUATELY SECURE CABLES, USING EITHER APPROPRIATELY SIZED STAINLESS STEEL SNAP-JINS OR MOUNTING HARDWARE AND BRACKETS AS SPECIFIED BY CABLE TO HORIZONTAL OR DIAGONAL TOWER MEMBERS USING PROPOSED STAINLESS STEEL ADAPTERS (DO NOT ATTACH TO TOWER LEG).

4. TOWER ELEVATIONS ARE MEASURED FROM TOP OF BASE PLATE TO MATCH STRUCTURAL ANALYSIS, ELEVATIONS DO NOT REFLECT TRUE ABOVE GROUND LEVEL (AGL.)

5. TOWER ELEVATION STRUCTURAL ANALYSIS FOR FULL TOWER LOADING.

THE EXISTING MOUNT CANNOT ADEQUATELY SUPPORT THE PROPOSED LOADING. THE PROPOSED MOUNT REPLACEMENT, DETAILED AT THE END OF THIS PLAN SET, MUST BE INSTALLED PRIOR TO THE INSTALLATION OF THE PROPOSED ANTENNAS AND OTHER EQUIPMENT.

TOWER ELEVATION

DATE DRAWN: 04/05/22
ATC JOB NO: 13973819_G3
CUSTOMER ID: 175 AT 110 BOOMER
CUSTOMER #: 9JK0218A

C-201 SHEET NUMBER:

REVISION:

T · Mobile ·

SEAL:

NO. 75137

NO. 75137

NO. 75137

JORNOVAL ELIGINATION

OS/03/22 05/03/22

SITE ADDRESS: 1334 HUNTSVILLE CHURCH RD LAKE CITY, FL 32055-7044 175 AT 110 BOOMER

SEAL:

T-MOBILE SITE NAME:

ATC SITE NAME:
FALLING CREEK FL

ATC SITE NUMBER: 24516


FOR CONSTRUCTION FOR CONSTRUCTION DESCRIPTION ZDS 05/03/22 ZDS 04/05/22 ΥВ DATE

TOGETHER PLANNING A BETTER TOMORROW
158 BUSINESS CENTER DRIVE
BIRMINGHAM, AL 35244
TEL: 205-252-8585 FAX: 205-320-1504

ENGINEERING GROUP, INC.





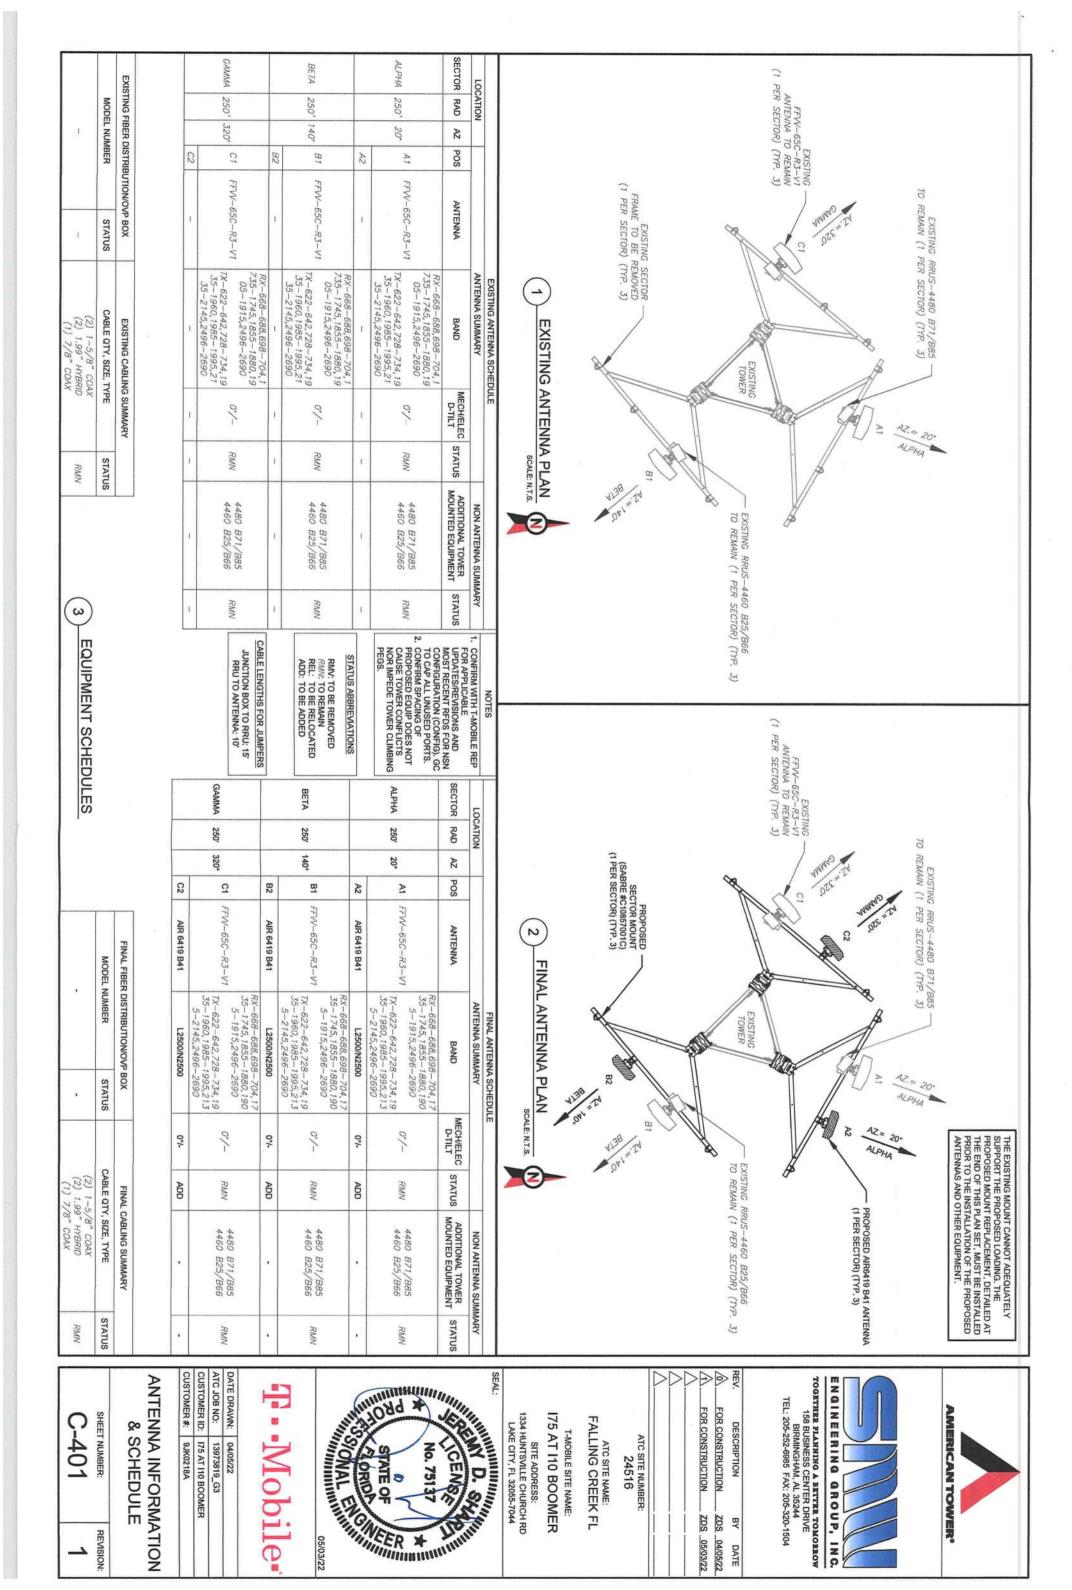


C-501 REVISION:

CONSTRUCTION DETAILS

CUSTOMER #: 9JK0218A

DATE DRAWN:	04/05/22
ATC JOB NO:	13973819_G3
CUSTOMER ID:	CUSTOMER ID: 175 AT 110 BOOMER

7

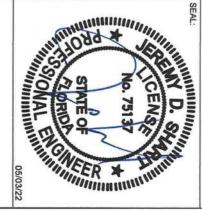

SITE ADDRESS: 1334 HUNTSVILLE CHURCH RD LAKE CITY, FL 32055-7044

T-MOBILE SITE NAME: 175 AT 110 BOOMER

ATC SITE NAME: FALLING CREEK FL

ATC SITE NUMBER: 24516

FOR CONSTRUCTION FOR CONSTRUCTION ZDS 04/05/22 ZDS 05/03/22

DESCRIPTION ВҮ DATE

TOGETHER PLANNING A BETTER TOMORROW
158 BUSINESS CENTER DRIVE
BIRMINGHAM, AL 35244
TEL: 205-252-6985 FAX: 205-320-1504

PROPOSED ANTENNA

- PROPOSED
SECTOR MOUNT
(SABRE #C10857001C)
(1 PER SECTOR) (TYP. 3)

PROPOSED 2-1/2" O.D. X 96" LONG





PROPOSED 5G ANTENNA MOUNTING DETAIL - TYPICAL
SCALE: N.T.S.

NOT TO EXCEED (H x W x D) 1) 34552 - ERICSSON AIR 6419 BAND 41 MAXIMUM OUTER DIMENSIONS CIRCULAR 4.49" 900 OPTICAL INDICATORS

(A) = FAULT (RED)

(B) = OPERATIONAL (GREEN)

(C) = MANTENANCE (BLUE)

(C) = MANTENANCE (BLUE) O.® o

DATE DRAWN: 04/05/22

ATC JOB NO: 13973819_G3

CUSTOMER ID: 175 AT 110 BOOMER

CUSTOMER #: 9JK0218A

EQUIPMENT SPECIFICATIONS

C-502 SHEET NUMBER:

REVISION:

T. Mobile

05/03/22

No. 75137

No. 75137

No. 75137

ADRIDA ENGINEER

05/03/22

SITE ADDRESS: 1334 HUNTSVILLE CHURCH RD LAKE CITY, FL 32055-7044

175 AT 110 BOOMER

T-MOBILE SITE NAME:

ATC SITE NAME: FALLING CREEK FL

ATC SITE NUMBER: 24516



TOGETHER PLANNING A BETTER TOMORROW
158 BUSINESS CENTER DRIVE
BIRMINGHAM, AL 35244
TEL: 205-252-6985 FAX: 205-320-1504

FOR CONSTRUCTION ZDS 05/03/22


FOR CONSTRUCTION

ZDS 04/05/22 ВΥ

DATE

DESCRIPTION

ENGINEERING GROUP, INC.

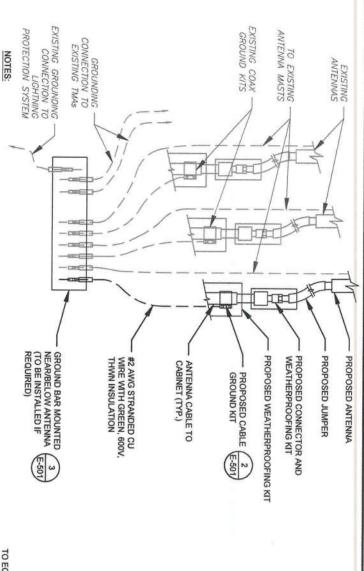


- THIS DETAIL IS INTENDED TO SHOW THE GENERAL GROUNDING REQUIREMENTS, SLIGHT ADJUSTMENTS MAY BE REQUIRED BASED ON EXISTING SITE CONDITIONS, THE CONTRACTOR SHALL MAKE FIELD ADJUSTMENTS AS NEEDED AND INFORM THE CONSTRUCTION MANAGER OF ANY CONFLICTS.

 SITE GROUNDING SHALL COMPLY WITH T-MOBILE GROUNDING STANDARDS, LATEST EDITION, AND COMPLY WITH T-MOBILE GROUNDING CHECKLIST, LATEST VERSION. WHEN NATIONAL AND LOCAL GROUNDING CODES ARE MORE STRINGENT THEY SHALL GOVERN.

TYPICAL ANTENNA GROUNDING DIAGRAM

ELECTRICAL NOTES:

IT IS THE RESPONSIBILITY OF THE CONTRACTOR TO COORDINATE WITH THE T-MOBILE REPRESENTATIVE AND LOCAL UTILITY COMPANY FOR THE INSTALLATION OF CONDUITS, CONDUCTORS, BREAKERS, DISCONNECTS, OR ANY OTHER EQUIPMENT REQUIRED FOR ELECTRICAL SERVICE: ALL ELECTRICAL WORK SHALL BE PERFORMED IN ACCORDANCE WITH LATEST EDITION OF THE STATE AND NATIONAL CODES, ORDINANCES AND REGULATIONS APPLICABLE TO THIS PROJECT.

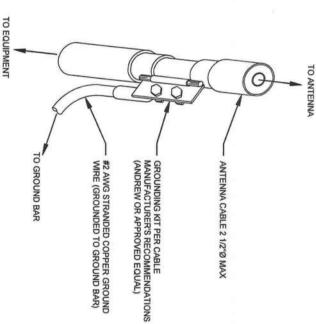


- GROUND KIT NOTES:

 1. DO NOT INSTALL CABLE GROUND KIT AT A BEND AND ALWAYS DIRECT
 GROUND WARE DOWN TO GROUND BAR.

 2. CONTRACTOR SHALL PROVIDE WEATHERPROOFING KIT (ANDREW PART
 NUMBER 221213) AND INSTALLTAPE PER MANUFACTURER'S SPECIFICATIONS.
- CABLE GROUND KIT CONNECTION DETAIL
 SCALE: N.T.S.


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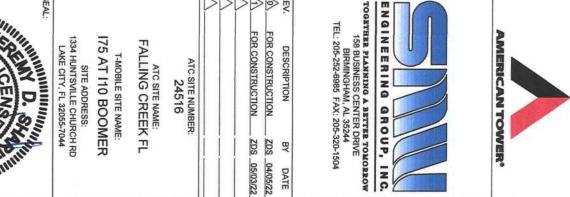


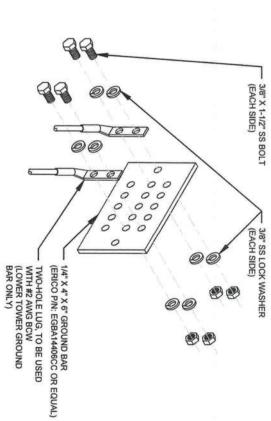GROUND BAR NOTES:

- GROUND BAR KITS COME WITH ALL HARDWARE, NUTS, BOLTS, WASHERS, ETC. EXCEPT THE STRUCTURAL MOUNTING MEMBER(S).
- GROUND BAR TO BE BONDED DIRECTLY TO TOWER.





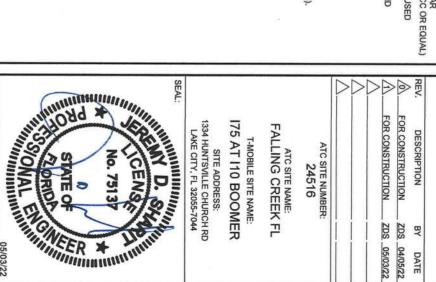



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FOR SPECIFIC CABINET / ANCILLARY EQUIPMENT WIRING REQUIREMENTS, THE T-MOBILE CONTRACTOR SHOULD REFERENCE DESIGN DOCUMENTS PROVIDED BY T-MOBILE FOR THIS CURRENT PROJECT CONFIGURATION, IN ACCORDANCE WITH LOCAL JURISDICTION REQUIREMENTS & NEC STANDARDS &

OCPD SIZE 80A/2P 100/2P

WIRE SIZE

GROUND SIZE

CONDUIT SIZE

2#3 AWG 2#2 AWG

ATC HAS NOT VERIFIED ANY EXISTING T-MOBILE GROUND EQUIPMENT OR ELECTRICAL LOADING, PROPOSED WORK BASED ON INSTALLATION CONFIGURATION PROVIDED BY T-MOBILE. CONTRACTOR TO VERIFY EXISTING T-MOBILE PANEL HAS SUFFICIENT SPACE FOR PROPOSED BREAKER. PROPOSED CABLE AND CONDUIT SHALL BE MINIMUM SIZE PER BELOW IN CHART.

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ELECTRICAL NOTES

2#1/0 AWG

#8 AWG #8 AWG #8 AWG #8 AWG

2#1 AWG

1-1/2" 1-1/4" 1-1/4"

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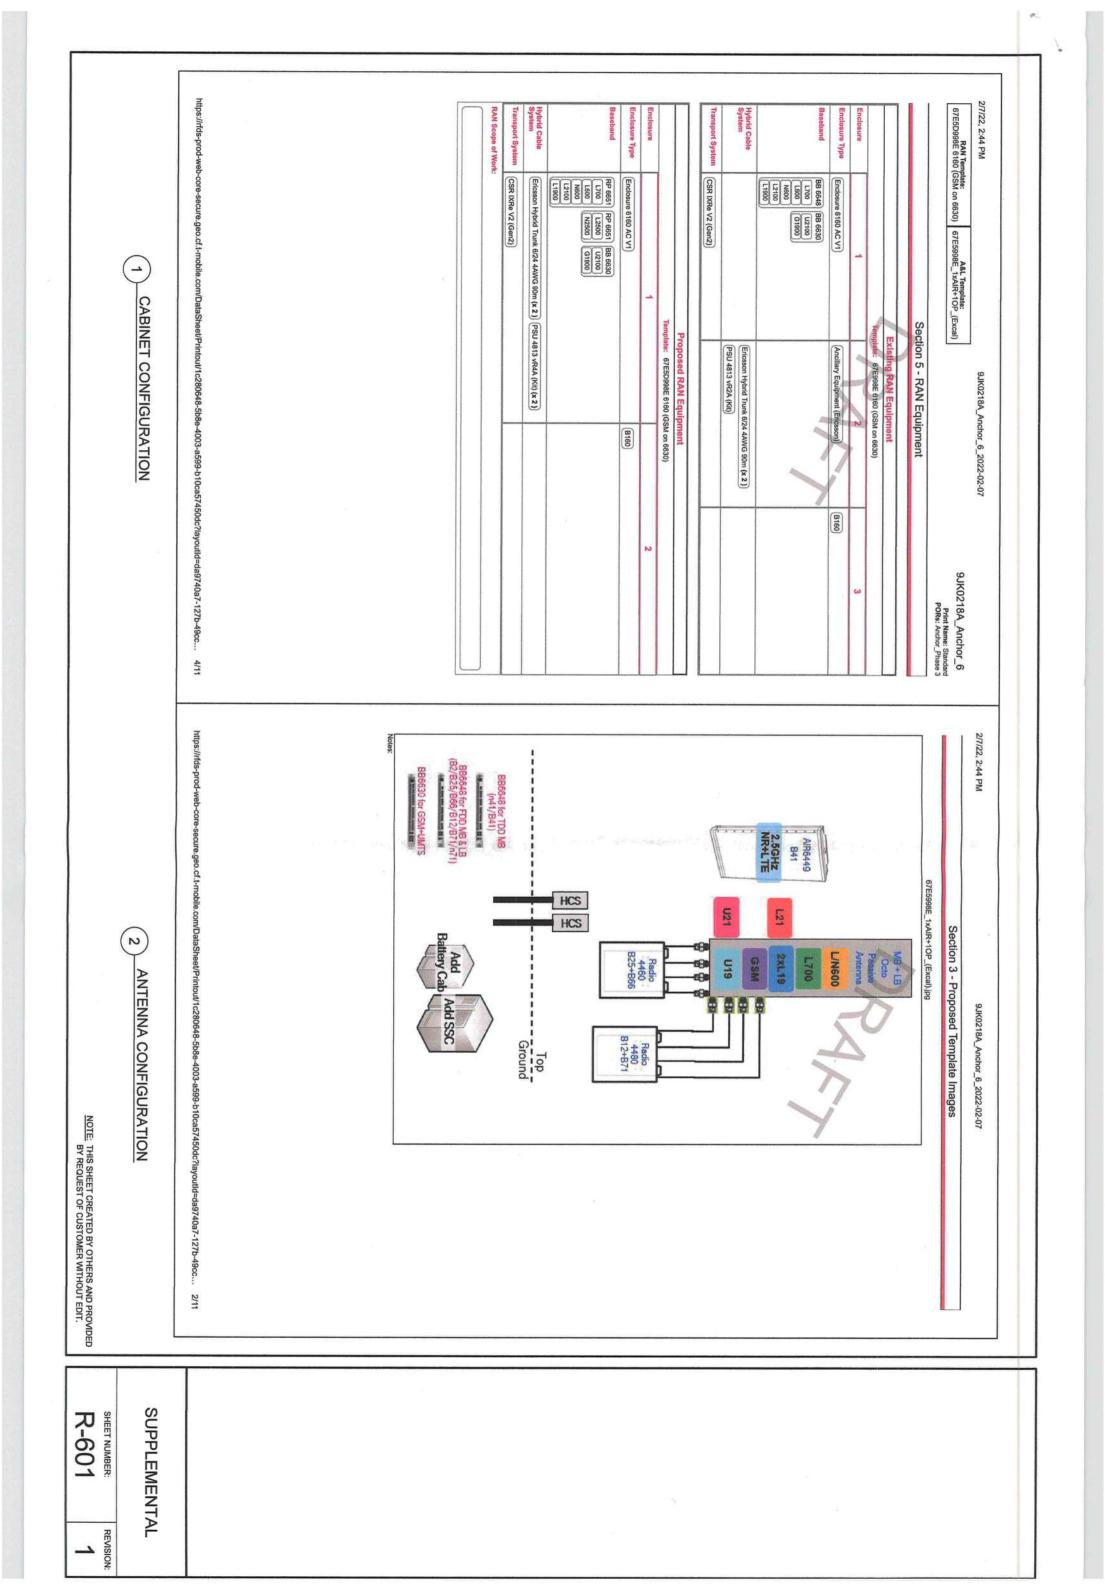
חבר החברים	20000
DATE DRAWN:	04/05/22
ATC JOB NO:	13973819_G3
CUSTOMER ID:	175 AT 110 BOOMER


GROUNDING DETAILS

CUSTOMER #: 9JK0218A

E-501 SHEET NUMBER:

REVISION:



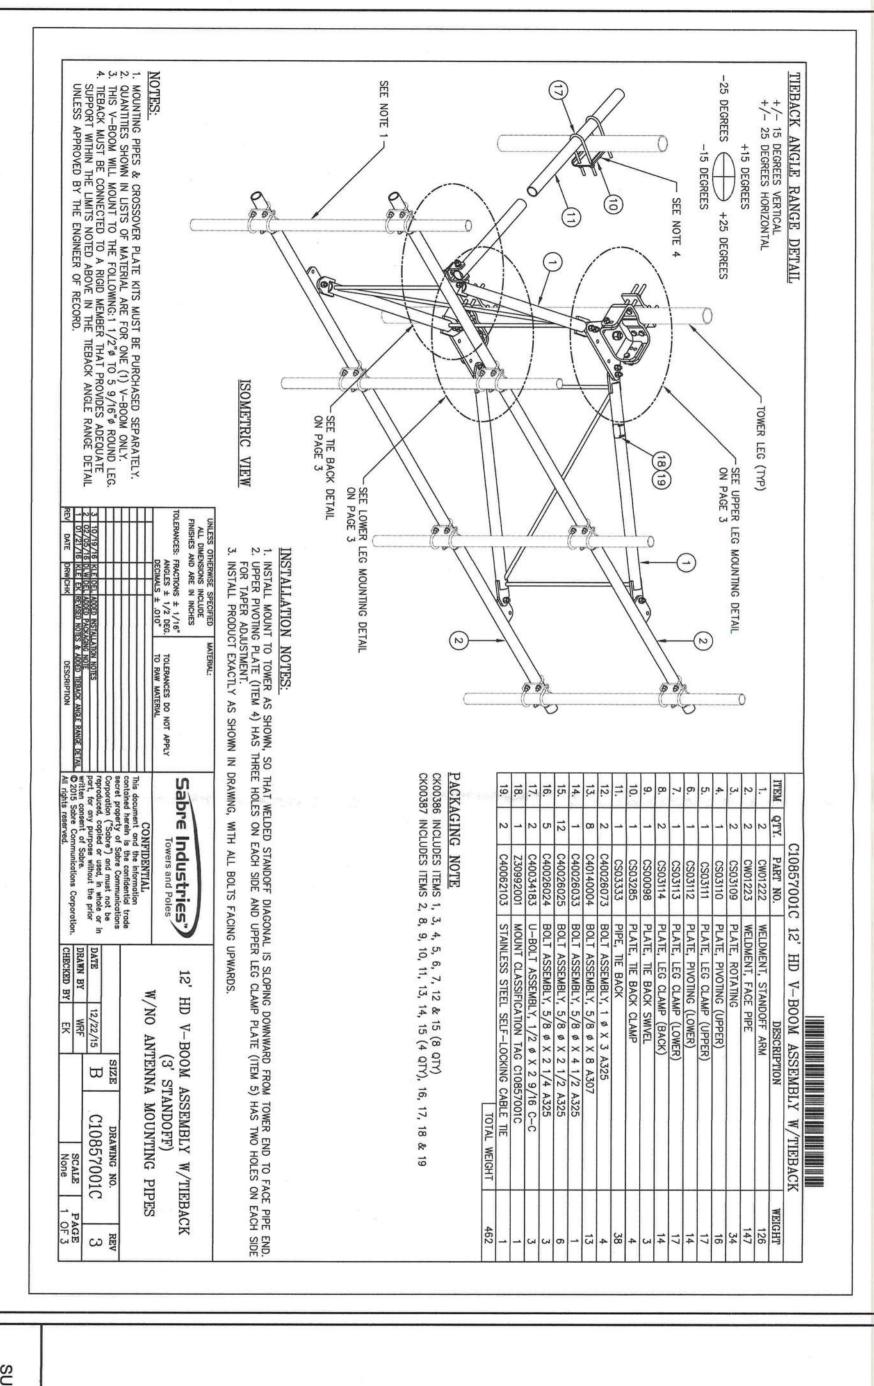

SUPPLEMENTAL
SHEET NUMBER:
R-602

REVISION:

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MOUNT DETAIL