# 11.32kW PV SYSTEM 1196 SW DAIRY ST,

**DUPREE RESIDENCE** LAKE CITY, FL 32024 **HOUSE PHOTO CODES AND STANDARDS OWNER** DUPREE, RICHARD-JASON **INSTALLER** 

## **EQUIPMENT SUMMARY**

SYSTEM SIZE: 11.32 kW DC STC

ARRAY AREA #1: 351.06 SQ FT.

ARRAY AREA #2: 253.55 SQ FT.

31 LG: LG365N1C-N6 (365W) MODULES

31x365 LG: LG365N1C-N6 (365W) MODULES

ENPHASE IQ7PLUS-72-2-US MICROINVERTERS

ROOF MOUNTED SOLAR PHOTOVOLTAIC MODULES

PROJECT DESCRIPTION:

**ENPHASE ENCHARGE 10 BATTERY** 

**ENPHASE ENPOWER SMART SWITCH** 01

RACKING: UNIRAC LIGHT RAIL

ATTACHMENT: S-5-PROTEA BRACKET

**DESIGN CRITERIA:** 

WIND SPEED (ULT): 120 WIND SPEED (ASD): 93 RISK CATEGORY: **EXPOSURE:** 

#### **GOVERNING CODES:**

FLORIDA RESIDENTIAL CODE, 7TH EDITION 2020 (FRC) FLORIDA PLUMBING CODE, 7TH EDITION 2020 (FPC) FLORIDA BUILDING CODE, 7TH EDITION 2020 EDITION (FBC) FLORIDA MECHANICAL CODE, 7TH EDITION 2020 (FMC) NATIONAL ELECTRICAL CODE 2017 (NEC) ASCE 7-16

SUNPRO SOLAR 4492- EAGLE FALLS PLACE TAMPA, FL 33619 PH: (866) 450-1012

#### **ENGINEER**

Castillo Engineering Services LLC 620 N. Wymore Road, Suite 250, Maitland, FL 32751 TEL: (407) 289-2575 Ermocrates E. Castillo License#: FL PE 52590

SHEET#	SHEET DESCRIPTION	
G-01	COVER SHEET	
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PROJECT SITES



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Engineering C

**CASTILLO ENGINEERING** SERVICES, LLC COA # 28345 620 N. WYMORE ROAD,

SUITE 250, MAITLAND, FL 32751 TEL: (407) 289-2575 ERMOCRATES E. CASTILLO - FL PE 52590

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SERVICES, LLC REVISIONS

PROJECT INSTALLER

DATE REV

DESCRIPTION

PROJECT NAME

**DUPREE RESIDENCI** 

SW DAIRY ST, CITY, FL 32024

**COVER SHEET** 

SHEET SIZE ANSI B 11" X 17"

SHEET NUMBER G-01


STRUCTURAL CERTIFICATION:

I ERMOCRATES CASTILLO PE# 52590 AN ENGINEER LICENSED PURSUANT TO CHAPTER 471, CERTIFY THAT THE INSTALLATION OF THE MODULES IS IN COMPLIANCE WITH FBC: RESIDENTIAL 2020, CHAPTER 3. SECTION 101.4.9 AND SECTION 428: MANUFACTURED BUILDINGS. BUILDING STRUCTURE WILL SAFELY ACCOMMODATE WIND LATERAL AND UPLIFT FORCES, AND EQUIPMENT DEAD LOADS

## **ELECTRICAL CERTIFICATION:**

I ERMOCRATES CASTILLO PE# 52590 AN ENGINEER LICENSED PURSUANT TO CHAPTER 471, CERTIFY THAT THE PV ELECTRICAL SYSTEM AND ELECTRICAL COMPONENTS ARE DESIGNED AND APPROVED USING THE STANDARDS CONTAINED IN THE MOST RECENT VERSION OF THE FLORIDA BUILDING CODE. FBC 107, THE NEC 2017, AND THOSE SET FORTH BY THE FLORIDA SOLAR **ENERGY CENTER CERTIFICATION** 

VICINITY MAP PROJECT SITE

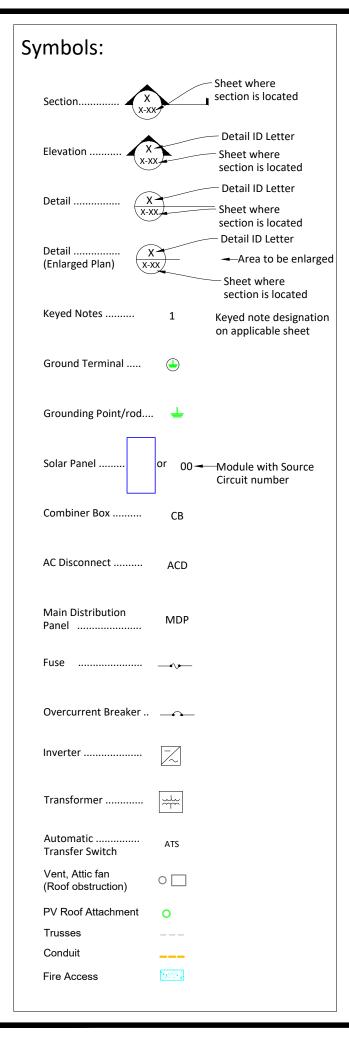

#### Abbreviations:

Abbrevi	ations:
ACD	AC Disconnect
AC	Alternating Current
APPROX	Approximate
AWG	American Wire Gauge
BAT	Enphase Encharge Battery
СВ	Combiner Box
DC	Direct Current
DISC	Disconnect
(E)	Existing
EL	Elevation
EQ	Equal
GP	Generation Panel
JB	Junction Box
MCB	Main Combiner Box
MFR	Manufacturer
MID	Microgrid Interconnect Device
MIN	Minimum
MISC	Miscellaneous
MDP	Main Distribution Panel
(N)	New
NAVD	North American Vertical datum
OCPD	Over Current Protection Device
POCC	Point Of Common Coupling
PV	Photovoltaic
SF	Squarefoot/feet
STC	Standard Test Conditions
SD	Soladeck
TBD	To Be Determined
TYP	Typical
UNO	Unless Noted Otherwise
UM	Utility meter
VIF	Verify In Field


Weather Proof

WP

#### **System Description**

This system is a grid-tied, PV system, with PV generation consisting of 31 LG: LG365N1C-N6 (365W) MODULES with a combined STC rated dc output power of 11315 W. The modules are connected into 31 ENPHASE IQ7PLUS-72-2-US MICROINVERTERS. The inverter has electronic maximum power point tracking to maximize energy captured by the PV modules. The inverter also has an internal ground fault detection and interruption device that is set to disconnect the array in the event that a ground fault that exceeds one ampere should occur. The inverter has DC and AC disconnect integrated system and labels are provided as required by the *National Electrical Code* 

When the sun is shining, power from the PV array is fed into the inverter, where it is converted from DC to AC. The inverter output is then used to contribute to the power requirements of the occupancy. If PV power meets the requirements of the loads of the occupancy, any remaining PV power is sold back to the utility. When utility power is available, but PV power is not available, building loads are supplied by the utility.

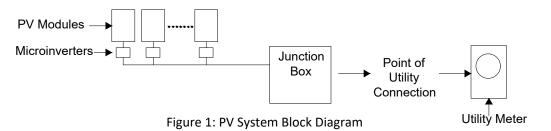

The inverter meets the requirements of IEEE 1547 and UL 1741.


#### **FALL PROTECTION:**

ANCHORAGES USED FOR ATTACHMENT OF PERSONAL FALL ARREST EQUIPMENT MUST BE INDEPENDENT OF ANY ANCHORAGE BEING USED TO SUPPORT OR SUSPEND PLATFORMS, AND CAPABLE OF SUPPORTING AT LEAST 5,000 POUNDS PER EMPLOYEE ATTACHED, OR MUST BE DESIGNED AND USED AS FOLLOWS:

- AS PART OF A COMPLETE PERSONAL FALL ARREST SYSTEM WHICH MAINTAINS A SAFETY FACTOR OF AT LEAST TWO.
- UNDER THE SUPERVISION OF A QUALIFIED PERSON

#### **ADDITIONAL INFORMATION**

- 29 CFR 1926 SUBPART M, FALL PROTECTION. OSHA STANDARD.
- 1926.502, FALL PROTECTION SYSTEMS CRITERIA AND PRACTICES
   1926.502(D)(15)

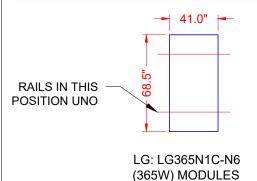

ALLOWABLE DESIGN PRESSURE	PSF
DOWN PRESSURE	125
UPLIFT PRESSURE, 2 RAILS	88

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DESCRIPTION	DATE	REV

PROJECT INSTALLER

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Signature with signed by:
Ermocrates
E Castillo
Date:

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PROJECT NAME

DUPREE RESIDENCE


1196 SW DAIRY LAKE CITY, FL 32

NOTES AND DESCRIPTION

ANSI B

SHEET NUMBER

A-00

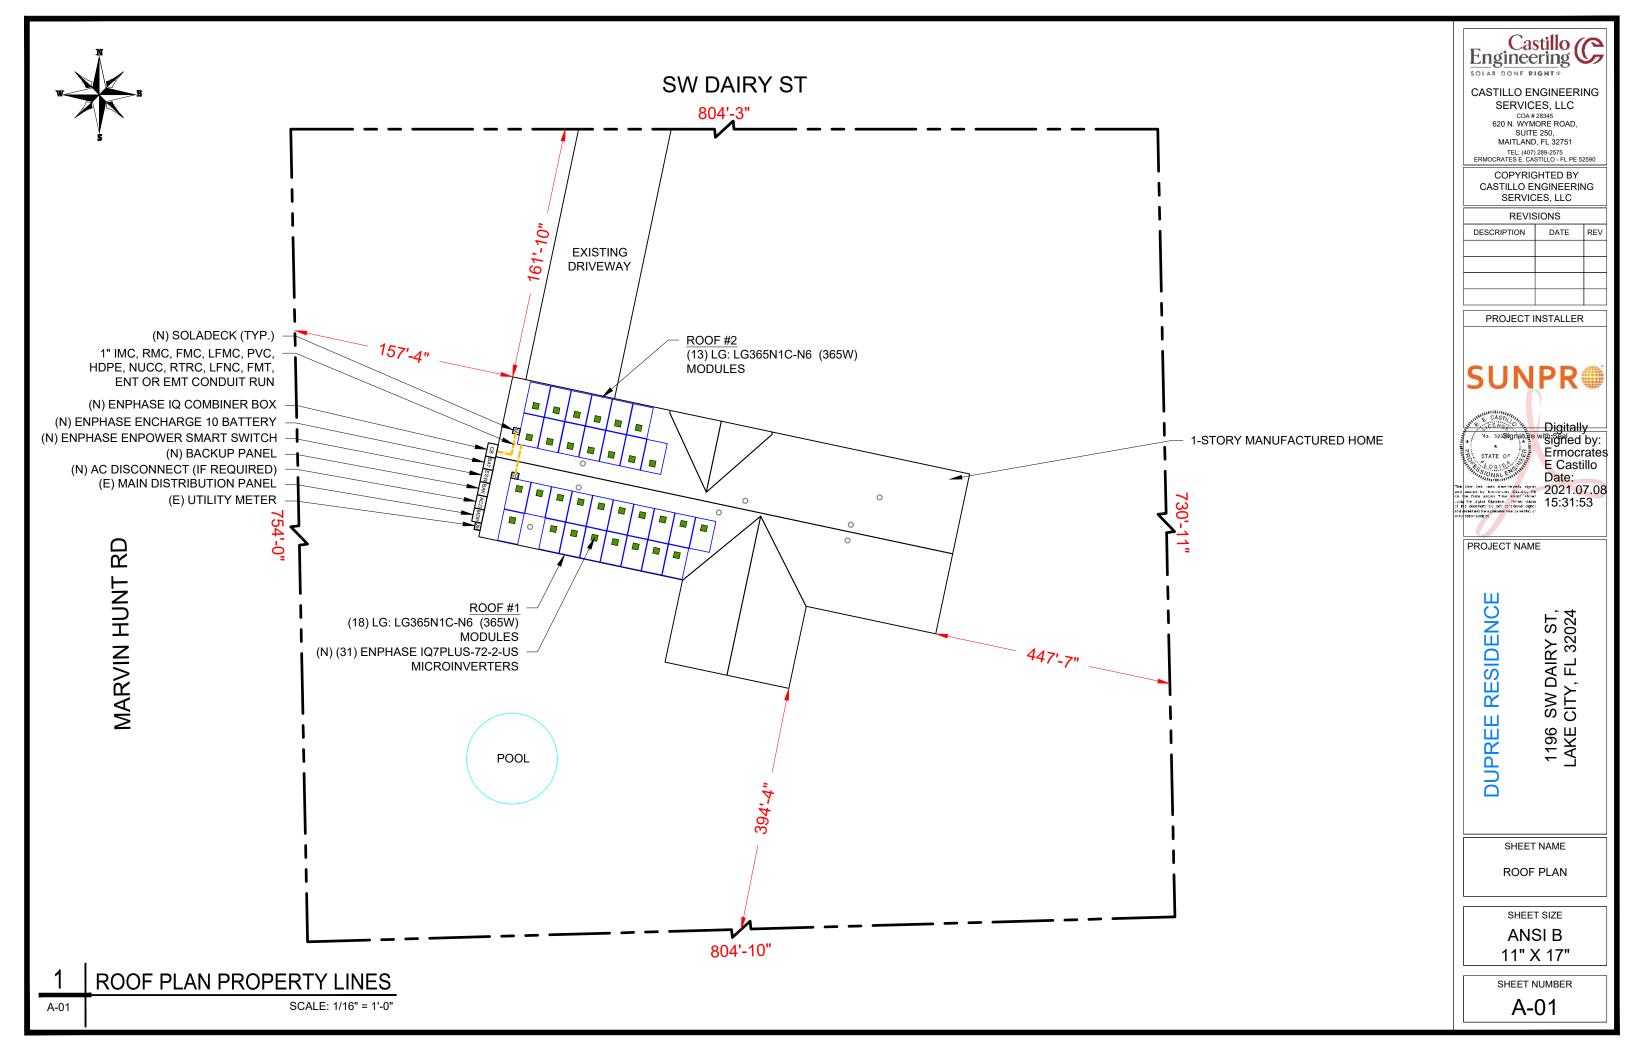

#### MODULE TYPE, DIMENSIONS & WEIGHT

NUMBER OF MODULES =31 MODULES MODULE TYPE = LG: LG365N1C-N6 (365W) MODULES WEIGHT = 41.01LBS / 18.6 KG. MODULE DIMENSIONS = 68.5" x 41.0" = 19.50 SF



ROOF	ROOF TYPE	ARRAY AREA (Sq. Ft.)	ROOF AREA (Sq. Ft.)	ROOF AREA COVERED BY ARRAY (%)	TILT	AZIMUTH	SEAM SPACING
#1	METAL	351.06	922.13	38.07	22.6°	192°	9" O.C.
#2	METAL	253.55	950.40	26.68	22.6°	12°	9" O.C.

	ROOF #2 (13) LG: LG365N1C-N6 (365W) MODULES ROOF #2 TILT - 22.6° AZIM 12°	(E) FRONT YARD
ROOF #1 (18) LG: LG365N1C-N6 (365W) MODULES	ROOF #1 TILT - 22.6° AZIM 192°	77'-10"    O-1/4
(N) UNIRAC LIGHT RAIL (TYP.) - (84) PV ROOF ATTACHMENT - @ 36" O.C. MAX. (SEE SHEET S-02 FOR ATTACHMENT DETAIL)		
(SEE SHEET S-01.1 FOR PARTIAL PRESSURE OF THE MODULE)	(E) BACK YARD	

#### GENERAL INSTALLATION PLAN NOTES:

1) ROOF ATTACHMENTS TO SEAM SHALL BE INSTALLED AS SHOWN IN SHEET S-02 AND AS FOLLOWS FOR EACH WIND ZONE:

WIND	NON-EXPOS	ED MODULES	EDGE / EXPOSED MODULES		
ZONES	SPAN	CANTILEVER	SPAN	CANTILEVER	
ZONE 1	36"	12"	36"	12"	
ZONE 1'	X	Х	Х	Х	
ZONE 2e	36"	12"	36"	12"	
ZONE 2n	36"	12"	36"	12"	
ZONE 2r	36"	12"	36"	12"	
ZONE 3e	36"	12"	36"	12"	
ZONE 3r	36"	12"	36"	12"	

SEE SHEET S-02.1 FOR SUPPORTING CALCULATIONS.

2) EXISTING RESIDENTIAL BUILDING IS A METAL ROOF WITH MEAN ROOF HEIGHT IS 15 FT AND SEAM SPACING 9" O.C. EXISTING ROOF SLOPE FOR SOLAR SYSTEM RETROFIT IS 22.6 DEGREES. CONTRACTOR TO FIELD VERIFY AND SHALL REPORT TO THE ENGINEER IF ANY DISCREPANCIES EXIST BETWEEN PLANS AND IN FIELD CONDITIONS.

I CERTIFY THAT THE INSTALLATION OF THE MODULES IS IN COMPLIANCE WITH FBC: RESIDENTIAL CHAPTER 3, SECTION 101.4.9 AND SECTION 428: MANUFACTURED BUILDINGS. BUILDING STRUCTURE WILL SAFELY ACCOMMODATE LATERAL AND UPLIFT WIND LOADS AND EQUIPMENT DEAD LOADS

#### **LEGEND**

- EDGE MODULE
- EXPOSED MODULE
- NON- EXPOSED MODULE

- MISSING MODULE
- MIN. MODULE EDGE DISTANCE LINE
- MODULE EXPOSURE LINE
- WIND ZONE 1 (TYP)
- WIND ZONE 2e (TYP)
- WIND ZONE 2n (TYP)
- WIND ZONE 2r (TYP)
- WIND ZONE 3r (TYP)
  - WIND ZONE 3e (TYP)



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PROJECT NAME

RESIDENC

DUPREE

SW DAIRY ST, CITY, FL 32024

SHEET NAME

MODULE LAYOUT

SHEET SIZE ANSI B 11" X 17"

SHEET NUMBER

S-01

**MODULE LAYOUT** 

S-01


SCALE: 3/32" = 1'-0"

	1	1'	2e	2n	2r	3e	3r	
	16.00	0.00	16.00	17.40	17.40	17.40	19.50	
			Modu	le Size	19.5	Sqft.		
		ľ	Non-Expos	ed modu <mark>l</mark> e	S			Partial
	1	1'	2e	2n	2r	3e	3r	Pressure
P7	15.14	0.00	0.00	0.00	4.36	0.00	0.00	16.31
P8	11.05	0.00	0.00	4.09	3.18	0.00	1.18	16.73
Р9	12.68	0.00	0.00	0.00	6.82	0.00	0.00	16.49
P10	15.27	0.00	0.00	0.00	4.23	0.00	0.00	16.30
P11	15.56	0.00	0.00	0.00	3.94	0.00	0.00	16.28
P12	11.94	0.00	0.00	3.62	3.03	0.00	0.92	16.64

	1	1'	2e	2n	2r	3e	3r	
	18.60	0.00	18.60	26.10	26.10	26.10	29.30	
			202 12 13					
			Modu	le Size	19.5	Sqft.		
		E	dge Modu	les module	:s			Partial
	1	1'	2e	2n	2r	3e	3r	Pressure
P1	3.79	0.00	11.17	<b>1.1</b> 5	0.00	3.38	0.00	20.34
P2	4.94	0.00	14.56	0.00	0.00	0.00	0.00	18.60
P3	3.14	0.00	14.56	0.00	1.81	0.00	0.00	19.30
P4	4.67	0.00	0.00	0.00	14.83	0.00	0.00	24.30
P5	5.36	0.00	14.14	0.00	0.00	0.00	0.00	18.60
P6	3.91	0.00	10.32	1.45	0.00	3.82	0.00	20.63

ALLOWABLE MODULE UPLIFT PRESSURE 2 RAILS: 88 PSF

ALLOWABLE MODULE UPLIFT PRESSURE 2 RAILS: 88 PSF

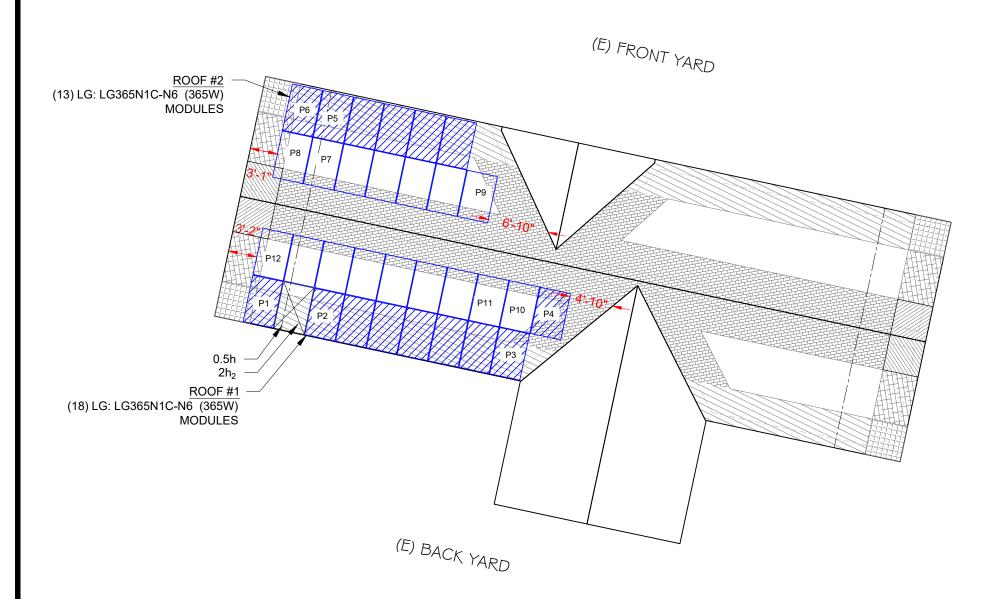



NOTE: PARTIAL PRESSURES OF THE WIND ZONES ON ALL MODULES HAVE BEEN VERIFIED AND ARE WITHIN THE ALLOWABLE PER THE MANUFACTURER SPECIFICATION, INSTALLER SHOULD FOLLOW THE LAYOUT TO AVOID HIGHER ZONAL PARTIAL PRESSURES. ANY CHANGES IN LAYOUT SHOULD BE REPORTED BACK TO THE ENGINEER OF RECORD.

DISTANCE: 12" 0.5h DISTANCE: 7' - 6"

## **LEGEND**



- EDGE MODULE
- EXPOSED MODULE
- NON- EXPOSED MODULE



- MISSING MODULE
- MIN. MODULE EDGE DISTANCE LINE
- MODULE EXPOSURE LINE
- WIND ZONE 1 (TYP)
- WIND ZONE 2e (TYP)
- - WIND ZONE 2n (TYP)
- WIND ZONE 2r (TYP)
- WIND ZONE 3r (TYP)
  - WIND ZONE 3e (TYP)



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DESCRIPTION	DATE	REV			

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PROJECT NAME

RESIDENCE

DUPREE

1196 SW DAIRY ST, LAKE CITY, FL 32024

SHEET NAME

PARTIAL PRESSURE AND MODULES EXPOSURE


> SHEET SIZE ANSI B

11" X 17"

SHEET NUMBER S-01.1

PARTIAL PRESSURE AND MODULES EXPOSURE SCALE: 3/32" = 1'-0"

S-01.1

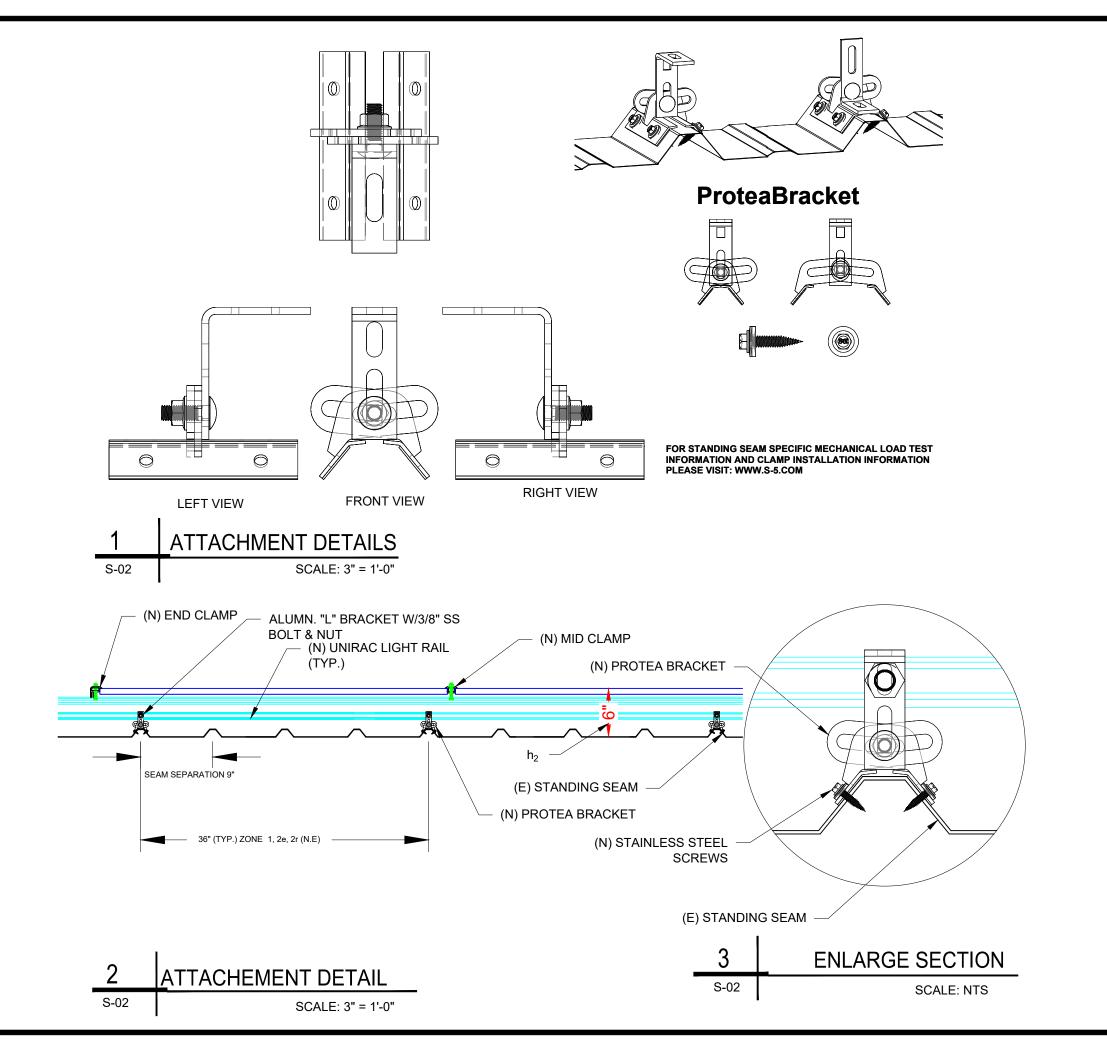

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Date:

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PROJECT NAME

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**DUPREE RESIDENC** 

1196 SW DAIRY ST, LAKE CITY, FL 32024

SHEET NAME

ATTACHMENT DETAIL

SHEET SIZE

ANSI B

11" X 17"

SHEET NUMBER

S-02

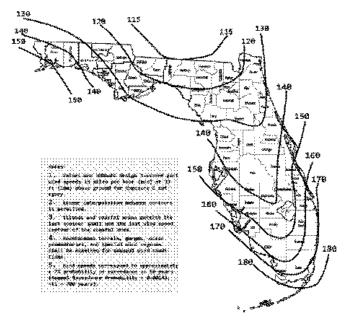


Figure 1809.1(1) Lithwate degich wind speeds.  $V_{\rm AXY}$  for risk category ii buildings and other structures

#### WIND LOAD CALCULATIONS FOR MODULES INSTALLED ON ROOFS WITH A HEIGHT LESS THAN 60'

		SITE INFORMATION	
FBC VERSION	2020	RISK CATEGORY	11
MEAN ROOF HEIGHT (ft)	15.0	EXPOSURE CATEGORY	В
ROOF LENGTH (ft)	77.8	ROOF SLOPE	5 /12
ROOF WIDTH (ft)	41.3	ROOF SLOPE (°)	22.6
PARAPET HEIGHT (ft)	0.0	ROOF TYPE	GABLE
MODULE LENGTH (in)	68.5	ULTIMATE WIND SPEED	120 mph
MODULE WIDTH (in)	41.00	NOMINAL WIND SPEED	93 mph
MODULE ORIENTATION	PORTRAIT	EXPOSURE FACTOR (Ce)	1.000
MODULE AREA (sq. ft.)	19.50	TEMPERATURE FACTOR (Ct)	1.000
GROUND SNOW LOAD (psf)	0.0	IMPORTANCE FACTOR (Is)	1.000
DEAD LOAD (psf)	3.0	SLOPE FACTOR (Cs)	0.910
SLOPED ROOF SNOW LOAD (psf)	0.0	<b>K</b> <sub>D</sub>	0.850
EFFECTIVE WIND AREA (ff²)	19.5	K <sub>ZT</sub>	1.000
GROUND ELEVATION (ft)	90.0	Ke	0.997
HVHZ	NO	K <sub>z</sub>	0.575

	DESIGN	CALCULA	TIONS				
VELOCITYPRESSURE (q) = .00256	S*KEKZKZTKDV <sup>2</sup>						
	10.8 psf						
WIDTH OF PRESSURE COEFFICIENT	41.3' * 10%	=	4.13'	ZONE WIDTH A	4 FT		
	15' * 40%	=	6'	ZONE 2 WIDTH	N/A	(FOR (°) < 7°)	
				ZONE 3 WIDTH	N/A	(FOR (°) < 7°)	
EXTERNAL PRESSURE COEFFICIENT	ZONE 1	0.467	-1.506				
•	ZONE 1'	X	X				
	ZONE 2e	0.467	-1.506				
	ZONE 2n	0.467	-2.179				
	ZONE 2r	0.467	-2.179				
	ZONE 3e	0.467	-2.179				
	ZONE 3r	0.467	-2.471				
INTERNAL PRESSURE COEFFICIENT (+/-)	0.18						


DESIGN PRESSURES							
	ROOF ZONE	DOWN	UP				
	1	16.0	-18.2	psf			
	1'	×	X	psf			
	2e	16.0	-18.2	psf	Module allowable uplift pressure	88	psf
	2n	16.0	-25.4	psf	Module allowable down pressure	125	psf
	2r	16.0	-25.4	psf			
	3e	16.0	-25.4	psf			
	3r	16.0	-28.6	psf			

	ARRA	FACTORS		
ARRAY EDGE FACT OR (EXPOSED)	1.5	SOLAR PANEL PRESSURE	0.684	
ARRAY EDGE FACT OR (NON-EXPOSED)	1	EQUALIZATION FACTOR	0.684	

		ADJUST	ED DESIGN PR	RESSURES	
ROOF ZONE	DOWN	UP (Exposed)	UP (N. Expose	ed)	
1	16.0	-18.6	-16.0	psf	
1"	X	X	X	psf	
2e	16.0	-18.6	-16.0	psf	
2n	16.0	-26.1	-17.4	psf	
2r	16.0	-26.1	-17.4	psf	
3e	16.0	-26.1	-17.4	psf	
3r	16.0	-29.3	-19.5	psf	

A	ATTACHMENTS USED		
ATTACHMENT MODEL	S-5 protea		
ATTACHMENT STRENGTH	422	lbs	

		MAXDES	IGN LOADS A	LOWABLE				
LIMIT MAX SPAN TO	).	36	in					
RAFTER/SEAM SPACE	NG	9	in	NO. OF RAILS	Exposed:	2	Non. Exp:	2
ROOF ZONE	DOWN	UP (Exposed)	UP (N. Expose	ed)	SPANS (E)		SPANS (N	.E)
1	137.0	159.6	137.0	lbs	36 in	1	36	in
1'	×	X	X	lbs	X in	1	X	in
2e	137.0	159.6	137.0	lbs	36 in	1	36	in
2n	137.0	223.2	148.8	lbs	36 in	i	36	in
2r	137.0	223.2	148.8	lbs	36 in	1	36	in
3e	137.0	223.2	148.8	lbs	36 in	1	36	in
3r	137.0	250.8	167.2	lbs	36 in	1	36	in

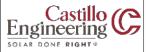

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DESCRIPTION	DATE	REV			

PROJECT INSTALLER



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Vo. 52-Signature with Signled by:
Ermocrates
E Castillo
Date:

2021.07.08

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PROJECT NAME


DUPREE RESIDENCE

1196 SW DAIRY ST, LAKE CITY, FL 32024

SHEET NAME STRUCTURE CALCULATION

ANSI B

SHEET NUMBER

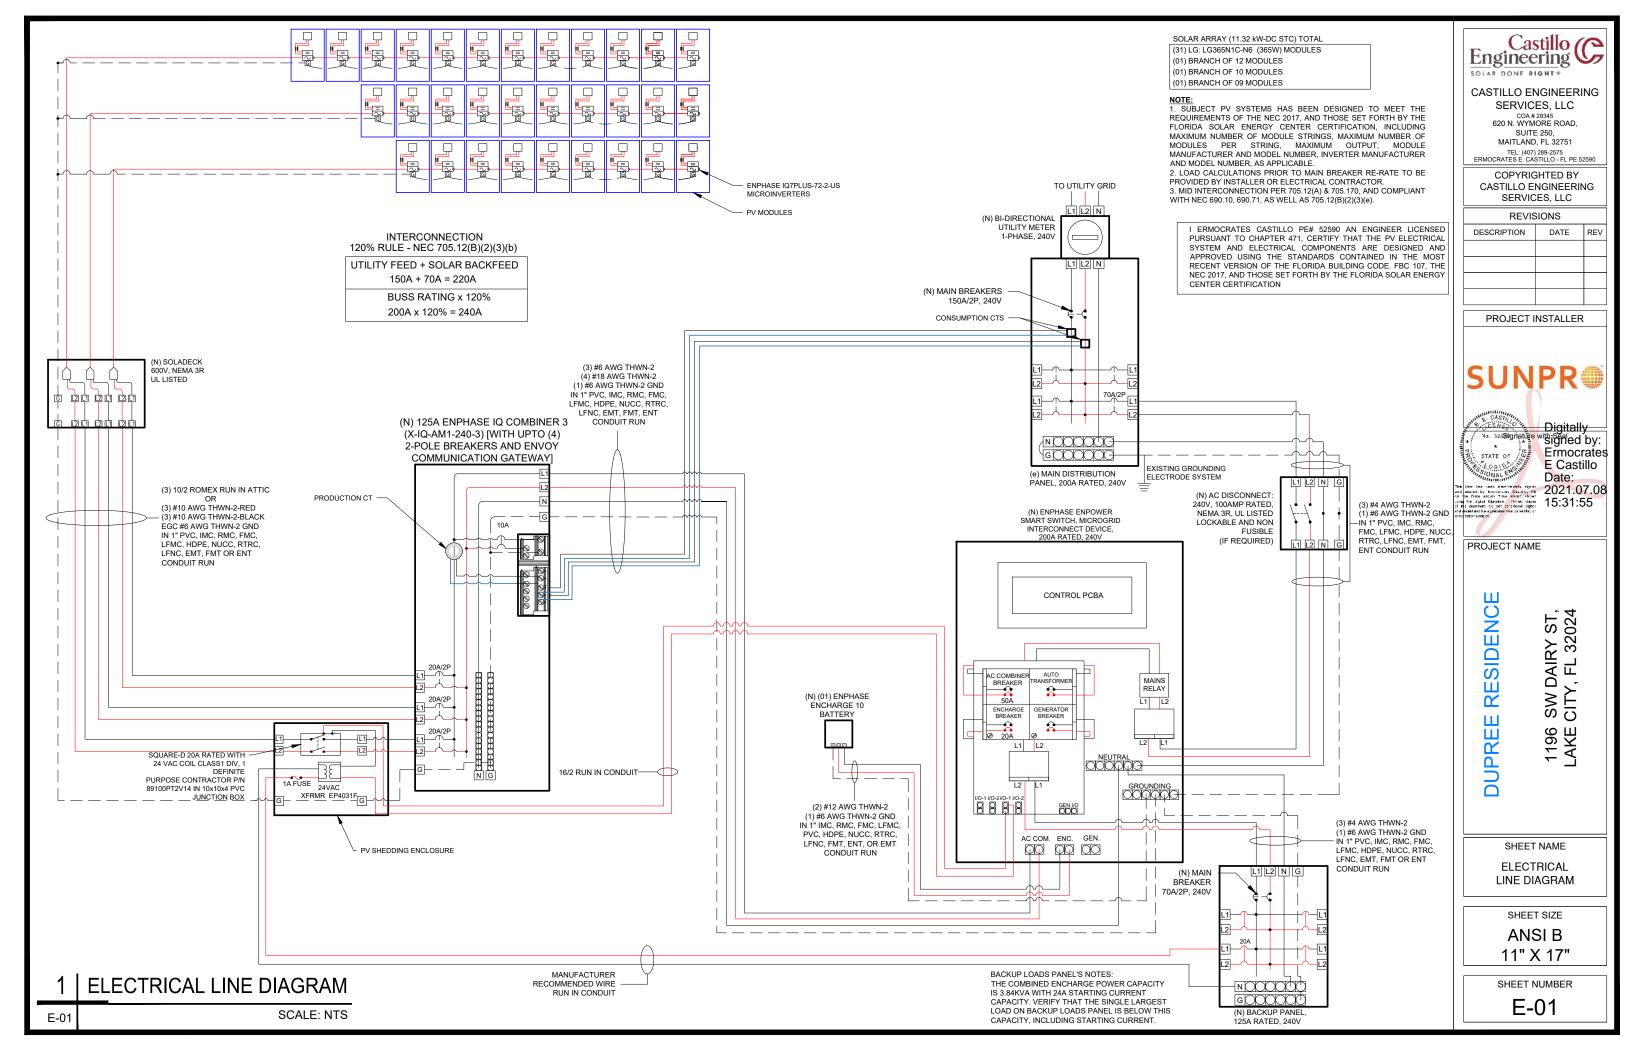

## AC CONDUCTOR AMPACITY CALCULATIONS: FROM ROOF TOP SOLADECK TO LOAD CENTER

## AC CONDUCTOR AMPACITY CALCULATIONS: FROM AC COMBINER BOX TO MSP

MODULE MANUFACTURER	LG
MODULE MODEL	LG365N1C-A6
INVERTER MANUFACTURER	ENPHASE
INVERTER MODEL	ENPHASE IQ 7 PLUS
MODULES/BRANCH CIRCUIT 1	12
MODULES/BRANCH CIRCUIT Z	10
MODULES/BRANCH CIRCUIT 3	9
TOTAL ARRAY POWER (KW)	11.32
SYSTEM AC VOLTAGE	240V I-PHASE

_								
		Module Pi	ROPERTIES					
	Voc	41.6	Isc	11.27				
	VMPP	34.5	IMP	10.58				
	TC Voc	-0.26%/ °C	TC VMP	-0.34%/ 1D				
	РМР	365.0	NOCT	45 °C				

DESIGN TEMPERATURE	
MIN. AMBIENT TEMP. "F	32
MAX. AMBIENT TEMP. "F	117
GALGULATED MAX. VOG	45
CALCULATED MIN VMP	27
CONDUIT FILL	
NUMBER OF CONDUITS	1

INVERTER PROPERTIES			
DUTPUT VOLTAGE	240 L-L 1-PH		
MAX INPUT OC VOLTAGE	60 Voc		
DPERATING RANGE	16 - 60 VDC		
MPPT VOLTAGE RANGE	27 - 45 VDG		
START VOLTAGE	22 Voc		
MAX INPUT POWER	440 WDC		
CONTINUOUS AC POWER	290 VA		

AMPACITY C	ALCULTIONS	]								
CIRCUIT	Мах Амря	1.25 x Max Amps	AWG	90 °C Ampacity	AMBIENT TEMP "F	TEMP DERATE	CONDUIT FILL	FILL DERATE	DERATED AMPACITY	
CIRCUIT 1	14.5	18.1	#10	40	130	0.76	6	0.8	24.32	20 A
CIRCUIT 2	12.1	15.1	#10	40	130	0.76	6	□. 🖯	24.32	20 A
CIRCUIT 3	10.9	13.6	#10	40	130	0.76	6	0.8	24.32	20 A
ENPHASE COMBINER	37.5	46.8	#6	75	95	0.96	3	1	72	50 A
ENPOWER TO ENCHARGE	16.0	20.0	#12	30	95	0.96	3	1	28.8	20 A
ENPOWER TO BACK	56.0	70.0	#4	95	95	0.96	3	1	91.2	70 A
ENPOWER TO MAIN PANEL	56.0	70.0	#4	95	95	0.96	3	1	91.2	70 A

MUMIXAM	CIRCUIT	VOLTAGE	DROP	2%	

VOLTAGE DROP CALCULATIONS					
GIRGUIT	AWG	GIRGULAR Mills	ı	٧	MAX LENGTH
CIRCUIT 1	#10	10380	14.5	240	133 FEET
CIRCUIT 2	#10	10380	12.1	240	I 60 FEET
CIRCUIT 3	#10	10380	10.9	240	178 FEET
ENPHAGE COMBINER DUTPUT	#6	26240	37.5	240	130 FEET
ENPOWER TO ENCHARGE	#12	6530	16.0	240	76 FEET
ENPOWER TO BACK UP PANEL	#4	41740	56.0	240	139 FEET
ENPOWER TO MAIN PANEL	#4	41740	56.0	240	139 FEET

NOTES			
TEMP DE	ERATE BABED ON NEC TABLE 310.15(B)(2)(A)		
Сомоція	T FILL DERATE BASED ON NEC TABLE 310.15(B)(31(A)		
МАХІМЫ	M VOC CALCULATED USING MODULE MANUFACTURE TEMPERATURE COEFFICIENTS PER NEC 690.7(A)		
UNLESS	OTHERWISE SPECIFIED, ALL WIRING MUST BE THHN OR THWN-2 COPPER		
ALL WIRE	E BIZES LIBTED ARE THE MINIMUM ALLOWABLE		
	IN ANY CELL INDICATES THAT THE SYSTEM IS SAFE AND COMPLIES WITH NEC REQUIREMENTS		
	IN ANY DELL INDIDATES A POTENTIALLY UNSAFE CONDITION		
	INFORMATION INPUT BY SYSTEM DESIGNER		
	INFORMATON OBTAINED FROM MANUFACTURER DATASHEETS		

I ERMOCRATES CASTILLO PE# 52590 AN ENGINEER LICENSED PURSUANT TO CHAPTER 471. CERTIFY THAT THE PV ELECTRICAL SYSTEM AND ELECTRICAL COMPONENTS ARE DESIGNED AND APPROVED USING THE STANDARDS CONTAINED IN THE MOST RECENT VERSION OF THE FLORIDA BUILDING CODE. FBC 107, THE NEC 2017, AND THOSE SET FORTH BY THE FLORIDA SOLAR **ENERGY CENTER CERTIFICATION** 

#### **ELECTRICAL NOTES**

- 1. ALL EQUIPMENT TO BE LISTED BY UL OR OTHER NRTL, AND LABELED FOR ITS APPLICATION.
- 2. ALL CONDUCTORS SHALL BE COPPER, RATED FOR 600 V AND 90 DEGREE C WET ENVIRONMENT. THE TERMINALS ARE RATED FOR 75 DEGREE C.
- THE WIRES ARE SIZED ACCORDING TO NEC 110.14.
- WIRING, CONDUIT, AND RACEWAYS MOUNTED ON ROOFTOPS SHALL BE ROUTED DIRECTLY TO, AND LOCATED AS CLOSE AS POSSIBLE TO THE NEAREST RIDGE, HIP, OR VALLEY.
- WORKING CLEARANCES AROUND ALL NEW AND EXISTING ELECTRICAL EQUIPMENT SHALL COMPLY WITH NEC 110.26.
- DRAWINGS INDICATE THE GENERAL ARRANGEMENT OF SYSTEMS. CONTRACTOR SHALL FURNISH ALL NECESSARY OUTLETS, SUPPORTS, FITTINGS AND ACCESSORIES TO FULFILL APPLICABLE CODES AND STANDARDS.
- 7. WHERE SIZES OF JUNCTION BOXES, RACEWAYS, AND CONDUITS ARE NOT SPECIFIED, THE CONTRACTOR SHALL SIZE THEM ACCORDINGLY.
- 8. ALL WIRE TERMINATIONS SHALL BE APPROPRIATELY LABELED AND READILY VISIBLE.
- MODULE GROUNDING CLIPS TO BE INSTALLED BETWEEN MODULE FRAME AND MODULE SUPPORT RAIL, PER THE GROUNDING CLIP MANUFACTURER'S INSTRUCTION.
- 10. MODULE SUPPORT RAIL TO BE BONDED TO CONTINUOUS COPPER G.E.C. VIA WEEB LUG OR ILSCO GBL-4DBT LAY-IN LUG.
- 11. THE POLARITY OF THE GROUNDED CONDUCTORS IS NEGATIVE.
- 12. UTILITY HAS 24-HR UNRESTRICTED ACCESS TO ALL PHOTOVOLTAIC SYSTEM COMPONENTS LOCATED AT THE SERVICE ENTRANCE.
- 13. MODULES CONFORM TO AND ARE LISTED UNDER UL 1703.
- 14. RACKING CONFORMS TO AND IS LISTED UNDER UL 2703.
- 15. CONDUCTORS EXPOSED TO SUNLIGHT SHALL BE LISTED AS SUNLIGHT RESISTANT PER NEC ARTICLE 300.6 (C) (1) AND ARTICLE 310.10 (D).
- 16. CONDUCTORS EXPOSED TO WET LOCATIONS SHALL BE SUITABLE FOR USE IN WET LOCATIONS PER NEC ARTICLE 310.10 (C).

Input Data (D0	<del>;</del> )	
	Recommended Input Power (STC)	245-400W +
	Maximum Input DC Voltage	60V
	Peak Power Tracking Voltage	27V-45V
	Operating Range	16V-60V
	Min. / Max. Start Voltage	22V / 60V
	Max DC Short Circuit Current	15A
Output Data (A	AC)	
	Maximum Output Power	290W
	Nominal Output Current	1.21A
	Nominal Voltage / Range	240V/211-264V
	Nominal Frequency / Range	60 Hz
	Extended Frequency / Range	47-68 Hz
	Power Factor at rated power	1.0
	Maximum unit per 20A Branch Circuit	13 (240 VAC)



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SERVICES, LLC **REVISIONS** 

DESCRIPTION	DATE	REV

PROJECT INSTALLER





PROJECT NAME

STATE OF

SIDENC RE DUPREE

SW DAIRY ST, CITY, FL 32024

SHEET NAME

WIRING CALCULATIONS

SHEET SIZE **ANSIB** 

11" X 17" SHEET NUMBER

E-02



#### **ELECTRIC SHOCK HAZARD**

TERMINALS ON BOTH LINE AND LOAD SIDES MAY BE ENERGIZED IN THE OPEN POSITION

LABEL LOCATION:

AC DISCONNECT, POINT OF INTERCONNECTION (PER CODE: NEC 690.13(B))

**WARNING** DUAL POWER SOURCE SECOND SOURCE IS PHOTOVOLTAIC SYSTEM

LABEL LOCATION: POINT OF INTERCONNECTION (PER CODE: NEC 705.12(B)(2)(3)(b))

## **PHOTOVOLTAIC SYSTEM** WITH RAPID **SHUTDOWN SWITCH**

LABEL LOCATION: AC DISCONNECT (PER CODE: NEC690.56(C)(3))

- ADHESIVE FASTENED SIGNS:

   THE LABEL SHALL BE SUITABLE FOR THE ENVIRONMENT WHERE IT IS INSTALLED.
- WHERE REQUIRED ELSEWHERE IN THIS CODE, ALL FIELD APPLIED LABELS, WARNINGS, AND MARKINGS SHOULD COMPLY WITH ANSI Z535.4 [NEC 110.21(B) FIELD MARKING]. • ADHESIVE FASTENED SIGNS MAY BE ACCEPTABLE IF PROPERLY ADHERED. VINYL SIGNS SHALL BE WEATHER RESISTANT [IFC 605.11.1.3]

#### **SOLAR CONNECTION** LINE SIDE TAP

LABEL LOCATION: POINT OF INTERCONNECTION (PER CODE: NEC 705.12(A))

# AC COMBINER BOX

LABEL LOCATION: **COMBINER BOX** (PER CODE: NEC690.52)



LABEL LOCATION: POINT OF INTERCONNECTION (PER CODE: NEC 705.12(B)(2)(3)(b))

### PHOTOVOLTAIC SYSTEM AC DISCONNECT RATED AC OPERATING CURRENT 37.5 AMPS AC NOMINAL OPERATING VOLTAGE 240 VOLTS

AC DISCONNECT, POINT OF INTERCONNECTION

(PER CODE: NEC690.54)

#### WARNING

INVERTER OUTPUT CONNECTION DO NOT RELOCATE THIS OVERCURRENT DEVICE

LABEL LOCATION: POINT OF INTERCONNECTION (PER CODE: NEC 705.12(B)(2)(3)(b))

#### DATA PER PANEL

**NOMINAL OPERATING AC VOLTAGE -NOMINAL OPERATING AC FREQUENCY-**60 MAXIMUM AC POWER- 290 **MAXIMUM AC CURRENT-** 1.21 MAXIMUM OVERCURRENT DEVICE RATING 20 FOR AC MODULE PROTECTION PER CIRCUIT-

LABEL LOCATION: COMBINER BOX (PER CODE: NEC690.52)

# **AC DISCONNECT**

LABEL LOCATION: AC DISCONNECT. POINT OF INTERCONNECTION (PER CODE: NEC690.54)

**PHOTOVOLTAIC SYSTEM MICROINVERTERS LOCATED UNDER EACH PV MODULE IN ROOF TOP ARRAY** 


LABEL LOCATION: (PER CODE: NEC690.52)

11.32 KW SOLAR **DISCONNECT LOCATED** 

LABEL LOCATION: AC DISCONNECT, POINT OF INTERCONNECTION (PER CODE: NEC690.54)

# SOLAR PV SYSTEM EQUIPPED WITH RAPID SHUTDOWN

TURN RAPID SHUTDOWN SWITCH TO THE "OFF" POSITION TO SHUT DOWN PV SYSTEM AND REDUCE SHOCK HAZARD IN THE ARRAY

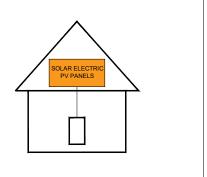

LABEL LOCATION: AC DISCONNECT, POINT OF INTERCONNECTION (PER CODE: NEC 690.56(C)(1)(a), IFC 605.11.3.1(1)



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SW DAIRY CITY, FL 320

SHEET NAME

SYSTEM LABELING

SHEET SIZE **ANSIB** 

11" X 17"

SHEET NUMBER

E-03

# LG NeON®2

LG365N1C-A6

## 365W

The LG NeON® 2 is LG's best selling solar module and one of the most powerful and versatile modules on the market today. The cells are designed to appear all-black at a distance, and the performance warranty guarantees 90.6% of labeled power output at 25 years.







#### Features



#### **Enhanced Performance Warranty**

LG NeON® 2 has an enhanced performance warranty. After 25 years, LG NeON® 2 is guaranteed at least 90.6% of initial performance.



#### 25-Year Limited Product Warranty

The NeON® 2 is covered by a 25-year limited product warranty. In addition, up to \$450 of labor costs will be covered in the rare case that a module needs to be repaired or replaced.



#### Solid Performance on Hot Days

LG NeON® 2 performs well on hot days due to its low temperature coefficient.



#### Roof Aesthetics

LG NeON® 2 has been designed with aesthetics in mind using thinner wires that appear all black at a distance.

#### When you go solar, ask for the brand you can trust: LG Solar

#### About LG Electronics USA, Inc.

LG Electronics is a global leader in electronic products in the clean energy markets by offering solar PV panels and energy storage systems. The company first embarked on a solar energy source research program in 1985, supported by LG Group's vast experience in the semi-conductor, LCD, chemistry and materials industries. In 2010, LG Solar successfully released its first MonoX® series to the market, which is now available in 32 countries. The NeON® (previous MonoX® NeON®, NeON®2, NeON®2, NeON®2 BiFacial won the "Intersolar AWARD" in 2013, 2015 and 2016, which demonstrates LG's leadership and innovation in the solar industry.



# LG NeON®2

#### LG365N1C-A6

#### General Data

Cell Properties (Material/Type)	Monocrystalline/N-type
Cell Maker	LG
Cell Configuration	60 Cells (6 x 10)
Module Dimensions (L x W x H)	1,740mm × 1,042mm × 40mm
Weight	18,6 kg
Glass (Material)	Tempered Glass with AR Coating
Backsheet (Color)	White
Frame (Material)	Anodized Aluminium
Junction Box (Protection Degree)	IP 68 with 3 Bypass Diodes
Cables (Length)	1,100mm x 2EA
Connector (Type/Maker)	MC 4/MC

#### Certifications and Warranty

Certifications'	IEC 61215-1/-1-1/2 : 2016, IEC 61730-1/2 : 2016 UL 61730-1 : 2017, UL 61730-2 : 2017
	ISO 9001, ISO 14001, ISO 50001
	OHSAS 18001
Salt Mist Corrosion Test	IEC 61701:2011 Severity 6
Ammonia Corrosion Test	IEC 62716 : 2013
Module Fire Performance	Type 1 (UL 61730)
Fire Rating	Class C (UL 790)
Solar Module Product Warranty	25 Year Limited
Solar Module Output Warranty	Linear Warranty*

<sup>\*</sup>Improved: 1\* year 98.5%, from 2-24th year: -0.33%/year down, 90.6% at year 25

#### Temperature Characteristics


NMOT*	[°C]	42 ± 3
Pmax	[%/°C]	-0.34
Voc	[%/°C]	-0.26
lsc	[%/°C]	0.03

NMOT (Nominal Module Operating Temperature): Irradiance 800 W/m², Ambient temperature 20°C, Wind speed 1 m/s, Spectrum AM 1.5

#### Flectrical Properties (NMOT)

Model		LG365N1C-A6	
Maximum Power (Pmax)	[VV]	273.4	
MPP Voltage (Vmpp)	[V]	32.4	
MPP Current (Impp)	[A]	8.44	
Open Circuit Voltage (Voc)	[V]	39.2	
Short Circuit Current (Isc)	[A]	9.06	

#### I-V Curves

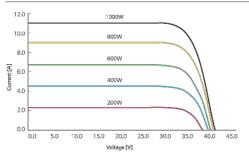

Model		LG365N1C-A6
Maximum Power (Pmax)	[W]	365
MPP Voltage (Vmpp)	[V]	34.5
MPP Current (Impp)	[A]	10.58
Open Circuit Voltage (Voc, ± 5%)	[V]	41.6
Short Circuit Current (Isc, ±5%)	[A]	11.27
Module Efficiency	[%]	20.1
Bifaciality Coefficient of Power	[%]	10
Power Tolerance	[%]	0-+3

\*STC (Standard Test Condition): Irradiance 1000 W/m², cell temperature 25°C, AM 1.5

#### **Operating Conditions**

Electrical Properties (STC\*)


Operating Temperature	[°C]	-40 ~+85
Maximum System Voltage	[V]	1,000
Maximum Series Fuse Rating	[A]	20
Mechanical Test Load* (Front)	[Pa/psf]	5,400
Mechanical Test Load" (Rear)	[Pa/psf]	4,000

\*Based on IEC 61215-2: 2016 (Test Load – Design Load x Safety Factor (1.5)) Mechanical Test Loads 6,000Pa / 5,400Pa based on IEC 61215: 2005

#### Packaging Configuration

acitaging configuration		
Number of Modules per Pallet	[EA]	25
Number of Modules per 40' Container	[EA]	650
Number of Modules per 53' Container	[EA]	850
Packaging Box Dimensions (L x W x H)	[mm]	1,790 x 1,120 x 1,213
Packaging Box Dimensions (L x W x H)	[in]	70.5 x 44.1 x 47.8
Packaging Box Gross Weight	[kg]	500
Packaging Box Gross Weight	[lb]	1,102

#### Dimensions (mm/inch)

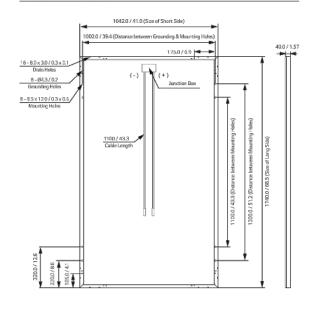



Solar Business Division 2000 Millbrook Drive Lincolnshire, IL 60069

Product specifications are subject to change without notice. 011821

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# Engineering C

#### **CASTILLO ENGINEERING** SERVICES, LLC

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SW DAIRY ST, CITY, FL 32024

SHEET NAME

**DATA SHEET** 

SHEET SIZE **ANSIB** 11" X 17"

SHEET NUMBER



LG Electronics U.S.A., Inc. 111 Sylvan Avenue Englewood Cliffs, NJ 07632 201.816.2000

Friday, February 5, 2021

#### RE: Mechanical Load Testing to Determine Structural Performance under Uniform Static Pressure

To: Castillo Engineering,


Upon your request we have conducted in house tests to determine the structural performance of the LG Module frames listed below. Our test results meet the requirements you presented in our conference call on January 29<sup>th</sup>. We will present the test criteria, results, and product limitations that may result from these test conditions in this letter.

The specifications and conditions presented in this letter apply retroactively to the following LG module(s);

	2 Rails	3 Rails
Front	9,000Pa	9,000Pa
Rear	6,350Pa	9,000Pa
Model	LGxxxN1C(K)-N5(L5), LGxxxN1C(K)-A6(B6)	
	LGxxxQ1C(K)-V5, LGxxxQ1C(K)-A6	

\*The result is based on test load.

Our R&D department has tested these modules to determine the structural performance of under uniform static loading to represent the effects of a wind load on the module. This test was designed only to determine structural performance; the revised specifications apply only to the mechanical performance of the module. A safety factor of 1.5 should be applied to these test loads for obtaining design loads. It is not recommend designing any system to the full test load.

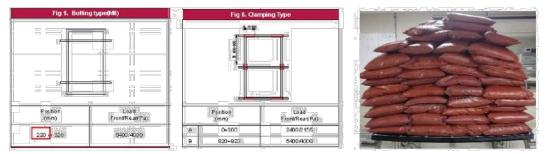

The scope of this test does not include electrical functionality or performance testing. Subjecting the module to these pressures may result in power degradation or total power loss. The electrical function and power generation warranties and specifications of these products are not altered by this document.

If you have any additional questions or concerns about this letter or the test protocol, contact your LG Solar Sales Representative.



#### CASTILLO ENGINEERING

SERVICES, LLC

COA # 28345
620 N. WYMORE ROAD,
SUITE 250,
MAITLAND, FL 32751

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Data Sheet **Enphase Microinverters** Region: US

# **Enphase** IQ 7 and IQ 7+ **Microinverters**

The high-powered smart grid-ready Enphase IQ 7 Micro™ and Enphase IQ 7+ Micro™ dramatically simplify the installation process while achieving the highest system efficiency.

Part of the Enphase IQ System, the IQ 7 and IQ 7+ Microinverters integrate seamlessly with the Enphase IQ Envoy™, Enphase Q Aggregator™, Enphase IQ Battery™, and the Enphase Enlighten™ monitoring and analysis software.

IQ Series Microinverters extend the reliability standards set forth by previous generations and undergo over a million hours of power-on testing, enabling Enphase to provide an industry-leading warranty of up to 25 years.



- · Lightweight and simple
- · Faster installation with improved, lighter two-wire cabling
- · Built-in rapid shutdown compliant (NEC 2014 & 2017)


#### Productive and Reliable

- · Optimized for high powered 60-cell and 72-cell\* modules
- · More than a million hours of testing
- · Class II double-insulated enclosure
- UL listed

#### Smart Grid Ready

- · Complies with advanced grid support, voltage and frequency ride-through requirements
- · Remotely updates to respond to changing grid requirements
- Configurable for varying grid profiles
- Meets CA Rule 21 (UL 1741-SA)
- \* The IQ 7+ Micro is required to support 72-cell modules.



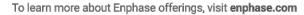



#### Enphase IQ 7 and IQ 7+ Microinverters

INPUT DATA (DC)	IQ7-60-2-US		IQ7PLUS-72	IQ7PLUS-72-2-US	
Commonly used module pairings <sup>1</sup>	235 W - 350 W +		235 W - 440 V	235 W - 440 W +	
Module compatibility	60-cell PV modules only		60-cell and 72	60-cell and 72-cell PV modules	
Maximum input DC voltage	48 V		60 V		
Peak power tracking voltage	27 V - 37 V		27 V - 45 V		
Operating range	16 V - 48 V		16 V - 60 V		
Min/Max start voltage	22 V / 48 V		22 V / 60 V		
Max DC short circuit current (module Isc)	15 A		15 A		
Overvoltage class DC port	II		II		
DC port backfeed current	0 A		0 A		
PV array configuration			tional DC side prote 20A per branch cir		
OUTPUT DATA (AC)	IQ 7 Microinve	erter	IQ 7+ Micro	inverter	
Peak output power	250 VA		295 VA		
Maximum continuous output power	240 VA		290 VA		
Nominal (L-L) voltage/range²	240 V / 211-264 V	208 V / 183-229 V	240 V / 211-264 V	208 V / 183-229 V	
Maximum continuous output current	1.0 A	1.15 A	1.21 A	1.39 A	
Nominal frequency	60 Hz		60 Hz		
Extended frequency range	47 - 68 Hz		47 - 68 Hz		
AC short circuit fault current over 3 cycles	5.8 Arms		5.8 Arms		
Maximum units per 20 A (L-L) branch circuit <sup>a</sup>	16 (240 VAC) 13 (208 VAC)		13 (240 VAC) 11 (208 VAC)		
Overvoltage class AC port	111		III		
AC port backfeed current	0 A		0 A		
Power factor setting	1.0		1.0		
Power factor (adjustable)	0.7 leading 0.	7 lagging	0.7 leading	0.7 lagging	
EFFICIENCY	@240 V	@208 V	@240 V	@208 V	
Peak CEC efficiency	97.6 %	97.6 %	97.5 %	97.3 %	
CEC weighted efficiency	97.0 %	97.0 %	97.0 %	97.0 %	
MECHANICAL DATA	IQ 7 Microinve	erter			
Ambient temperature range	-40°C to +65°C				
Relative humidity range	4% to 100% (cor	ndensing)			
Connector type	MC4 (or Amphe	nol H4 UTX with	additional Q-DCC-	5 adapter)	
Dimensions (WxHxD)	212 mm x 175 n	nm x 30.2 mm (w	ithout bracket)		
Weight	1.08 kg (2.38 lbs	s)			
Cooling	Natural convect	ion - No fans			
Approved for wet locations	Yes				
Pollution degree	PD3				
Enclosure	Class II double-	insulated, corros	ion resistant polyn	neric enclosure	
Environmental category / UV exposure rating	NEMA Type 6 /	outdoor			
FEATURES					
Communication	Power Line Con	nmunication (PL0	C)		
Monitoring	Enlighten Manager and MyEnlighten monitoring options. Both options require installation of an Enphase IQ Envoy.				
Disconnecting means	The AC and DC connectors have been evaluated and approved by UL for use as the load-break disconnect required by NEC 690.				
Compliance	CA Rule 21 (UL 1741-SA) UL 62109-1, UL1741/IEEE1547, FCC Part 15 Class B, ICES-0003 Class B, CAN/CSA-C22.2 NO. 1071-01 This product is UL Listed as PV Rapid Shut Down Equipment and conforms with NEC-2014 and NEC-2017 section 690.12 and C22.1-2015 Rule 64-218 Rapid Shutdown of PV Systems, for AC and DC conductors, when installed according manufacturer's instructions.				

- No enforced DC/AC ratio. See the compatibility calculator at <a href="https://enphase.com/en-us/support/module-compatibility.">https://enphase.com/en-us/support/module-compatibility.</a>
   Nominal voltage range can be extended beyond nominal if required by the utility.
   Limits may vary. Refer to local requirements to define the number of microinverters per branch in your area.

#### To learn more about Enphase offerings, visit enphase.com

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DATA SHEET

SHEET SIZE ANSI B 11" X 17"

SHEET NUMBER

Data Sheet **Enphase Networking** 

# **Enphase IQ Combiner 3**

(X-IQ-AM1-240-3)

The Enphase IQ Combiner 3™ with Enphase IQ Envoy™ consolidates interconnection equipment into a single enclosure and streamlines PV and storage installations by providing a consistent, pre-wired solution for residential applications. It offers up to four 2-pole input circuits and Eaton BR series busbar assembly.



To learn more about Enphase offerings, visit enphase.com

#### Smart

- · Includes IQ Envoy for communication and control
- · Flexible networking supports Wi-Fi, Ethernet, or cellular
- · Optional AC receptacle available for PLC bridge
- Provides production metering and optional consumption monitoring

#### Simple

- · Reduced size from previous combiner
- · Centered mounting brackets support single stud mounting
- · Supports back and side conduit entry
- · Up to four 2-pole branch circuits for 240 VAC plug-in breakers (not included)
- · 80 A total PV or storage branch circuits

#### Reliable

- · Durable NRTL-certified NEMA type 3R enclosure
- · Five-year warranty
- UL listed



#### **Enphase IQ Combiner 3**

MODEL NUMBER	
IQ Combiner 3 X-IQ-AM1-240-3	IQ Combiner 3 with Enphase IQ Envoy* printed circuit board for integrated revenue grade PV production metering (ANSI C12.20 +/- 0.5%) and optional* consumption monitoring (+/- 2.5%) and optional $^{\star}$ constitution of the constitution
ACCESSORIES and REPLACEMENT PARTS (no	t included, order separately)
Enphase Mobile Connect** CELLMODEM-03 (4G / 12-year data plan) CELLMODEM-01 (3G / 5-year data plan) CELLMODEM-M1 (4G based LTE-M / 5-year data plan)	Plug and play industrial grade cellular modem with data plan for systems up to 60 microinverters. (Available in the US, Canada, Mexico, Puerto Rico, and the US Virgin Islands, where there is adequate cellular service in the installation area.)
Consumption Monitoring* CT CT-200-SPLIT	Split core current transformers enable whole home consumption metering (+/- 2.5%).
Circuit Breakers BRK-10A-2-240 BRK-15A-2-240 BRK-20A-2P-240	Supports Eaton BR210, BR215, BR220, BR230, BR240, BR250, and BR260 circuit breakers. Circuit breaker, 2 pole, 10A, Eaton BR210 Circuit breaker, 2 pole, 15A, Eaton BR215 Circuit breaker, 2 pole, 20A, Eaton BR220
EPLC-01	Power line carrier (communication bridge pair), quantity 2
XA-PLUG-120-3	Accessory receptacle for Power Line Carrier in IQ Combiner 3 (required for EPLC-01)
XA-ENV-PCBA-3	Replacement IQ Envoy printed circuit board (PCB) for Combiner 3
ELECTRICAL SPECIFICATIONS	
Rating	Continuous duty
System voltage	120/240 VAC, 60 Hz
Eaton BR series busbar rating	125 A
Max. continuous current rating (output to grid)	65 A
Max. fuse/circuit rating (output)	90 A
Branch circuits (solar and/or storage)	Up to four 2-pole Eaton BR series Distributed Generation (DG) breakers only (not included)
Max. continuous current rating (input from PV)	64 A
Max. total branch circuit breaker rating (input)	80A of distributed generation / 90A with IQ Envoy breaker included
Production Metering CT	200 A solid core pre-installed and wired to IQ Envoy
MECHANICAL DATA	
Dimensions (WxHxD)	49.5 x 37.5 x 16.8 cm (19.5" x 14.75" x 6.63"). Height is 21.06" (53.5 cm with mounting bracke
Weight	7.5 kg (16.5 lbs)
Ambient temperature range	-40° C to +46° C (-40° to 115° F)
Cooling	Natural convection, plus heat shield
Enclosure environmental rating	Outdoor, NRTL-certified, NEMA type 3R, polycarbonate construction
Wire sizes	<ul> <li>20 A to 50 A breaker inputs: 14 to 4 AWG copper conductors</li> <li>60 A breaker branch input: 4 to 1/0 AWG copper conductors</li> <li>Main lug combined output: 10 to 2/0 AWG copper conductors</li> <li>Neutral and ground: 14 to 1/0 copper conductors</li> <li>Always follow local code requirements for conductor sizing.</li> </ul>
Altitude	To 2000 meters (6,560 feet)
INTERNET CONNECTION OPTIONS	
Integrated Wi-Fi	802.11b/g/n
Ethernet	Optional, 802.3, Cat5E (or Cat 6) UTP Ethernet cable (not included)
Cellular	Optional, CELLMODEM-01 (3G) or CELLMODEM-03 (4G) or CELLMODEM-M1 (4G based LTE-N (not included)
COMPLIANCE	
Compliance, Combiner	UL 1741 CAN/CSA C22.2 No. 107.1 47 CFR, Part 15, Class B, ICES 003 Production metering: ANSI C12.20 accuracy class 0.5 (PV production)
Compliance, IQ Envoy	UL 60601-1/CANCSA 22.2 No. 61010-1

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SW DAIRY ST, CITY, FL 32024

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SHEET NAME

DATA SHEET

SHEET SIZE **ANSI B** 11" X 17"

SHEET NUMBER

- Three Encharge 3.36 kWh base units (B3-A01-US001-1-3)

# **Enphase Encharge 10**

The Enphase Encharge 10™ all-in-one AC-coupled storage system is reliable, smart, simple, and safe. It is comprised of three base Encharge 3™ storage units, has a total usable energy capacity of 10.08 kWh and twelve embedded grid-forming microinverters with 3.84 kW power rating. It provides backup capability and installers can quickly design the right system size to meet the needs of both new and retrofit solar customers.



#### Reliable

- · Proven high reliability IQ Series Microinverters
- · Ten-year limited warranty
- · Three independent Encharge storage base units
- · Twelve embedded IQ 8X-BAT Microinverters
- · Passive cooling (no moving parts/fans)

#### Smart

- · Grid-forming capability for backup operation
- · Remote software and firmware upgrade
- · Mobile app-based monitoring and control
- · Support for self consumption
- · Utility time of use (TOU) optimization

#### Simple

- · Fully integrated AC battery system
- · Quick and easy plug-and-play installation
- · Interconnects with standard household AC wiring

#### Safe

- · Cells safety tested
- · Lithium iron phosphate (LFP) chemistry for maximum safety and longevity



#### To learn more about Enphase offerings, visit enphase.com

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MODEL NUMBER ENCHARGE-10-1P-NA Encharge 10 battery storage system with integrated Enphase Microinverters and battery management unit (BMU). Includes:

- One Encharge 10 cover kit with cover, wall mounting bracket, watertight conduit hubs, and interconnect kit for wiring between batteries (B10-C-1050-0) ACCESSORIES

ENCHARG-HNDL-R1 One set of Encharge base unit installation handles

OUTPUT (AC) @ 240 VAC1 Rated (continuous) output power<sup>2</sup> 3.84 kVA Peak output power 5.7 kVA (10 seconds) 240 / 211 - 264 VAC Nominal voltage / range Nominal frequency / range 60 / 57 - 61 Hz Rated output current 16 A Power factor (adjustable) 0.85 leading ... 0.85 lagging Maximum units per 20 A branch circuit 1 unit (single phase)

Interconnection Single-phase Maximum AC short circuit fault current over 3 cycles 69.6 Arms

Round trip efficiency<sup>2</sup> BATTERY 10.5 kWh Total capacity

Usable capacity 10.08 kW Round trip efficiency 96% Nominal DC voltage 67.2 V 73.5 V Maximum DC voltage

-15° C to 55° C (5° F to 131° F) non-condensing Ambient operating temperature range

Optimum operating temperature range 0° C to 30° C (32° F to 86° F) Chemistry Lithium iron phosphate (LFP)

MECHANICAL DATA Dimensions (WxHxD) 1070 mm x 664 mm x 319 mm (42.13 in x 26.14 in x 12.56 in) Three individual 44.2 kg (97.4 lbs) base units plus 21.1 kg (48.7 lbs) cover and mounting Weight

bracket; total 154.7 kg (341 lbs) Enclosure Outdoor - NEMA type 3R NEMA type 6 IQ 8X-BAT microinverter enclosure Cooling Natural convection - No fans

Altitude Up to 2500 meters (8200 feet) Mounting FEATURES AND COMPLIANCE

Compatible with grid-tied PV systems. Compatible with Enphase IQ Series Micros, Enphase Compatibility Enpower, and Enphase IQ Envoy for backup operation Communication Wireless 2.4 GHz and 915 MHz

Services Backup, self-consumption, TOU, Demand Charge, NEM Integrity Enlighten Manager and MyEnlighten monitoring options; API integration Monitoring UL 9540, UN 38.3, UL 9540A, UL 1998, UL 991, NEMA Type 3R, AC156 Compliance (pending) EMI: 47 CFR, Part 15, Class B, ICES 003

>70% capacity, up to 10 years or 4000 cycles

Cell Module: UL 1973, UN 38.3 Inverters: UL 62109-1, IEC 62109-2, UL 1741SA, CAN/CSA C22.2 No. 107.1-16 LIMITED WARRANTY

Limited Warranty<sup>3</sup> Supported in backup/off grid operations

2. AC to Battery to AC at 50% power rating.

3. Whichever occurs first, Restrictions apply

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SHEET SIZE ANSI B 11" X 17"

SHEET NUMBER **DS-05** 

To learn more about Enphase offerings, visit enphase.com

Data Sheet Enphase Ensemble energy management system

# **Enphase Enpower**

The Enphase Enpower™ smart switch connects the home to grid power, the Encharge storage system, and solar PV. It provides microgrid interconnection device (MID) functionality by automatically detecting and seamlessly transitioning the home energy system from grid power to backup power in the event of a grid failure. It consolidates interconnection equipment into a single enclosure and streamlines grid independent capabilities of PV and storage installations by providing a consistent, pre-wired solution for residential applications.



To learn more about Enphase offerings, visit enphase.com

#### Reliable

- · Durable NEMA type 3R enclosure
- · Ten-year limited warranty

#### Smart

- · Controls safe connectivity to the grid
- · Automatically detects grid outages
- · Provides seamless transition to backup

- · Connects to the load or service equipment1 side of the main load panel
- · Centered mounting brackets support single stud
- Supports conduit entry from the bottom, bottom left side, and bottom right side
- · Supports whole home and partial home backup and subpanel backup
- · Up to 200A main breaker support
- · Includes neutral-forming transformer for split phase 120/240V backup operation
- 1. Enpower is not suitable for use as service equipment in



#### **Enphase Enpower**

MODEL NUMBER		
EP200G101-M240US00	Enphase Enpower smart switch with neutral-forming transformer (MID), breakers, and screws. Streamlines grid-independent capab	
ACCESSORIES and REPLACEMENT PART	rs	
XA-E3-PCBA-ENS	Replacement Enpower controller printed circuit board	
Circuit breakers (as needed) <sup>2,3</sup> BRK-100A-2P-240V BRK-125A-2P-240V BRK-150A-2P-240V BRK-150A-2P-240V BRK-200A-2P-240V BRK-200A-2P-240V BRK-30A-2P-240V BRK-40A-2P-240V BRK-60A-2P-240V BRK-60A-2P-240V BRK-80A-2P-240V	Not included, must order separately:  • Main breaker, 2 pole, 100A, 25kAIC, CSR2100N or CSR2100  • Main breaker, 2 pole, 125A, 25kAIC, CSR2125N  • Main breaker, 2 pole, 150A, 25kAIC, CSR2150N  • Main breaker, 2 pole, 175A, 25kAIC, CSR2175N  • Main breaker, 2 pole, 200A, 25kAIC, CSR2200N  • Circuit breaker, 2 pole, 200A, 25kAIC, CSR2200N  • Circuit breaker, 2 pole, 20A, 10kAIC, BR220B  • Circuit breaker, 2 pole, 30A, 10kAIC, BR230B  • Circuit breaker, 2 pole, 40A, 10kAIC, BR240B  • Circuit breaker, 2 pole, 60A, 10kAIC, BR260  • Circuit breaker, 2 pole, 80A, 10kAIC, BR280	
EP200G-HNDL-R1	Enpower installation handle kit (order separately)	
ELECTRICAL SPECIFICATIONS	0-1	
Assembly rating	Continuous operation at 100% of its rating	
Nominal voltage / range (L-L)	240 VAC / 100 - 310 VAC	
Voltage measurement accuracy	±1% V nominal (±1.2V L-N and ±2.4V L-L)	
Nominal frequency / range	60 Hz / 56 - 63 Hz	
Frequency measurement accuracy	±0.1 Hz	
Maximum continuous current rating	160A	
Maximum output overcurrent protection device		
Maximum input overcurrent protection device		
Maximum overcurrent protection device rating for storage branch circuit <sup>4</sup>	80A	
Maximum overcurrent protection device rating for PV combiner branch circuit <sup>4</sup>	80A	
Neutral Forming Transformer (NFT)	Breaker rating (pre-installed): 40A between L1 and Neutral; 40A     Continuous rated power: 3600VA     Maximum continuous unbalance current: 30A @ 120V     Peak rated power: 8800VA for 30 seconds     Peak unbalanced current: 80A @ 120V for 30 seconds	between L2 and Neutral
MECHANICAL DATA		
Dimensions (WxHxD)	50cm x 91.6cm x 24.6cm (19.7 in x 36 in x 9.7 in)	
Weight	38.5 kg (85 lbs)	
Ambient temperature range	-40° C to +50° C (-40° F to 122° F)	
Cooling	Natural convection, plus heat shield	
Enclosure environmental rating	Outdoor, NEMA type 3R, polycarbonate construction	
Altitude	To 2500 meters (8200 feet)	
WIRE SIZES		
Connections	Main lugs, backup load lugs, and CSR breakers     BR breakers (wire provided)     AC combiner lugs, Encharge lugs, and generator (reserved for future use) lugs     Neutral (large lugs)	Cu/AL: 2 AWG - 300 KCMIL 6 AWG 14 AWG - 2 AWG Cu/AL: 6 AWG - 300 KCMIL
Neutral and ground bars	Large holes (5/16-24 UNF) Small holes (10-32 UNF)	14 AWG - 1/0 AWG 14 AWG - 6 AWG
COMPLIANCE		
Compliance	UL 1741, UL 1741 SA, UL1998, UL869A5, UL675, UL5085, UL50E6 CSA 22.2 No. 107.1, 47 CFR, Part 15, Class B, ICES 003, AC156.	

- Compatible with BRHDK125 Hold-Down Kit to comply with 2017 NEC 710.15E for back-fed circuit breakers.
   The kAIC of Enpower is the same as the kAIC of the main breaker being installed as listed.
   Not included, Installer must provide properly rated breaker per circuit breaker list above.
   Sections from these standards were used during the safety evaluation and included in the UL 1741 listing.

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# **SOLAR**MOUNT



**SOLARMOUNT** defined the standard in solar racking. Features are designed to get installers off the roof faster. Our grounding & bonding process eliminates copper wire and grounding straps to reduce costs. Systems can be configured with standard or light rail to meet your design requirements at the lowest cost possible. The superior aesthetics package provides a streamlined clean edge for enhanced curb appeal, with no special brackets required for installation.









SMALL IS THE NEXT NEW BIG THING Light Rail is Fully Compatible with all SM Components



# **FAST INSTALLATION. SUPERIOR AESTHETICS**

OPTIMIZED COMPONENTS . VERSATILITY . DESIGN TOOLS . QUALITY PROVIDER

# **SOLAR**MOUNT

# **#UNIRAC**


# **OPTIMIZED COMPONENTS**

Components are pre-assembled and optimized to reduce installation steps and save labor time. Our new grounding & bonding process eliminates copper wire and grounding, straps or bonding jumpers to reduce costs. Utilize the microinverter mount with a wire management clip for an easier installation.

#### **ONE PRODUCT - MANY APPLICATIONS**

Quickly set modules flush to the roof or at a desired tilt angle. Change module orientation to portrait or landscape while securing a large variety of framed modules on to outperform your projects financial and aesthetic aspirations

Creating a bill of materials is just a few clicks away with U-Builder, a powerful online Save time by creating a user profile, and recall preferences and projects automatically when you log in. You will enjoy the ability to share projects with customers: there's no need to print results and send to a distributor, just click and share

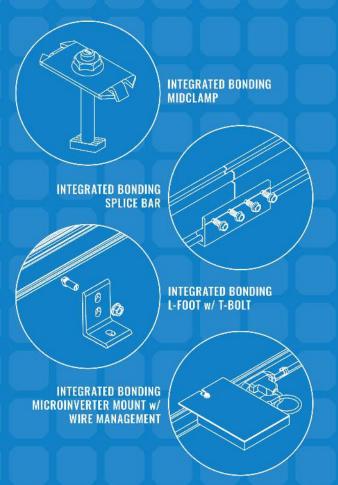



## UNIRAC CUSTOMER SERVICE MEANS THE HIGHEST LEVEL OF PRODUCT SUPPORT



TECHNICAL SUPPORT







**CERTIFIED QUALITY PROVIDER** 





#### **BANKABLE WARRANTY**

strength to back our products and reduce your risk. Have peace

PROTECT YOUR REPUTATION WITH QUALITY RACKING SOLUTIONS BACKED BY ENGINEERING EXCELLENCE AND A SUPERIOR SUPPLY CHAIN

for 9001:2015, 14001:2015 and DHSAS 18001:2007.

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**DUPREE RESIDENCE** SW DAIRY ST, CITY, FL 32024

SHEET NAME

DATA SHEET

SHEET SIZE

**ANSIB** 11" X 17"

SHEET NUMBER

# The Right Way!

## **ProteaBracket**<sup>™</sup>

ProteaBracket™ is the most versatile standing seam metal roof attachment solution on the market, fitting most trapezoidal sheet profiles with and without intermediate insulation. It features an adjustable attachment base and multiple solar module attachment options (illustrated on back) to accommodate varying widths and heights. There are no messy sealants to apply and no chance for leaks; the ProteaBracket comes with factory-applied, adhesive rubber sealant to ensure quick installation and a weather-proof fit.

Installation is simple! The ProteaBracket is mounted directly onto the crown of the panel, straddling the profile. No surface preparation is necessary; simply wipe away excess oil and debris, align, and apply. Secure ProteaBracket through its pre-punched holes, using the hardened drill point S-5!® screws.

ProteaBracket is the perfect match for our S-5-PV Kit and spares you the hassle of cold-bridging! For a solar attachment solution that is both economical and easy to use, choose ProteaBracket.\*

\*When ProteaBracket is used in conjunction with the S-5-PV Kit, an additional nut is required during installation.











S-5!® ProteaBracket™ is a versatile bracket that adjusts easily to most trapezoidal roof profiles. S-51®
The Right Way!

ProteaBracket<sup>™</sup> is the perfect solar attachment solution for most trapezoidal exposed-fastened metal roof profiles! No messy sealants to apply. The factory-applied adhesive rubber sealant weather-proofs and makes installation easy!

Each **ProteaBracket™** comes with a factory-applied, adhesive rubber sealant on the base. A structural A2 stainless steel bimetal attachment bracket, ProteaBracket is compatible with most common metal roofing materials. All four pre-punched holes must be used to achieve tested strength. Mounting hardware is furnished with the ProteaBracket. For design assistance, ask your distributor, or visit **www.S-5.com** for the independent lab test data that can be used for load-critical designs and applications. Also, please visit our website for more information including metallurgical compatibilities and specifications. S-5!® holding strength is unmatched in the industry.

Multiple Attachment Options:

Side Rail Option

Top Rail Option



S-5-PV Kit Option

| www.S-5.com


888-825-3432

#### S-5!® Warning! Please use this product responsibly!

Products are protected by multiple U.S. and foreign patents. For published data regarding holding strength, bolt torque, patents, and trademarks, visit the S-5! website at www.S-5.com.

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## **ProteaBracket**™

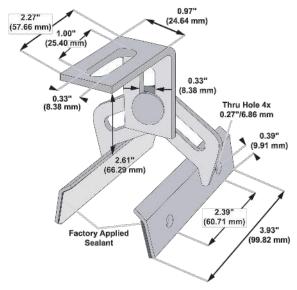

Please note: All measurements are rounded to the second decimal place.

#### **Example Applications**



S-5-PV Kit demonstrated with a ProteaBracket on a trapezoidal profile.

#### **Example Profile**



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1196 SW DAIRY ST, LAKE CITY, FL 32024

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