
# T--Mobile-® stick together®

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1720 W US HIGHWAY 90 LAKE CITY, FLORIDA 32055 (COLUMBIA COUNTY)

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Α	03/25/21		PRELIM PLANS
В	04/06/21	RE\	VISED PER COMMENTS
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Ρ	ROJECT NO.:		21-5084
1	DRAWN BY:		J. MALLISON
PROJECT MANAGER:			D. REVELS
CHECKED BY:			D. REVELS

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CERTIFICATE OF AUTHORIZATION 33693

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7025 A.C. SKINNER PARKWAY

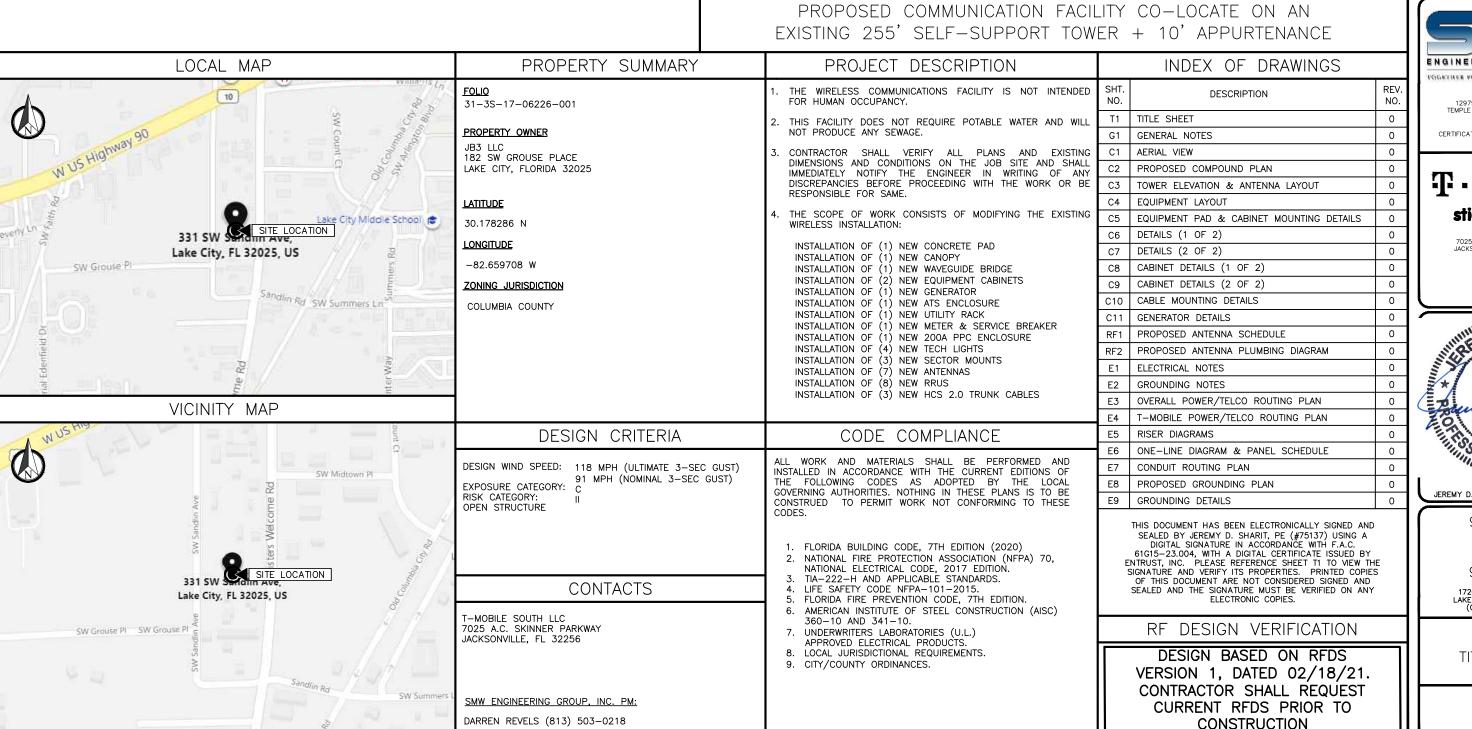

JEREMY D. SHARIT PE FL LIC 75137

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1. FOR THE PURPOSES OF THESE CONSTRUCTION DRAWINGS, THE FOLLOWING DEFINITIONS SHALL APPLY:

OWNER - T-MOBILE USA

ENGINEER - SMW ENGINEERING GROUP, INC.

CONTRACTOR - GENERAL CONTRACTOR (CONSTRUCTION)

- 2. PRIOR TO SUBMITTING HIS BID, THE CONTRACTOR SHALL VISIT THE JOB SITE IN ORDER TO (1) VERIFY ALL EXISTING CONDITIONS, (2) CONFIRM WHETHER ALL DIMENSIONS ARE AS SHOWN ON THE PLANS AND (3) CONFIRM WHETHER THE WORK MAY BE ACCOMPLISHED AS SHOWN. ANY DISCREPANCIES SHALL BE BROUGHT TO THE ATTENTION OF THE CONSTRUCTION MANAGER.
- 3. A 20-FOOT HORIZONTAL CLEARANCE DISTANCE SHALL BE MAINTAINED FROM ALL EXISTING POWER LINES.
- 4. THE CONTRACTOR'S USE OF A CONSTRUCTION STAGING AREA SHALL BE COORDINATED WITH THE OWNER WELL IN ADVANCE OF THE CONSTRUCTION START DATE.
- 5. LABOR, MATERIAL, TOOLS, EQUIPMENT, TRANSPORTATION AND TEMPORARY POWER SERVICES NECESSARY FOR AND INCIDENTAL TO COMPLETION OF ALL WORK SHALL BE PROVIDED AS INDICATED ON THE DRAWINGS AND/OR AS SPECIFIED HEREIN. LABOR AND MATERIALS SHALL BE FURNISHED AS REQUIRED FOR COMPLETE SYSTEMS, INCLUDING ALL ELEMENTS OBVIOUSLY OR REASONABLY INCIDENTAL TO A COMPLETE INSTALLATION, WHETHER OR NOT SPECIFICALLY INDICATED ON THE PLANS.
- 6. FOR TASKS REQUIRED TO BE PERFORMED BUT NOT CLEARLY DEFINED OR IDENTIFIED BY THE CONTRACT DOCUMENTS, THE CONTRACTOR SHALL NOT START WORK ON SUCH TASKS WITHOUT HAVING RECEIVED WRITTEN AUTHORIZATION FROM THE CONSTRUCTION MANAGER TO PROCEED.
- 7. THE DRAWINGS ARE DIAGRAMMATIC AND INDICATE THE GENERAL ARRANGEMENT OF SYSTEMS AND EQUIPMENT UNLESS OTHERWISE INDICATED BY DIMENSIONS OR DETAILS. EXACT EQUIPMENT LOCATIONS MAY BE MODIFIED AS REQUIRED BY ACTUAL FIELD CONDITIONS. IF THE SPECIFIED EQUIPMENT CANNOT BE INSTALLED AS SHOWN ON THESE DRAWINGS, CONTRACTOR SHALL PROPOSE AN ALTERNATIVE INSTALLATION FOR APPROVAL BY THE ENGINEER AND THE CONSTRUCTION MANAGER.
- 8. THE CONTRACTOR SHALL OBTAIN, PAY FOR AND DELIVER ALL REQUIRED PERMITS, CERTIFICATES OF INSPECTION, INCLUDING UTILITY CONNECTION FEES, ETC., REQUIRED BY THE AUTHORITIES HAVING JURISDICTION AND SHALL DELIVER SUCH DOCUMENTS TO THE OWNER PRIOR TO FINAL ACCEPTANCE OF THE WORK.
- 9. THE CONTRACTOR'S OPERATIONS SHALL BE CONFINED TO AREAS OF NEW CONSTRUCTION.
- 10. ALL NECESSARY PROVISIONS SHALL BE MADE TO PROTECT EXISTING IMPROVEMENTS, PAVING, CURBS, GALVANIZED SURFACES, ETC, AND THE CONTRACTOR SHALL BE RESPONSIBLE FOR ANY DAMAGE TO SAME RESULTING FROM THE CONSTRUCTION WORK. ALL DISTURBED AND DAMAGED AREAS SHALL BE RESTORED TO THEIR ORIGINAL CONDITION OR BETTER UPON COMPLETION OF ALL WORK TO THE SATISFACTION OF THE CONSTRUCTION MANAGER.
- 11. THE FOLLOWING CLEANUP TASKS SHALL BE PERFORMED AS FOLLOWS: (1) ON A DAILY BASIS, KEEP THE GENERAL AREA CLEAN AND HAZARD FREE, REMOVING ALL WASTE, DEBRIS AND TRASH FROM THE SITE AND DISPOSING OF SAME IN A LEGAL MANNER. (2) UPON COMPLETION, LEAVE THE PREMISES IN A CLEAN CONDITION AND FREE FROM PAINT SPOTS, DUST, OR SMUDGES OF ANY NATURE. (3) UPON COMPLETION, CONSTRUCTION AND CONSTRUCTION STAGING AREA SHALL BE LEFT IN AS GOOD OR BETTER CONDITION THAN PRIOR TO CONSTRUCTION.
- 12. ALL EQUIPMENT AND MATERIALS SHALL BE INSTALLED IN ACCORDANCE WITH THE RESPECTIVE MANUFACTURER'S RECOMMENDATIONS EXCEPT WHERE IT IS SPECIFICALLY INDICATED OTHERWISE IN THE CONTRACT DOCUMENTS OR WHERE LOCAL CODES OR REGULATIONS TAKE PRECEDENCE.
- 13. ALL WORK PERFORMED AND MATERIALS INSTALLED SHALL BE IN STRICT ACCORDANCE WITH ALL APPLICABLE CODES, REGULATIONS AND ORDINANCES. THE CONTRACTOR SHALL GIVE ALL NOTICES AND COMPLY WITH ALL LAWS, ORDINANCES, RULES, REGULATIONS AND LAWFUL ORDERS OF ANY PUBLIC AUTHORITY HAVING JURISDICTION OVER THE PERFORMANCE OF THE WORK. MECHANICAL AND ELECTRICAL SYSTEMS SHALL BE INSTALLED IN ACCORDANCE WITH ALL APPLICABLE MUNICIPAL AND UTILITY COMPANY SPECIFICATIONS AS WELL AS LOCAL AND STATE CODES, ORDINANCES AND APPLICABLE REGULATIONS.
- 14. THE CONTRACTOR SHALL SUPERVISE AND DIRECT THE WORK AT ALL TIMES, USING THE BEST SKILLS AND ATTENTION. HE SHALL BE SOLELY RESPONSIBLE FOR ALL OF THE CONSTRUCTION MEANS, METHODS, TECHNIQUES, SEQUENCES AND PROCEDURES AND FOR COORDINATING ALL PORTIONS OF THE WORK, INCLUDING CONTACT AND COORDINATION WITH THE CONSTRUCTION MANAGER AND WITH THE OWNER'S AUTHORIZED REPRESENTATIVE.
- 15. WITHIN TEN (10) WORKING DAYS AFTER PROJECT COMPLETION, THE CONTRACTOR SHALL PROVIDE A COMPLETE SET OF AS-BUILT DRAWINGS, SWEEP TEST, CYLINDER TESTS, LIEN RELEASES, AND OTHER CLOSEOUT DOCUMENTATION AS REQUIRED BY THE OWNER. ALL SYSTEMS SHALL BE COMPLETELY ASSEMBLED, TESTED, ADJUSTED AND DEMONSTRATED TO BE READY FOR OPERATION PRIOR TO THE OWNER'S ACCEPTANCE.

- THE APPROPRIATE UTILITY LOCATING SERVICES SHALL BE CONTACTED PRIOR TO THE START OF CONSTRUCTION IN ORDER TO VERIFY THE EXACT LOCATION OF ALL EXISTING UNDERGROUND UTILITIES.
- 2. THE INSTALLATION OF NEW UTILITIES SHALL BE COORDINATED WITH LOCAL AUTHORITIES.
- ALL EXISTING ACTIVE SEWER, WATER, GAS, ELECTRIC AND OTHER UTILITIES, WHERE ENCOUNTERED IN THE WORK, SHALL BE PROTECTED AT ALL TIMES. WHERE REQUIRED FOR THE PROPER EXECUTION OF THE WORK, SUCH UTILITIES SHALL BE RELOCATED AS DIRECTED BY THE CONSTRUCTION MANAGER. EXTREME CAUTION SHALL BE USED WHEN EXCAVATING OR DRILLING PIERS AROUND OR NEAR UTILITIES.
- . RUBBISH. STUMPS, DEBRIS, STICKS, STONES AND OTHER REFUSE SHALL BE REMOVED FROM THE SITE AND DISPOSED OF LEGALLY.
- 5. ALL EXISTING INACTIVE SEWER, WATER, GAS, ELECTRIC AND OTHER UTILITIES THAT INTERFERE WITH THE EXECUTION OF THE WORK SHALL BE REMOVED AND/OR CAPPED, PLUGGED OR OTHERWISE DISCONTINUED AT POINTS THAT WILL NOT INTERFERE WITH THE EXECUTION OF THE WORK, SUBJECT TO THE APPROVAL OF THE LANDLORD AND/OR LOCAL UTILITIES.
- DISTURBANCE TO THE EXISTING SITE DURING CONSTRUCTION SHALL BE MINIMIZED.
- ANY AREAS OF THE CONSTRUCTION SITE DISTURBED BY THE WORK AND NOT COVERED BY THE TOWER, EQUIPMENT OR DRIVEWAY, SHALL BE GRADED TO A UNIFORM SLOPE. SUCH GRADING SHALL CAUSE SURFACE WATER TO FLOW AWAY FROM ANY EQUIPMENT SHELTER AND TOWER AREAS AND THE SOIL SHALL BE STABILIZED TO PREVENT EROSION. EROSION CONTROL MEASURES, IF REQUIRED DURING CONSTRUCTION, SHALL BE IN CONFORMANCE WITH THE LOCAL GUIDELINES FOR EROSION AND SEDIMENT CONTROL.
- 8. THE SUB-GRADE SHALL BE COMPACTED AND BROUGHT TO A UNIFORM GRADE PRIOR TO FINISHED SURFACE APPLICATION.
- 9. BACKFILL SHALL CONSIST OF CLEAN SAND FILL APPROVED FOR USE BY THE ENGINEER. NO UNAPPROVED MATERIAL WILL BE ALLOWED. CLEAN SAND FILL SHALL BE FREE OF ALL ROOTS, BOULDERS, OR OTHER DELETERIOUS MATERIAL.
- 10. THE CONTRACTOR SHALL RESTORE ALL DISTURBED AREAS TO EQUAL TO OR BETTER CONDITION THAN ORIGINAL
- . SITE SIGNAGE SHALL BE PROVIDED IN ACCORDANCE WITH THE TECHNICAL SPECIFICATIONS FOR SUCH SIGNAGE AS MAY BE CONTAINED IN THESE DRAWINGS.

#### SITE WORK NOTES

. MATERIAL:

- A. ALL STRUCTURAL STEEL WORK SHALL CONFORM TO THE LATEST EDITION OF THE AISC "STEEL CONSTRUCTION MANUAL".
- B. ALL STRUCTURAL STEEL WF BEAMS SHALL BE ASTM A992 AND "HOT DIPPED" GALVANIZED IN ACCORDANCE WITH ASTM A123 AND ASTM A153 STANDARDS.
- C. ALL STRUCTURAL PLATES, ANGLES, AND CHANNELS SHALL BE ASTM A36 AND "HOT DIPPED" GALVANIZED IN ACCORDANCE WITH ASTM A123 AND ASTM A153 STANDARDS.
- D. ALL HSS/TS MEMBERS SHALL BE ASTM A500 GRADE B (Fy=46ksi), AND "HOT DIPPED" GALVANIZED IN ACCORDANCE WITH ASTM A123 AND ASTM A153 STANDARDS.
- E. ALL STRUCTURAL PIPE MEMBERS SHALL BE ASTM A500 GRADE B (Fy=42ksi), AND "HOT DIPPED" GALVANIZED IN ACCORDANCE WITH ASTM A123 AND ASTM A153 STANDARDS.
- F. ALL NON\_STRUCTURAL PIPE MEMBERS SHALL BE ASTM A53 GRADE B, AND "HOT DIPPED" GALVANIZED IN ACCORDANCE WITH ASTM A123 AND ASTM A153 STANDARDS.
- 2. DESIGN, FABRICATION, AND CONSTRUCTION OF ALL CONNECTIONS SHALL CONFORM TO AISC STEEL CONSTRUCTION MANUAL.

#### WELDING:

- A. ALL WELDS, WELDERS, AND WELD INSPECTIONS SHALL CONFORM TO THE REQUIREMENTS OF AWS D 1.1, LATEST REVISION.
- B. ALL WELDS SHALL BE MADE WITH E70XX LOW HYDROGEN ELECTRODES
- C. ALL STEEL SHALL BE SPRAY GALVANIZED AFTER WELDING.
- -. ALL BOLTS SHALL BE GALVANIZED ¾" DIAMETER, A325-N, UNLESS NOTED OTHERWISE AND TIGHTENED TO A "SNUG TIGHT" CONDITION AS DEFINED BY AISC. SECURE NUT WITH LOCKING WASHER.
- 5. ANCHOR BOLTS SHALL CONFORM TO ASTM A307, UNLESS NOTED OTHERWISE.
- THE CONTRACTOR/STEEL FABRICATOR SHALL LOCATE ANY REINFORCEMENT IN THE STRUCTURAL MEMBERS IN SUCH A MANNER SO THAT THERE WILL NOT BE CONFLICT WITH THE REINFORCEMENT WHEN INSTALLING ANCHORS. THE ANCHORS SHALL BE INSTALLED PER THE MANUFACTURER'S INSTRUCTION.
- 7. THE CONTRACTOR/STEEL FABRICATOR SHALL CONFORM TO THE MINIMUM EDGE DISTANCE REQUIREMENTS IN ACCORDANCE WITH THE AISC MANUAL OF STEEL CONSTRUCTION.
- 8. ALL STRUCTURAL STEEL SHALL BE FABRICATED TO FIT AT BOLTED CONNECTIONS WITHIN 1/16 INCH TOLERANCE. STRUCTURAL STEEL SHALL NOT BE FLAME CUT UNDER ANY CIRCUMSTANCES WITHOUT APPROVAL OF THE ENGINEER.
- 9. THE CONTRACTOR/STEEL FABRICATOR SHALL CAP OR SEAL ALL PIPES AS REQUIRED TO PREVENT RAINWATER INTRUSION.
- . THE CONTRACTOR/STEEL FABRICATOR SHALL SUBMIT SHOP DRAWINGS FOR REVIEW PRIOR TO ANY STEEL FABRICATION. AT THE CONTRACTOR'S OPTION, FIELD SPLICES MAY BE USED FOR ERECTION PURPOSES. IF FIELD SPLICES ARE USED, THE SHOP DRAWINGS SHALL INCLUDE ALL DETAILS FOR THE PROPOSED FIELD SPLICES.
- 11. AT THE CONTRACTOR'S OPTION, SHOP WELDS MAY BE USED INSTEAD OF FIELD WELDS.
  - SUBMIT ORIGINAL SHOP DRAWINGS, INCLUDING COMPLETE DETAILS, SCHEDULES OF FABRICATION AND ASSEMBLY, PROCEDURES, AND DIAGRAMS. INCLUDE DETAILS OF CUTS, CONNECTIONS, CAMBER, HOLE, AND OTHER PERTINENT DATA. INDICATE WELDS BY STANDARD AWS A2.1 AND A2.4 SYMBOLS, AND SHOW SIZE, LENGTH, AND TYPE OF WELD. PROVIDE SETTING DRAWINGS, TEMPLATES, AND DIRECTIONS FOR INSTALLATION OF ANCHOR BOLTS AND OTHER ANCHORAGES TO BE INSTALLED AS WORK OF OTHERS' SECTIONS.

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PROJECT NO.:			2	1-5084	
DRAWN BY:			J.	MALLISON	
PROJECT MANAGER:			D.	REVELS	
CHECKED BY:			D.	REVELS	

DESCRIPTION

REV DATE

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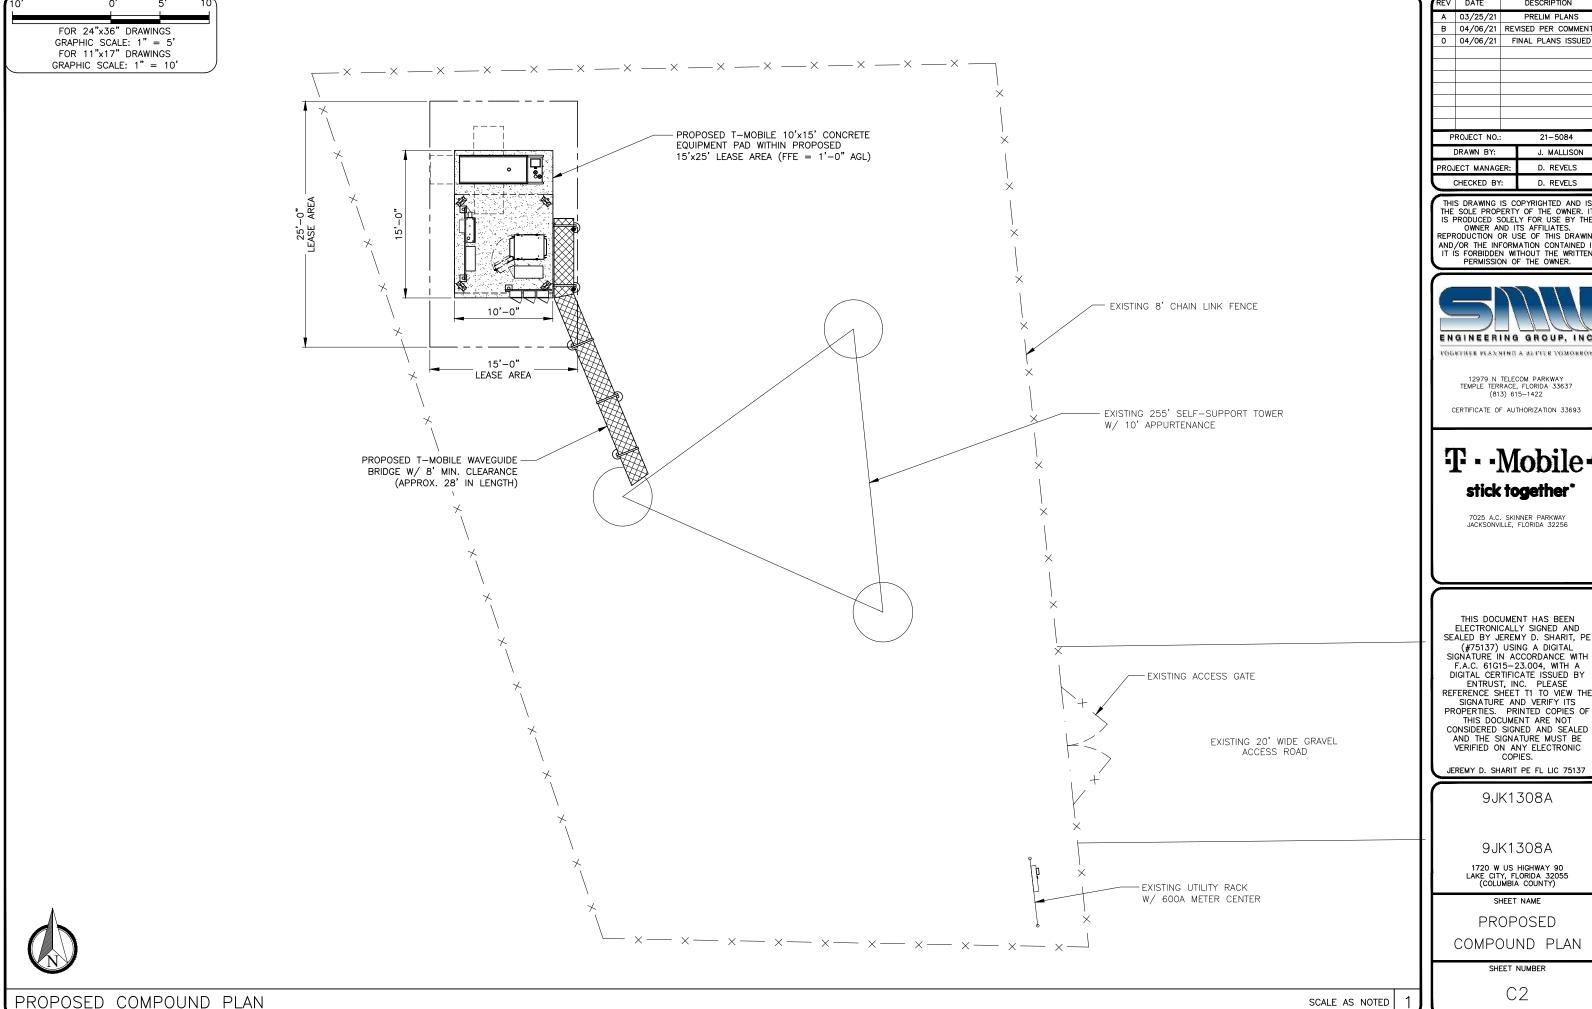
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	DRAWN BY:			J. MALLISON
	PROJECT MANAGER:			D. REVELS
-	CHECKED BY:			D. REVELS

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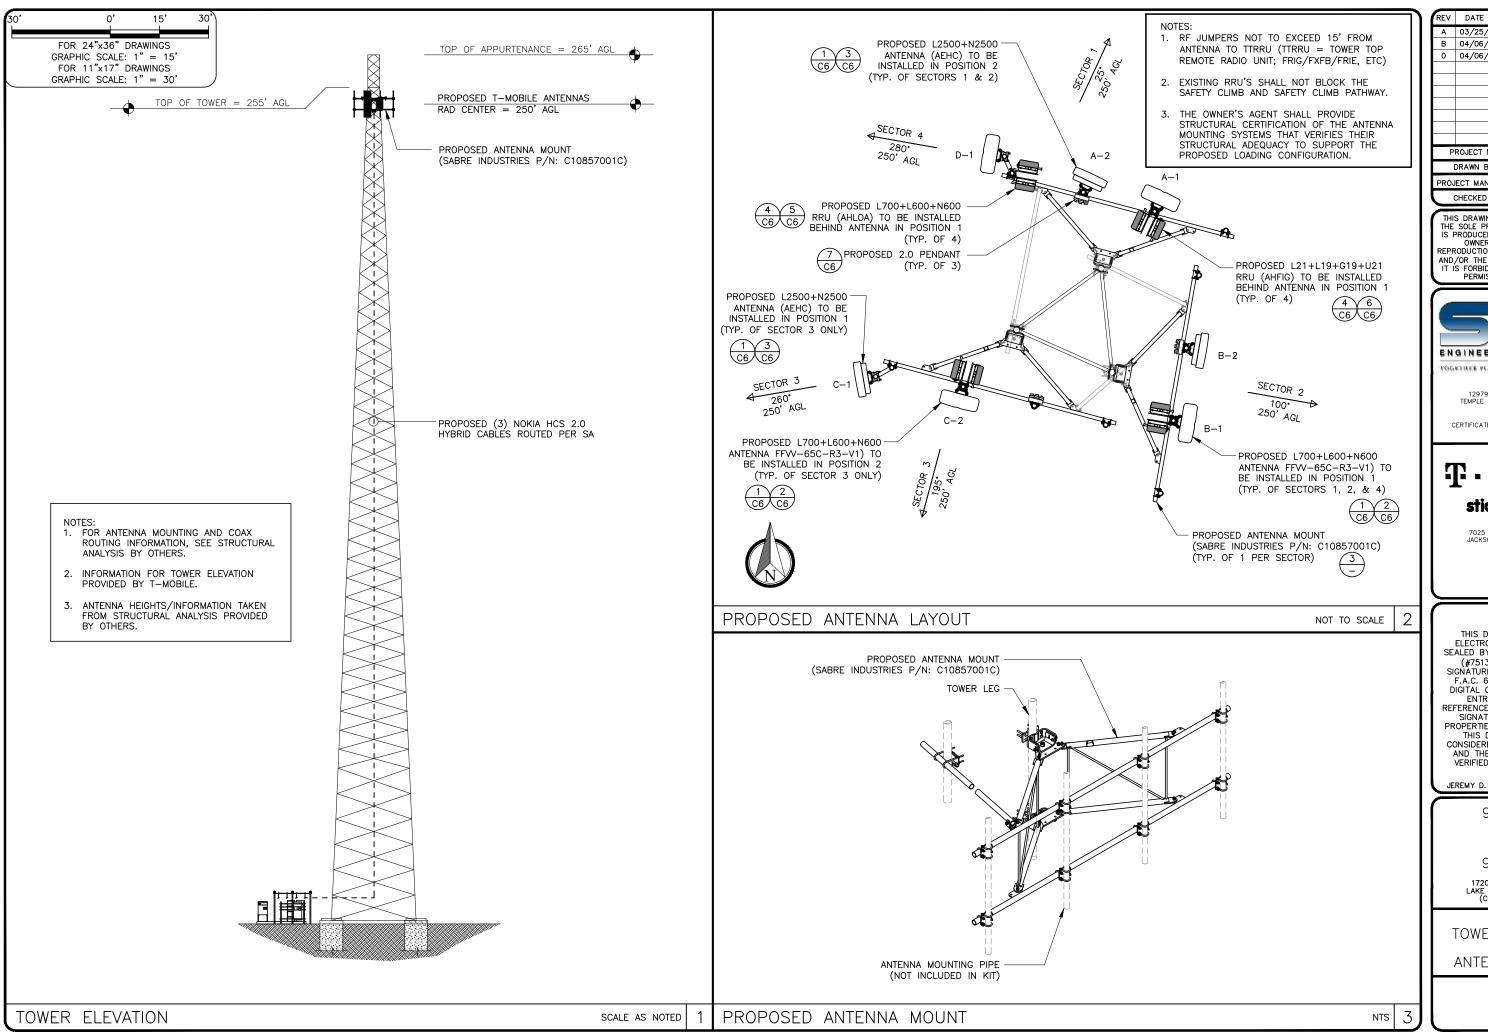
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O 04/06/21 FINAL PLANS ISSUED

PROJECT NO.: 21-5084

DRAWN BY: J. MALLISON

PROJECT MANAGER: D. REVELS

CHECKED BY: D. REVELS

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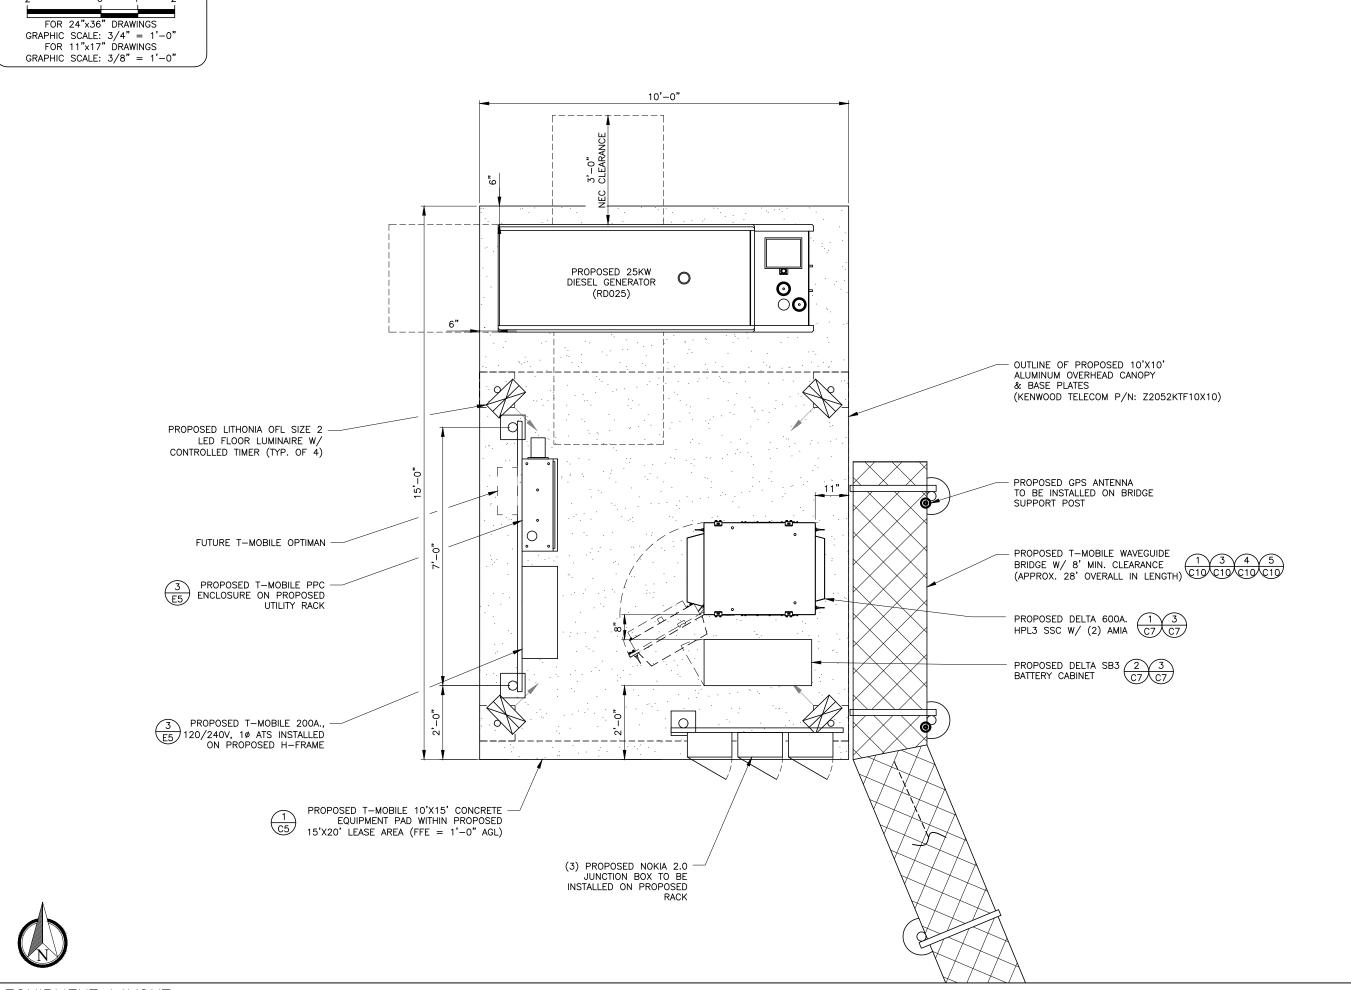
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	DRAWN BY:	J. MALLISON
PRO	JECT MANAG	ER: D. REVELS
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JACKSONVILLE, FLORIDA 32256

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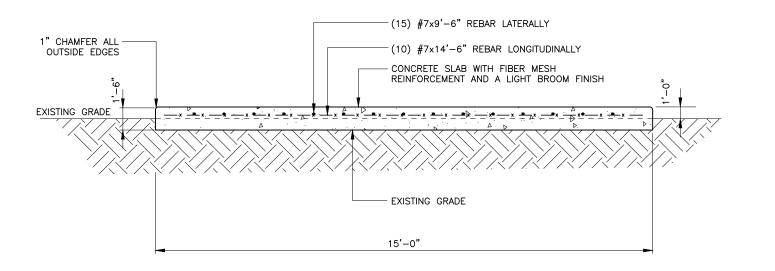
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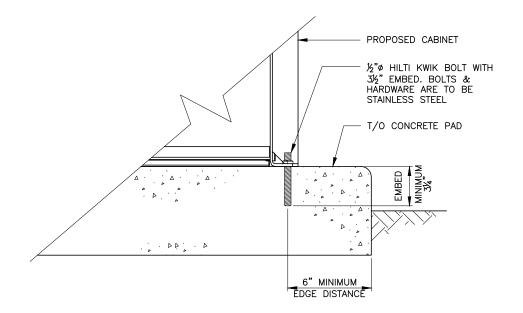
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NOTES

- 1. ALL CONCRETE TO HAVE A COMPRESSIVE STRENGTH OF fc'=3000 PSI WITH COMMERCIAL GRADE FIBER MESH REINFORCEMENT 1.5# PER CU. YARD
- 2. CONCRETE PAD IS DESIGNED TO BEAR ON 2000 PSF SOIL BEARING CAPACITY TO BE VERIFIED AT TIME OF EXCAVATION BY A SOILS ENGINEER REGISTERED IN THE STATE OF GEORGIA.

EQUIPMENT PAD FOUNDATION DETAIL



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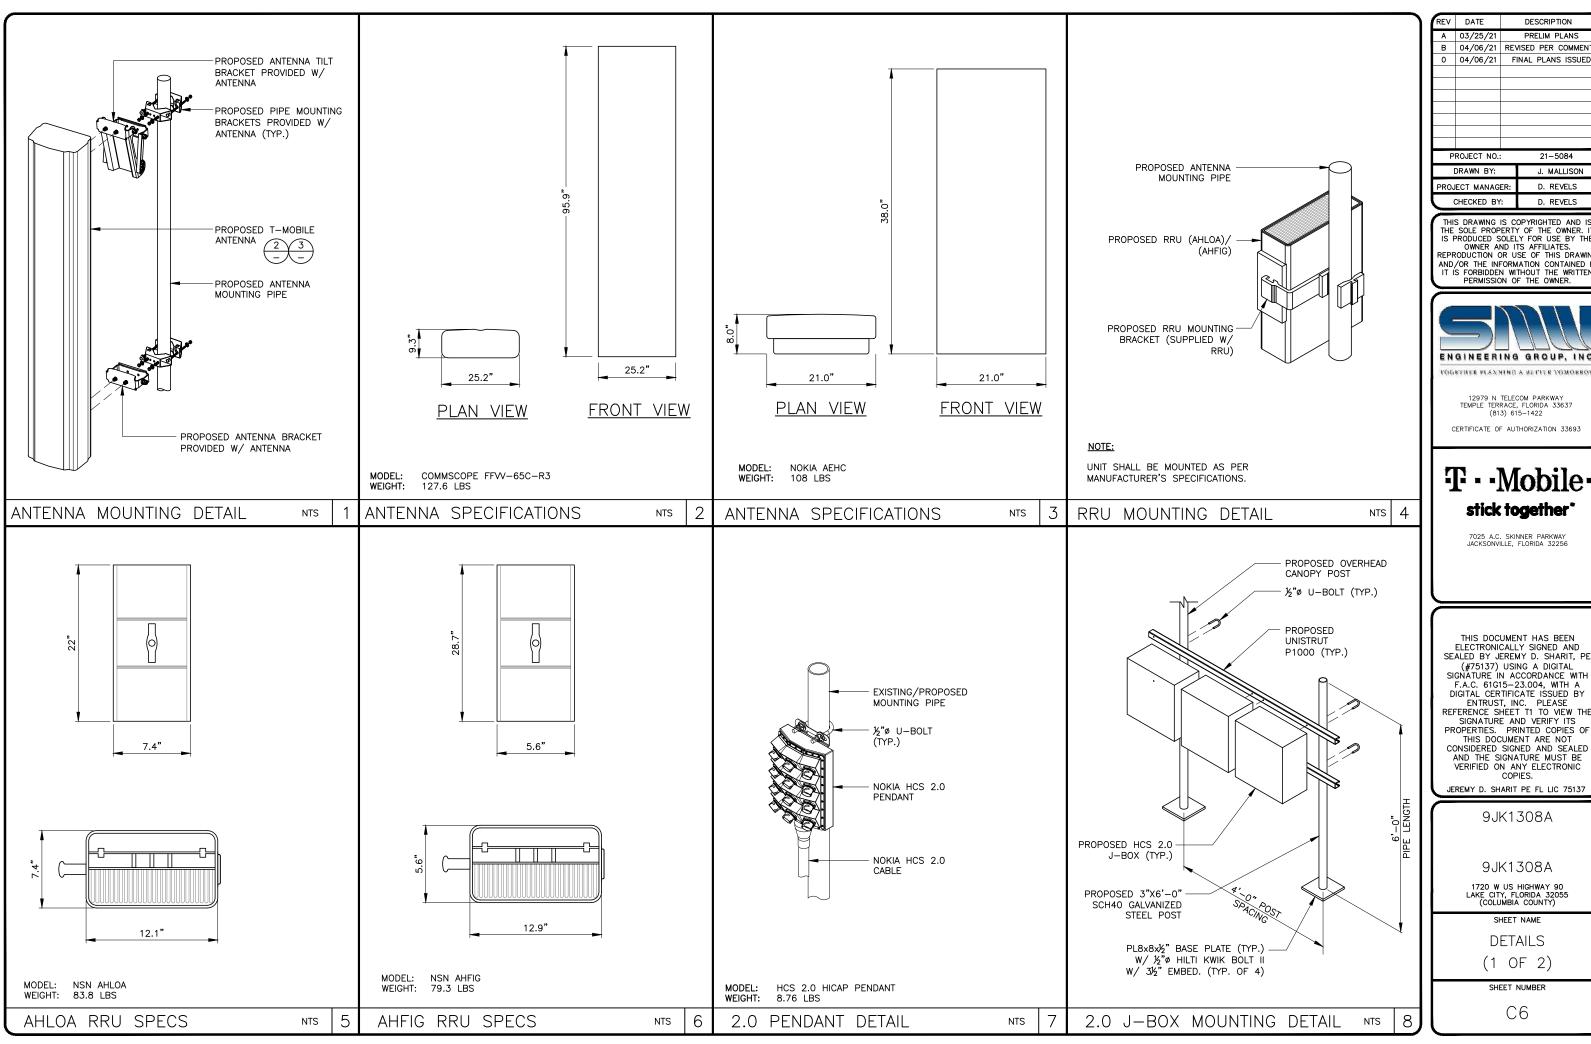
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EQUIPMENT PAD & CABINET MOUNTING DETAILS

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CABINET MOUNTING DETAIL



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9JK1308A

1720 W US HIGHWAY 90 LAKE CITY, FLORIDA 32055 (COLUMBIA COUNTY)

SHEET NAME

**DETAILS** 

(1 OF 2)SHEET NUMBER

С6

### **Specifications**

Model	HP-Large 3 Power Cabinet		
1. General			
Construction	Aluminum enclosure		
Dimensions (W x H x D)	30 x 72 x 35 in.(766x 1829 x 889 mm), Depth with Door: 41 in. (1067 mm)		
Weight	~551 lbs (~270kg) (withoutcustomer equipment or batteries)		
Internal rack dimension	Total Equipment space, 30RU:  Horizontal rack: 19" x 27RU		
	Vertical rack: 19" x 3RU		

Power System space: 23" x 12RU

Mounting options	Pad-mount, plinth option	
Finish	Polyester Powder Paint (Tan)	
Safety	UL Listed , IEC / EN 60950	
2. Environment		
Operating temperature	-40°C to +50°C ( -40°F to +122°F) with solar load. IP55	
Protection class	designed to GR-487	
Acoustics	5°C delta T: 70 dBA @ 6000W, 65dBA @5000W heat load	
Humidity (relative)	95%,non-condensing (Max.)	
3. Thermal managemen	t l	
Cooling Equipment:	Direct Air Cooling 6000W, 5°C delta T	

7100000110	•	3 C della 1. 10 dbA @ 0000W, 03dbA @3000W Heat load		
Humidity (relative)		95%,non-condensing (Max.)		
3. Thern	nal management			
Cooling	Equipment:	Direct Air Cooling 6000W, 5°C delta T (6) centrifugal redundant fans, (3) Merv-13 or optional GORE filters front door (3) Merv-13 filters rear hatch		


Heating	Equipment:	Forcedair heating (2) 1000W AC heaters

Heating Equipment:	Forcedair heating (2) 1000W AC heaters
4. Equipment	
	Knock-out plate on each upper side wall
Cable Entry	Additional knockouts each side
	(1) 3" conduit hole with hole plug
Door latch	3 point latching, 5/16 nut driver tool, pad-locking capability
Primary ground	10 double-hole 1/4"-20 threaded holes on 5/8" center ground bar
Lifting Ears	4 Lifting Tabs
Standard equipment	AC Load Center: 240V dual feed / (1) 200A + (1)100A
	208V single feed / (1) 200A
	AC SurgeProtection for each breaker feed
	GFCI Receptacle 120V
	(6 form-C) Alarm Termination block
	(1) Thermal Probe
	605A/ 54V (336kW) redundant Power System with DIN rail distribution:
	12 rectifier positions (qty 3x55A DPR3000 rectifiers included)
	52 poles for load (qty 1x150A, 3x10A load circuit breakers included) 16
	poles for battery (qty 2x200A battery circuit breakers included) (2)
	SB350 generator connector
	LVD over-ride switch
	(2) SB175 Battery connections (2) SB350 Battery connections
	(2) 35330 Battery Connections
Front	Door: (6) DC powered centrifugal fans with (3) MERV-13 filters, (GORE option)
	Clogged Filter alarm pressure switch
	Door intrusion alarm

(2) 1000W AC powered heaters


LED interior cabinet light

Rear Hatch: Exhaust vent with (3) MERV-13 filters

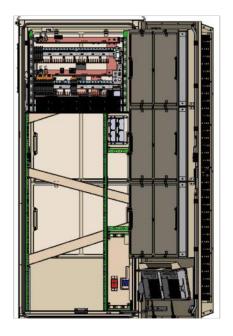

#### **Specifications**

Model	Small Battery 3 (SB3) Cabinet
1. General	
Construction	Aluminum enclosure
Dimensions (W x H x D)	15 x 72 x 35in. (381 x 1829x 889mm), Depth with door: 37.4 in. (950mm)
Weight	~310lbs 141(kg) (without batteries)
Internal rack dimension	4 battery trays to support up to 2 strings 210Ah batteries
Mounting options	Pad-mount, plinth option
Finish	Polyester Powder Paint (Tan)
Safety	UL Listed, IEC / EN 60950
2. Environment	
Operating temperature	-40C to +50C ( -40F to +122F) with solar load.
Protection class	IP55 designed to GR-487
Acoustics	65 dBA
Humidity (relative)	95%, non-condensing (Max.)
3. Thermal management	
Cooling	Direct Air Cooling: (4) Axial Fans. Filters: F6 front and rear
Heating	Forced air heating (1) 1000W AC heaters
4. Equipment	
Cable Entry	Knock-out plate on each upper side wall
	Additional knockouts each side
Door latch	3 point latching, 5/16 Nut driver tool, pad-locking capability
Lifting Ears	4 removable lifting ears
Standard equipment	AC Load Center with AC Surge protection and GFCI outlet Left or Right side AC entry options (1) 1000W AC powered heater
	DC Load Center 600A bulk feed bus bar (2) 400A bolt in battery breakers (4) 2-hole lug landings (2) Anderson SB350 input connectors to daisy chain 2 <sup>nd</sup> SB3 or LB3 battery cabinet 4/0 battery cables from breakers to trays
	(4) battery trays, each holds (2) 12V batteries up to 210Ah, two trays required per -48V battery string
	Door intrusion switch LED interior cabinet light Fan Control Board, factory wired alarms via RJ45 output (fan & breaker ala
	Cabinet Connection kit (2) 4/0 cables with SB350 disconnects to connect to power cabinet (2) 4/0 tray to tray cables supplied (4) High current Cell-Cell straps supplied (16) High current front terminal adapters supplied

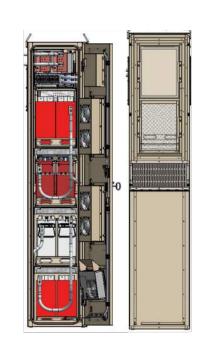

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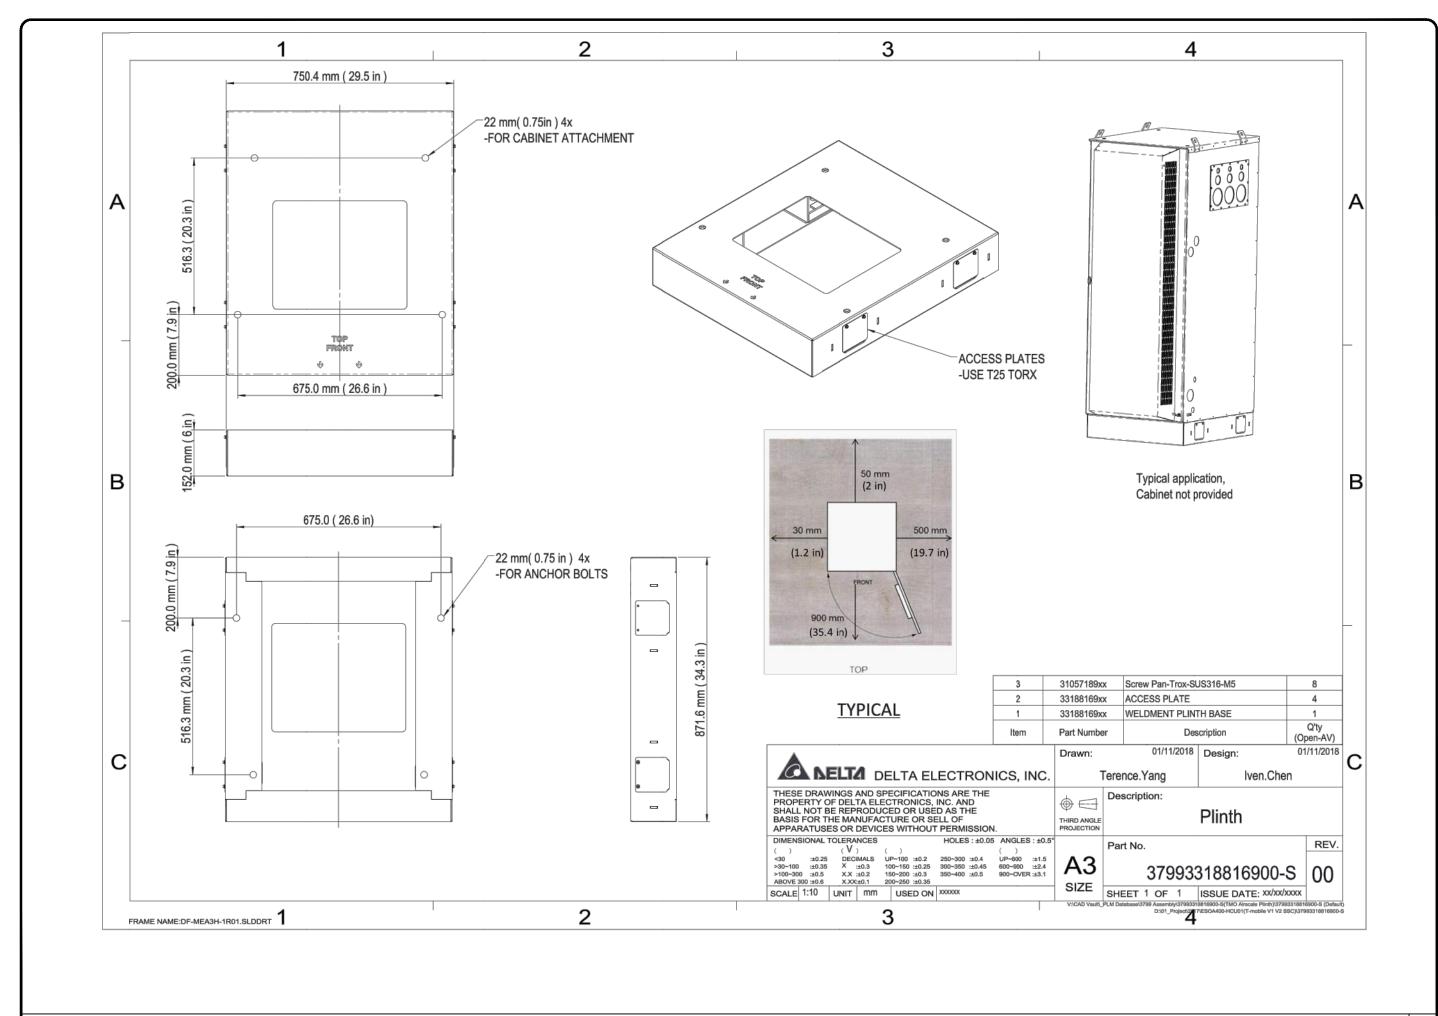
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SHEET NAME

DETAILS (2 OF 2)

SHEET NUMBER

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В	04/06/21	REVISED PER COMMENTS
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Р	ROJECT NO.:	: 21–5084
	DRAWN BY:	J. MALLISON
PROJ	ECT MANAG	ER: D. REVELS
	CHECKED BY	Y: D. REVELS

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TOGETHER PLANNING A BETTER TOMORROW

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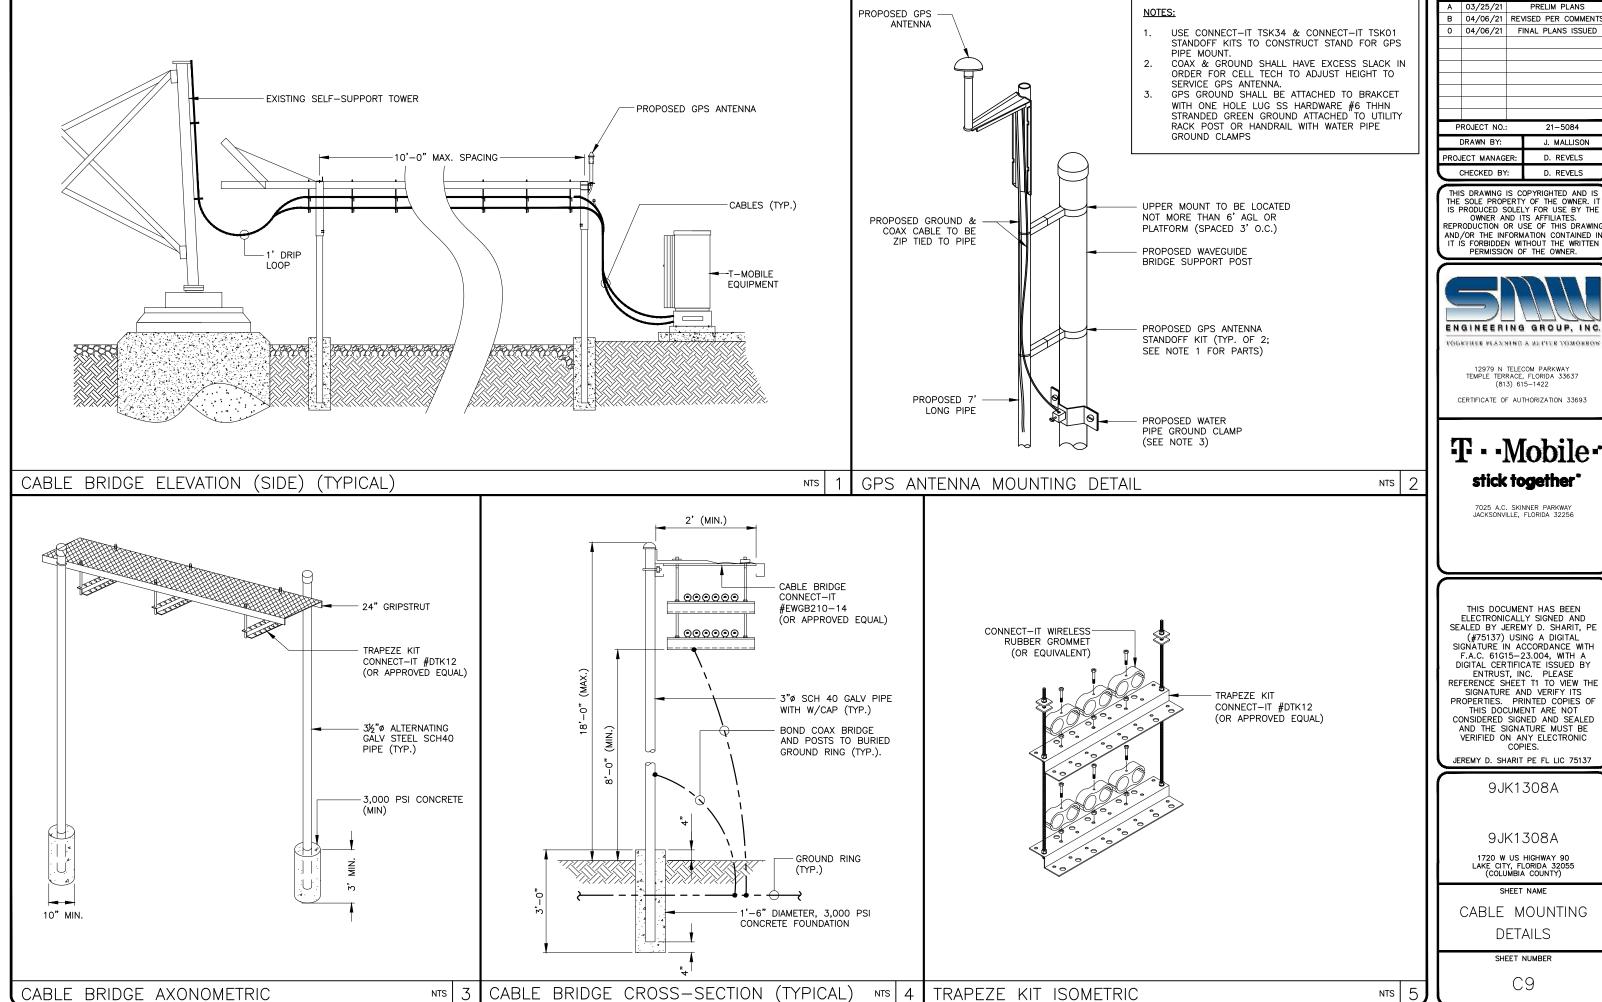
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CABINET MOUNTING DETAILS

SHEET NUMBER

C8




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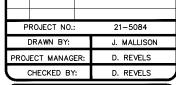


GENERATOR SIDE VIEW

GENERATOR END VIEW

SCALED AS NOTED

FOR 24"x36" DRAWINGS
GRAPHIC SCALE: 1" = 1'-0"
FOR 11"x17" DRAWINGS
GRAPHIC SCALE: 1/2" = 1'-0"

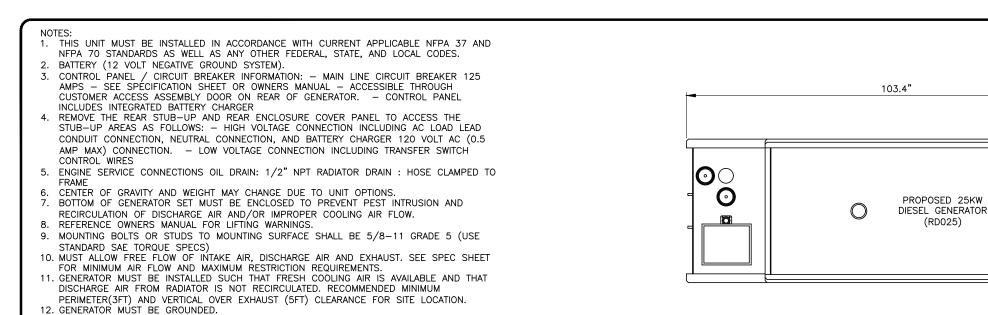

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SHEET NAME

GENERATOR DETAILS

SHEET NUMBER

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GENERATOR PLAN VIEW SCALED AS NOTED FOR 24"x36" DRAWINGS FOR 24"x36" DRAWINGS GRAPHIC SCALE: 1" = 1'-0"FOR 11"x17" DRAWINGS GRAPHIC SCALE: 1" = 1'-0"FOR 11"x17" DRAWINGS GRAPHIC SCALE: 1/2" = 1'-0"GRAPHIC SCALE: 1/2" = 1'-0"84.2" 33.5" 25KW DIESEL **GENERATOR** GENERATOR FUEL ½"ø HILTI KWIK BOLT WIT 3½" EMBED. BOLTS & 25KW DIESEL HARDWARE ARE TO BE **GENERATOR** STAINLESS STEEL T/O CONCRETE PAD GALLON GENERATOR 6" MINIMUM BASETANK EDGE DISTANCE GALLON GENERATOR **BASETANK** 18.9" 25.2" 25.1" 25.2" 35.0" PROPOSED CONCRETE PAD-PROPOSED CONCRETE PAD

3

SCALED AS NOTED

GENERATOR ANCHORING DETAIL

		Sec	tion 1 - Sit	e Informat	ion	
Last Modified: 4.	placement	Site Type: 1	Self Support To: Structure Non Bo 2020 DKSONVILLE FI kia	ulding	Latitude: 39,160 Longitude: 492.# Address: 1720 V City, State: Lake Region: SOUTH	6049200 V De Highway 80
RAN Template: 5	6794EZ_SR_U21			AL Template:	56794EZ_SR_U21	
Sector Count: 4	Antenna Count: 7	1	Coax Line Cour	n: 0	TMA Count: D	RRU Count: B
		Pr	oposed RAI	N Equipmen	it	
		1.0	Template: 567	94EZ_SR_U21		
Enclosure	1		2		3	4
Enclosure Type	Delta HPL3 600A DC plant	(Taver Top N	Aourt (Nokia)	(An	cilary Equipment (Noka)	Delta LB3 Battery Cabinet (4 strings)
Baseband	ASIB   ASIK   ASIK   ASIB   L2600					
Baseband Submodule	ABIA (x 2 ) ABIA (x 3) (x 3) (x 5) (x 5) (x 1) (					
Baseband Subrack	[AMIA (x 2 )]					
Hybrid Cable System	Voltage Booster PowerPlus w/ 2 Amplifier Raycap Extra Amplifier for PowerPlus Voltage Booster				sin HCS 2.0 Trunk "Select gih" (x 3 )	
Junction Box				(No)	kia HCS 2.0 Tower Junction Box	
Power subsystem	Rectifier Shelf "Select size"  Breakers "Select size"					Batteries *Select size*)
Radio		AHLOA (x 4 L/00 L900 Ne00	AHFIG (x 4 L2100 L1900 G1900 U2100			

Coverage Type	K	3			
	A - Cuidoor Mas				
Antenna			1		2
Antenna Model	Commiscope - F	FVV-65C-R3-V1 (0.8	0)		(AEHC (Active Antenna - Massive MIMO))
Azimuth	(25)				26
M. Tilt	0				0
Height	250)				(250)
Ports	P1	P2	P3	P4	P5
Active Tech.	L700 (L800) (N800)	(L700) [L800] (N600)	[2100 [L1900] [G1900] [U2100]	(L2100) (L1900) (G1900) (U2100)	(L2502) (N2500)
Dark Tech.					
Restricted Tech.					
Decomm. Tech.					
E. Tilt	4	0	2	(2)	2
Cables					
TMAs					
Diplexers / Combiners					
Radio					
Sector Equipment					
Unconnected Equip	ment:				

Coverage Type	A - Outdoor Mac	4 - Custour Macro							
Antenna			1		2				
Antenna Model	Соптворре - FI	FVV-85C-R3-V1 (Oc	loi)		(AEHC (Active Antenna - Massive MIMO))				
Azimuth	(100)				(100)				
M. Tilt	0				0				
Height	(250)				(250)				
Ports	P1	P2	P3	P4	P5				
Active Tech.	L700 (L800) (N800)	(L700 L800) (N800)	(L210) (L1900) (G1900) (U2100)	(L2100) (L1900) (G1900) (U2100)	(250) (N250)				
Dark Tech.									
Restricted Tech.									
Decomm. Tech.									
E. TIR	•	0	2	2	0				
Cables									
TMAe									
Diplexers / Combiners									
Radio									
Sector Equipment									
Unconnected Equip	ment:		-10	<del>(</del> 1					

Coverage Type		_				
	A - Ouidoor Mac	200				
Antenna			1		2	
Antenna Model	Commiscope - F	FVV-85C-R3-V1 (Oc	lo)		(AEHC (Active Antenna - Massive MIMO))	
Azimuth	(195)				(200)	
M. Titt	0				0	
Height	250)				250	
Ports	P1	P2	P3	P4	P5	
Active Tech.	L700 L800 N800	L700 L800 (N800	(L2100 (L1900) (G1900) (U2100)	(2100) (L1900) (G1900) (U2100)	(L2500) (N2500)	
Dark Tech.						
Restricted Tech.						
Decomm. Tech.						
E. Tilt	•	4	2	2	3	
Cables						
TMAe						
Diplexers / Combiners						
Radio		1	1	P		
Sector Equipment		1				
Unconnected Equip	oment:	*	-10			

Coverage Type	A - Cuideor Macro						
Antenna			1				
Antenna Model	Commiscope - FFVV-85C-R3-V	/1 (Octo)					
Azimuth	(280)						
M. Tilt	0						
Height	250)						
Ports	P1	P2	P3	P4			
Active Tech.	[L700] [L800] [N600]	(L7C0) (L600) (N600)	(L2100) (L1900) (G1900) (U2100)	[L2100] [L1900] [G1900] [U2100]			
Dark Tech.							
Restricted Tech.							
Decomm. Tech.							
E. Tilt	4	(4)	2	2			
Cables							
TMAs							
Diplexers / Combiners							
Radio							
Sector Equipment							
Unconnected Equip	mient:		*	7.			

Α	03/25/21		PRE	LIM PI	_ANS	
В	04/06/21	REVISED PER COMMENT				
0	04/06/21	F	INAL	PLANS	ISSUED	
PI	ROJECT NO.:	:		21-50	084	
DRAWN BY:			J. MALLISON			
PROJECT MANAGE			ER: D. REVELS			
	CHECKED BY			D. RE	/ELS	

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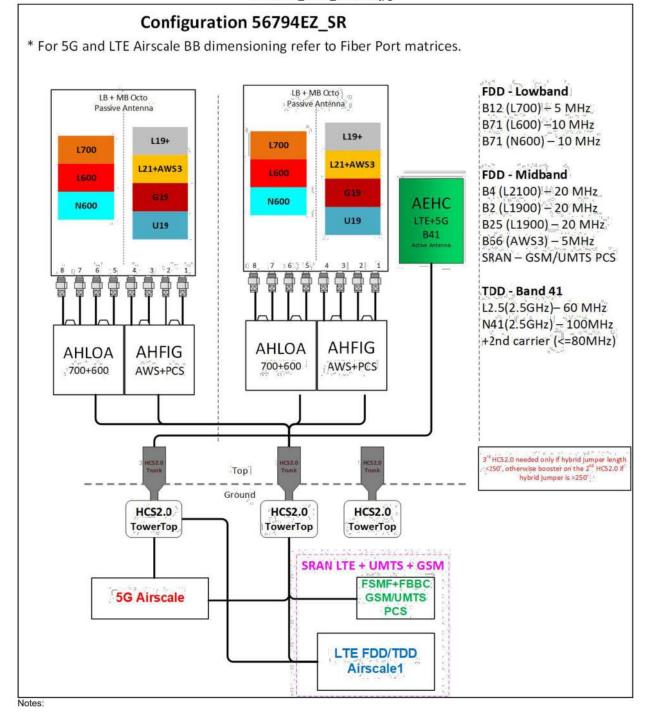
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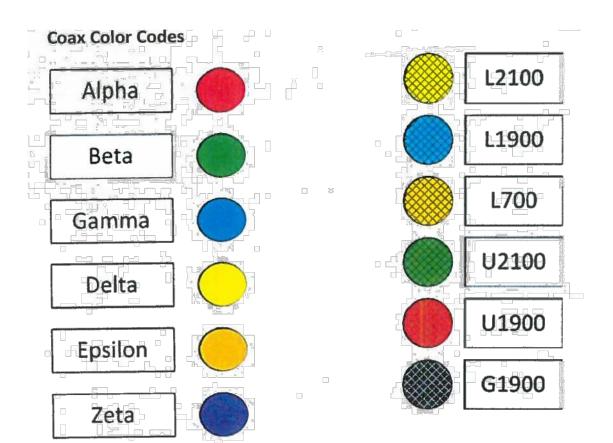
PROPOSED ANTENNA SCHEDULE

SHEET NUMBER

ransport System (CSR IXRe V1 (Gen1))

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Α		03/25/21		PRELI	M PL	ANS	
В		04/06/21	RE\	/ISED P	ER C	ОММ	ENTS
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	Ρ	ROJECT NO.:	:	2	1-50	84	
	ı	DRAWN BY:		J.	MAL	LISON	1
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	(	CHECKED BY	<b>′</b> :	D.	RE\	/ELS	

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1720 W US HIGHWAY 90 LAKE CITY, FLORIDA 32055 (COLUMBIA COUNTY)

SHEET NAM

PROPOSED ANTENNA PLUMBING DIAGRAM

SHEET NUMBER

RF2

#### A - GENERAL

- A1. ALL ELECTRICAL WORK SHALL CONFORM TO THE NATIONAL ELECTRICAL CODE (EDITION ADOPTED BY LOCAL JURISDICTION) AND APPLICABLE LOCAL CODES.
- A2. GROUNDING SHALL COMPLY WITH ARTICLE 250 OF THE NATIONAL ELECTRIC CODE.
- 43. ALL ELECTRICAL EQUIPMENT AND ACCESSORIES SHALL BE U.L. APPROVED OR LISTED.
- A4. ALL POWER WIRING SHALL BE STRANDED COPPER, TYPE THHN/THHW, AND 90 DEGREES C RATED.
- A5. GROUNDING ELECTRODE CONDUCTORS SHALL BE BARE, TIN COATED COPPER AND EQUIPMENT GROUND CONDUCTORS SHALL BE GREEN INSULATED, UNLESS OTHERWISE NOTED.
- A6. ALL POWER WIRING SHALL BE INSTALLED IN GALVANIZED RIGID STEEL CONDUIT, PVC, OR FLEXIBLE LIQUIDTIGHT CONDUIT, AS INDICATED.
- A7. CONTRACTOR SHALL OBTAIN ALL PERMITS, PAY PERMIT FEES, AND SCHEDULE INSPECTIONS.
- A8. CONTRACTOR SHALL APPLY FOR ELECTRICAL SERVICE AS SOON AS POSSIBLE AND COORDINATE REQUIREMENTS, SERVICE ROUTING, AND METER SOCKET TYPE WITH LOCAL POWER COMPANY.
- A9. CONTRACTOR SHALL APPLY FOR TELEPHONE SERVICE AS SOON AS POSSIBLE AND COORDINATE REQUIREMENTS AND SERVICE ROUTING WITH TELEPHONE COMPANY.
- A10. PROVIDE ALL LABOR AND MATERIAL DESCRIBED ON THIS DRAWING, AND ALL ITEMS INCIDENTAL TO COMPLETING AND PRESENTING THIS PROJECT AS FULLY OPERATIONAL.
- A11. WHERE LONG POWER CABLE RUNS PREVAIL, CONTRACTOR SHALL CALCULATE THE VOLTAGE DROP AND SIZE WIRES AND CONDUIT ACCORDINGLY.
- A12. WHERE TRANSFORMER IS REQUIRED FOR ELECTRICAL SERVICE, TRANSFORMER SECONDARY SHALL BE GROUNDED PER N.E.C., ARTICLE 250-26.
- A13. REFER TO SITE SPECIFIC DWGS FOR ELEVATIONS.
- A14. ALL ELECTRICAL DEVICES EXPOSED TO WEATHER SHALL BE OF RAINPROOF CONSTRUCTION AND SHALL REQUIRE WATER TIGHT CONDUIT HUBS. NEMA 3R TYPICAL
- A15. CONTRACTOR SHALL COIL CABLES AT HANDHOLE WITH LENGTHS AS REQUIRED BY ELECTRICAL UTILITY FOR CONNECTION BY LITHLITY.
- A16. ALL UNDERGROUND SERVICE ENTRANCE POWER CABLES SHALL BE TYPE FOR SUCH USE. CONTRACTOR SHALL CALCULATE VOLTAGE DROP AND RE-SIZE CABLES PER NEC REQUIREMENTS FOR CABLE RUNS EXCEEDING 250 FEET.

#### B - POWER CABLE AND SERVICE

- B1. CONTRACTOR SHALL PROVIDE CONDUIT AND WIRING TO BTS AND VERIFY EXACT CONDUIT ROUTING. RACEWAY SYSTEM MATERIALS AND DEVICES FURNISHED SHALL BE IN ACCORDANCE WITH APPLICABLE STANDARDS OF ANSI, NEMA, AND UL. RACEWAY SYSTEM COMPONENTS SHALL BE INSTALLED IN ACCORDANCE WITH APPLICABLE REQUIREMENTS OF THE N.E.C.
- B2. CONTRACTOR SHALL SEAL AROUND ALL CONDUIT PENETRATIONS THROUGH WALLS, FLOORS AND ROOFS TO PREVENT MOISTURE PENETRATION OR VERMIN INFESTATION.
- B3. CONDUCTORS RUNNING ALONG HORIZONTAL SURFACES (ROOF TOP OR SLAB) SHALL BE INSTALLED IN RIGID CONDUIT SUPPORT.
- B4. ALL VERTICAL RUNS OF POWER CABLE EXCEEDING 80 FEET IN LENGTH SHALL BE SUPPORTED PER N.E.C. ARTICLE 300 USING KELLEMS GRIPS OR ACCEPTABLE EQUAL CABLE SUPPORT SYSTEM.
- B5. WHERE A SEPARATE ELECTRICAL SERVICE DROP IS ADDED, CONTRACTOR SHALL INSTALL PERMANENT SERVICE DISCONNECT OR GROUPING THEREOF, DENOTING ALL OTHER SERVICE ENTRANCES, LOCATION OF EACH AND THE AREAS SERVED BY EACH.
- B6. WHERE ELECTRICAL POWER IS TO BE SUB-FED FROM AN EXISTING DISTRIBUTION SYSTEM, THE FOLLOWING SHALL APPLY:
  - A) CONTRACTOR SHALL PERFORM LOAD TESTING TO DETERMINE MAXIMUM FEEDER DEMAND PER N.E.C. ARTICLE 220-35.
  - B) CONTRACTOR SHALL VERIFY WHETHER EXISTING FEEDER CAPACITY EXCEEDS VALUE CALCULATED PER N.E.C. ARTICLE 220-35
  - C) EACH BRANCH CIRCUIT PROTECTIVE DEVICE SHALL HAVE SAME INTERRUPTING RATING AS EQUIPMENT SUPPLYING IT.

    D) PREFERRED MEANS OF SUPPLY SHALL BE A BRANCH CIRCUIT PROTECTIVE DEVICE LOCATED IN EXISTING PANEL.
  - E) IF A BRANCH CIRCUIT PROTECTIVE DEVICE CANNOT BE OBTAINED OR SPACE IS NOT AVAILABLE, A BRANCH CIRCUIT MAY BE TAPPED FROM EXISTING FEEDER CONDUCTORS USING AN INSTALLED 2—POLE FUSED DISCONNECT AND METER BASE PER N.E.C. ARTICLE 240—21 WITH TEN FOOT (10) MAXIMUM TAP CONDUCTORS. FUSED DISCONNECT SHALL BE LISTED SAME OR BETTER INTERRUPTING RATING AS EXISTING SOURCE OF SUPPLY.

#### C - RF (COAX) AND LOW VOLTAGE CABLE

- C1. RF CABLES AND LOW VOLTAGE CABLING BETWEEN BTS, LNA OR TMA AND ANTENNA SHALL BE SUPPORTED USING ANDREW "SNAP-IN" HANGERS OR ACCEPTABLE EQUAL.
- C2. RF CABLES AND LOW VOLTAGE CABLING BETWEEN BTS, LNA OR TMA AND ANTENNA SHALL BE ROUTED AS FOLLOWS:
  - A) RUNNING ALONG HORIZONTAL SURFACES: USE WAVEGUIDE SUPPORTS OR BRIDGE KIT MOUNTED ON CONCRETE SLEEPERS.
  - B) RUNNING ALONG VERTICAL TOWER FACE: WAVEGUIDE LADDER W/HANGERS OR KELLEMS GRIPS.
  - C) RUNNING ALONG OR ADJACENT TO BTS PLATFORM: USE 12 X 3 OPEN OR COVERED ELECTRICAL LADDER TRAY.

#### D - IDENTIFICATION

- D1. LOCATE NAMEPLATE, MARKING, OR OTHER IDENTIFICATION MEANS ON OUTSIDE EQUIPMENT OR BOX FRONT COVERS.
- D2. PROVIDE NAMEPLATE ENGRAVED WITH EQUIPMENT DESIGNATION FOR EACH SAFETY SWITCH AND ALL OTHER ELECTRICAL CABINETS. ETC.
- D3. DURING TRENCH BACK-FILLING FOR EACH UNDERGROUND ELECTRICAL, TELEPHONE, SIGNAL AND COMMUNICATIONS LINE, PROVIDE A CONTINUOUS UNDERGROUND WARNING TAPE TWELVE INCHES BELOW FINISHED GRADE.

Α	03/25/21		PR	ELIM PLANS
В	04/06/21	RE\	/ISED	PER COMMENTS
0	04/06/21	F	INAL	PLANS ISSUED
Ρ	ROJECT NO.:	:		21-5084
	DRAWN BY:			J. MALLISON
PROJ	ECT MANAG	ER:		D. REVELS
	CHECKED BY			D. REVELS

DESCRIPTION

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JEREMY D. SHARIT PE FL LIC 75137

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1720 W US HIGHWAY 90 LAKE CITY, FLORIDA 32055 (COLUMBIA COUNTY)

SHEET NAMI

ELECTRICAL NOTES

SHEET NUMBER

Ε1

ELECTRICAL NOTES

#### A - GENERAL

- A1. INSTALLATION OF GROUNDING ELECTRODE SYSTEM SHALL COMPLY WITH ARTICLE 250 OF THE NATIONAL ELECTRIC CODE AND WITH ALL BUILDING CODES OF AUTHORITIES HAVING JURISDICTION.
- A2. GROUNDING CONDUCTORS SHALL BE #2 AWG TINNED SOLID BARE COPPER BELOW AND ABOVE GRADE, UNLESS OTHERWISE NOTED AND SHALL BE ROUTED IN A DOWNWARD PATH TOWARDS GROUND BARS.
- A3. GROUNDING CONDUCTORS SHALL BE KEPT AS SHORT AND DIRECT AS POSSIBLE WITH MINIMUM BEND RADIUS OF 12 INCHES.
- A4. ALL BELOW GRADE CONNECTIONS SHALL BE CADWELD TYPE CONNECTIONS AND ALL CONNECTIONS TO EQUIPMENT AND GROUND BARS SHALL BE 2-HOLE BRONZE COMPRESSION CONNECTORS UNLESS OTHERWISE NOTED.
- A5. CONTRACTOR SHALL INSTALL NEW PCS GROUNDING SYSTEM PER SPECIFICATIONS AND INTERCONNECT NEW SYSTEMS TO ANY EXISTING GROUNDING SYSTEMS AS REQUIRED BY NFPA 70 AND 780 (THIS APPLIES TO ELECTRICAL POWER DISTRIBUTION GROUNDING SYSTEM, LIGHTNING PROTECTION GROUNDING SYSTEM, COAX CABLE GROUNDING SYSTEM AND ANY OTHER EXISTING GROUNDING SYSTEMS).
- A6. GROUNDING CONDUCTORS SHALL BE BONDED TO CABLE SUPPORTS, ANTENNA FRAMES, AND ANY SUPPORT FRAMES OR RACKS USING CADWELD OR MECHANICAL CONNECTIONS.
- A7. CONTRACTOR SHALL PROVIDE LOCK WASHERS FOR ALL MECHANICAL CONNECTIONS FOR GROUND CONDUCTORS, STAINLESS STEEL HARDWARE SHALL BE USED THROUGHOUT.
- A8. GROUNDING CONDUCTORS EMBEDDED IN CONCRETE OR PENETRATING WALLS AND FLOORS SHALL BE ENCASED IN PVC CONDUIT. NO METALLIC CONDUIT SHALL BE USED FOR GROUNDING CONDUCTORS UNLESS REQUIRED BY LOCAL CODES OR OTHERWISE INDICATED ON DRAWINGS. CONTRACTOR SHALL SEAL AROUND ALL CONDUIT PENETRATIONS TO PREVENT MOISTURE PENETRATION AND VERMIN INFESTATION.
- A9. CONTRACTOR SHALL BOND PCS GROUNDING SYSTEM VIA THE MASTER GROUND BAR TO ALL METAL OBJECTS WITHIN 12 FEET OF EQUIPMENT, CONDUIT AND CABLES.
- A10. BONDING OF GROUNDED CONDUCTOR (NEUTRAL) AND GROUNDING CONDUCTOR SHALL BE AT SERVICE DISCONNECTING MEANS. BONDING JUMPER SHALL BE INSTALLED PER N.E.C. ARTICLE 250-28.
- A11. CONTRACTOR SHALL VERIFY EXACT CONDUIT ROUTING FOR GROUNDING CONDUCTORS WHERE APPLICABLE.
- A12. A GROUND LEAD IS REQUIRED ONLY FOR BTS SUPPORTED ON STEEL FRAME. AN ADDITIONAL GROUND LEAD IS REQUIRED IF CABLE TRAY IS USED.
- A13. CONNECTIONS TO CGB SHALL BE ARRANGED IN THE FOLLOWING THREE GROUPS:
  - \* SURGE PRODUCERS (COAXIAL CABLE GROUND KITS, TELCO CABINET AND POWER PEDESTAL GROUND).
  - \* SURGE ABSORBERS (GROUNDING ELECTRODE RING OR BUILDING STEEL).
  - \* NON-SURGING OBJECTS (EGB GROUND IN BTS).
- A14. DOUBLING OR STACKING OF ANY GROUNDING CONNECTIONS IS NOT ACCEPTABLE.
- A15. ALL GROUND BARS SHALL BE INSTALLED WITH STAND OFF INSULATORS.

#### B - PREPARATION

- B1. SURFACES: ALL CONNECTIONS SHALL BE MADE TO BARE METAL. ALL PAINTED SURFACES SHALL BE FIELD INSPECTED TO ENSURE PROPER CONTACT. ALL GALVANIZED SURFACES ON WHICH GALVANIZING HAS BEEN REMOVED BY CUTTING, DRILLING, OR ANY OTHER OPERATION SHALL BE RE—GALVANIZED IN ACCORDANCE WITH ASTM A780 USING "ZINC RICH" COATING AS MANUFACTURED BY ZRC CHEMICAL PRODUCTS COMPANY (LOCATED IN QUINCY, MASSACHUSETTS), OR ACCEPTABLE EQUAL. NO WASHERS ARE ALLOWED BETWEEN ITEMS BEING GROUNDED. ALL CONNECTIONS ARE TO HAVE A NON—OXIDIZING AGENT ("COPPER SHIELD") APPLIED PRIOR TO INSTALLATION.
- B2. GROUND BAR: ALL COPPER GROUND BARS SHALL BE CLEANED, POLISHED AND A NON-OXIDIZING AGENT ("COPPER SHIELD") APPLIED. NO FINGER PRINTS OR DISCOLORED COPPER SHALL BE PERMITTED.

#### C - BUILDINGS

- C1. ELECTRICAL CONTRACTOR SHALL PERFORM REQUIRED TESTING ON GROUNDING SYSTEM ONCE GROUNDING SYSTEM IS COMPLETELY CONSTRUCTED AND BEFORE SERVICE POWER AND GROUND IS CONNECTED (SEE NOTE 11 FOR TEST DESCRIPTION).
- C2. A #4/O AWG COPPER CONDUCTOR SHALL BE ROUTED FROM MASTER GROUND BAR AT BTS SITE TO MAIN METAL COLD WATER PIPE AND BONDED TO PIPE WITH BRONZE 2-HOLE PIPE CLAMP. CLAMP SHALL BE CONNECTED TO WATER PIPE WITHIN 5 FEET OF ENTRY OF PIPE INTO BUILDING WITH NO DEVICES BETWEEN ENTRY POINT AND CONNECTION AND SHALL COME IN CONTACT WITH PIPE FOR A MINIMUM DISTANCE OF 4 INCHES.
- C3. METAL RACEWAYS, ENCLOSURES, FRAMES AND OTHER NON-CURRENT CARRYING PARTS OF ELECTRICAL EQUIPMENT SHALL BE KEPT AT LEAST 6 FEET AWAY FROM LIGHTNING ROD CONDUCTORS OR THEY MUST BE BONDED TO LIGHTING ROD CONDUCTORS AT THE LOCATION WHERE SEPARATION DISTANCE IS LESS THAN 6 FEET.
- C4. A MASTER GROUND BAR (MGB) SHALL BE INSTALLED NEAR BTS WITH BUILDING PRINCIPAL GROUND BAR (BPG) INSTALLED NEAR ENTRANCE OF MAIN METAL COLD WATER PIPE INTO BUILDING. A #4/O AWG STRANDED COPPER DOWN CONDUCTOR (VERTICAL GROUND RISER) SHALL BE USED TO INTERCONNECT GROUND BARS.
- C5. VERTICAL RISER SHALL CONSIST OF A #4/O AWG (THWN) STRANDED COPPER CONDUCTOR INSIDE 3/4" CONDUIT.
- C6. CONTRACTOR SHALL BOND BUILDING PRINCIPAL GROUND BAR (BPG) NEAR MAIN METAL COLD WATER PIPE TO EXISTING BUILDING GROUND RING AS WELL AS TO MAIN METAL COLD WATER PIPE WITH #4/0 AWG (THWN) STRANDED COPPER CONDUCTOR.
- C7. ANTENNA GROUND BARS (AGB) SHALL BE INSTALLED NEAR ANTENNAS AND SHALL BE BONDED TO MASTER GROUND BAR (MGB) WITH #2 AWG TINNED SOLID BARE COPPER CONDUCTOR.
- C8. IF CODES REQUIRE VERTICAL RISER TO BE ISOLATED IN CONDUIT, PVC CONDUIT IS PREFERRED. IF METALLIC CONDUIT IS USED, GROUNDING BUSHINGS SHALL BE INSTALLED ON EACH END OF THE CONDUIT AND BONDED TO GROUND BARS USING #2 AWG (THWN) STRANDED COPPER CONDUCTORS WITH GREEN INSULATION.

#### D - LAND BUILDS AND CO-LOCATES

- 11. THE GROUND ELECTRODE SYSTEM SHALL CONSIST OF DRIVEN GROUND RODS UNIFORMLY SPACED AROUND THE EQUIPMENT FOUNDATION AND AROUND THE PERIMETER OF THE TOWER FOUNDATION. THE GROUND RODS SHALL BE 56" X 10'-0" COPPER CLAD STEEL INTERCONNECTED WITH #2 SOLID TINNED BARE COPPER GROUND CONDUCTOR TO FORM A GROUND RING AT A DEPTH OF 30 INCHES BELOW THE SUFFACE OF THE SOIL. A MINIMUM OF 1 FOOT AND A MAXIMUM OF 3 FEET CLEARANCES SHALL BE MAINTAINED FROM FOUNDATIONS. TOWER AND EQUIPMENT GROUND RINGS SHALL BE INTERCONNECTED WITH TWO GROUNDING CONDUCTORS OF EQUAL LENGTH AND MATERIALS.
- D2. GROUND RODS SHALL BE BONDED TO GROUND RINGS AND INTERCONNECTING CONDUCTORS AT EQUAL INTERVALS OF APPROXIMATELY 10 FEET.
- D3. WAVEGUIDE BRIDGE SHALL BE BONDED TO GROUND RINGS OR INTERCONNECTING CONDUCTORS WITH GROUNDING CONDUCTORS BONDED TO DIAGONALLY OPPOSED SUPPORT POSTS.
- D4. GROUND BARS SHALL BE BONDED TO GROUND RING WITH SINGLE GROUNDING CONDUCTOR.
- D5. BONDS TO ANTENNA MASTS, FENCE POSTS, WAVEGUIDE BRIDGE, TOWER STEEL (UNLESS PROHIBITED BY TOWER MANUFACTURER) AND THOSE BELOW GRADE SHALL BE EXOTHERMIC TYPE (CADWELD). ALL OTHER BONDS SHALL BE BRONZE 2—HOLE COMPRESSION FITTINGS UNLESS OTHERWISE NOTED.
- D6. GROUNDING CONDUCTORS MAKING A TRANSITION FROM ABOVE TO BELOW GRADE SHALL BE INSULATED FROM EARTH CONTACT BY PASSING THROUGH PVC CONDUIT. THE CONDUIT SHALL EXTEND AT LEAST 6 INCHES ABOVE AND 12 INCHES BELOW GRADE LEVEL.

#### E - LIGHTNING PROTECTION

- E1. IF EXISTING BUILDING HAS AN NFPA 780 AIR TERMINAL SYSTEM, EXISTING SYSTEM SHALL BE BONDED TO A GROUND BAR TO BOND THE EXISTING SYSTEM TO THE NEW SYSTEM. SHOULD THE EXISTING SYSTEM COME WITHIN 8 FEET OF ANTENNA STRUCTURES, EXISTING SYSTEM SHALL ALSO BE BONDED TO COAX GROUND BARS.
- E2. IF SITE IS IN A HIGH RISK AREA AND ANTENNAS DO NOT FALL WITHIN EXISTING CONE OF PROTECTION FOR BUILDING, AIR TERMINALS SHALL BE INSTALLED AT ANTENNAS. A SINGLE AIR TERMINAL MAY BE USED WHEN TWO ANTENNAS ARE MOUNTED ON SAME STRUCTURE AND IT HAS BEEN DETERMINED THAT BOTH ANTENNAS WILL FALL WITHIN LIGHTNING CONE OF PROTECTION FOR SINGLE AIR TERMINAL.

#### T - GROUNDING REQUIREMENTS

- T1. CONTRACTOR SHALL INSPECT AND TEST ANY NEW OR EXISTING T-MOBILE GROUNDING SYSTEM WITH A BIDDLE-MEGGER TESTER UTILIZING THE FALL OF POTENTIAL METHOD AND CONTACT CONSTRUCTION MANAGER IF RESISTANCE EXCEEDS 5 OHMS AND SHALL FIELD MODIFY GROUNDING SYSTEM AS NECESSARY TO ACHIEVE COMPLIANCE. TEST RESULTS AND CONCLUSIONS SHALL BE RECORDED FOR PROJECT CLOSE-OUT DOCUMENTATION.
- T2. COAX CABLE OUTER CONDUCTORS (SHIELDS) SHALL BE GROUNDED USING COAX GROUNDING KITS AT A MINIMUM OF TWO POINTS, INCLUDING AT ANTENNA AND AT MASTER GROUND BAR. THE COAXIAL CABLE SHALL NOT EXCEED 100 FEET BETWEEN GROUNDING KITS.
- T3. GROUNDING CONDUCTOR CONSISTING OF 2-#2 AWG TINNED SOLID BARE COPPER WIRE SHALL BE BONDED TO WAVEGUIDE ENTRY GROUND BAR USING CADWELD CONNECTIONS.
- T4. COAX CABLE ENTERING A BUILDING SHALL BE GROUNDED WITH COAX GROUNDING KITS TO AN INSULATED COAX GROUND BAR WHICH SHALL BE INSTALLED ON THE OUTSIDE FACE OF THE BUILDING, BELOW THE CABLE ENTRY PORTS.
- T5. WHEN COAX CABLES ENTER A BUILDING FROM A TOWER, THE COAX GROUND BAR AT THE BUILDING SHALL BE CONNECTED TO THE EXTERNAL GROUND RING USING 2-#2 AWG BARE TINNED SOLID COPPER ISOLATED IN PVC CONDUIT.
- T6. WHEN COAX CABLES ENTER A BUILDING FROM A ROOF TOP, THE COAX GROUND BAR AT THE BUILDING SHALL BE CONNECTED TO THE MASTER GROUND BAR NEAR THE BTS USING #2 AWG STRANDED INSULATED COPPER CONDUCTOR (SEE BUILDINGS NOTES ON THIS DRAWING FOR CONNECTION TO PRINCIPLE GROUND BAR AND BUILDING GROUND).

В	04/06/21	RE۱	/ISED	PER	COMMENTS
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PF	ROJECT NO.:			21-5	5084
D	RAWN BY:			J. MA	ALLISON
PROJE	ECT MANAG	ER:		D. RI	EVELS
С	HECKED BY	:		D. RI	EVELS
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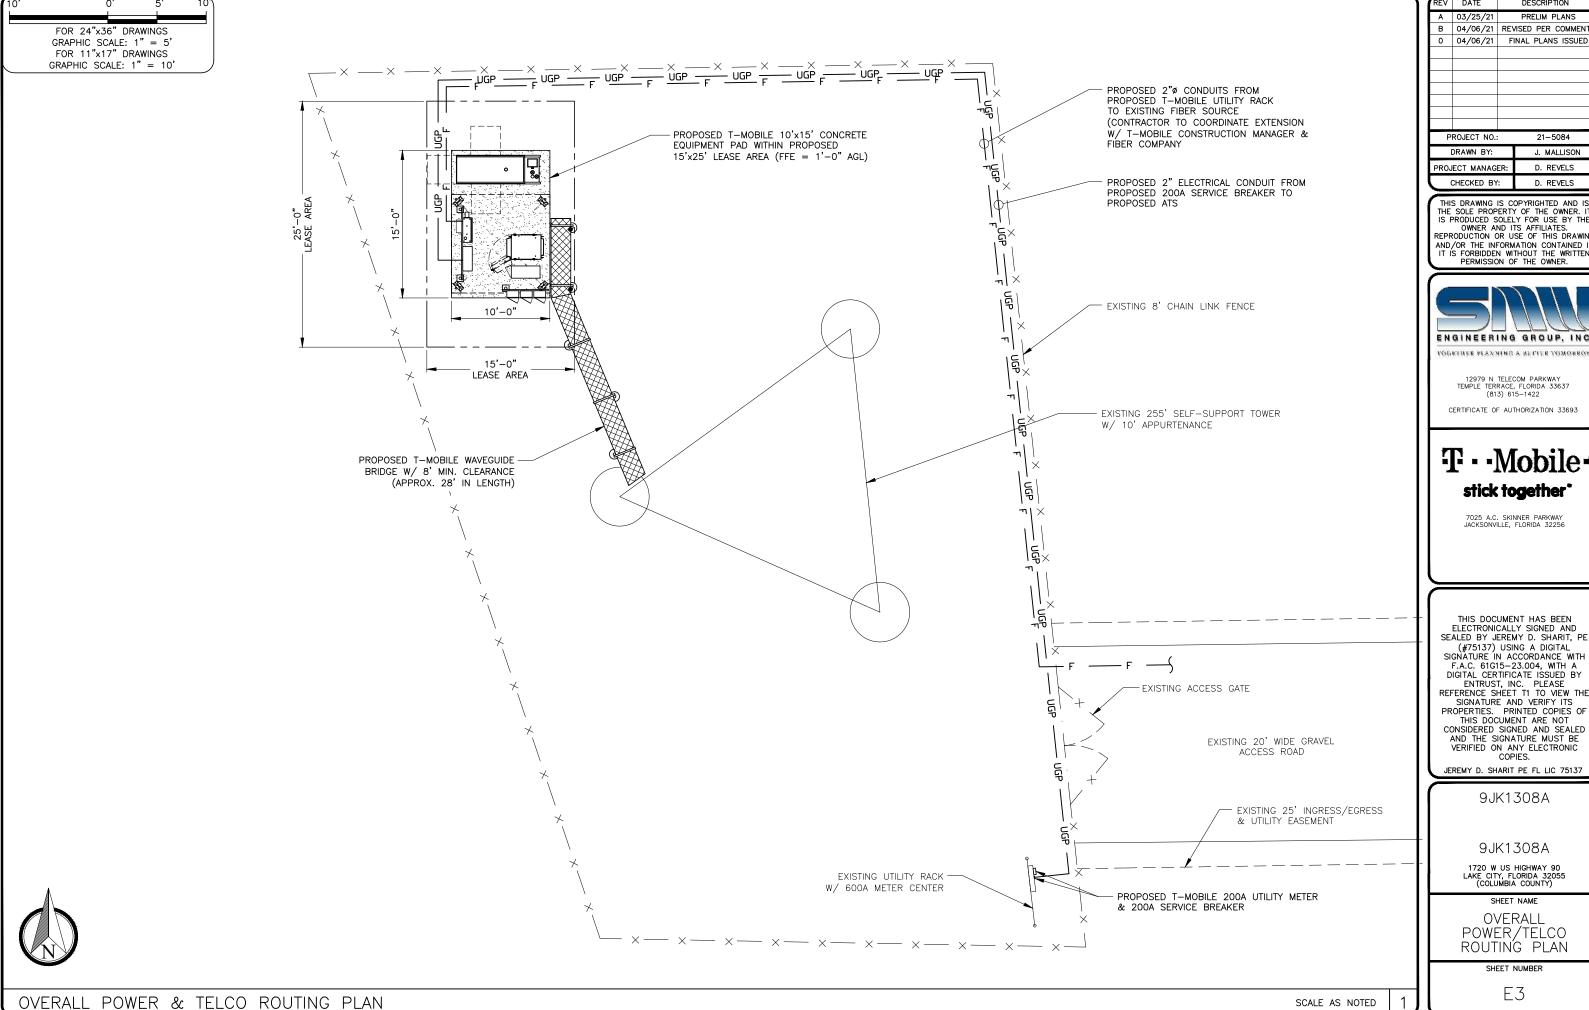
GROUNDING NOTES

SHEET NUMBER

E2

GROUNDING NOTES

| 1



1	REV	DATE		DESCRIP	TION	
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	Р	ROJECT NO.:		21-	5084	
		DRAWN BY:		J. M.	ALLISON	
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D. REVELS



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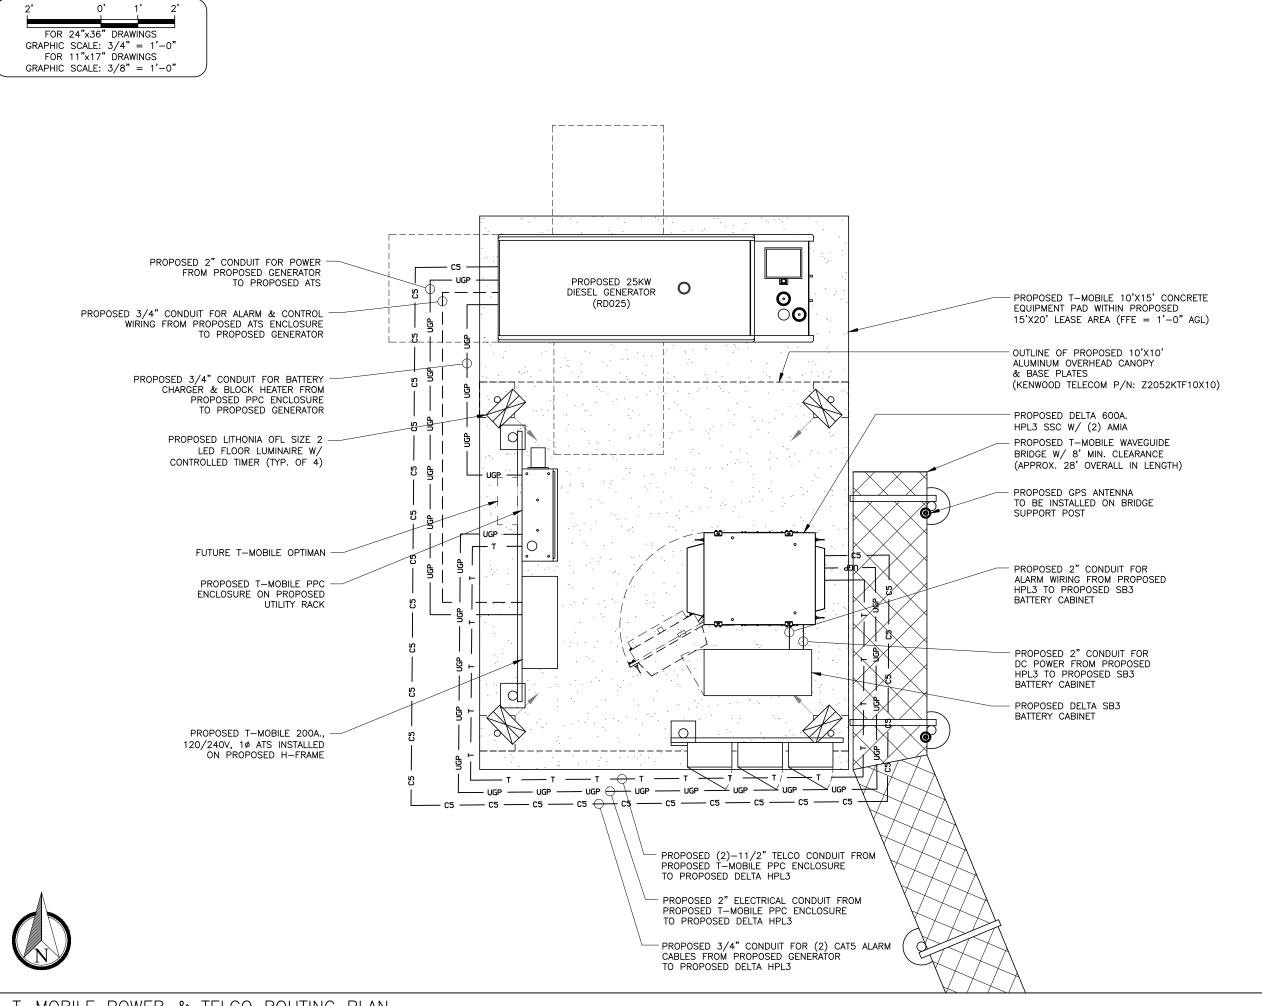
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SHEET NAME

OVERALL POWER/TELCO ROUTING PLAN

SHEET NUMBER



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Р	PROJECT NO.:		21-5084		
	DRAWN BY:		J. MALLISON		
PROJ	PROJECT MANAGE		D. REVELS		
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TOGETHER PLANNING A BETTER TOMORROW

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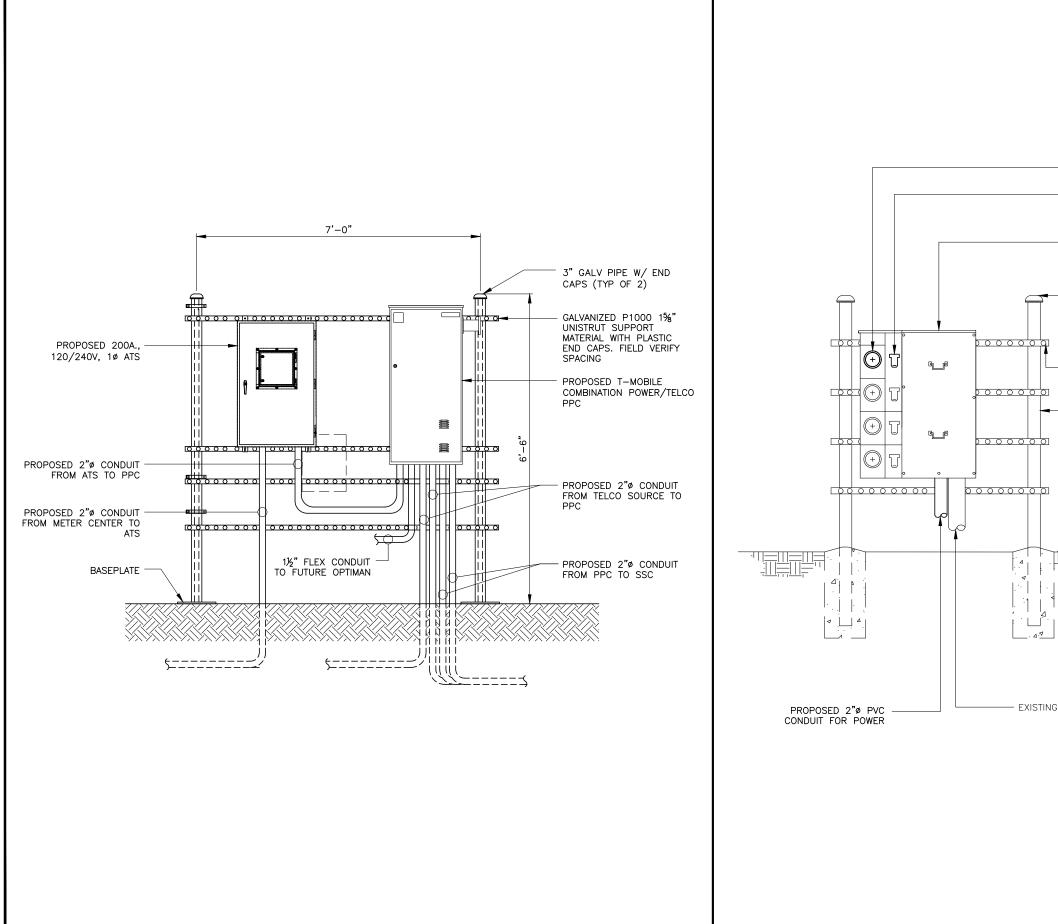
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T-MOBILE POWER/TELCO ROUTING PLAN

SHEET NUMBER



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	PROJECT NO.:			21-5084	
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	PROJECT MANAGER:		ER:	D. REVELS	
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DESCRIPTION

REV DATE

PROPOSED T-MOBILE 200A UTILITY METER

PROPOSED T-MOBILE 200A., 120/240V, 1ø SERVICE

EXISTING PIPE CAP (TYP.)

EXISTING 600A, 120/240V 4-GANG

BRÉAKER

METER CENTER

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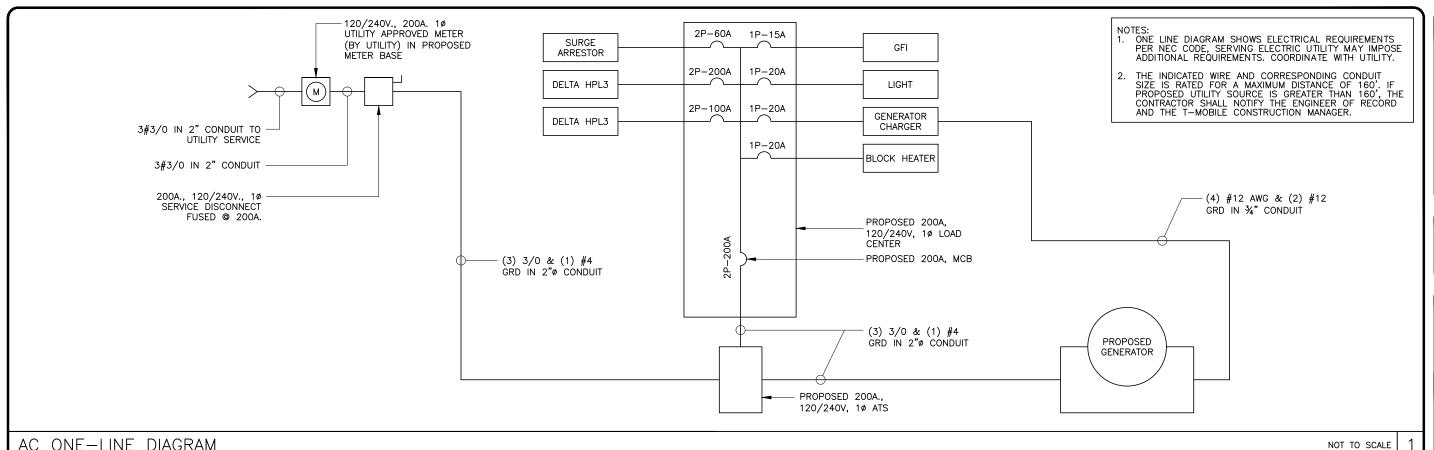
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DIAGRAMS

SHEET NUMBER

EXISTING UNISTRUT EXISTING 3"Ø SCH. 40 GALV. STEEL POST EXISTING ELECTRICAL SERVICE CONDUIT

NTS 2



PANEL NAME: T-MOBILE PANEL RATING 200 AMPS PHASE 200 MCB RATING 200 AMP LOCATION: H-FRAME 120/240 VOLTS WIRE 3 MAIN LUG ONLY 65K AIC CKT WIRE POLE AMP KVA GND COND COND GND DESCRIPTION WIRE DESCRIPTION POLE NO. AB AB NO. #12 15/1 0.18 GFI 0 #12 2 60/2 SURGE ARRESTOR (1) (1) 3 3/4" #12 #12 20/1 1.0 LIGHTS 1 & 2 \* 0 . 4 #12 20/1 0.7 **BLOCK HEATER** 6 5 #12 11.5 3/4" **GEN CHARGER** #3/0 #12 #12 20/1 0.74 8 SITE SUPPORT CABINET 200/2 2" 9 & (1) SPACE 10 11.5 11 SPACE 12 13 4.8 SPACE 14 T-MOBILE SITE SUPPORT CABINET 100/2 (3) #1 (1) #6 2" 15 2 4.8 17410 SPACE 16 -17 SPACE SPACE 18 19 SPACE SPACE 20 21 SPACE SPACE 22 23 SPACE SPACE 24 SUB TOTAL KVA (CONT) SUB TOTAL KVA (CONT) 0 0 0 0 SUB TOTAL KVA (NON-CONT) 0.92 0.74 SUB TOTAL KVA (NON-CONT) 16.3 16.3 TOTAL KVA 34.3 142.8 TOTAL AMPS NON-CONT + 125% CONT. EXISTING

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ı	PROJECT NO.: DRAWN BY:		:	21-5084		
ı				J. MALLISON		
ı	PROJECT MANAGER: CHECKED BY:			D. REVELS		
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ONE-LINE DIAGRAM &: PANEL SCHEDULE

SHEET NUMBER


E6

PANEL SCHEDULE

PREWIRED FROM MANUFACTURER

SITE ID PLATE (PROPOSED METER & PPC)

SYM	TYPE	FROM	ТО
1	2"ø CONDUIT W (2) #3/0 & (1) #6 & (1) #4 GROUND	AC PANEL	HPL3 SSC
2	(2)-1½"ø CONDUIT W/ TELCO CABLE	TELCO ENC.	HPL3 SSC
3	1½"ø CONDUIT W/ DC CONDUCTORS	HPL3 SSC	BATTERY CABINET
4	1"Ø CONDUIT W/ (15) PAIR ALARM CABLE	BATTERY CABINET	HPL3 SSC
5	1"Ø CONDUIT W/ (15) PAIR ALARM CABLE	BATTERY CABINET	TELCO ENC.
6	FIBER OPTIC CABLE	BATTERY CABINET	2.0 J-BOX
7	HYBRID TRUNK CABLE	2.0 J-BOX	TOWER TOP
8	NOT USED	N/A	N/A
9	1½"ø CONDUIT W/ DC CONDUCTORS	HPL3 SSC	2.0 J-BOX
10	¾"ø CONDUIT W/ (2) #12 (1) #12 GROUND	AC PANEL	TECH LIGHT
(11)	2"ø PVC CONDUIT FOR POWER	GENERATOR	ATS
(12)	3/4"ø PVC CONDUIT FOR CAT6 ALARM WIRING	GENERATOR	BATTERY CABINET
(13)	3/4"ø PVC CONDUIT FOR ALARM & CONTROL WIRING	GENERATOR	ATS
14)	3/4"ø PVC CONDUIT W/ (4) #12 & (2) #12 GRD FOR BATTERY & BLOCK HEATER	GENERATOR	AC PANEL
(15)	2"ø PVC CONDUIT FOR POWER	ATS	AC PANEL
16	2"ø PVC CONDUIT FOR POWER	SOURCE	ATS

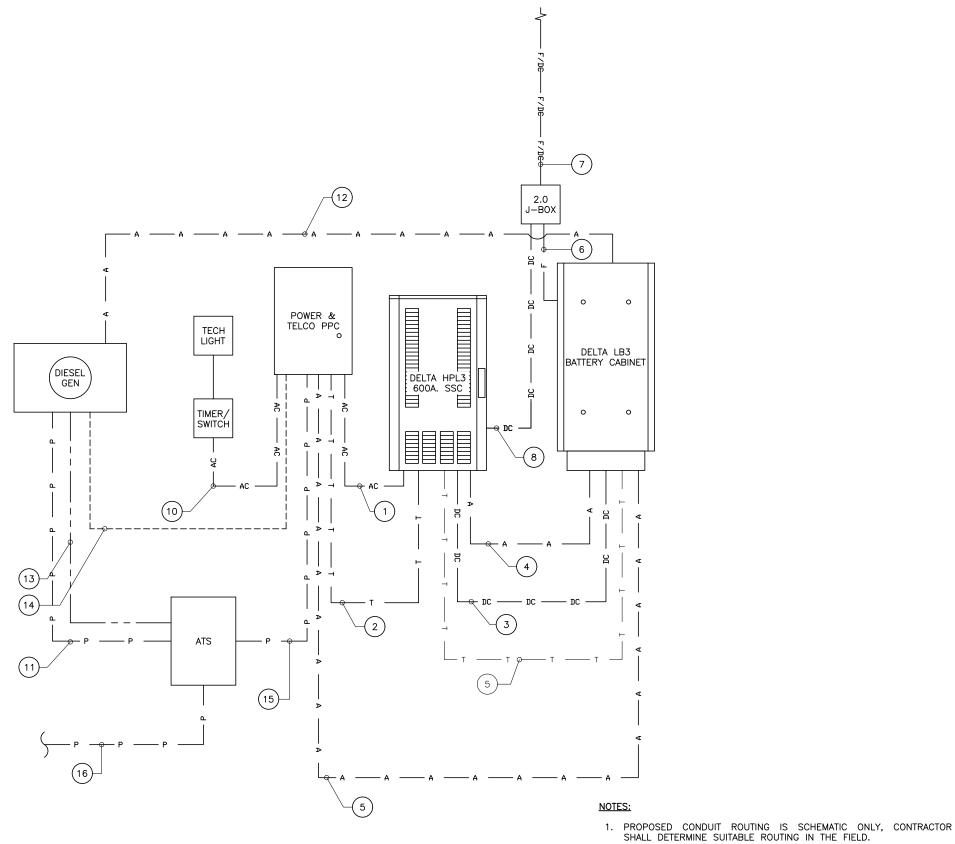

TO TOWER

A 03/25/21 PRELIM PLANS
B 04/06/21 REVISED PER COMMENTS
0 04/06/21 FINAL PLANS ISSUED

PROJECT NO.: 21-5084

DRAWN BY: J. MALLISON

PROJECT MANAGER: D. REVELS

DESCRIPTION

REV DATE

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CERTIFICATE OF AUTHORIZATION 33693

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7025 A.C. SKINNER PARKWAY JACKSONVILLE, FLORIDA 32256

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JEREMY D. SHARIT PE FL LIC 75137

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1720 W US HIGHWAY 90 LAKE CITY, FLORIDA 32055 (COLUMBIA COUNTY)

SHEET NAME


CONDUIT ROUTING

PLAN

SHEET NUMBER

E7

2. PROPOSED CONDUIT SHALL BE GALVANIZED RIGID STEEL APART FROM PORTION ENTERING EQUIPMENT CABINET, WHICH SHALL BE FLEXIBLE LIQUID TIGHT CONDUIT.

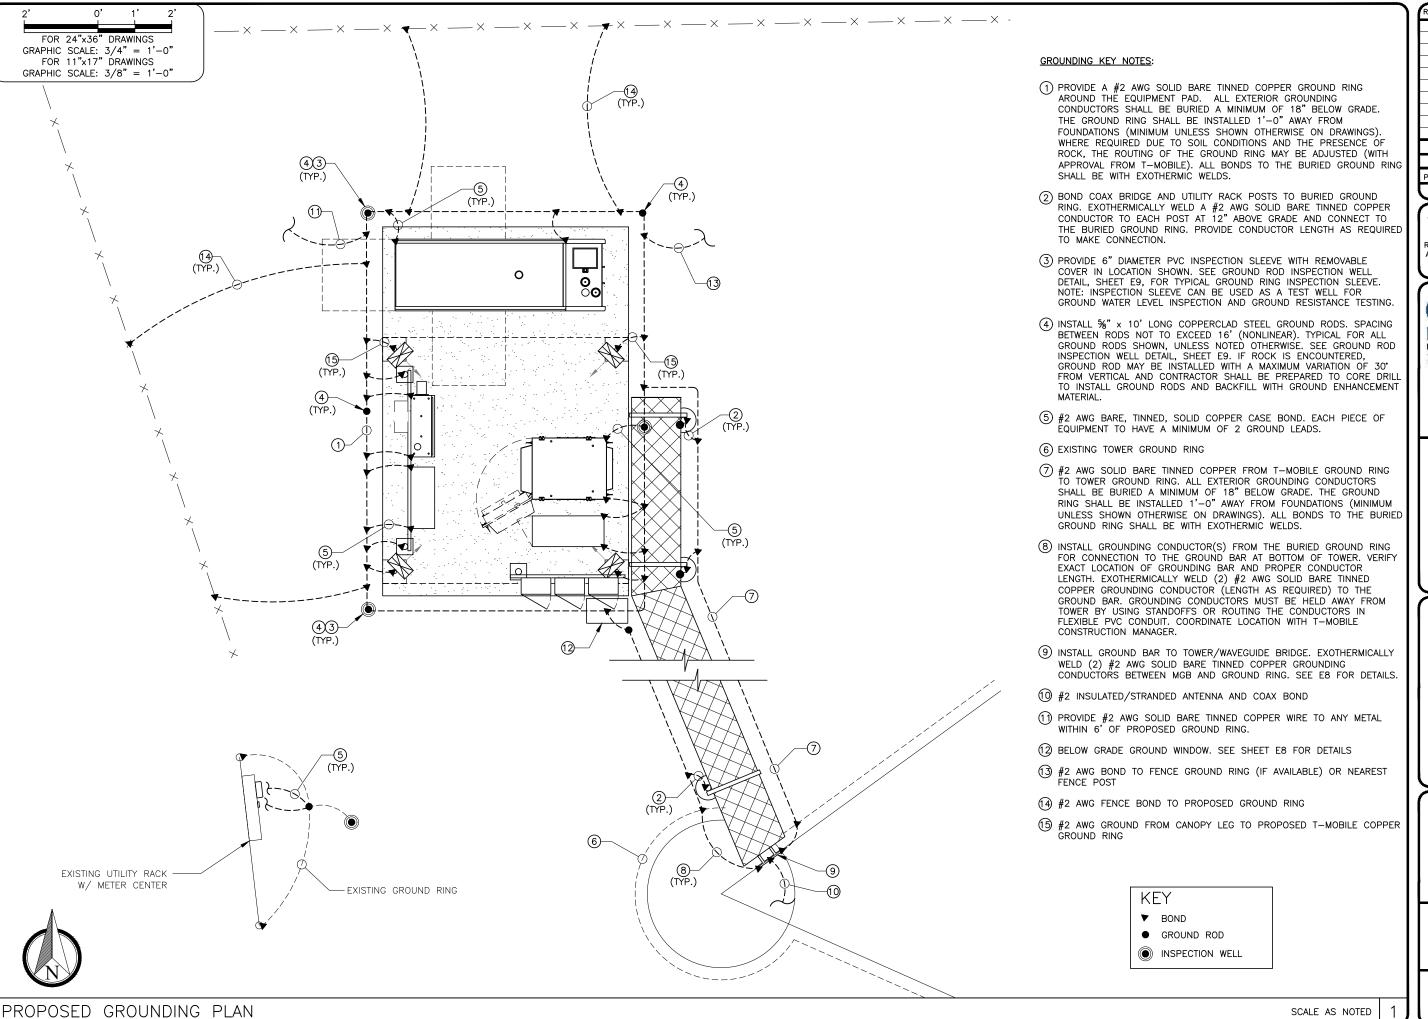

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CHECKED BY: D. REVELS

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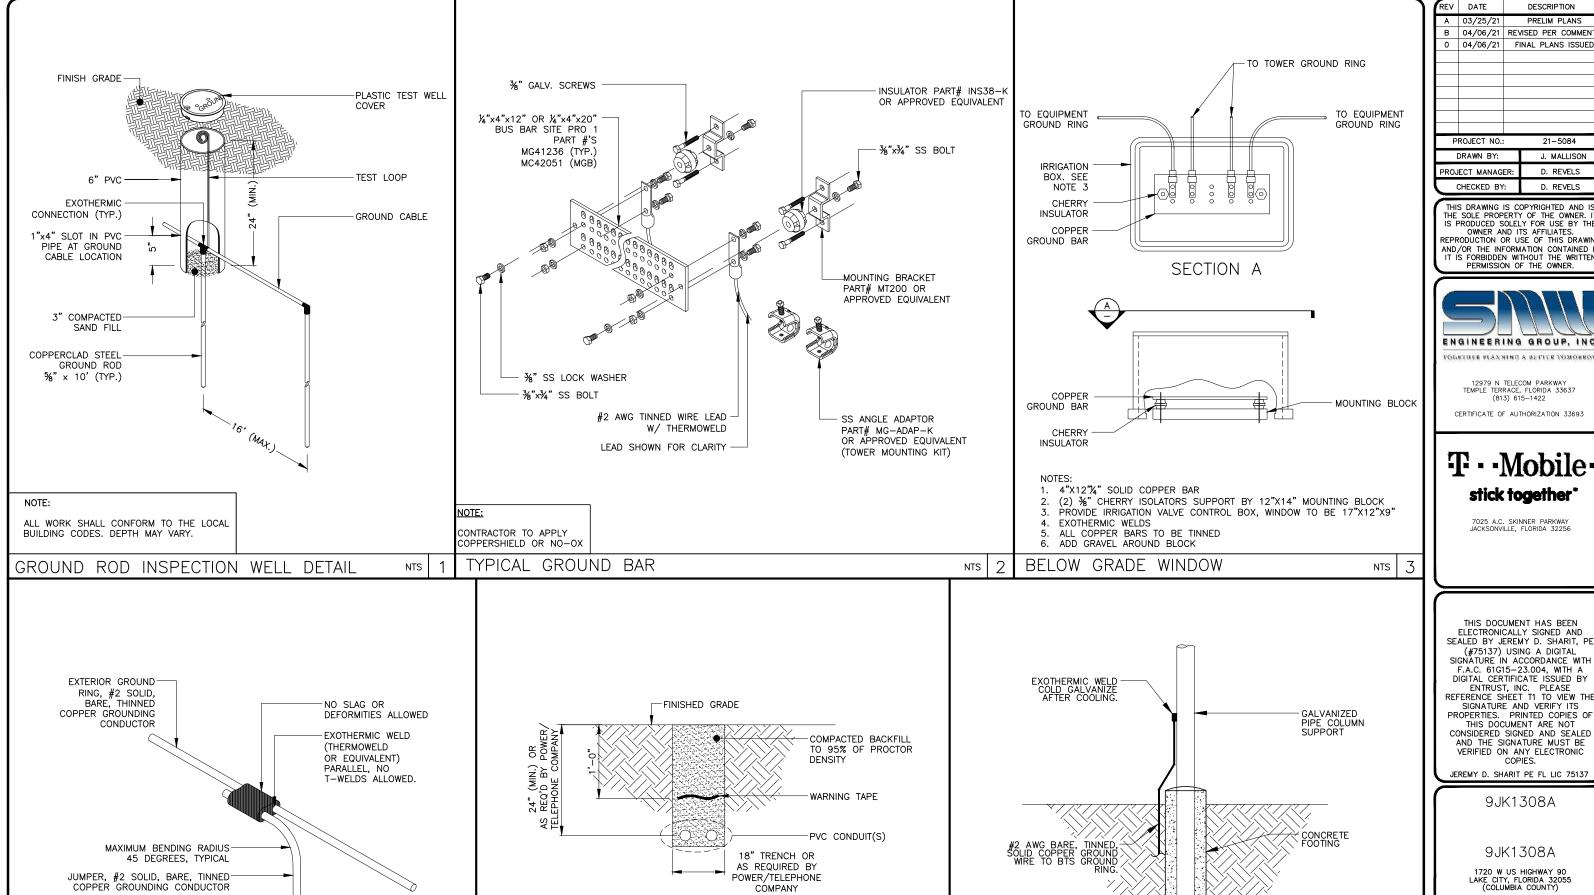
SHEET NAME

PROPOSED

GROUNDING PLAN

SHEET NUMBER

E8



UTILITY TRENCH DETAIL

EXOTHERMIC WELD DETAIL

FENCE POST SIMILAR

NTS

WAVEGUIDE POST BONDING DETAIL

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SHEET NAME GROUNDING

**DETAILS** SHEET NUMBER

E9

6

NTS