

AMERICAN TOWER®

SITE ADDRESS: 338 SW LENOX GLEN **VERIZON SITE NUMBER:477708** ATC SITE NAME: FT WHITE WEST FL VERIZON SITE NAME: FT WHITE WEST ATC SITE NUMBER: 282213 FORT WHITE, FL 32038-0001

APPROVALS

THE FOLLOWING PARTIES HEREBY APPROVE AND ACCEPT THESE DOCUMENTS & AUTHORIZE THE SUBCONTRACTOR TO PROCEED WITH CONSTRUCTION AS DESCRIBED HEREIN. ALL CONSTRUCTION DOCUMENTS ARE SUBJECT TO REVIEW BY THE LOCAL BUILDING DEPARTMENT & ANY CHANGES OR MODIFICATIONS THEY MAY IMPOSE


APE	APPROVAL:	SIGNATURE:	DATE:
PRO	PROJECT MANAGER:		
SITIS	SITE ACQUISITION:		
CO	CONSTRUCTION MANAGER:		
SITIS	SITE OWNER:		
	RF ENGINEER		
N	DEVELOPMENT MANAGER		
ERIZO	CONSTRUCTION MANAGER		
V	OPS MANAGER		
	PROJECT MANAGER		

ANTENNA AMENDMENT DRAWINGS VERIZON

Know what's below.	POWER COMPANY: PROGRESS ENERGY OF FL PHONE: (877) 372-8477 TELEPHONE COMPANY: UNKNOWN PHONE: N/A	UTILITY COMPANIES							BASIC WIND SPEED: 120 MPH (3-SECOND GUST)	ANSITIA-222-H BENEFIT ON FLORIDA FIRE PREVENTION CODE (NFPA 70)		TO BE CONSTRUED TO PERMIT WORK NOT CONFORMING TO THESE CODES.	FOLLOWING CODES AS ADOPTED BY THE LOCAL GOVERNMENT AUTHORITIES. NOTHING IN THESE PLANS IS	ALL WORK SHALL BE PERFORMED AND MATERIALS INSTALLED IN ACCORDANCE WITH THE CURRENT EDITIONS OF THE	COMPLIANCE CODE
IWG TLA TELECOM LLC 338 SW LENOX GLEN FORT WHITE - FL - 32038	JOHN M. BANKS 604 FOX GLEN BARRINGTON, IL 60010 PROPERTY OWNER:	WOBURN, MA 01801 ARCHITECT:	TOWER OWNER: AMERICAN TOWER 10 PRESIDENTIAL WAY	PROJECT TEAM				GROUND ELEVATION: 61' AMSL	LONGITUDE: -82.75315979	LATITUDE: 29.95360396	GEOGRAPHIC COORDINATES:	COUNTY: COLUMBIA	SOBT WILITE EL 32038 0001	SITE ADDRESS:	PROJECT SUMMARY
TAKE 1-75 TO EXIT 399 AND TRAVEL WEST ON 441/HWY27 TO SW JUNCTION RD AND MAKE A RIGHT ONTO SW JUNCTION RD TO SW LENOX GLEN AND MAKE A LEFT ONTO LENOX GLEN TO ACCESS AT BACK OF DIRT ROAD	REVIEW UNDER 47 U.S.C. § 1455(A) AS A MODIFICATION OF AN EXISTING WIRELESS TOWER THAT INVOLVES THE COLLOCATION, REMOVAL, AND/OR REPLACEMENT OF TRANSMISSION EQUIPMENT THAT IS NOT A SUBSTANTIAL CHANGE UNDER CFR § 1.61000 (B)(7).	5. HANDICAP ACCESS IS NOT REQUIRED. 6. THE PROJECT DEPICTED IN THESE PLANS QUALIFIES AS AN ELIGIBLE FACILITIES REQUEST ENTITLED TO EXPEDITED	MONTH FOR ROUTINE INSPECTION AND MAINTENANCE. 3. THE PROJECT WILL NOT RESULT IN ANY SIGNIFICANT LAND DISTURBANCE OR EFFECT OF STORM WATER DRAINAGE. 4. NO SANITARY SEWER, POTABLE WATER OR TRASH DISPOSAL IS REQUIRED.	THE FACILITY IS UNMANNED. A TECHNICIAN WILL VISIT THE SITE APPROXIMATELY ONCE A	PROJECT NOTES		8		The second	Croppe 10 (Senior Inc.)	EXISTING (6) ANTENNA(s), (6) RRH(s), (1) OVP AND (1) 1-1/4" HYBRID CARLE TO REMAIN	INSTALL (3) ANTENNA(s), (1) OVP AND (1) 1-5/8" HYBRID CABLE	REMOVE (1) OVP(s) AND (1) 1-1/4" HYBRID CABLE	THE PROPOSED PROJECT INCLUDES MODIFYING GROUND BASED AND TOWER MOUNTED EQUIPMENT AS INDICATED PER BELOW:	PROJECT DESCRIPTION
						R-601	E-501	C-501	C-401	C-201	C-101	G-002	G-001	SHEET NO:	
	EXA	a Compliance	OLUMB TO	Received	B ALIVE	SUPPLEMENTAL	GROUNDING DETAILS 0	CONSTRUCTION DETAILS 0	ANTENNA INFORMATION & SCHEDULE 0	TOWER ELEVATION 0	DETAILED SITE PLAN 0	GENERAL NOTES 0	TITLE SHEET 0	DESCRIPTION: REV:	SHEET INDEX
	EXAMINE	Ince N	OP ANTHA9	ived	JUNOW!		07/12/21	07/12/21	07/12/21	07/12/21	07/12/21	07/12/21	07/12/21	DATE:	
							MN	1 MN	MN t	1 MN	1 MN	1 MN	1 MN	BY:	
														ñ.	

Know what's below.

Call before you dig.

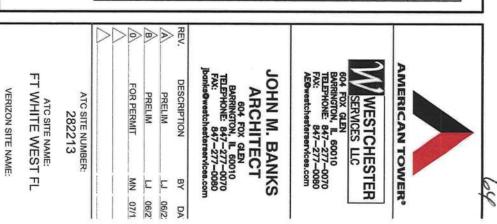

DA

SRED ARC T VVIII...
SITE ADDRESS:
338 SW LENOX GLEN
FORT WHITE EL 32038-0001 AR91251 182 NX.

FT WHITE WEST

477708	CUSTOMER #:
FT WHITE WEST	CUSTOMER ID:
13686628_D1	ATC JOB NO:
06/27/21	DATE DRAWN:

SHEET NUMBER: G-001

TITLE SHEET

REVISI

GENERAL CONSTRUCTION NOTES:

- OWNER FURNISHED MATERIALS, VERIZON "THE COMPANY" WILL PROVIDE AND THE CONTRACTOR WILL INSTALL
- BTS EQUIPMENT FRAME (PLATFORM) AND ICEBRIDGE SHELTER (GROUND BUILD/CO-LOCATE ONLY) AC/TELCO INTERFACE BOX (PPC)
 ICE BRIDGE (CABLE TRAY WITH COVER) (GROUND BUILD/CO-LOCATE ONLY, GC
 TO FURNISH AND INSTALL FOR ROOFTOP INSTALLATION)

- TOWER LIGHTING
 GENERATORS & LIQUID PROPANE TANK
 GENERATORS & LIQUID PROPANE TANK
 ANTENNA STANDARD BRACKETS, FRAMES AND PIPES FOR MOUNTING
 ANTENNAS (INSTALLED BY OTHERS)
 TRANSMISSION LINE
 TRANSMISSION LINE JUMPERS TRANSMISSION LINE CONNECTORS WITH WEATHERPROOFING KITS TRANSMISSION LINE GROUND KITS
- D Y X L Y P L Y D Y W D
- 28.

 THE CONTRACTOR IS RESPONSIBLE TO PROVIDE ALL OTHER MATERIALS FOR THE COMPRETE INSTALLATION OF THE SITE INCLIDING, BUT NOT LIMITED TO, SUCH MATERIALS AS FENCING, STRUCTURAL STEEL SUPPORTING SUB-FRAME FOR PLATFORM, ROOFING LABOR AND MATERIALS, GROUNDING RINGS, GROUNDING WIRES, COPPER-CLAD OR XIT CHEMICAL, GROUND RODIS), BUSS BARS, TRANSFORMERS AND DISCONNECT SWITCHES WHERE A PPULCABLE, TEMPORARY ELECTRICAL POWER, CONDUIT, LANDSCAPING COMPOUND STONE, CRANES, CORE DRILLING, SLEEPERS AND RUBBER MATTING, REBAR, CONCRETE CARSSONS, PAGS ANDIORA AUGER MOUNTS, MISCELLANGUS FASTENERS, CABLE TRAYS, MON-STAUNDAD ANTENNA FRAMES AND ALL OTHER MATERIAL AND LABOR REQUIRED TO COMPLETE THE JOB ACCORDING TO THE DRAWINGS AND SPECIFICATIONS, IT IS THE POSITION OF VERZION TO APPLY FOR PERMITTING AND CONTRACTOR RESPONSIBLE FOR PICKUP AND PAYMENT OF REQUIRED PERMITS.
- ALL WORK SHALL CONFORM TO ALL CURRENT APPLICABLE FEDERAL, STATE, AND LOCAL CODES, INCLUDING ANSI/EI/A/TIA-222, AND COMPLY WITH ATC CONSTRUCTION SPECIFICATIONS.
- CONTRACTOR SHALL CONTACT LOCAL 811 FOR IDENTIFICATION OF UNDERGROUND UTILITIES PRIOR TO START OF CONSTRUCTION.
- CONTRACTOR SHALL BE RESPONSIBLE FOR COORDINATING ALL REQUIRED INSPECTIONS.
- ALL DIMENSIONS TO, OF, AND ON EXISTING BUILDINGS, DRAINAGE STRUCTURES, AND SITE IMPROVEMENTS SHALL BE VERIFIED IN FIELD BY CONTRACTOR WITH ALL DISCREPANCIES REPORTED TO THE ENGINEER.
- DO NOT CHANGE SIZE OR SPACING OF STRUCTURAL ELEMENTS.
- DETAILS SHOWN ARE TYPICAL; SIMILAR DETAILS APPLY TO SIMILAR CONDITIONS UNLESS OTHERWISE NOTED.

THESE DRAWINGS DO NOT INCLUDE NECESSARY COMPONENTS FOR CONSTRUCTION SAFETY WHICH SHALL BE THE SOLE RESPONSIBILITY OF THE CONTRACTOR.

- 10.
- CONTRACTOR SHALL BRACE STRUCTURES UNTIL ALL STRUCTURAL ELEMENTS NEEDED FOR STABILITY ARE INSTALLED. THESE ELEMENTS ARE AS FOLLOWS: LATERAL BRACING, ANCHOR BOLTS, ETC.
- # CONTRACTOR SHALL DETERMINE EXACT LOCATION OF EXISTING UTILITIES, GROUNDS DRAINS, DRAIN PIPES, VENTS, ETC. BEFORE COMMENCING WORK.
- 12. INCORRECTLY FABRICATED, DAMAGED, OR OTHERWISE MISFITTING OR NONCONFORMING MATERIALS OR CONDITIONS SHALL BE REPORTED TO THE VERIZON REP PRIOR TO REMEDIAL ACTION SHALL REQUIRE WRITTEN APPROVAL BY THE VERIZON REP PRIOR TO PROCEEDING.
- 13. EACH CONTRACTOR SHALL COOPERATE WITH THE VERIZON REP, AND COORDINATE HIS WORK WITH THE WORK OF OTHERS.
- 4 CONTRACTOR SHALL REPAIR ANY DAMAGE CAUSED BY CONSTRUCTION OF THIS PROJECT TO MATCH EXISTING PRE-CONSTRUCTION CONDITIONS TO THE SATISFACTION OF THE VERIZON CONSTRUCTION MANAGER.
- 15. ALL CABLE/CONDUIT ENTRY/EXIT PORTS SHALL BE WEATHERPROOFED DURING INSTALLATION USING A SILICONE SEALANT.
- 6. WHERE EXISTING CONDITIONS DO NOT MATCH THOSE SHOWN IN THIS PLAN SET, CONTRACTOR SHALL NOTIFY THE VERIZON REP AND ENGINEER OF RECORD IMMEDIATELY.
- 17. CONTRACTOR SHALL ENSURE ALL SUBCONTRACTORS ARE PROVIDED WITH A COMPLETE AND CURRENT SET OF DRAWINGS AND SPECIFICATIONS FOR THIS PROJECT.
- 8 CONTRACTOR SHALL REMOVE ALL RUBBISH AND DEBRIS FROM THE SITE AT THE END OF EACH DAY.
- 19.
- CONTRACTOR SHALL COORDINATE WORK SCHEDULE WITH AMERICAN TOWER CORPORATION (ATC) AND TAKE PRECAUTIONS TO MINIMIZE IMPACT AND DISRUPTION OF OTHER OCCUPANTS OF THE FACILITY.
- 20. CONTRACTOR SHALL FURNISH VERIZON AND AMERICAN TOWER CORPORATION (ATC) WITH A PDF MARKED UP AS-BUILT SET OF DRAWINGS UPON COMPLETION OF WORK.
- 21. PRIOR TO SUBMISSION OF BID, CONTRACTOR SHALL COORDINATE WITH VERIZON REP TO DETERMINE WHAT, IF ANY, ITEMS WILL BE PROVIDED, ALL ITEMS NOT PROVIDED SHALL BE PROVIDED AND INSTALLED BY THE CONTRACTOR, CONTRACTOR WILL INSTALL ALL ITEMS PROVIDED.

- 22.
- 23. CONTRACTOR SHALL INSTALL ALL SITE SIGNAGE IN ACCORDANCE WITH VERIZON SPECIFICATIONS AND REQUIREMENTS.
- 24. CONTRACTOR SHALL SUBMIT ALL SHOP DRAWINGS APPROVAL PRIOR TO FABRICATION. TO VERIZON FOR REVIEW AND

AMERICAN TOWER®

WESTCHESTER SERVICES LLC

JOHN M. BANKS

ARCHITECT

604 FOX GLEN
BARRINGTON, IL 60010
RELEPHONE: 847-277-0070
3X: 847-277-0080
sinks@westchesterservices.com

DESCRIPTION

PRELIM

FOR PERMIT

PELIM

LJ 06/2 MN 07/1

LJ 06/2:

DA:

BARRINGTON, IL 60010
TELEPHONE: 847-277-0070
FAX: 847-277-0080
AE@westchesterservices.com

- 25. ALL EQUIPMENT SHALL BE INSTALLED ACCORDING TO MANUFACTURER'S SPECIFICATIONS AND LOCATED ACCORDING TO VERIZON SPECIFICATIONS, AND AS SHOWN IN THESE PLANS.
- 26. THE CONTRACTOR SHALL SUPERVISE AND DIRECT THE PROJECT DESCRIBED HEREIN. THE CONTRACTOR SHALL BE SOLELY RESPONSIBLE FOR ALL THE CONSTRUCTION MEANS, METHODS, TECHNIQUES, SEQUENCES AND PROCEDURES AND FOR COORDINATING ALL PORTIONS OF THE WORK UNDER THE CONTRACT.
- 27. CONTRACTOR SHALL NOTIFY VERIZON REP A MINIMUM OF 48 HOURS IN ADVANCE OF POURING CONCRETE OR BACKFILLING ANY UNDERGROUND UTILITIES, FOUNDATIONS OR SEALING ANY WALL, FLOOR OR ROOF PENETRATIONS FOR ENGINEERING REVIEW AND APPROVAL.
- 28. CONTRACTOR SHALL BE RESPONSIBLE FOR SITE SAFETY INCLUDING COMPLIANCE WITH ALL APPLICABLE OSHA STANDARDS AND RECOMMENDATIONS AND SHALL PROVIDE ALL NECESSARY SAFETY DEVICES INCLUDING PPE AND PPM AND CONSTRUCTION DEVICES SUCH AS WELDING AND FIRE PREVENTION, TEMPORARY SHORING, SCAFFOLDING, TRENCH BOXES/SLOPING, BARRIERS, ETC.
- 29.
- 30. ALL WORK SHALL BE INSTALLED IN A FIRST CLASS, NEAT AND WORKMANLIKE MANNER BY MECHANICS SKILLED IN THE TRADE INVOLVED. THE QUALITY OF WORKMANSHIP SHALL BE SUBJECT TO THE APPROVAL OF THE VERZON REP, ANY WORK FOUND BY THE VERZON REP TO BE OF INFERIOR QUALITY AND/OR WORKMANSHIP SHALL BE REPLACED AND/OR REPORE AT CONTRACTOR EXPENSE UNTIL APPROVAL IS OBTAINED.
- 31. IN ORDER TO ESTABLISH STANDARDS OF QUALITY AND PERFORMANCE, ALL TYPES OF MATERIALS LISTED HEREINAFIER BY MANUFACTURERS NAMES ANDIOR MANUFACTURERS CATALOG NUMBER SHALL BE PROVIDED BY THESE MANUFACTURERS
- 32. VERIZON FURNISHED EQUIPMENT SHALL BE PICKED-UP AT THE VERIZON WAREHOUSE, NO LATER THAW 48HR AFTER BEING NOTIFIED INSURED, STORED, UNICARE, PROTECTED AND INSTALLED BY THE CONTRACTOR WITH ALL APPURTENANCES REQUIRED TO PLACE THE EQUIPMENT IN OPERATION, READY FOR USE, THE CONTRACTOR SHALL BE RESPONSIBLE FOR THE EQUIPMENT AFTER PICKING IT UP.
- 33.

ANTENNA INSTALLATION NOTES: SPECIAL CONSTRUCTION

.

- P ANTENNA AND COAXIAL CABLES ARE FURNISHED BY VERIZON UNDER A SEPARATE CONTRACT. THE CONTRACTOR SHALL ASSIST ANTENNA INSTALLATION CONTRACTOR IN TERMS OD COORDINATION AND SITE ACCESS. ERECTION SUBCONTRACTOR SHALL BE RESPONSIBLE FOR THE PROTECTION OF PERSONNEL AND
- . INSTALL ANTENNA AS INDICATE ON DRAWINGS AND VERIZON SPECIFICATIONS.
- 0 INSTALL GALVANIZED STEEL ANTENNA MOUNTS AS INDICATED ON DRAWINGS
- m CONTRACTOR SHALL PROVIDE FOUR (4) SETS OF SWEEP TESTS USING ARRITZL-PACKARD 8713B RF SCALAR NETWORK ANALYZER. SUBMIT FREQUENCY DOMAIN REFLECTOMETER/DRI TESTS REGULTS TO THE PROJECT MANAGER. SWEEP TESTS SHALL BE AS PER ATTACHED RFS "MINIMUM FIELD TESTING SERVICE PROFAMIENDED FOR ANTENNA AND HELLAX COLAXIAL CABLE SYSTEMS" DATED 103/593, TIESTING SHALL BE PERFORMED BY AN INDEPENDENT TESTING SERVICE AND BE BOUND AND SUBMITTED WITHIN ONE WEEK OF WORK COMPLETION.
- Ţ INSTALL COAXIAL CABLES AND TERMINATING BETWEEN ANTENNAS AND EQUIPMENT PER MANUFACTURER'S RECOMMENDATIONS, WEATHERPROOF ALL CONNECTIONS BETWEEN THE ANTENNA AND EQUIPMENT PER MANUFACTURER'S REQUIREMENTS, TERMINATE ALL COAXIAL CABLE THREE (3) FEET IN EXCESS OF ENTRY PORT LOCATION UNLESS OTHERWISE STATED.
- 0 ANTENNA AND COAXIAL CABLE GROUNDING:
- ALL EXTERIOR #6 GREED GROUND WIRE "DAISY CHAIN" CONNECTIONS ARE TO BE WEATHER SEALED WITH RFS CONNECTORS/SPLICE WEATHERPROOFING KIT #221213 OR EQUAL.
- ALL COAXIAL CABLE GROUNDING KITS ARE TO BE INSTALLED ON STRAIGHT RUNS OF COAXIAL CABLE (NOT WITHIN BENDS)

PRIOR TO SUBMISSION OF BID. CONTRACTOR SHALL COORDINATE WITH VERIZON REP TO DETERMINE IF ANY PERMITS WILL BE OBTAINED BY CONTRACTOR. ALL REQUIRED PERMITS NOT OBTAINED BY VERIZON MUST BE OBTAINED, AND PAID FOR, BY THE CONTRACTOR.

- THE CONTRACTOR SHALL PROTECT AT HIS OWN EXPENSE, ALL EXISTING FACILITIES AND SUCH OF HIS NEW WORK (LIBLE TO INJURY DURING THE CONSTRUCTION PERIOD. ANY DAMAGE CAUSED BY NEGLECT ON THE PART OF THIS CONTRACTOR OR HIS REPRESENTATIVES, OR BY THE ELEMENTS DUE TO NEGLECT ON THE PART OF THIS CONTRACTOR OR HIS REPRESENTATIVES, ETHER TO THE EXISTING WORK, OR TO HIS WORK OR THE WORK OF ANY OTHER CONTRACTOR, SHALL BE REPAIRED AT HIS EXPENSE TO THE OWNER'S SATISFACTION.

- VERIZON OR HIS ARCHITECT/ENGINEER RESERVES THE RIGHT TO REJECT ANY EQUIPMENT OR MATERIALS WHICH, IN HIS OWN OPINION ARE NOT IN COMPCHANCE WITH THE CONTRACT DOCUMENTS, EITHER BEFORE OR AFTER INSTALLATION AND THE EQUIPMENT SALL BE REPACED WITH EQUIPMENT CONFORMING TO THE REQUIREMENTS OF THE CONTRACT DOCUMENTS BY THE CONTRACTOR AT NO COST TO VERIZON OR THEIR ARCHITECT/ENGINEER.

WORK INCLUDED:

- D. INSTALL FURNISHED GALVANIZED STEEL OR ALUMINUM WAVEGUIDE.

DATE DRAWN: 06/27/21
ATC JOB NO: 13886628_D1
CUSTOMER ID: FT WHITE WEST
CUSTOMER #: 477708

verizon

NOHOK:

OF FLOR

F FLO

ATC SITE NAME: FT WHITE WEST FL

ATC SITE NUMBER: 282213

FT WHITE WEST

VERIZON SITE NAME:

SITE ADDRESS: 338 SW LENOX GLEN

TERED ARCHITUTA

GENERAL NOTES


SHEET NUMBER: G-002


ALL DISCREPANCIES FROM WHAT IS SHOWN ON THESE CONSTRUCTION DRAWINGS SHALL BE COMMUNICATED TO ATC ENGINEERING IMMEDIATELY FOR CORRECTION OR RE-DESIGN. FAILURE TO COMMUNICATE DIRECTLY WITH ATC ENGINEERING OR ANY CHANGES FROM THE DESIGN CONDUCTED WITHOUT PRIOR APPROVAL FROM ATC ENGINEERING SHALL BE THE SOLE RESPONSIBILITY OF THE GENERAL CONTRACTOR.


REVISI

SITE PLAN NOTES:

- THIS SITE PLAN REPRESENTS THE BEST PRESENT KNOWLEDGE AVAILABLE TO THE ENGINEER AT THE TIME OF THIS DESIGN. THE CONTRACTOR SHALL VISIT THE SITE PRIOR TO CONSTRUCTION AND VERIFY ALL EXISTING CONDITIONS RELATED TO THE SCOPE OF WORK FOR THIS PROJECT.
- ICE BRIDGE, CABLE LADDER, COAX PORT, AND COAX CABLE ARE SHOWN FOR REFERENCE ONLY. CONTRACTOR SHALL CONFIRM THE EXACT LOCATION OF ALL PROPOSED AND EXISTING EQUIPMENT AND STRUCTURES DEPICTED ON THIS PLAN. BEFORE UTILIZING EXISTING CABLE SUPPORTS, COAX PORTS, INSTALLING NEW PORTS OR ANY OTHER EQUIPMENT, CONTRACTOR SHALL VERIFY ALL ASPECTS OF THE COMPONENTS MEET THE ATC SPECIFICATIONS.
- THIS PROJECT INCLUDES NO INSTALL OR MODIFICATION AT GRADE.

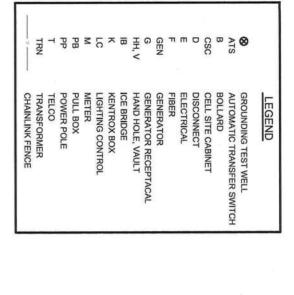

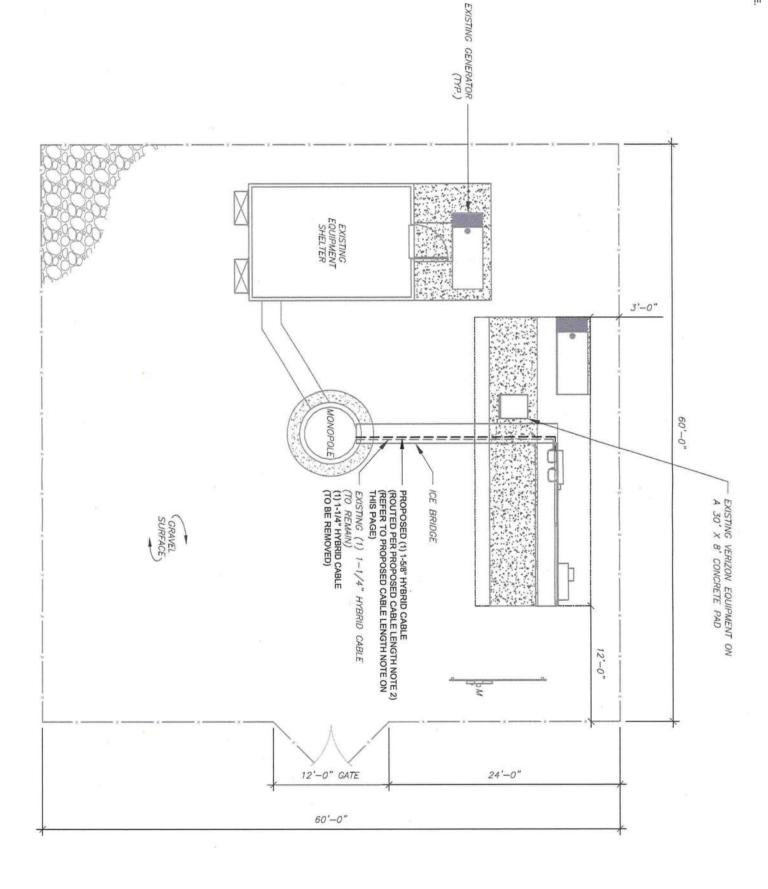

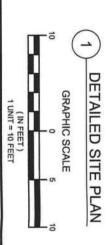

1. ESTIMATED LENGTH OF PROPOSED CABLE IS 225.
ESTIMATED LENGTH OF CABLE WAS PROVIDED BY CUSTOMER OR CALCULATED BY ADDING THE RAD CENTER AND THE DISTANCE FROM THE SHELTER ENTRY PLATE TO THE TOWER (ALONG THE ICE BRIDGE) AND A SAFETY FACTOR MEASUREMENT OF 15% (OF THE TWO PREVIOUS VALUES), CDS DEFER TO GREATEST CABLE LENGTH.

2. ROUTE PROPOSED CABLES ALONG SAME PATH AS EXISTING CABLES AND IN ACCORDANCE WITH STRUCTURAL ANALYSIS, IF ADEQUATE SPACE EXISTS, ROUTE CABLES THROUGH ENTRY PORT HOLE, UP INSIDE OF MONOPOLE, AND THROUGH EXIT PORT HOLE, IF ROUTING OUTSIDE THE MONOPOLE, ATTACH CABLES USING STAINLESS STEEL BANDING. ADEQUATELY SECURE CABLES USING ETHER APPROPRIATELY SIZED STAINLESS STEEL BRADING, OR MOINTING HARDWARF AND BRACKETS.

PROPOSED CABLE LENGTH:

AS SPECIFIED BY CABLE MANUFACTURER.





AMERICAN TOWER® WESTCHESTER SERVICES LLC

JOHN M. BANKS ARCHITECT 804 FOX GLEN BARRINGTON, IL 80010 TELEPHONE: 847-277-0000 FAX: 847-277-0000 Jonice@westchesterservices.com

NGTON, IL 60010 HONE: 847-277-0070 847-277-0080 estchesterservices.com

PRELIM LJ 06/22 PRELIM LJ 06/22 PRELIM LJ 06/27 PRELIM MN 07/1;		Ö	ATO SITE ALL IMPED	
M E E BY			, ,	
MN F F BA				
모드	07/1:	MN	FOR PERMIT	0
LA RB	06/27		PRELIM	B
ВУ	06/22		PRELIM	A
	DA.	ВҮ	DESCRIPTION	REV.

ATC SITE NUMBER: 282213

ATC SITE NAME: FT WHITE WEST FL

VERIZON SITE NAME: FT WHITE WEST

SITE ADDRESS: 338 SW LENOX GLEN DRI WHITE, EL 32038-0001


FRED ARCA OF FLOO AR91251

477708	CUSTOMER #:
FT WHITE WEST	CUSTOMER ID:
13686628_D1	ATC JOB NO:
06/27/21	DATE DRAWN:

DETAILED SITE PLAN

C-101

SHEET NUMBER: REVISI

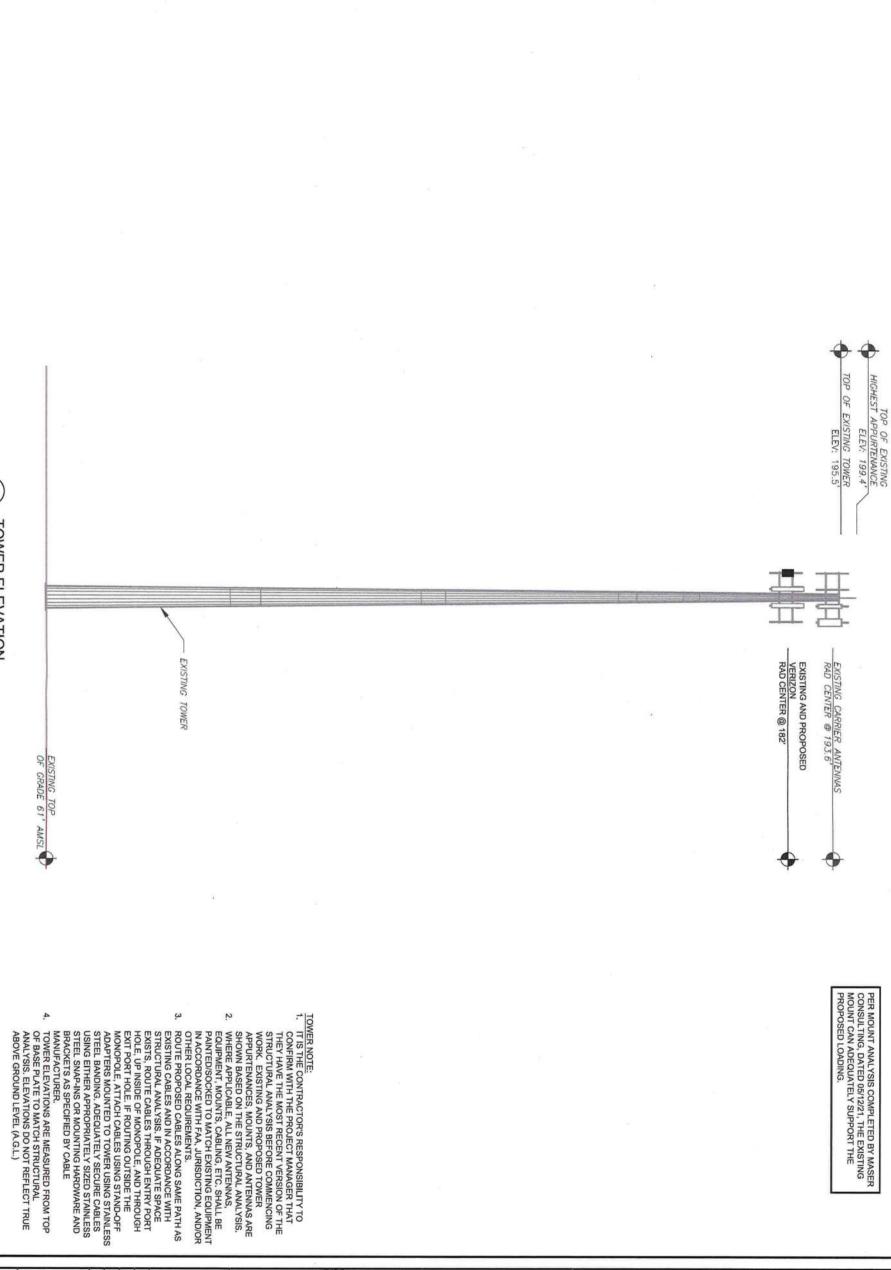

PER MOUNT ANALYSIS COMPLETED BY MASER CONSULTING, DATED 05/12/21, THE EXISTING MOUNT CAN ADEQUATELY SUPPORT THE PROPOSED LOADING.

D D REV.

FOR PERMIT

MN 07/1 LJ 06/2

PRELIM PRELIM

LJ 06/2

DESCRIPTION

BY

DA

ARCHITECT

804 FOX GLEN

804 FOX GLEN

804 FOX GLEN

807 - 277 - 0070

FAX:

847 - 277 - 0080

Jbanks@westchesterservices.com

JOHN M. BANKS

BARRINGTON, IL 60010
TELEPHONE: 847-277-0070
FAX: 847-277-0080
AEGwestchesterservices.com

WESTCHESTER
SERVICES LLC
FOX GLEN

AR91251 CAMED ARCTURED

JOHN M. BAA

CANE OF FLORIDA

SITE ADDR...
338 SW LENOX GLEN
FORT WHIFE 1-32038-0001

ATC SITE NAME: FT WHITE WEST FL

ATC SITE NUMBER: 282213

FT WHITE WEST

VERIZON SITE NAME:

TOWER ELEVATION
SCALE: N.T.S.


אוא פת דד	
A/AI.	W
08/77/30	
2	N
	0

TOWER ELEVATION	
477708	CUSTOMER #:
FT WHITE WEST	CUSTOMER ID:
13686628_D1	ATC JOB NO:
06/27/21	DATE DRAWN:

C-201 SHEET NUMBER:

REVISI

AMERICAN TOWER®

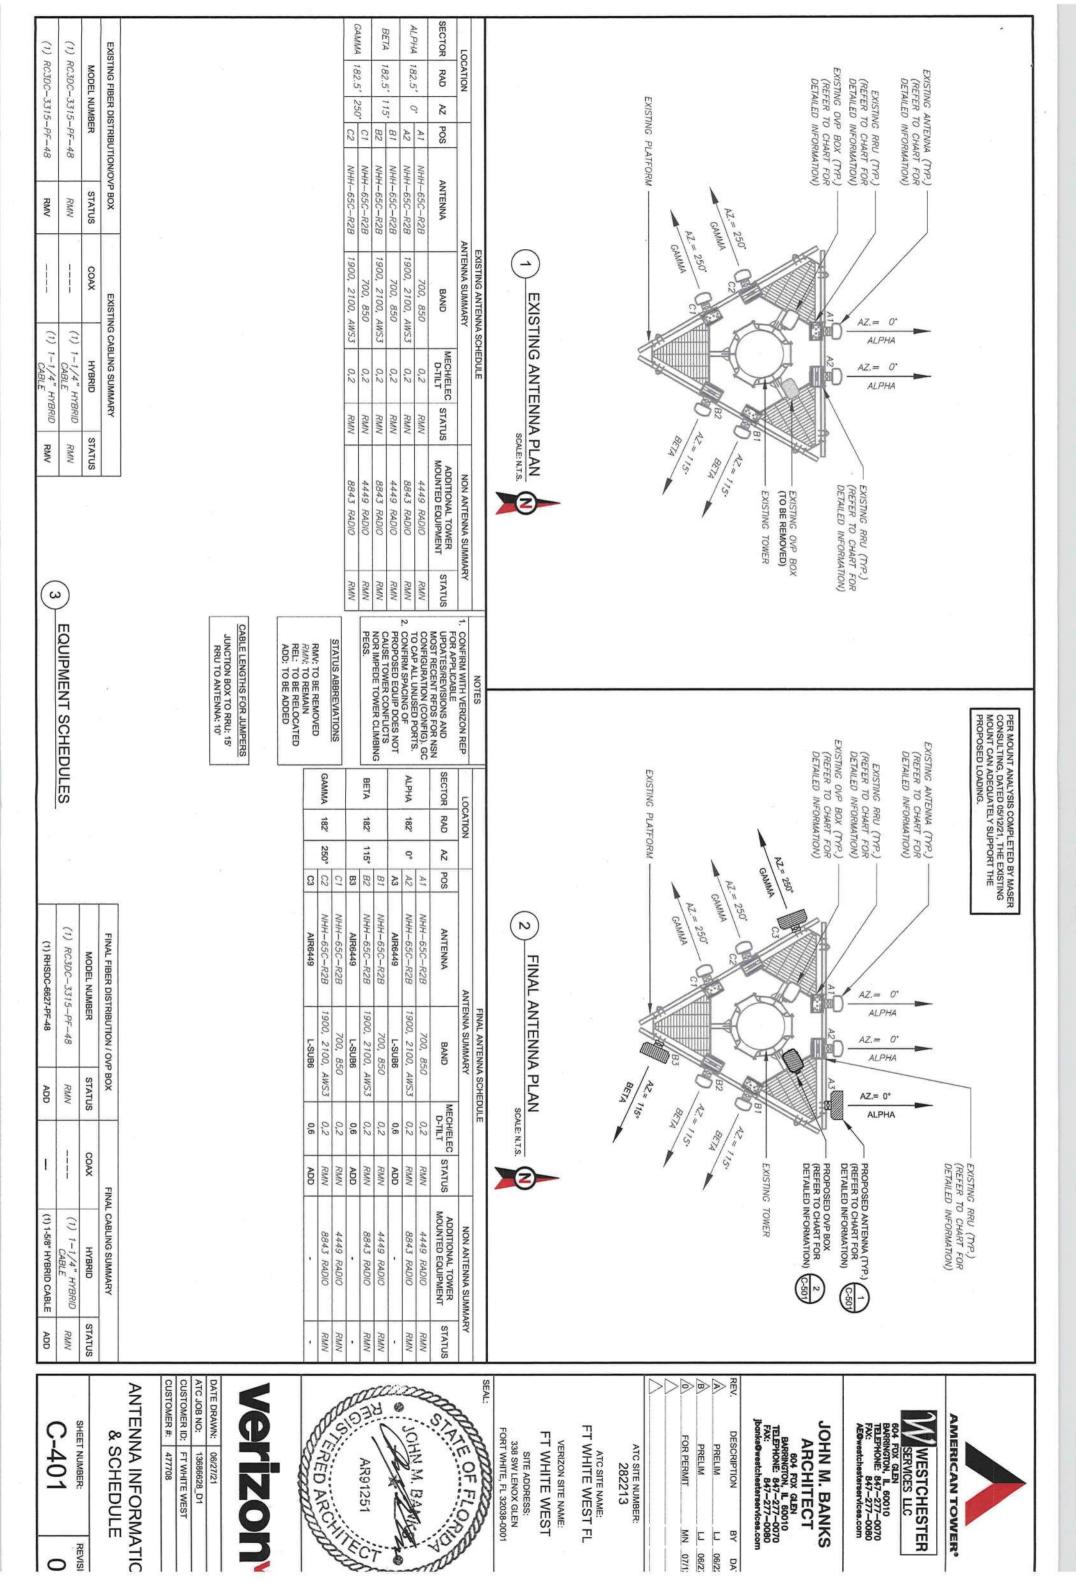


MN 07/1:


REVISI

ΥВ Ξ LJ 06/2

06/27 DA. PROPOSED OVP MOUNTING

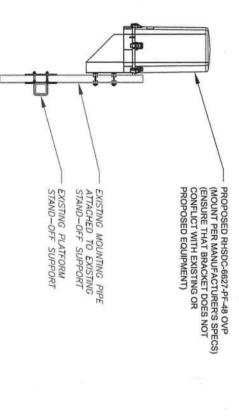

PROPOSED 5G ANTENNA MOUNTING DETAIL - TYPICAL SCALE: N.T.S.

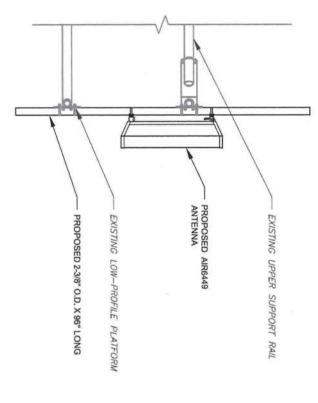

JOHN MBANL SITE ADDRESS: 338 SW LENOX GLEN

CUSTOMER ID: FT WHITE WEST CUSTOMER #: 477708

CONSTRUCTION

DETAILS

C-501 SHEET NUMBER:

REVISI

DATE DRAWN: 06/27/21 ATC JOB NO: 13686628_D1

FT WHITE WEST

VERIZON SITE NAME:

ATC SITE NAME: FT WHITE WEST FL

ATC SITE NUMBER: 282213


FOR PERMIT PRELIM PRELIM

DESCRIPTION MN 07/1; LJ 06/2% LJ 06/27 DA.

JOHN M. BANKS
ARCHITECT
604 FOX GLEN
BARRINGTON, IL. 60010
TELEPHONE: 847-277-0080
Jbanks@westchesterservices.com

BARRINGTON, IL 60010
TELEPHONE: 847-277-0070
FAX: 847-277-0080
AE@westchesterservices.com WESTCHESTER
SERVICES LLC

AMERICAN TOWER®

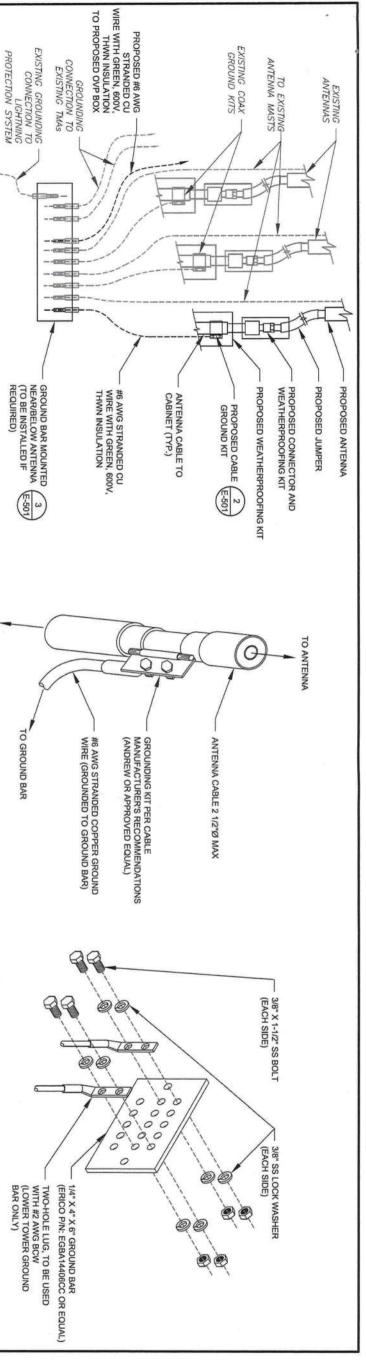

1. THIS DETAIL IS INTENDED TO SHOW THE GENERAL GROUNDING REQUIREMENTS. SLIGHT ADJUSTMENTS MAY BE REQUIRED BASED ON EXISTING SITE CONDITIONS. THE CONTRACTOR SHALL MAKE FIELD ADJUSTMENTS AS NEEDED AND INFORM THE CONSTRUCTION MANAGER OF ANY CONFLICTS.

2. SITE GROUNDING SHALL COMPLY WITH VERIZON GROUNDING STANDARDS, LATEST EDITION, AND COMPLY WITH VERIZON GROUNDING CHECKLIST, LATEST VERSION. WHEN NATIONAL AND LOCAL GROUNDING CODES ARE MORE STRINGENT THEY SHALL GOVERN. TYPICAL ANTENNA GROUNDING DIAGRAM
SCALE: N.T.S.

NOTES:

2

CABLE GROUND KIT CONNECTION DETAIL
SCALE: N.T.S.

GROUND KIT NOTES:

1. DO NOT INSTALL CABLE GROUND KIT AT A BEND AND ALWAYS DIRECT GROUND WIRE DOWN TO GROUND BAR.

2. CONTRACTOR SHALL PROVIDE WEATHERPROOFING KIT (ANDREW PART NUMBER 221213) AND INSTALL/TAPE PER MANUFACTURER'S SPECIFICATIONS.

TO EQUIPMENT


GROUND BAR NOTES:

- GROUND BAR KITS COME WITH ALL HARDWARE, NUTS, BOLTS, WASHERS, ETC. EXCEPT THE STRUCTURAL MOUNTING MEMBER(S).
- GROUND BAR TO BE BONDED DIRECTLY TO TOWER.

ATC SITE NAME: FT WHITE WEST FL

ATC SITE NUMBER: 282213

TOWER GROUND BAR DETAIL
SCALE: N.T.S.

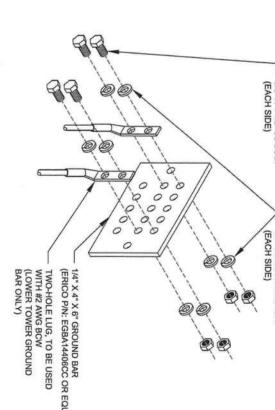

BARRINGTON, IL. 60010
TELEPHONE: 847-277-0070
FAX: 847-277-0080
Jbanks@westchesterservices.com

DESCRIPTION

FOR PERMIT

MN 07/1 LJ 06/2 LJ 06/2

PRELIM PRELIM JOHN M. BANKS

ARCHITECT

04 FOX GLEN
ARRINGTON, IL 60010
9 1 EPHONE: 847—277—0070
W: 847—277—0080
C@westchesterservices.com

verizon

JOHN M. BAN

AR91251

SITE ADDRESS: 338 SW LENOX GLEN FORT WHITE, FL 32038-0001

FT WHITE WEST

VERIZON SITE NAME:

OF FLORIS

A DESCRIPTION OF THE PERSON OF

DATE DRAWN:	06/27/21
ATC JOB NO:	13686628_D1
CUSTOMER ID:	FT WHITE WEST
CUSTOMER #:	477708

G	
R	
2	
Z	
\Box	
Z	
0	
H	
7	
\neq	
rn	

E-501 SHEET NUMBER: REVISI

AMERICAN TOWER® WESTCHESTER
SERVICES LLC

Antenna Mount Analysis Report and PMI Requirements

sources of Information:

SMART Tool Project # 10058040 Maser Consulting Project # 21944703A

May 12, 2021

May 12, 2021 Site ID: 477708-VZW / FT WHITE WEST Page | 2

The edjective of this report is to determine the capacity of the anterna support mount at the subject stating for the final wireless between this report is to determine over the supplicable codes and standards. Any modification issted indicated the configuration, por the applicable codes and standards. Any modification issted under Sources of Information was assumed completed and was included in this analysis. ins analysis is inclusive of the mount structure only and closs not abbress the structural capacity of the supporting fracture. This recurring farms was not, a hardyced as an acctor abstractment point for fail protection. All climbing children are required to have a fail protection plant completed by a competent person.

Analysis Criteria: Radio Frequency Data Sheet (RFDS) Verizon RFDS Site ID: 477708, dated May 4, 2021

Mount Mapping Tower Engineering Professionals, dated April 13, 2021 int Type

Codes and Standards:

Vind Speed (3-sec. Gust): Maintenance Live Load, Lv.: Maintenance Live Load, Lm.: 0.079

RISA-3D (V17)

47708-VZW-FT WHITE WEST FT WHITE WEST Vertzon Wereless 338 SW Lenox Gein FORT WHITE, Florida 32038 Columbia County 28 93(807)

FUZE ID # 16276846

Analysis Results
Platform: 92.9% Pass

"Contactor PM Requirements."
Included at the end of this MA report
Variable & Submitted via portal at https://pmi.vzwsmart.com.
Outractor - Please Review Specific Site PMI Requirements Upon Award
Requirements also Noved on Mount Modification Drawings
Requirements may also be Noted on A & E drawings

May 12, 2021 Site ID: 477708-VZW1 FT WHITE WEST Page 1 3

Mount Structural Analysis Report (1) 12:50-Ft Platform

May 12, 2021 Site ID: 477708-VZW / FT WHITE WEST Page | 4

All services are performed, results obtained, and recommendations made in accordance with generally accepted engineering principles and practices. Maser Consulting is not responsible for the conclusion, opinions, and recommendations made by others based on the information supplied.

Final Loading Configuration: The following equipment has been co

- Structural Steel Grades have been assumed as follows, if applicable analysis: unless otherwise noted in this
- Channel, Solid Round, Angle, Plate
 HSS (Rectangular)
 Pipe
 Threaded Rod
 Bots ASTM A36 (G: 36) ASTM 500 (G: 8-46) ASTM A53 (G: 8-35) F1554 (G: 36) ASTM A325

Added Status

Discrepancies between in field conditions and the assumptions listed above may invalid unless explicitly approved by Moser Consulting. Analysis Results:

Recommendation:

Standard Conditions:

1. All engineering services are performed on the basis that the information provided to Maser Consulting and used in this analysis is current and correct. The existing explorient loading has been applied all locations determined from the supplied counteration. Any pleasablor from the loading locations specified in this report of such as a commentation. Any pleasablor from the loading locations specified in the property of the supplied counterations. Any pleasablor from the loading locations specified in the property of the load of the lo

Mounts are assumed to have been properly fabricated, installed and maintained in good condition, twist free and plumb in accordance with its original design and manufacturer's specifications. Obvious safety and structural issuesideficiencies noticed at the fine of the mount mapping and reported in the Mount Mapping Report are assumed to be corrected and documented as part of the PMI process and are not considered in the mount analysis. The mount analysis and the mount mapping are not a condition assessment of the mount. Proper maintenance and condition assessments are still required post analysis.

The recent mount mapping reported existing OVP units, it is acceptable to install up to any three (3) of the OVP nodel numbers listed below as required at any location other than the mount see without affecting the structural spacety of the mount. If OVP units are installed on the mount face, a mount re-analysis may be required unless replacing an existing OVP.

Model Number Ports AKA RC30C-3315-PF-48 6 OVP-6 RHSDC-6627-PF-48 12 OVP-12

The existing mount is SUFFICIENT for the final loading or

SHASSP rigging plan review services compliant with the requirements of ANSVTIA 322 are available for a struction Class IV alte or other, if required. Separate review fees will apply:

5. The mount was chested up to, and including, the boils that faster, it to the mount collaboratement and threaded not connections in color members if applicable. Local deformation and interaction between the mount collaboratement and the supporting lower structure are outside the scope of this shalpds.

For mount analyses completed from other data sources (including new replacement mounts) and not specifically mapped by Maser Consulting, the mounts are assumed to have been properly flabricated, installed and natinitized is good condition, telest free and plumb in accordance with to original design and manufacturer's specifications.

Mount Photos
 Mount Mapping Report (for reference only)
 Analysis Calculations
 Contractor Required Post installation trapection (PMI) Report Deliverables
 Acontract Placement Diagrams

MOUNT ANALYSIS

NOTE: THIS SHEET WAS CREATED BY OTHERS AND PROVIDED AT THE REQUEST OF THE CUSTOMER WITHOUT EDIT. PLEASE REFERENCE THE MOUNT ANALYSIS REPORT FOR COMPLETE MOUNT ANALYSIS CALCULATIONS AND DETAILS. SUPPLEMENTAL PAGES INCLUDED IN THE CONSTRUCTION DRAWINGS ARE FOR REFERENCE ONLY, GENERAL CONTRACTOR IS TO VERYIFY THEY HAVE THE MOST RECENT MOUNT ANALYSIS PRIOR TO CONTRUCTION.

R-601 SHEET NUMBER:

REVISI

SUPPLEMENTAL