
STANDARD HEADER SCHEDULE ROOF PLAN NOTES R-1 SEE ELEVATIONS FOR ROOF PITCH 0'-0" UP TO 6'-0" OPENINGS DOUBLE 2x8 No.*2 SOUTHERN PINE WITH 1/2" OSB SOLID CONTINUOUS SPACER GLUED AND NAILED R-2 ALL OVERHANG 18" (12" on gables) WITH IOd x 0.128" x 3" NAILS IN 2 ROWS @ 12" O.C. STAGGERED EACH SIDE WITH I - SIMPSON MSTAIS UNLESS OTHERWISE NOTED TOP AND I - SIMPSON SPH4R BOTTOM EACH SIDE OF OPENING WITH I - HEADER STUD AND I FULL PROVIDE ATTIC VENTILATION IN AC-HEIGHT STUDS EACH SIDE OF OPENING CORDANCE WITH SCHEDULE ON SD.3 SEE EXTERIOR ELEVATIONS AND FLOOR PLANS TO VERIFY PLATE AND HEEL HEIGHTS 6'-0" UP TO 9'-0" OPENINGS DOUBLE 2x12 No. *2 SOUTHERN PINE WITH 1/2" OSB SOLID CONTINUOUS SPACER GLUED AND NAILED WITH 10d x 0.128" x 3" NAILS IN 2 ROWS @ 12" O.C. STAGGERED EACH SIDE WITH 1 - SIMPSON MSTA24 MOVE ALL VENTS AND OTHER ROOF PENETRATIONS TO REAR TOP AND 2 - SIMPSON SPH4R BOTTOM EACH SIDE OF OPENING WITH 1 - HEADER STUD AND 2 FULL HEIGHT STUDS EACH SIDE OF OPENING 9'-0" UP TO 16'-0" OPENINGS DOUBLE 2x12 No. *2 SOUTHERN PINE WITH 1/2" OSB SOLID CONTINUOUS SPACER GLUED AND NAILED WITH 10d x 0.128" x 3" NAILS IN 2 ROWS @ 12" O.C. STAGGERED EACH SIDE WITH 3 - SIMPSON MSTAIS EACH SIDE OF OPENING WITH 2 - HEADER STUDS AND 3 FULL HEIGHT STUDS EACH SIDE OF OPENING GARAGE DOOR AND REAR PORCH OPENINGS 2 PLY 1%" \times 11 7/8" 2.0E MICROLAMM LYL HEADER GLUED AND NAILED WITH 10d \times 0.128" \times 3" NAIL6 IN 2 ROWS @ 12" O.C. STAGGERED EACH SIDE WITH 3 - SIMPSON MSTAIS EACH SIDE OF OPENING WITH 2 - HEADER STUDS AND 3 FULL HEIGHT STUDS EACH SIDE OF OPENING FOR (2) OR (3) GANG LAM. NAIL PLYWOOD FLITCH BEAM 1 3/4" BEAMS NAIL MEMBERS TOGETHER W/ 16d NAILS TOGETHER W/ 16d NAILS STAGGERED TOP AND BOTTOM, STAGGERED TOP AND BOTTOM, EACH FACE EACH FACE WHERE BEAM SPAN IS GREATER x - x × - × -THAN 8'-0", CENTER 8'-0" LONG PLYWOOD AT CENTER OF BEAM SPAN, BUTT ADJACENT PLYWOOD PIECES TIGHT TO CENTER PIECE. STAGGER JOINTS AT BEAMS WITH MORE THAN ONE PLYWOOD PLATE. MULTIPLE GANG LAM, DETAIL PLYWOOD FLITCH BEAM DETAIL NOT TO SCALE NOT TO SCALE B/U Beam DETAILS SCALE: NONE


MATERIAL	MINIMUM THICKNESS (in)	GAGE	WEIGHT
COPPER			16
ALUMINUM	0.024		
STAINLESS STEEL		28	
GALVANIZED STEEL	er10.0	26 (ZINC COATED G90)	
ZINC ALLOY LEAD PAINTED TERNE	0.027		4 <i>O</i> 2 <i>O</i>

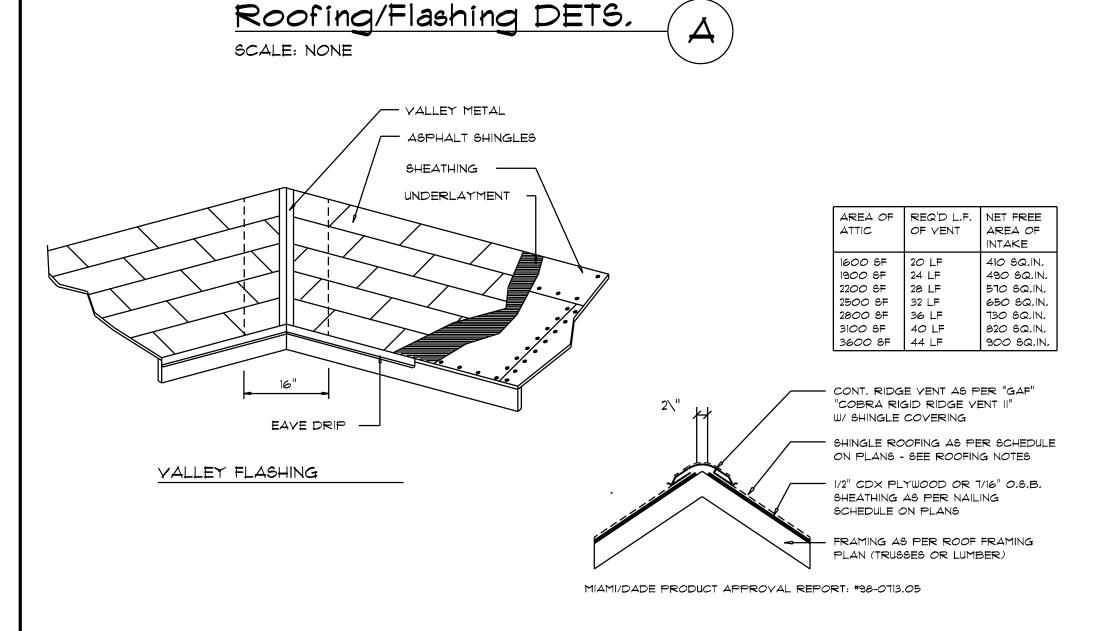

Ridge Vent DETAIL

SCALE: 3/4" = 1'-0"

B

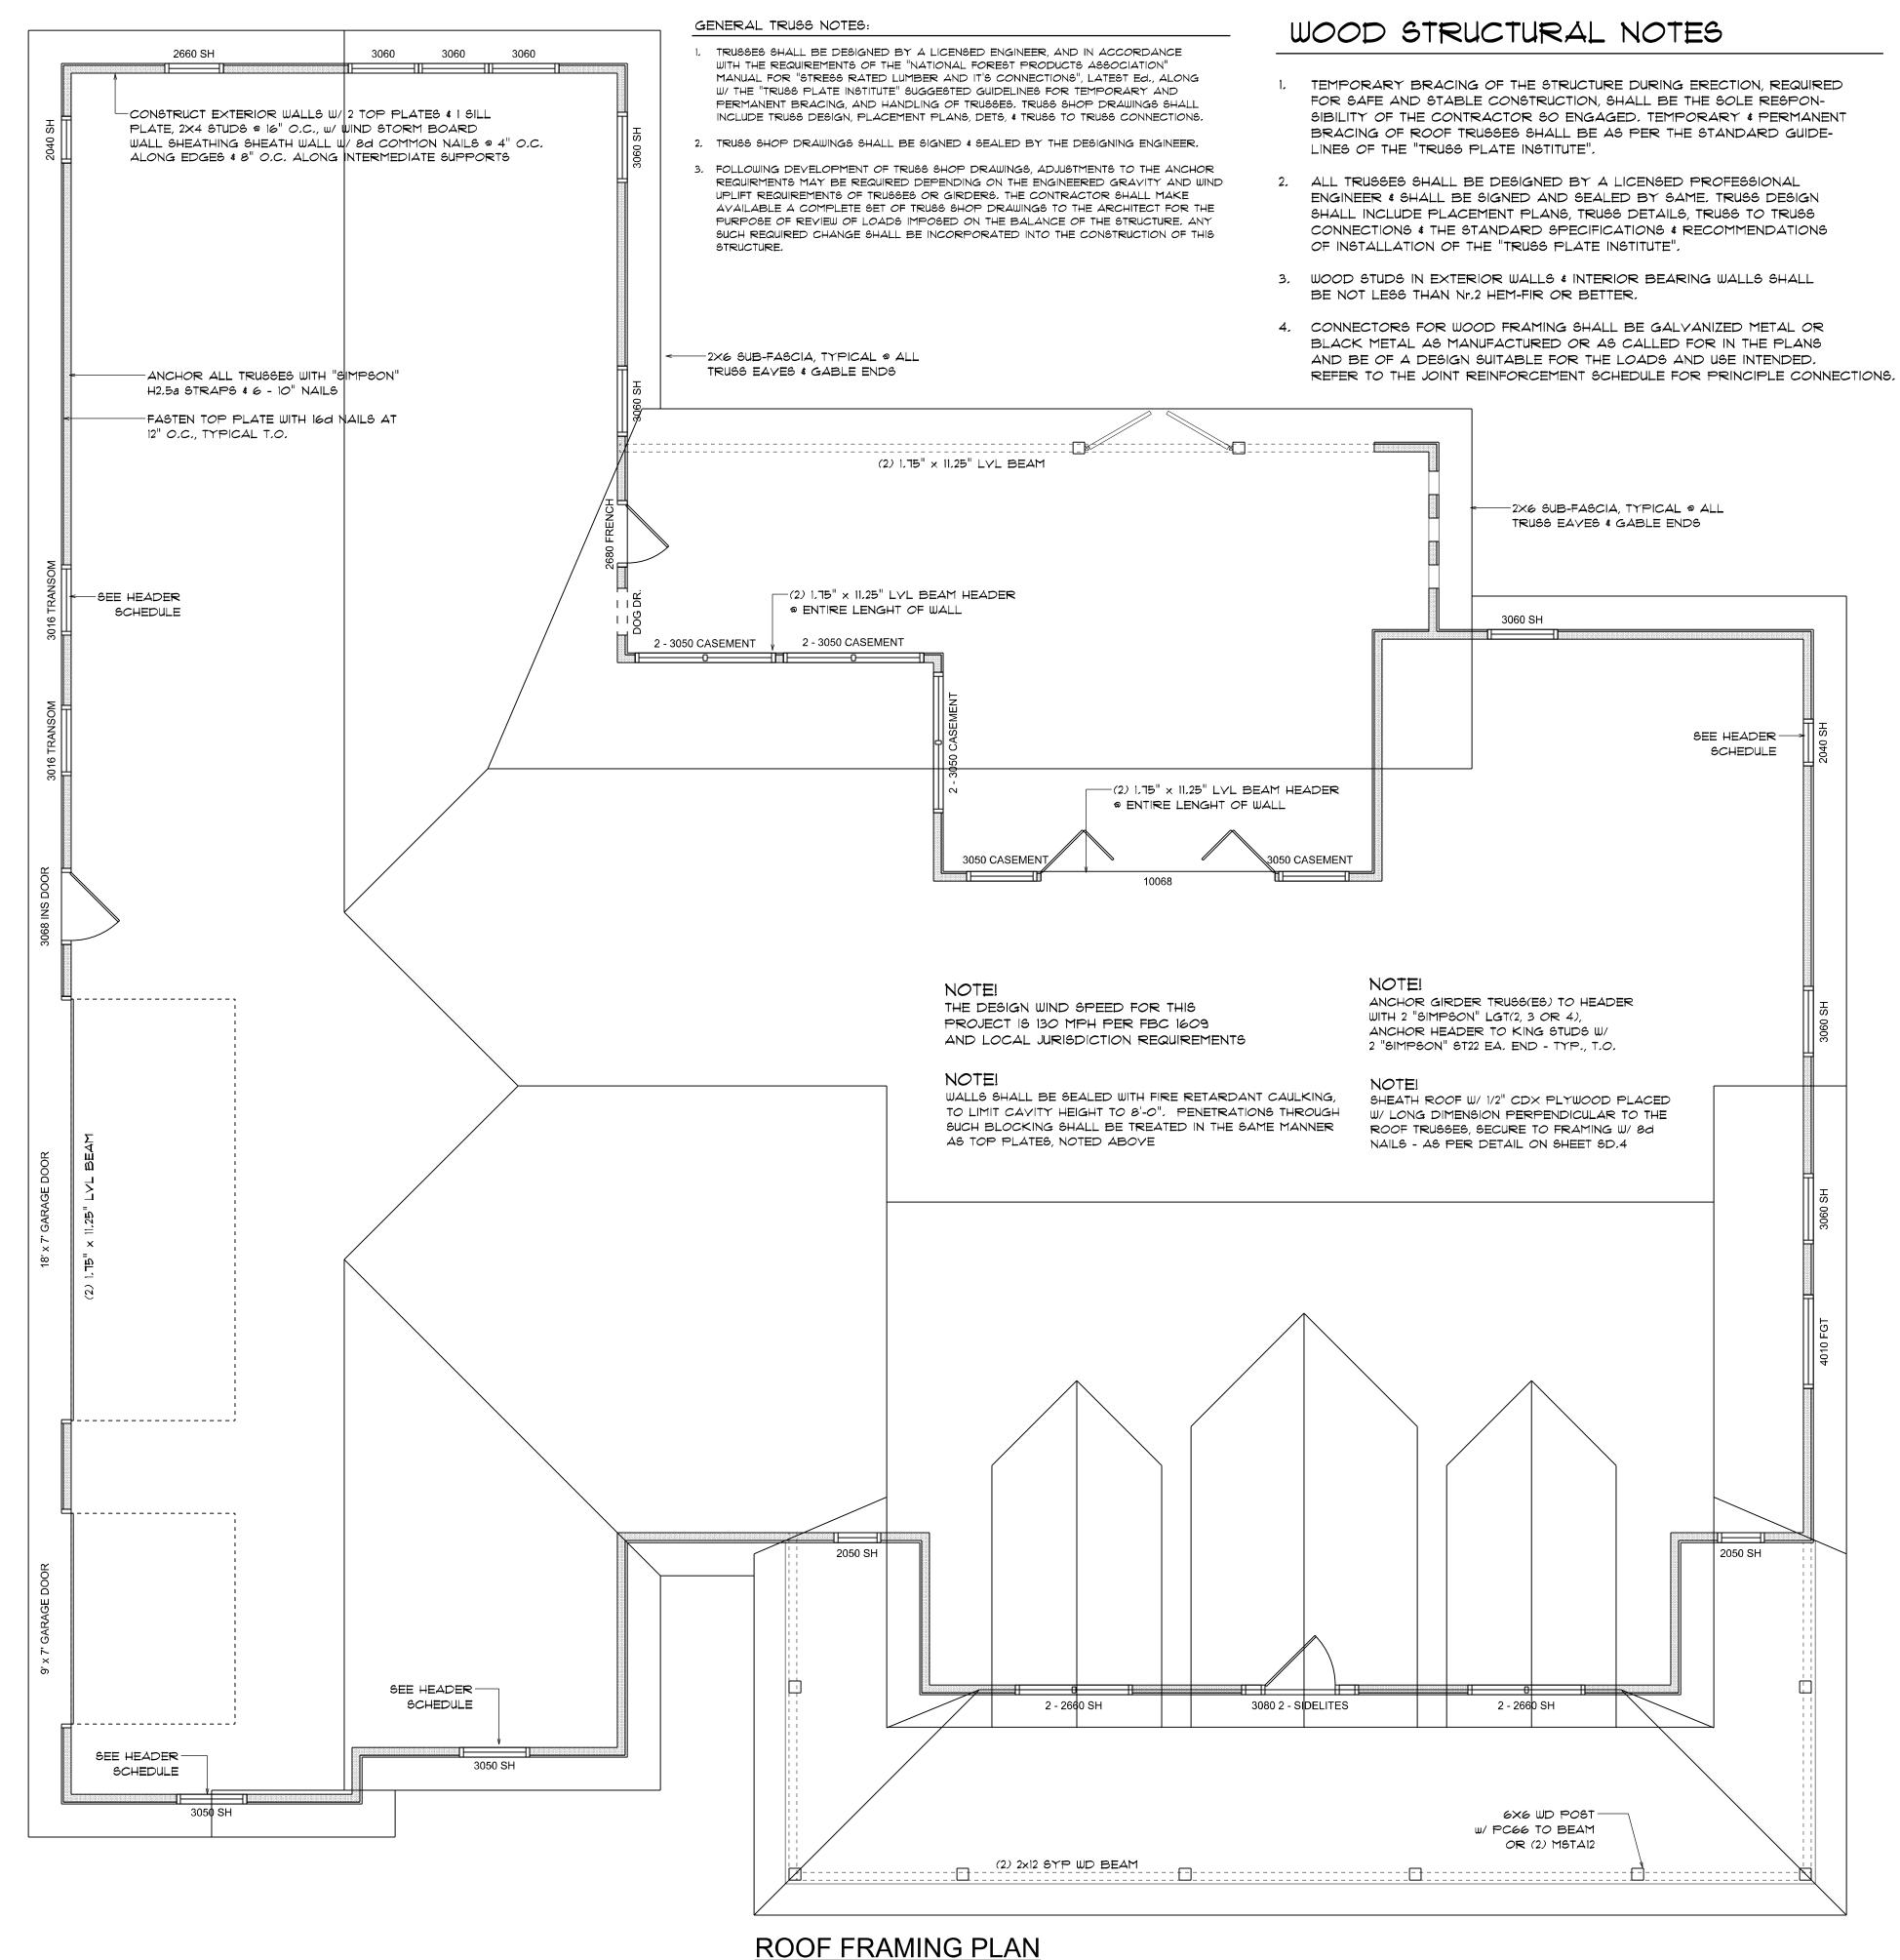

REVISIONS MAY 7th, 202

NOL

SHEET NUMBER OF 4 SHEETS

