


REVISIONS

SOFTPIAN ARCHITECTURAL DESIGN SOFTWARE

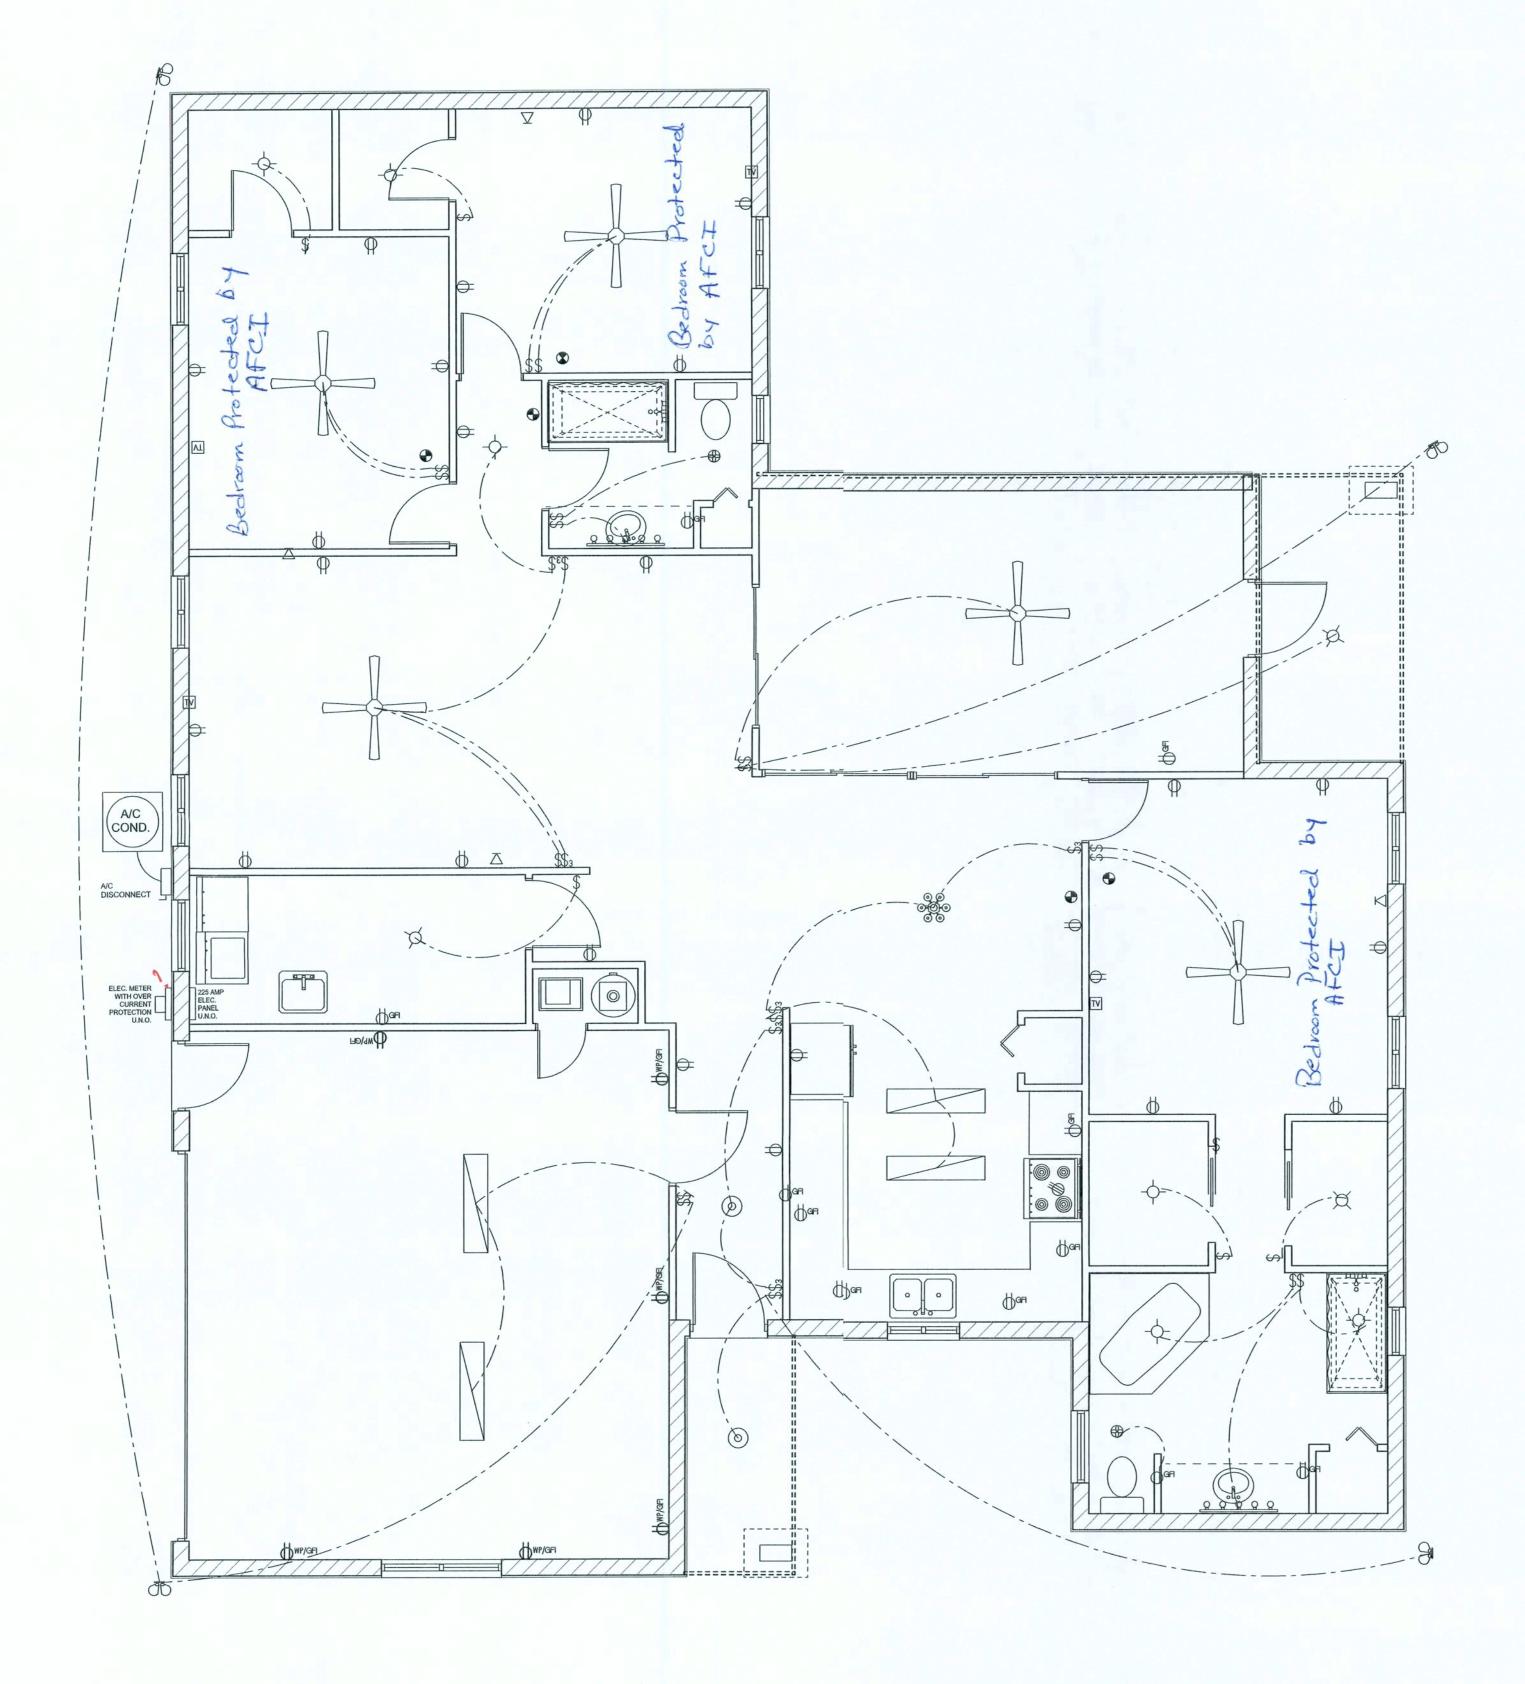

ELECTRICAL PLAN
SCALE: 1/4" = 1'-0"

ELECTRICAL PLAN NOTES

E -1 WIRE ALL APPLIANCES, HVAC UNITS AND OTHER EQUIPMENT PER MANUF. SPECIFICATIONS.

E -2 CONSULT THE OWNER FOR THE NUMBER OF SEPERATE TELEPHONE LINES TO BE INSTALLED.

E -3 ALL INSTALLATIONS SHALL BE PER NAT'L. ELECTRIC CODE.

E -4

ALL SMOKE DETECTORS SHALL BE 120V W/ BATTERY
BACKUP OF THE PHOTOELECTRIC TYPE, AND SHALL
BE INTERLOCKED TOGETHER. INSTALL INSIDE AND
NEAR ALL BEDROOMS.

E -5

TELEPHONE, TELEVISION AND OTHER LOW VOLTAGE
DEVICES OR OUTLETS SHALL BE AS PER THE OWNER'S
DIRECTIONS, & IN ACCORDANCE W/ APPLICABLE
SECTIONS OF NEC-LATEST EDITION.

E -6 ELECTRICAL CONT'R SHALL BE RESPONSIBLE FOR THE DESIGN & SIZING OF ELECTRICAL SERVICE AND CIRCUITS.

E -7 ENTRY OF SERVICE (UNDERGROUND OR OVERHEAD)
TO BE DETERMINED BY POWER COMPANY.

E -8 ALL BEDROOM RECEPTACLES SHALL BE AFCI (ARC FAULT CIRCUIT INTERRUPT)

E -9 ALL OUTLETS TO BE LOCATED ABOVE BASE FLOOD ELEVATION

A SERVICE DISCONNECT WITH OVER CURRENT PROTECTION SHALL BE INSTALLED OUTSIDE OF THE BUILDING, ON THE LOAD SIDE OF THE METER, AT THE PLACE ELECTRIC CONDUCTORS ENTER THE BUILDING.

E -10 CONDUCTORS ENTER THE BUILDING.
SERVICE ENTRANCE CONDUCTORS MAY NOT BE LOCATED
INSIDE OF THE OF THE BUILDING WITHOUT SPECIAL
APPROVAL OF THE BUILDING OFFICIAL

	EL FOTDIO () TOTAL
	ELECTRICAL LEGEND
	CEILING FAN (PRE-WIRE FOR LIGHTKIT)
₫₽	DOUBLE SECURITY LIGHT
	2X4 FLUORESCENT LIGHT FIXTURE
0	RECESSED CAN LIGHT
- →	BATH EXAUST FAN WITH LIGHT
₩	BATH EXAUST FAN
- 	LIGHT FIXTURE
Ф	DUPLEX OUTLET
Ф	220v OUTLET
Фан	GFI DUPLEX OUTLET
•	SMOKE DETECTOR
\$	WALL SWITCH
\$3	3 WAY WALL SWITCH
\$4	4 WAY WALL SWITCH
₩P/GFI	WATER PROOF GFI OLTLET
∇	PHONE JACK
0	TELEVISION JACK
9	GARAGE DOOR OPENER
	WALL HEATER

HOMETOWN HOMES

FODOR RESIDENCE

ADDRESS: 460 SW Riverland Ct. Fort White, FL 32038


PRINTED DATE:
July 10, 2006


DRAWN BY: CHECKED BY:

FINALES DATE:


JOB NUMBER: 606209 DRAWING NUMBER

A-3
OF 6 SHEETS

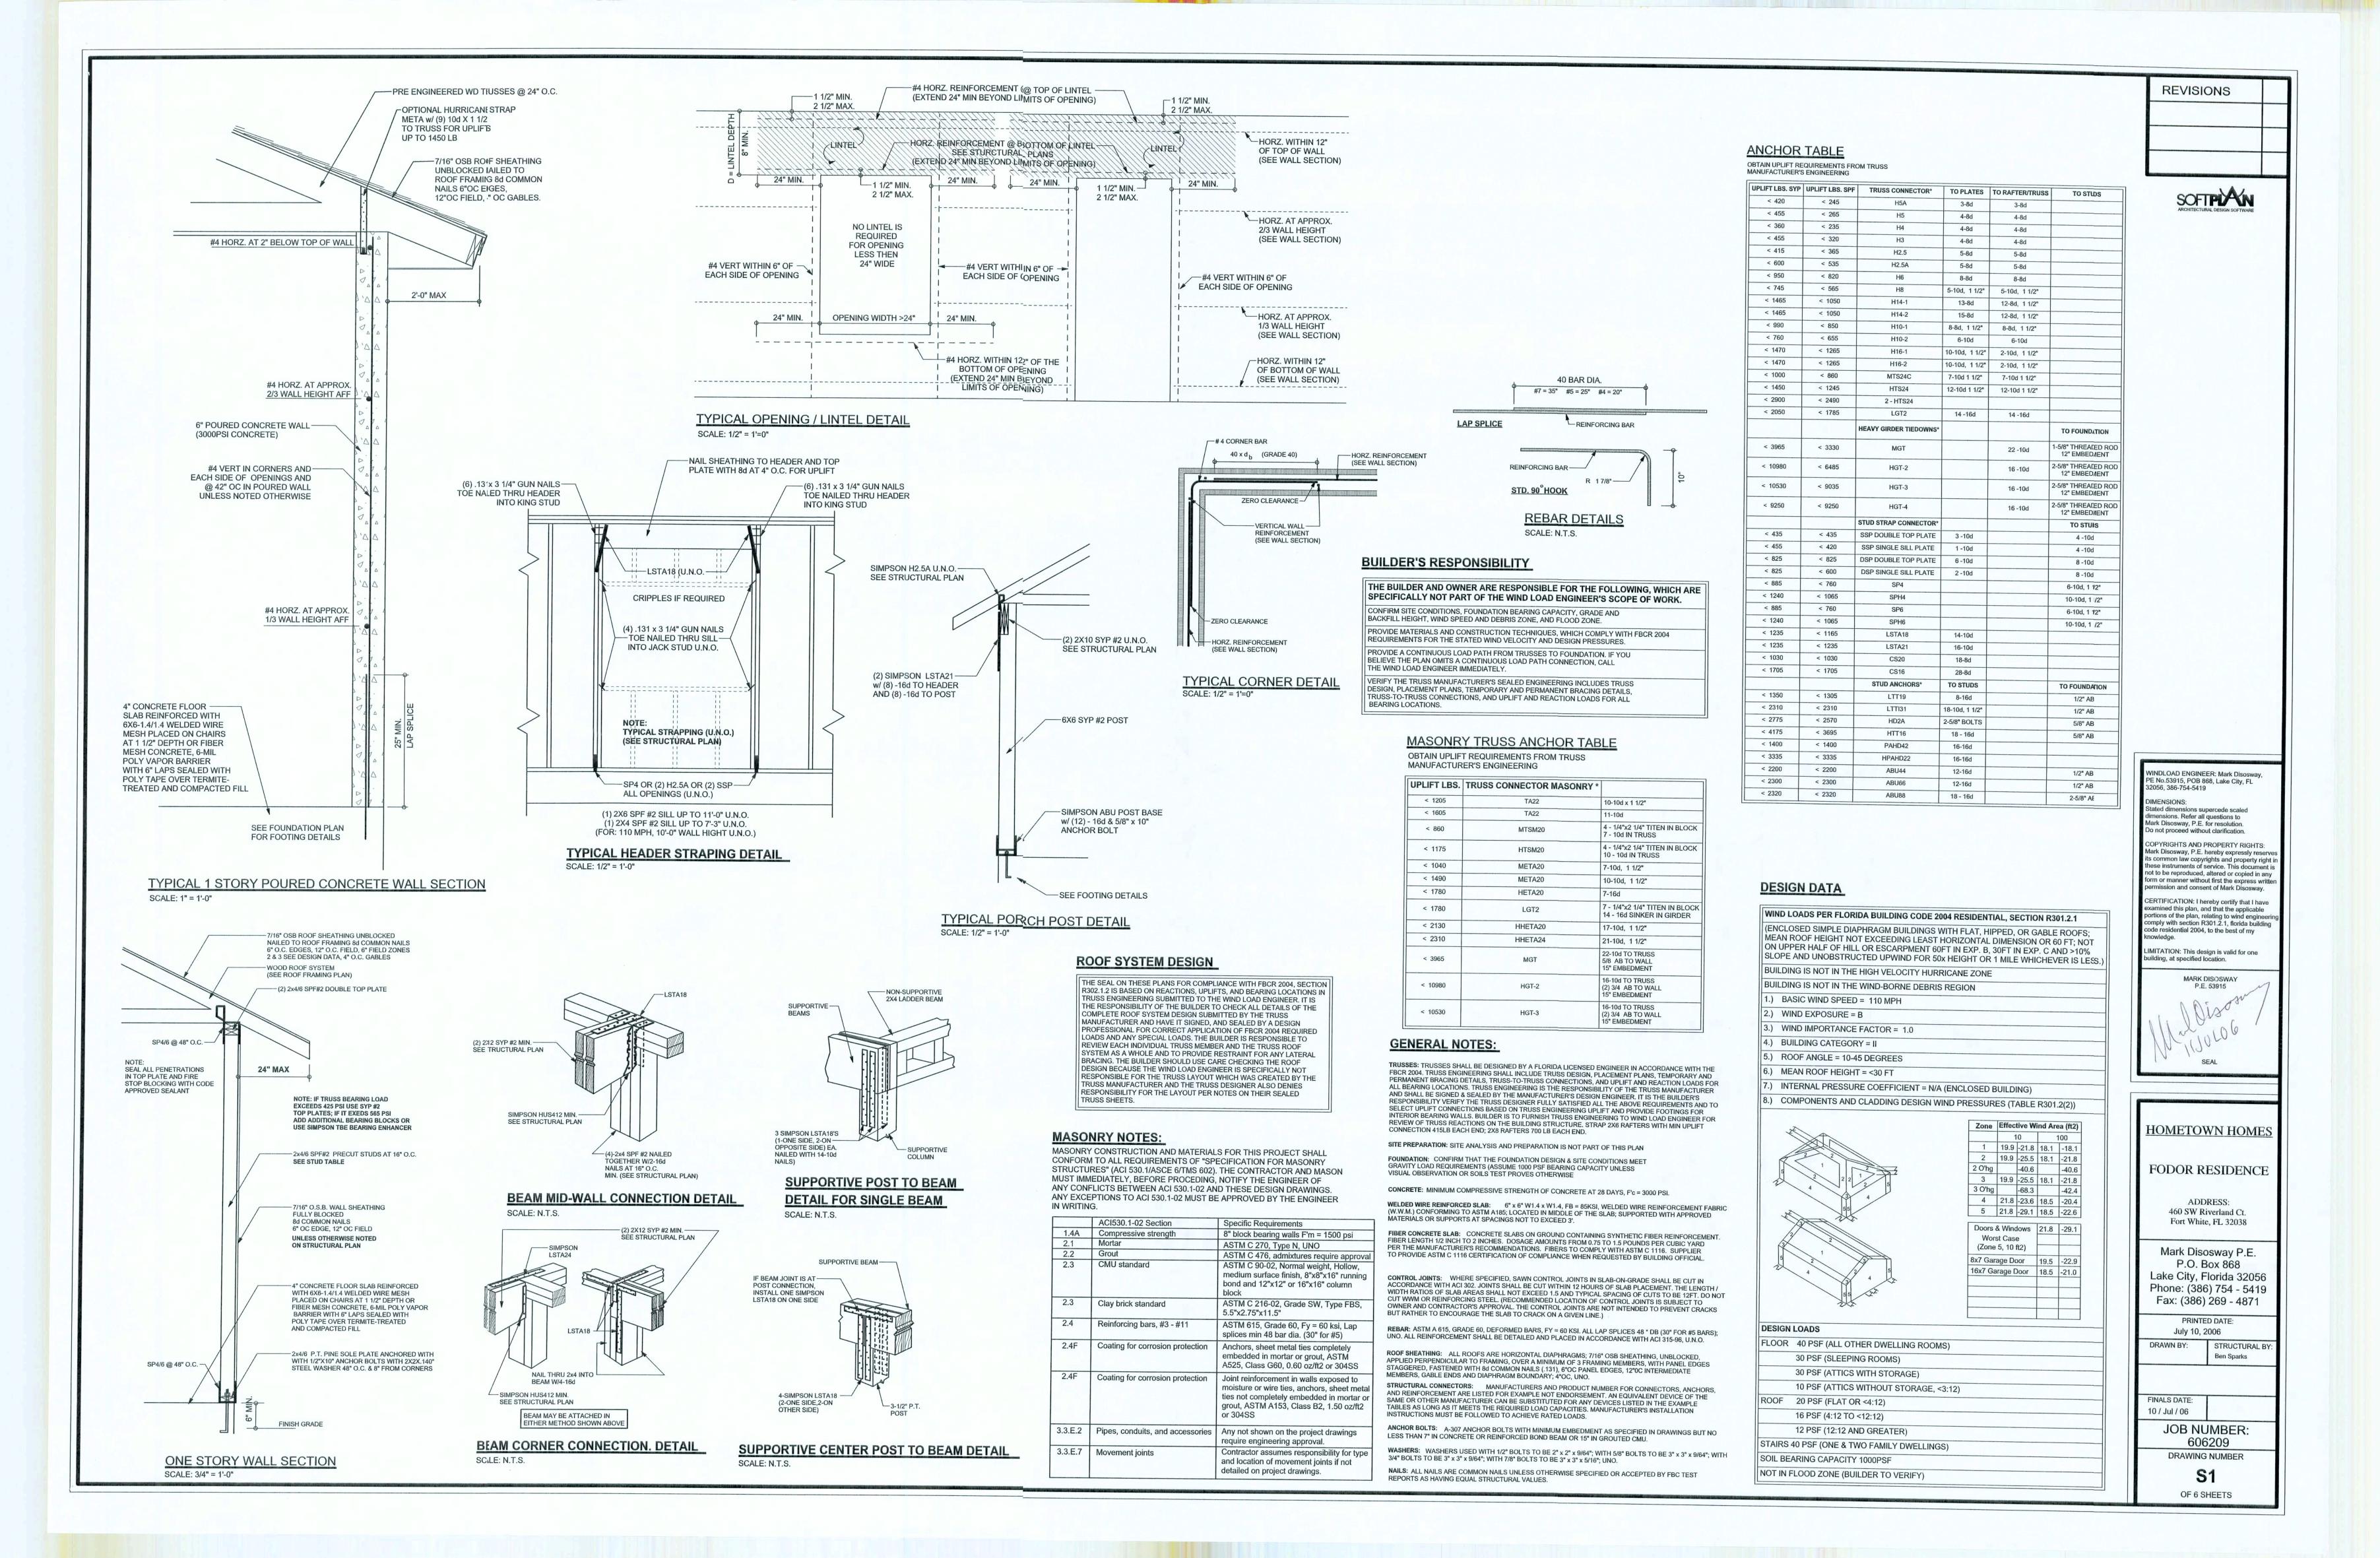


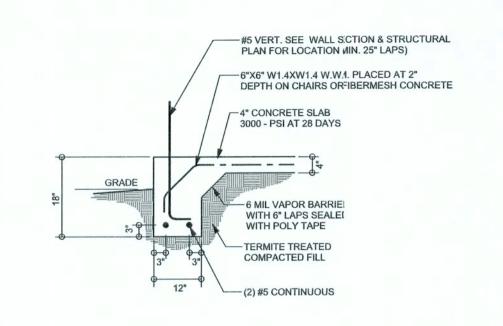


F16 MONOLITHIC FOOTING SCALE: 1/2" = 1'-0"

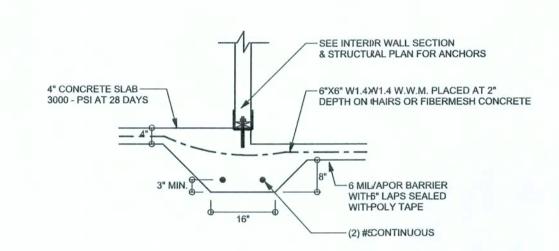


INTERIOR BEARING STEP FOOTING S-2 SCALE: 1/2" = 1'-0"

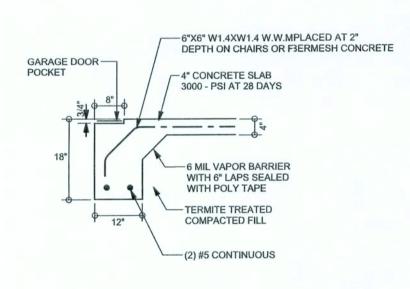

F4 GARAGE DOOR FOOTING S-2 SCALE: 1/2" = 1'-0"

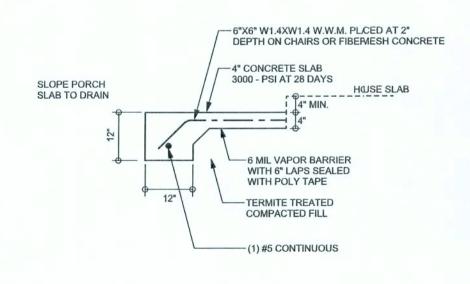

F5 PORCH FOOTING S-2 SCALE: 1/2" = 1'-0"

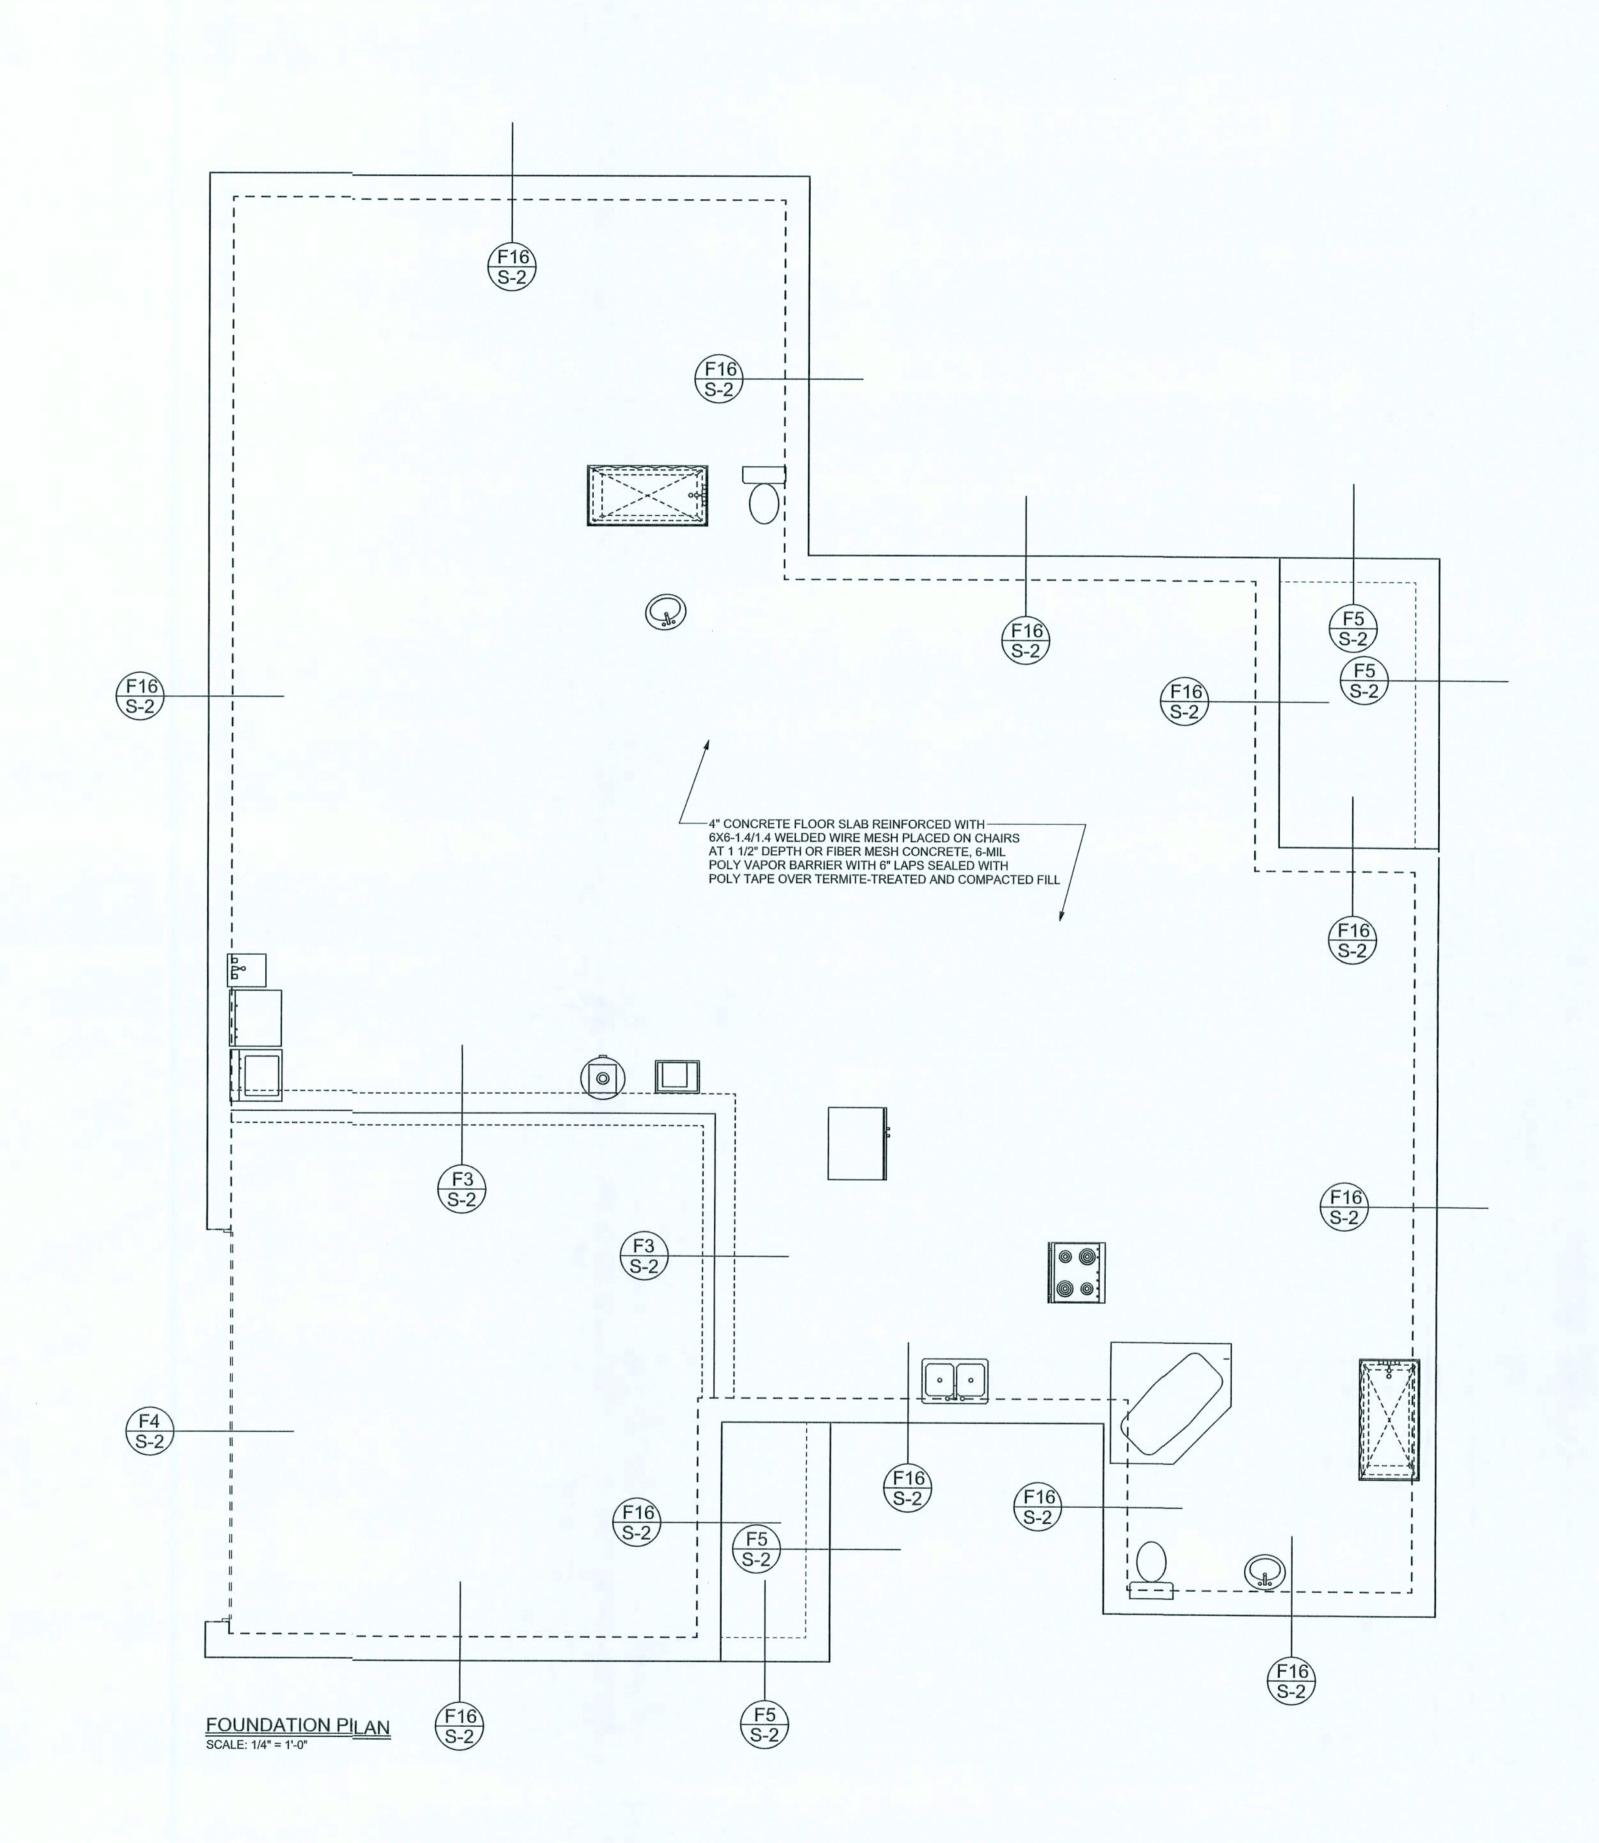

REVISIONS


WINDLOAD ENGINEER: Mark Disosway, PE No.53915, POB 868, Lake City, FL 32056, 386-754-5419

Stated dimensions supercede scaled dimensions. Refer all questions to Mark Disosway, P.E. for resolution. Do not proceed without clarification.

COPYRIGHTS AND PROPERTY RIGHTS: Mark Disosway, P.E. hereby expressly reserves its common law copyrights and property right in these instruments of service. This document is not to be reproduced, altered or copied in any form or manner without first the express written permission and consent of Mark Disosway.

CERTIFICATION: I hereby certify that I have examined this plan, and that the applicable portions of the plan, relating to wind engineering comply with section R301.2.1, florida building code residential 2004, to the best of my knowledge.

LIMITATION: This design is valid for one building, at specified location. MARK DISOSWAY P.E. 53915

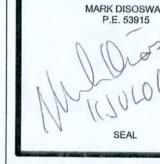

HOMETOWN HOMES

FODOR RESIDENCE

ADDRESS: 460 SW Riverland Ct. Fort White, FL 32038

Mark Disosway P.E. P.O. Box 868 Lake City, Florida 32056 Phone: (386) 754 - 5419 Fax: (386) 269 - 4871

PRINTED DATE: July 10, 2006 DRAWN BY: STRUCTURAL BY Ben Sparks


FINALS DATE: 10 / Jul / 06

> JOB NUMBER: 606209

> > **S-2**

OF 6 SHEETS

DRAWING NUMBER

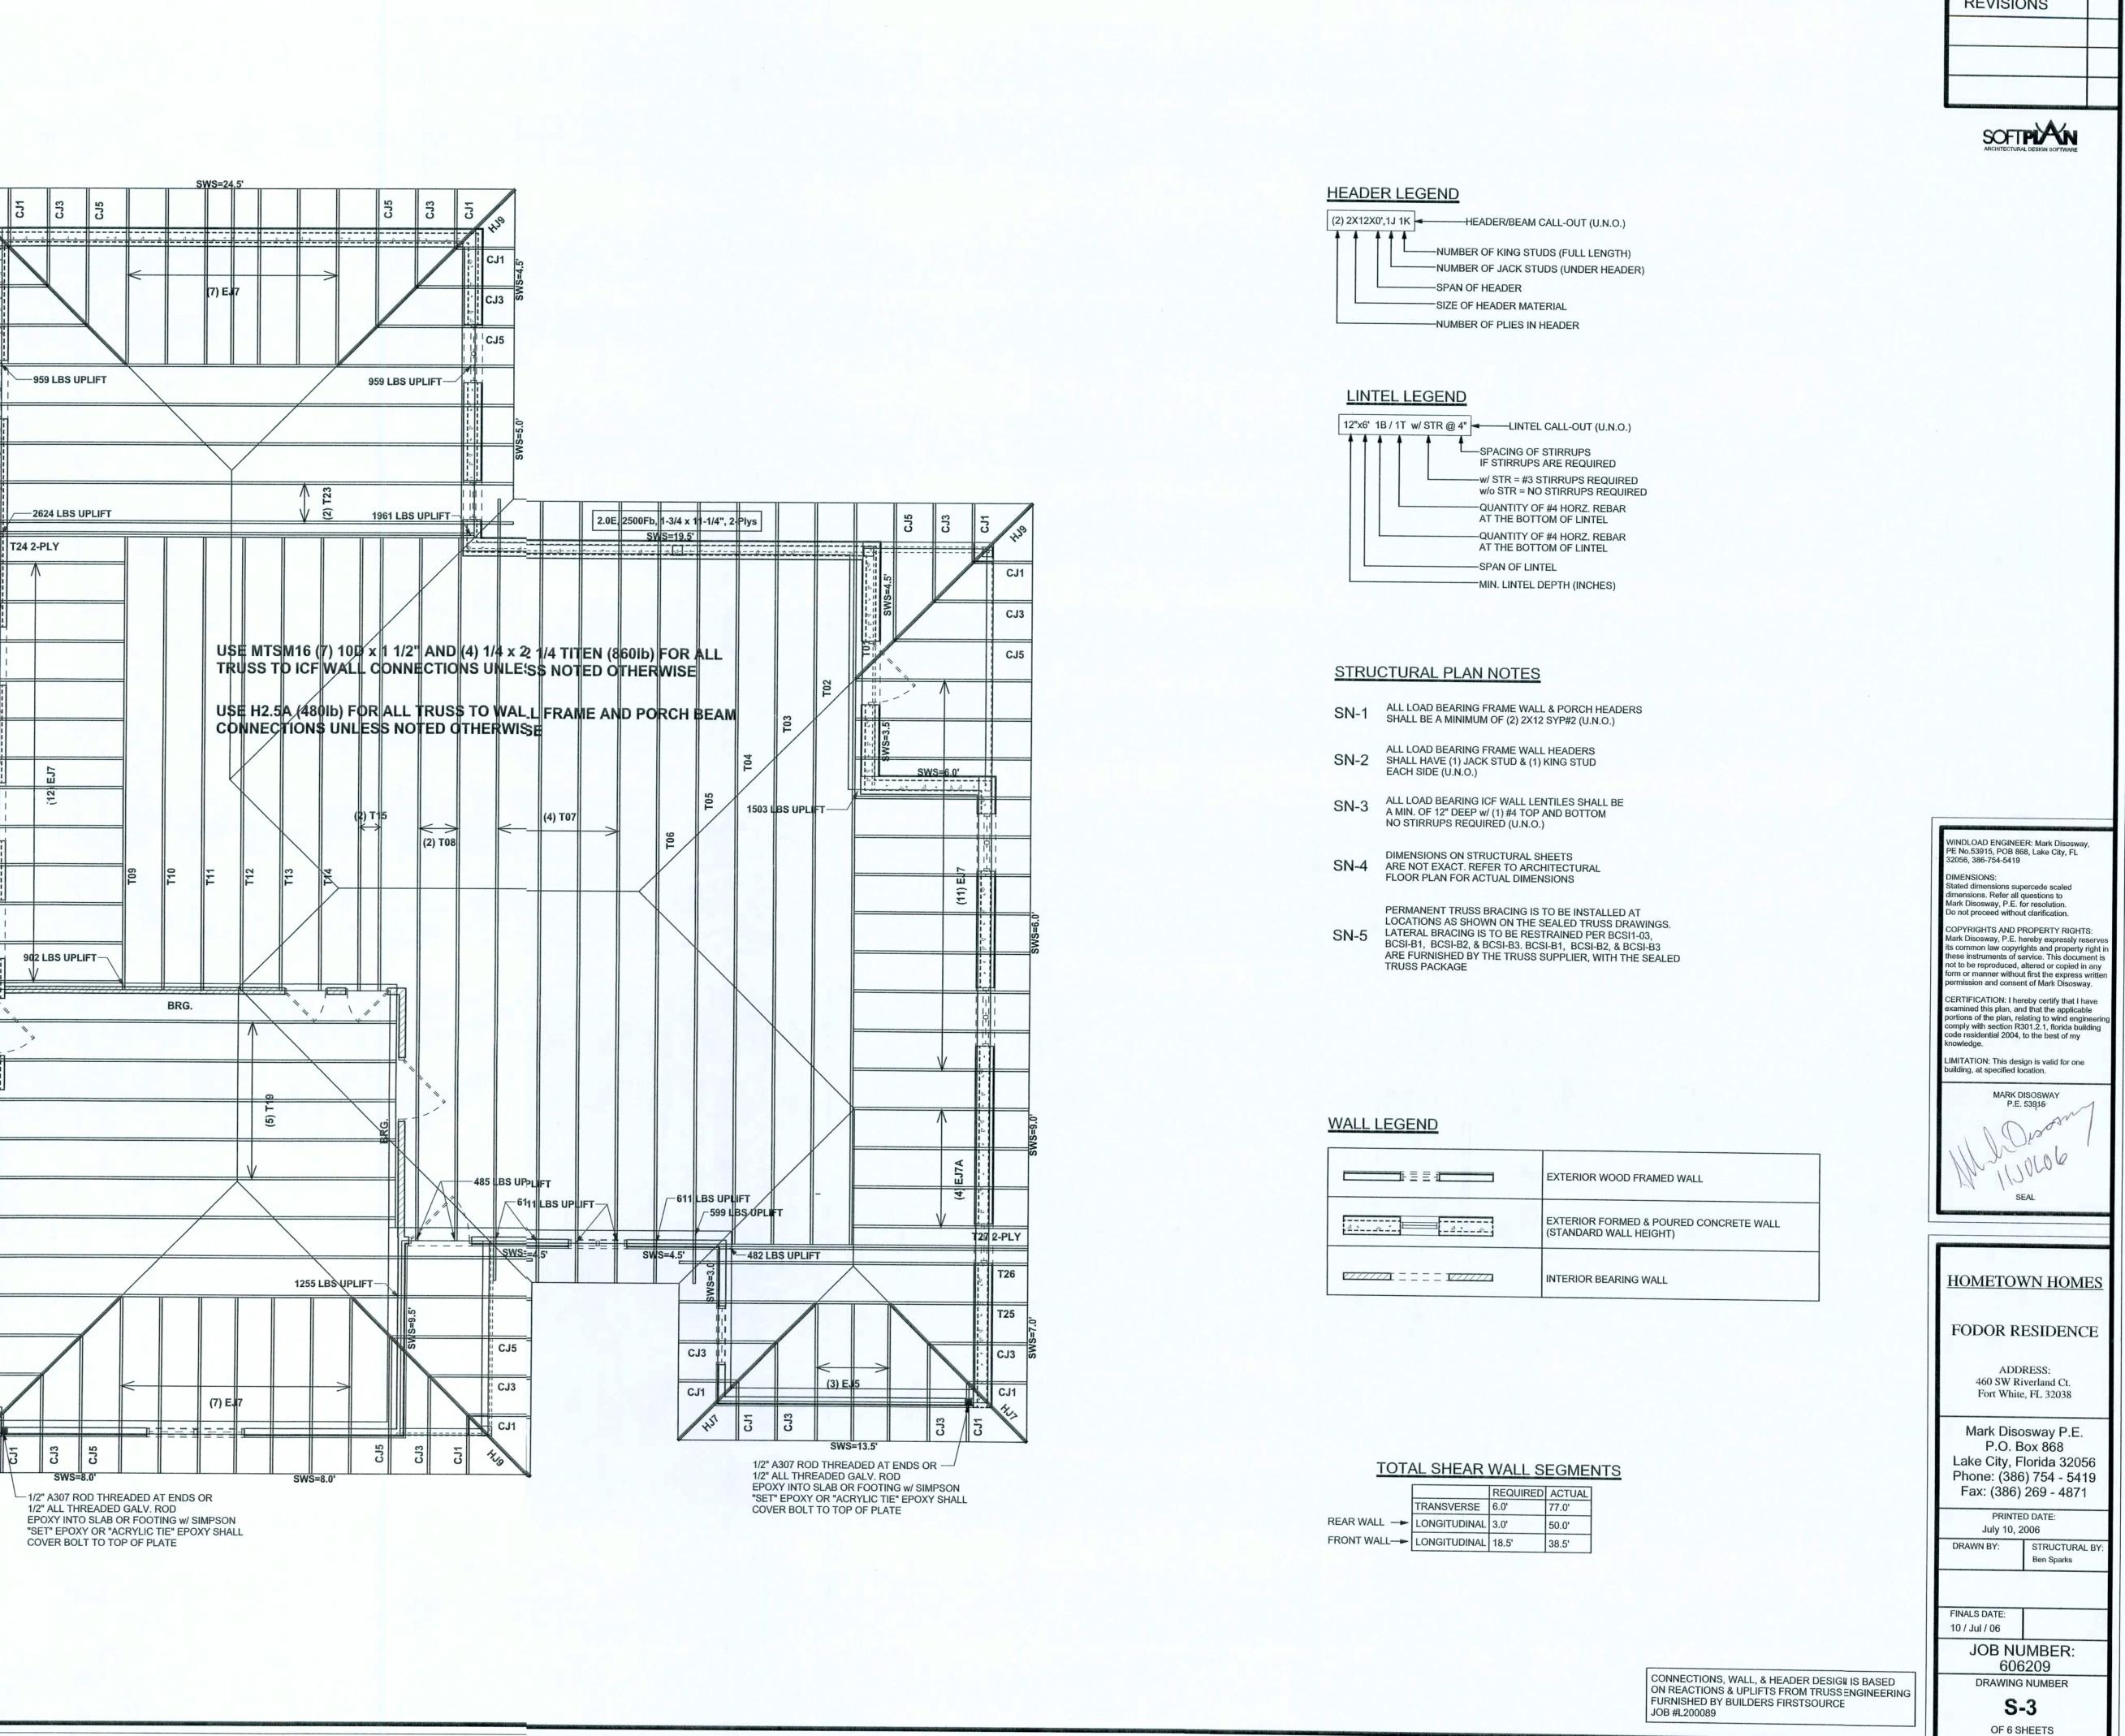

CJ3

CJ5

T20

T21

REVISIONS