

### SCOPE OF WORK:

TO INSTALL A ROOF MOUNTED SOLAR PHOTOVOLTAIC SYSTEM AT THE OWNER RESIDENCE LOCATED AT 615 SOUTHWEST OLEANDER PLACE, LAKE CITY, FL 32025.

SYSTEM DC RATING: 15.60 KWDC SYSTEM AC RATING: 11.33 KWAC

#### GENERAL NOTES:

- THESE CONSTRUCTION DOCUMENTS HAVE BEEN BASED ON FIELD INSPECTIONS AND OTHER INFORMATION AVAILABLE AT THE TIME. ACTUAL FIELD CONDITIONS MAY REQUIRE MODIFICATIONS IN CONSTRUCTION DETAILS.
- CONTRACTOR HAS THE FULL RESPONSIBILITY TO CHECK AND VERIFY ALL DIMENSIONS AND EXISTING CONDITIONS. ANY DISCREPANCIES SHALL BE REPORTED TO THE ENGINEER BEFORE PROCEEDING WITH THE WORK. ANY WORK STARTED BEFORE CONSULTATION AND ACCEPTANCE BY THE ENGINEER SHALL BE THE SOLE RESPONSIBILITY OF THE CONTRACTOR AND SHALL BE SUBJECT TO CORRECTION BY THEM WITHOUT ADDITIONAL COMPENSATION.
- THE CONTRACTOR SHALL BE HELD RESPONSIBLE FOR THE PROPER INSTALLATION AND COMPLETION OF THE WORK WITH APPROVED MATERIALS.
- THE EQUIPMENT AND ALL ASSOCIATED WIRING AND INTERCONNECTION SHALL BE INSTALLED ONLY BY QUALIFIED PEOPLE. A QUALIFIED PERSON IS ONE WHO HAS SKILLS AND KNOWLEDGE RELATED TO THE CONSTRUCTION AND OPERATION OF THE ELECTRICAL EQUIPMENT AND INSTALLATIONS AND HAS RECEIVED SAFETY TRAINING TO RECOGNIZE AND AVOID THE HAZARDS INVOLVED. (NEC 690.4(C), NEC 2017).
- NEW CONDUIT ROUTING SHOWN IS ESSENTIALLY SCHEMATIC.
   CONTRACTOR SHALL LAY OUT RUNS TO SUIT FIELD CONDITIONS AND THE COORDINATION REQUIREMENTS OF OTHER TRADES.
- ARRAY WIRING SHOULD NOT BE READILY ACCESSIBLE EXCEPT TO QUALIFIED PERSONNEL.
- THE AC DISCONNECT MUST BE ACCESSIBLE TO QUALIFIED UTILITY PERSONNEL, BE LOCKABLE, AND BE A VISIBLE-BREAK SWITCH.



	SHEET INDEX								
CS-0	COVER SHEET & BOM								
E-1	STRING LAYOUT & SIGNAGE								
E-2	ELECTRICAL DIAGRAM & CALCS.								
E-3+	EQUIPMENT SPECIFICATIONS								

GOVERNING CODES
2017 NEC
2018 NFPA / 2020 FFPC
2020 FBC
2018 IRC

AUTHORITY HAVING JURISDICTION (AHJ): COUNTY OF MARION UTILITY COMPANY: FPL

	BILL OF MATERIALS									
EQUIPMENT	QTY	DESCRIPTION								
SOLAR PV MODULE	39	Q CELLS Q.PEAK DUO BLK ML-G10+ 400								
MICROINVERTER	39	ENPHASE IQ8PLUS-72-2-US								
JUNCTION BOX	1	JUNCTION BOX, NEMA 3R, UL LISTED								
COMBINER BOX	1	ENPHASE IQ COMBINER 4/4C W/ IQ ENVOY (X-IQ-AM1-240-4)								
AC DISCONNECT	1	60A FUSED AC DISCONNECT, 240V, NEMA 3R, UL LISTED								



ATLANTIC KEY ENERGY LLC 12600 CHALLENGER PARKWAY

SUITE 200 ORLANDO, FL 32826 1 (407) 988-0273



MARIANNE JOHNSON RESIDENCE PROJECT # P-0074754 SOUTHWEST OLEANDER PLA LAKE CITY, FL 32025

SIGNATURE WITH SEAL

2

REVISIONS

DESCRIPTION DATE REV

Aunument of the provided HTML of the pr

04/24/2023

SHEET NAME


COVER SHEET & BOM

CS-0


SHEET NUMBER

2023.04.24 13:33:14 -04'00'

THIS ITEM HAS BEEN DIGITALLY SIGNED AND SEALED BY OMAR TIRADO ON THE DATE ADJACENT TO THE SEAL PRINTED COPIES OF THIS DOCUMENT ARE NOT VCONSIDERED SIGNED AND SEAL, AND THE SIGNATURE MUST BE VERIFIED ON ANY ELECTRONIC COPIES

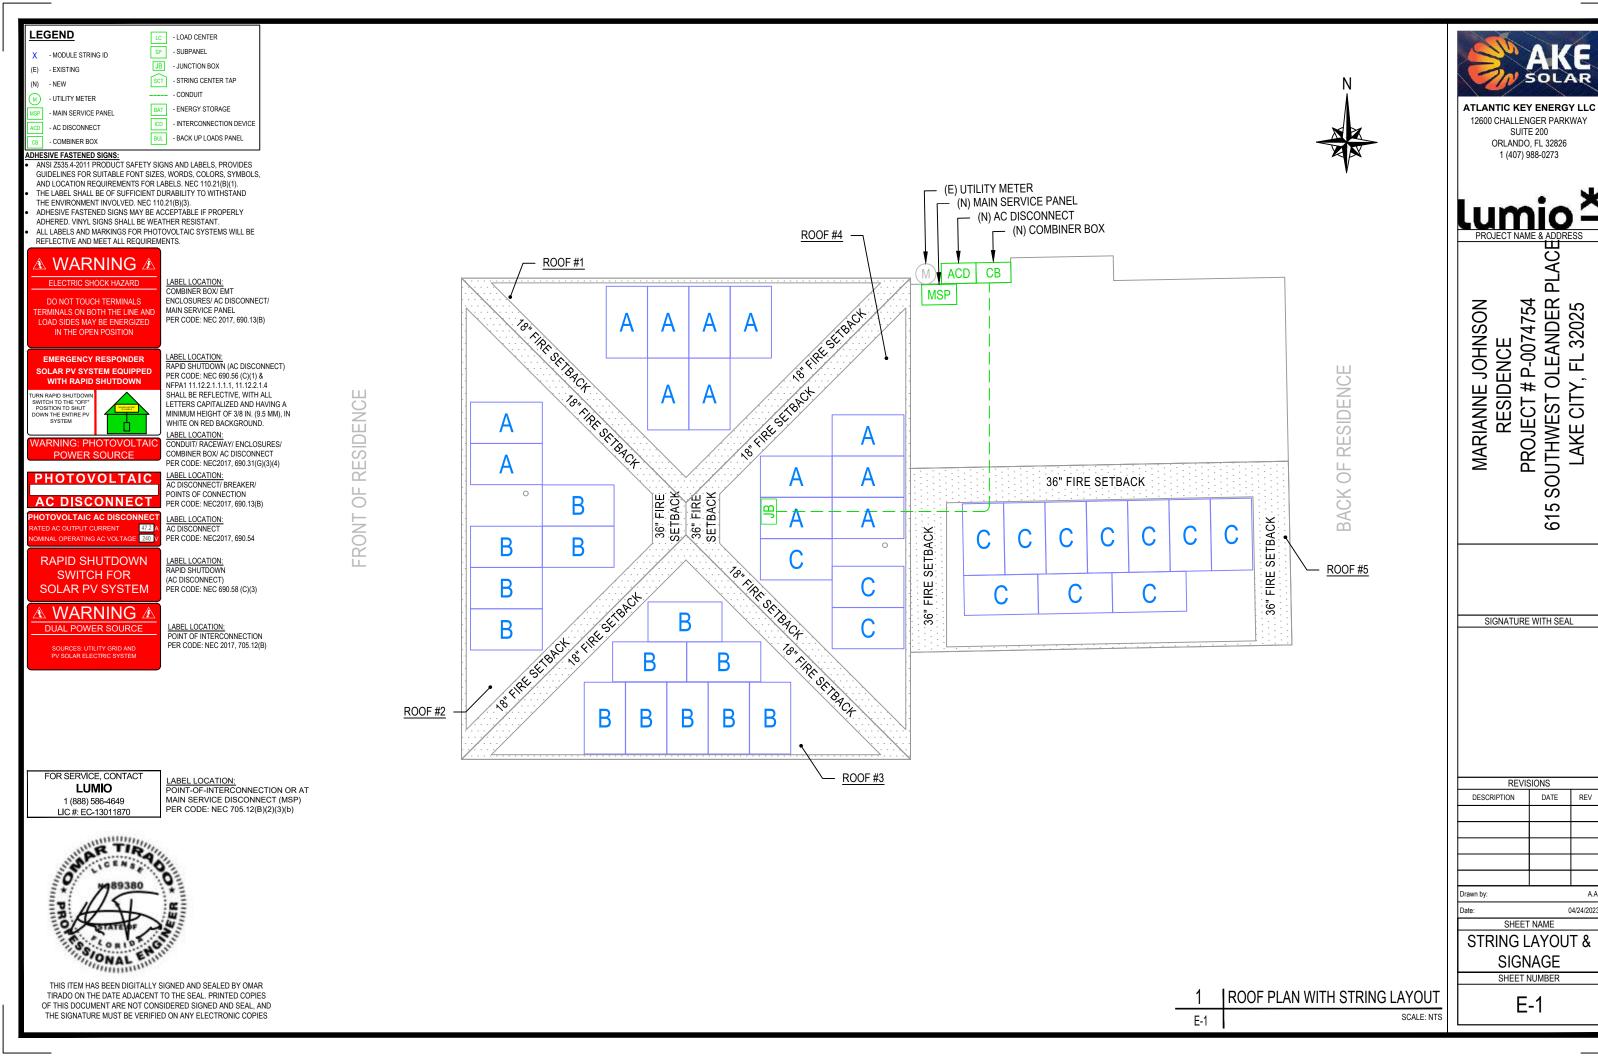

ID	INITIAL CONDUCTOR LOCATION	FINAL CONDUCTOR LOCATION		MIN. CONDUCTOR SIZE (AWG)	MIN. DIA CONDUIT SIZE (IN.)	# OF PARALLEL CIRCUITS	CURRENT-CARRYING CONDUCTORS IN CONDUIT	OCPD (A)		MIN. EGC SIZE (AWG)	TEMP. FAC		CONDUIT FILL FACTOR	CONT. CURRENT (A)	MAX. CURRENT (A)	BASE AMP. (A)	DERATED AMP. (A)	TERM. AMP. RATING (A)	LENGTH (FT)	VOLTAGE DROP (%)
1	STRING A	JUNCTION BOX	12	Q CABLE	N/A	1	2	N/A	6	BARE COPPER	0.76	55°C	N/A	15.73	19.66	30	N/A	N/A	72.00	0.76
2	STRING B	JUNCTION BOX	12	Q CABLE	N/A	1	2	N/A	6	BARE COPPER	0.76	55°C	N/A	15.73	19.66	30	N/A	N/A	78.00	0.82
3	STRING C	JUNCTION BOX	12	Q CABLE	N/A	1	2	N/A	6	BARE COPPER	0.76	55°C	N/A	15.73	19.66	30	N/A	N/A	68.00	0.72
4	JUNCTION BOX	COMBINER BOX	10	THWN-2 COPPER	0.75 LTNM	3	6	20	10	THWN-2 COPPER	0.76	55°C	0.8	15.73	19.66	40	24.3	35	47.00	0.77
5	COMBINER BOX	AC DISCONNECT	6	THWN-2 COPPER	0.75 LTNM	1	3	60	10	THWN-2 COPPER	0.96	34°C	1	47.19	58.99	75	72.0	65	5.00	0.10
6	AC DISCONNECT	MSP	6	THWN-2 COPPER	0.75 LTNM	1	3	N/A	-	-	0.96	34°C	1	47.19	58.99	75	72.0	65	5.00	0.10

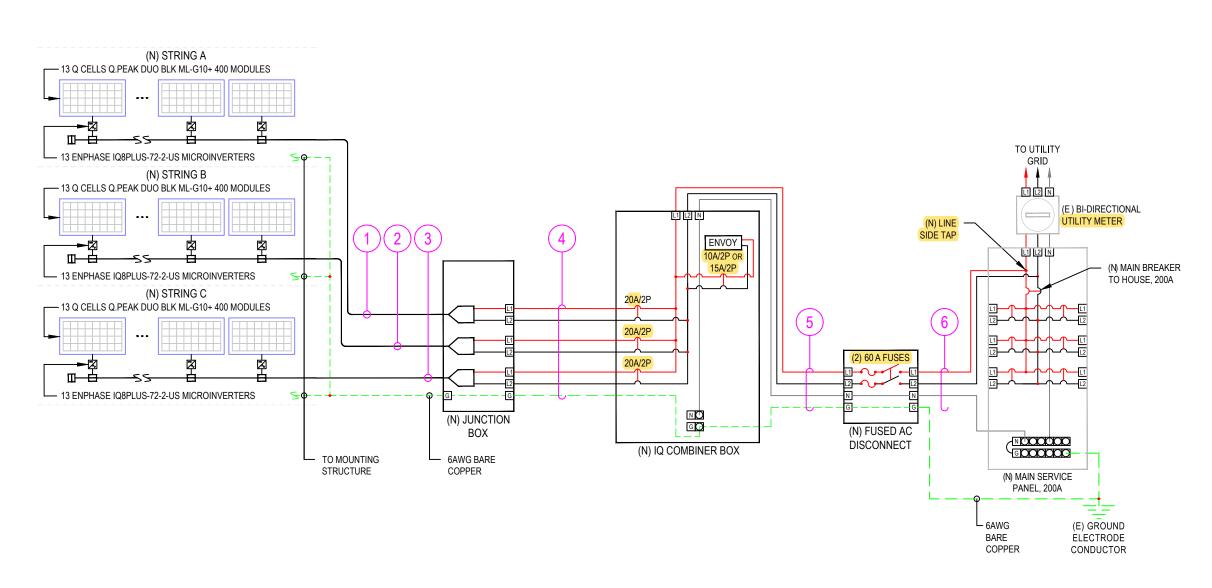



THIS ITEM HAS BEEN DIGITALLY SIGNED AND SEALED BY OMAR TIRADO ON THE DATE ADJACENT TO THE SEAL. PRINTED COPIES OF THIS DOCUMENT ARE NOT CONSIDERED SIGNED AND SEAL, AND THE SIGNATURE MUST BE VERIFIED ON ANY ELECTRONIC COPIES

ELECTRICAL LINE DIAGRAM SCALE: NTS E-2

**LEGEND** NOTE:
1. LTNM OR EQUIVALENT TYPE CONDUIT (E) - EXISTING (N) - NEW

DESIGN TEMPERATURE SPECIFICATIONS									
RECORD LOW TEMP	-6°C								
AMBIENT TEMP. (HIGH TEMP. 2%)	34°C								
CONDUIT HEIGHT	1.0"								
CONDUCTOR TEMP. RATE (ROOF)	55°C								

ATLANTIC KEY ENERGY LLC 12600 CHALLENGER PARKWAY SUITE 200 ORLANDO, FL 32826

1 (407) 988-0273

PLACE PROJECT # P-0074754 5 SOUTHWEST OLEANDER P LAKE CITY, FL 32025 MARIANNE JOHNSON RESIDENCE 615

SIGNATURE WITH SEAL

REVISIONS DESCRIPTION DATE REV 04/24/2023

SHEET NAME


ELECTRICAL LINE DIAGRAM & CALCS. SHEET NUMBER

E-2

# Q.PEAK DUO BLK ML-G10+ SERIES

#### ■ Mechanical Specification

Format	74.0 in × 4t3 in × 1.26 in (including frame)
	(1879 mm × 1045 mm × 32 mm)
Weight	48.5 lbs (22.0 kg)
Front Cover	0.13 in (3.2 mm) thermally pre-siressed glass
	with anti-reflection technology
Back Cover	Composite film
Frame	Black anadised aluminium
Cell	6 × 22 monocrystalline Q.ANTUM solar half cells
Junction box	2.09-3.98 in × 1,26-2.36 in × 0.59-0.71 in (\$3.401 mm × 32-60 mm × 15-18 mm), IP67, with bypass diodes
Cable	4 mm² Solar cable; (+) ≥ 49.2 in (1250 mm), (-) ≥ 49.2 in (1250 mm)
Connector	Staubii MC4; IP68

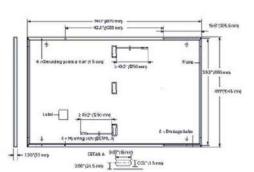


#### ■ Electrical Characteristics

PC	WER CLASS			385	390	395	400	405
М	NIMUM PERFORMANCE AT STANDARD	TEST CONDITIONS, ST	C! (POWER TOLERA	NCE+5W/-OW)				
	Power at MPP <sup>4</sup>	Page	[W]	385	390	395	400	405
**	Short Circuit Current <sup>1</sup>	l <sub>sc</sub>	(A)	11.04	11.07	11.10	11.14	11.17
Ting.	Open Circuit Voltage <sup>1</sup>	Voc	(V)	45.19	45.23	45.27	45.3	45.34
guil.	Current at MPP	Lygop	[A]	10.59	10.65	10.71	10.77	10,83
-	Voltage at MPP	Ver	[V]	36,36	36.62	36,88	37,13	37.39
	Efficiency <sup>1</sup>	η	[%]	≥19.6	≥19.9	≥20.1	≥20.4	≥20.6

#### MINIMUM PERFORMANCE AT NORMAL OPERATING CONDITIONS, NIMOT2

Power at MPP	Page	[W]	288.8	292.6	296,3	3001	303.8
Short Circuit Current	l <sub>sc</sub>	[A]	8,90	8.92	8.95	8.97	9.00
Open Circuit Voltage	Voc	(V)	42.62	42.65	42.69	42.72	42.76
Ourrent at MPP	l <sub>bpp</sub>	[A]	8.35	8.41	8.46	8.51	8.57
Voltage at MPP	V <sub>MP</sub>	[V]	34.59	34.81	35.03	35.25	35.46


### **Qcells PERFORMANCE WARRANTY**

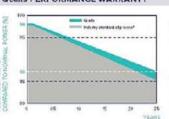

At least 56 % of nominal power during first year. Thereafter max 0.5% degradation per year. At least 93.5% of nominal power up to 10 years. At least 66 % of nominal power up to 25 years.

All data within measurement tolerances. Full warrantes in accordance with the warranty terms of the Qcells sales

organisation of your respective

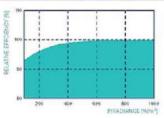

PERFORMANCE AT LOW IRRADIANCE

Typical module performance under low irradiance conditions in comparison to STC conditions (25°C, 1000Wm²).

highest production capacity in 2021 (February 2021)	
TEMPERATURE COEFFICIENTS	

"Standard terms of guarantee for the 5 PV companies with the

TEMPERATURE COEFFICIENTS							
Temperature Coefficient of I <sub>sc</sub>	a	[%/K]	+0.04	Temperature Coefficient of $V_{\infty}$	β	[%/K]	-0.27
Temperature Coefficient of Pur	Y	(%/K)	-0.34	Naminal Module Operating Temperature	NMOT	[F]	109±5.4

#### ■ Properties for System Design

		-			
Maximum System Voltage	Vovs	[9]	1000 (IEC)/1000 (UL)	PV module classification	Class II
Maximum Series Fuse Rating		[A DC]	20	Fire Rating based on ANSI/UL 61730	TYPE 2
Max. Design Load, Push/Pull <sup>2</sup>		[lbs/ff <sup>2</sup> ]	75 (3600 Pa) / 55 (2660 Pa)	Permitted Medule Temperature	-40°F up to +185°F
Man Taskinad Donk (Dolk)		time saids	413 (E 4000 Per 104 (4000 Per	on Cantinuous Duty	(-40°C up to +85°C)



#### s and Certificates











# IQ8 Series Microinverters

INPUT DATA (DC)		108-60-2-05	108PLUS-72-2-US	108M-72-2-US	108A-72-2-US	108H-240-72-2-U\$	108H-208-72-2-US
Commonly used module pairings <sup>2</sup>	W	235 - 350	235 - 440	260 - 460	295 - 500	320 - 540+	295 - 500+
Module compatibility		60-cell/120 half-cell		60-cell/120 half-cell, 6	66-cell/132 half-cell a	and 72-cell/144 half-ce	lle
MPPT voltage range	У	27 - 37	29 - 45	33-45	36 - 45	38 - 45	38 - 45
Operating range	¥	25 - 48			25 - 58		
Min/max start voltage	٧	30 / 48			30 / 58		
Max input DC voltage	٧	50			60		
Max DC current <sup>a</sup> [module lsc]	A			1	15		
Overvoltage class DC port					II		
DC port backfeed current	mA				0		
PV array configuration		IxI Ungrounded a	array; No additional I	DC side protection requ	uired; AC side protect	ion requires max 20A p	er branch circuit
OUTPUT DATA (AC)		1 <b>08-6</b> 0-2-US	IQBPLUS-72-2-US	108M-72-2-US	108A-72-2-US	198H-240-72-2-US	1984-208-72-2-05
Peak output power	VA	245	300	330	366	384	366
Max continuous output power	VA	240	290	325	349	380	360
Nominal (L-L) voltage/range4	y			240 / 211 - 264			208 / 183 - 250
Max continuous output current	A	1.0	1.21	1.35	1.45	1.58	1.73
Nominal frequency	Hz				50		
Extended frequency range	Hz			50	- 68		
AC short circuit fault current over 3 cycles	Arms			2			4.4
Max units per 20 A (L-L.) branch circuit <sup>s</sup>	5	16	13	11	11	10	9
Total harmonic distortion				4	5%		
Overvoltage class AC port					m.		
AC port backfeed current	mA			3	50		
Power factor setting				1	.0		
Grid-tied power factor (adjustable)				0.85 leading	- 0.85 lagging		
Peak efficiency	%	97.5	97.6	97.6	97.6	97.6	97.4
CEC weighted efficiency	%	97	97	97	97.5	97	97
Night-time power consumption	mW			6	50		
MECHANICAL DATA							
Ambient temperature range				-40°C to +60°C	(-40°F to +140°F)		
Relative humidity range				4% to 100%	(condensing)		
DC Connector type				M	C4		
Dimensions (HxWxD)				212 mm (8.3") x 175 mm	n (6.9°) x 30.2 mm (1.2	2")	
Weight				1.08 kg	(2.38 lbs)		
Cooling				Natural conve	ection - no fans		
Approved for wet locations				γ	'es		
Pollution degree				P	D3		
Enclosure			Class II d	ouble-insulated, corros	ion resistant polymer	ic enclosure	
Environ, category / UV exposure rating				NEMA Type	6 / outdoor		
COMPLIANCE							
		CA Rule 21 (UL 1741-5	SA), UL 62109-1, ULI	741/IEEE1547, FCC Part	15 Class B, ICES-000	03 Class B, CAN/CSA-	C22.2 NO. 107.1-01
Certifications			18 Rule 64-218 Rapi	ut Down Equipment and d Shutdown of PV Syste			

(1) The IQBH-208 variant will be operating in grid-tied mode only at 208V AC. (2) No enforced DC/AC ratio. See the compatibility calculator at https://link.enphase.com/module-compatibility (3) Maximum continuous input DC current is 10.6A (4) Nominal voltage range can be extended beyond nominal if required by the utility. (5) Limits may vary. Refer to local requirements to define the number of microinverters per branch in your area.

IQ8SE-DS-0001-01-EN-US-2022-03-17

ATLANTIC KEY ENERGY LLC 12600 CHALLENGER PARKWAY

SUITE 200 ORLANDO, FL 32826 1 (407) 988-0273

**PLACI** PROJECT # P-0074754 SOUTHWEST OLEANDER MARIANNE JOHNSON RESIDENCE LAKE CITY, FL

SIGNATURE WITH SEAL

615

REVISIONS DESCRIPTION DATE REV

SHEET NAME **EQUIPMENT** 

04/24/2023

**SPECIFICATIONS** SHEET NUMBER

E-3

THIS ITEM HAS BEEN DIGITALLY SIGNED AND SEALED BY OMARPUT in consideration of the global environment. TIRADO ON THE DATE ADJACENT TO THE SEAL PRINTED COPIES TO BOTTO FOR THE FLOOR INSTITUTE OF THE PRODUCT OF THE SEAL PRINTED COPIES TO BOTTO FOR THE FLOOR INSTITUTE OF THE PRODUCT OF THIS DOCUMENT ARE NOT CONSIDERED SIGNED AND SEAL, AND THE SIGNATURE MUST BE VERIFIED ON ANY ELECTRONIC COPIES

# BONAL ENGINEER

THIS ITEM HAS BEEN DIGITALLY SIGNED AND SEALED BY OMAR TIRADO ON THE DATE ADJACENT TO THE SEAL. PRINTED COPIES OF THIS DOCUMENT ARE NOT CONSIDERED SIGNED AND SEAL, AND THE SIGNATURE MUST BE VERIFIED ON ANY ELECTRONIC COPIES

# Enphase IQ Combiner 4/4C

MODEL NUMBER	
IQ Combiner 4 (X IQ-AM1 240-4)	Q Combiner 4 with Emphase IQ Gateway printed circuit board for integrated revenue grade PV production metering (AN C12.20 +/-0.5%) and consumption monitoring (+/-2.5%). Includes a silver solar shield to match the IQ Battery system at IQ System Controller 2 and to defect heat.
IQ Combiner 4C (X-IQ-AM1-240-4C)	Q Combiner 4C with Enphase IQ Gateway printed circuit board for integrated revenue grade PV production metering (ANSI 012.20 ±/-0.5%) and consumption monitoring (±/-2.5%). Includes Enphase Mobile Connect cellular modem (CELLMODEM-MT-06-SP-05), a plug-and-play industrial-grade cell modem for systems up to 60 microinverters. (Available in the US, Canada, Mexico, Puerto Rico, and the US Virgin Islands, where there is adequate cellular service in the installation area.) Includes a silver solar shield to match the IQ Battery and IQ System Controller and to deflect hea
ACCESSORIES AND REPLACEMENT PARTS	(not included, order separately)
Ensemble Communications Kit COMMS-CELLMODEM-M1-06 CELLMODEM-M1-06-SP-05 CELLMODEM-M1-06-AT-05	<ul> <li>Includes COMMS-KIT-01 and CELLMODEM-M1-06-SP-05 with 5-year Sprint data plan for Ensemble sites</li> <li>4G based LTE-M1 cellular modern with 5-year Sprint data plan</li> <li>4G based LTE-M1 cellular modern with 5-year AT&amp;T data plan</li> </ul>
Circuit Breakers BRK-10A-2-240V BRK-15A-2-240V BRK-20A-2P-240V BRK-15A-2P-240V-B BRK-20A-2P-240V-B	Supports Eaton BR210, BR215, BR220, BR230, BR240, BR250, and BR260 circuit breakers. Circuit breaker, 2 pole, 16A, Eaton BR216 Circuit breaker, 2 pole, 16A, Eaton BR215 Circuit breaker, 2 pole, 20A, Eaton BR220 Circuit breaker, 2 pole, 15A, Eaton BR2158 with hold down kit support Circuit breaker, 2 pole, 26A, Eaton BR2208 with hold down kit support
EPLC-01	Power line carrier (communication bridge pair), quantity - one pair
XA-SOLARSHIELD-ES	Replacement solar shield for IQ Combiner 4/4C
XA-PLUG-120-3	Accessory receptacle for Power Line Carrier in IQ Combiner 4/4C (required for EPLC-01)
XA-ENV-PCBA-3	Replacement IQ Gateway printed circuit board (PCB) for Combiner 4/4C
X-IQ-NA-HD-125A	Hold down kit for Eaton circuit breaker with screws.
ELECTRICAL SPECIFICATIONS	
Rating	Continuous duty
System voltage	120/240 VAC, 60 Hz
Eaton BR series busbar rating	125 A
Max. continuous current rating	65A
Max. continuous current rating (input from PV/storage)	64 A
Max. fuse/circult rating (output)	90 A
Branch circuits (solar and/or storage)	Up to four 2-pole Eaton BR series Distributed Generation (DG) breakers only (not included)
Max. total branch circuit breaker rating (input)	80A of distributed generation / 95A with IQ Geteway breaker included
Production metering CT	200 A solid core pre-installed and wired to IQ Gateway
Consumption monitoring CT (CT-200-SPLIT)	A pair of 200 A split core current transformers
MECHANICAL DATA	
Dimensions (WxHxD)	37.5 x 49.5 x 16.8 cm (14.75" x 19.5" x 6.63"). Height is 21.06" (53.5 cm) with mounting brackets.
Weight	7.5 kg (16.5 lbs)
Ambient temperature range	-40° Cto +46° C (-40° to 115° F)
Cooling	Natural convection, plus heat shield
Enclosure environmental rating	Outdoor, NRTL-certified, NEMA type 3R, polycarbonate construction
Wire sizes	20 A to 50 A breaker inputs: 14 to 4 AWG copper conductors 60 A breaker branch input: 4 to 1/0 AWG copper conductors Main lug combined output: 10 to 2/0 AWG copper conductors Neutral and ground: 14 to 1/0 copper conductors Always follow local code requirements for conductor sixing.
Altitude	To 2000 meters (6,560 feet)
INTERNET CONNECTION OPTIONS	
Integrated Wi-Fi	802.11b/g/n
Cellular	CELLMODEM-M1-D6-SP-05, CELLMODEM-M1-06-AT-05 (4G based LTE-M1 cellular modern). Note that an Enphase Mobile Connect cellular modern is required for all Ensemble installations.
Ethernet	Optional, 802.3, Cat5E (or Cat 6) UTP Ethernet cable (not included)
COMPLIANCE	
Compliance, Q Combiner	UL 1741, CAN/CSA C22.2 No. 107.1, 47 CFR, Part 15, Class B, ICES 003 Production metering: ANSI C12.20 accuracy class 0.5 (PV production) Consumption matering: accuracy class 2.5
Compliance, Q Gateway	UL 60601-1/CANCSA 22.2 No. 61010-1

#### To learn more about Enphase offerings, visit enphase.com

© 2021 Enphase Energy, All rights reserved. Enphase, the Enphase logo, IQ Combiner 4/4C, and other names are trademarks of Enphase Energy, Inc. Data subject to change. 10-21-2021



ATLANTIC KEY ENERGY LLC
12600 CHALLENGER PARKWAY
SUITE 200

SUITE 200 ORLANDO, FL 32826 1 (407) 988-0273

Lumio \*
PROJECT NAME & ADDRESS

MARIANNE JOHNSON RESIDENCE PROJECT # P-0074754 615 SOUTHWEST OLEANDER PLACE LAKE CITY, FL 32025

SIGNATURE WITH SEAL

REVISIONS
DESCRIPTION DATE REV

e: 04/24/2023

ENPHASE.

SHEET NAME
EQUIPMENT

SPECIFICATIONS
SHEET NUMBER

E-4