



AMERICAN TOWER®

ATC SITE NAME: COLUMBIA - NEXTEL BTS

ATC SITE NUMBER: 21806

VERIZON SITE NAME: ATC COLUMBIA

VERIZON SITE NUMBER:131312

SITE ADDRESS: 3969 SW TUSTENUGGEE AVE

LAKE CITY, FL 32024



LOCATION MAP

VERIZON ANTENNA AMENDMENT DRAWINGS

COMPLIANCE CODE	PROJECT SUMMARY	PROJECT DESCRIPTION		SHEET INDEX			
ALL WORK SHALL BE PERFORMED AND MATERIALS INSTALLED IN ACCORDANCE WITH THE CURRENT EDITIONS OF THE	SITE ADDRESS:	THE PROPOSED PROJECT INCLUDES MODIFYING GROUND BASED AND TOWER MOUNTED EQUIPMENT AS INDICATED PER BELOW:	SHEET NO:	DESCRIPTION:	REV:	DATE:	BY:
FOLLOWING CODES AS ADOPTED BY THE LOCAL GOVERNMENT AUTHORITIES. NOTHING IN THESE PLANS IS		REMOVE (6) ANTENNA(s), (6) RRH(s), (2) DIPLEXER(s), AND (1) 1 5/8" COAX CABLE(s)	G-001	TITLE SHEET	1	09/13/21	LR
TO BE CONSTRUED TO PERMIT WORK NOT CONFORMING TO THESE CODES.	COUNTY: COLUMBIA	INSTALL (3) ANTENNA(s), (6) RRH(s), (1) OVP(s), AND (1) 12X24 HYBRID CABLE(s)	G-002	GENERAL NOTES	0	09/02/21	JP
1. 2020 FLORIDA BUILDING CODE, 7TH EDITION	GEOGRAPHIC COORDINATES:	EXISTING (6) ANTENNA(s), (1) OVP(s), (6) 1 5/8" COAX CABLE(s), AND (1) 6X12	C-101	DETAILED SITE PLAN	0	09/02/21	JP
ANSI/TIA-222-H 6TH EDITION FLORIDA FIRE PREVENTION CODE (NFPA 70)	LATITUDE: 30.08611107	HYBRID CABLE(s) TO REMAIN	C-102	DETAILED SITE PLAN	0	09/02/21	JP
4. 2017 NATIONAL ELECTRICAL CODE 5. BASIC WIND SPEED: 125 MPH (3-SECOND GUST)	LONGITUDE: -82.64020538	GROUND WORK: REMOVE (1) 6201 CABINET(S), (1) GENERATOR, (1) ATS(S), (1) PPC(S), AND	C-201	TOWER ELEVATION	0	09/02/21	JP
6. CITY/COUNTY ORDINANCES	GROUND ELEVATION: 96' AMSL	SUBPANEL(S).	C-401	ANTENNA INFORMATION & SCHEDULE	0	09/02/21	JP
		NSTALL (1) CONSOLIDATED EQUIPMENT, PAD EXPANSION AND POWER CABINET(S), (1) 50KW GENERATOR(S), (1) 200A ILC(S)	C-501	CONSTRUCTION DETAILS	0	09/02/21	JP
		PROJECT NOTES	E-101	CONDUIT LAYOUT	0	09/02/21	JP
		THE FACILITY IS UNMANNED. A TECHNICIAN WILL VISIT THE SITE APPROXIMATELY ONCE A	E-501 GROUNDING DETAILS		0	09/02/21	JP
	PROJECT TEAM	MONTH FOR ROUTINE INSPECTION AND MAINTENANCE. 3. THE PROJECT WILL NOT RESULT IN ANY SIGNIFICANT LAND	E-601	ONE-LINE DIAGRAM	1	09/13/21	LR
	TOWER OWNER: APPLICANT: AMERICAN TOWER VERIZON WIRELESS 10 PRESIDENTIAL WAY WOBURN, MA 01801	DISTURBANCE OR EFFECT OF STORM WATER DRAINAGE. 4. NO SANITARY SEWER, POTABLE WATER OR TRASH DISPOSAL	E-602	PANEL SCHEDULE AND ELECTRICAL DETAILS	0	09/02/21	JP
		IS REQUIRED. 5. HANDICAP ACCESS IS NOT REQUIRED. 6. THE PROJECT DEPICTED IN THESE PLANS QUALIFIES AS AN ELIGIBLE FACILITIES REQUEST ENTITLED TO EXPEDITED REVIEW UNDER 47 U.S.C. § 1455(A) AS A MODIFICATION OF AN	R-601	SUPPLEMENTAL			
			R-602	SUPPLEMENTAL			
UTILITY COMPANIES	ENGINEER:	EXISTING WIRELESS TOWER THAT INVOLVES THE COLLOCATION, REMOVAL, AND/OR REPLACEMENT OF	R-603	SUPPLEMENTAL			
POWER COMPANY: CLAY ELECTRIC COORPERATION PHONE: (352) 728-9800	ATC TOWER SERVICES, LLC	TRANSMISSION EQUIPMENT THAT IS NOT A SUBSTANTIAL CHANGE UNDER CFR § 1.61000 (B)(7).					
TELEPHONE COMPANY: BELLSOUTH	3500 REGENCY PKWY STE 100 CARY, NC 27518	PROJECT LOCATION DIRECTIONS					
PHONE: (800) 252-0803	PROPERTY OWNER:	FROM NEXTEL'S OFFICE, GO SOUTH ON PHILIPS HWY. TO I-95 AND TAKE I-95 TO I-295 NORTH, GO APPX, 12 MILES TO I-10					
677	AUBREY BAILEY	WEST TOWARDS LAKE CITY. TAKE EXIT 303 OFF OF I-10 ON TO HWY 441 AND GO SOUTH ON 441 TO LAKE CITY APPX. 4 MILES					
X11	3969 SW TUSTENUGGEE AVE LAKE CITY, FL 32024	TO DOWNTOWN LAKE CITY. CONTINUE SOUTH ON HWY 441 APPRX. 3.5 MILES TO HWY 131 AND TURN RIGHT ONTO HWY					
		131. GO 2.5 MILES UNTIL IT CROSSES I-75 AND CONTINUE ON					
		131 FOR APPROX. 1500'. TURN LEFT (PECAN ORCHARD WILL BE ON YOUR RIGHT) GO THROUGH CATTLE GATE AND CROSS THE PASTURE. SITE IS ON THE NORTH SIDE OF THE PASTURE NEAR					
Know what's below. Call before you dig.		THE TREELINE. IT IS BETWEEN HWY 131 AND I-75 APPRX. 150'					
Can before you dig.		EAST OF THE POWER LINES ON THE NORTH SIDE OF THE PASTURE NEXT TO THE TREE LINE.					



ATC TOWER SERVICES, LLC

3500 REGENCY PARKWAY SUITE 100 CARY, NC 27518 PHONE: (919) 468-0112 COA: 9053

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REV.	DESCRIPTION	BY	DATE
\triangle_{-}	FOR CONSTRUCTION	<u></u>	09/02/21
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ATC SITE NAME: **COLUMBIA - NEXTEL BTS**

VERIZON SITE NAME:

ATC COLUMBIA

SITE ADDRESS: 3969 SW TUSTENUGGEE AVE



verizon vigr

DATE DRAWN:	09/02/21
ATC JOB NO:	13692328_D1
CUSTOMER ID:	ATC COLUMBIA
CUSTOMER #:	131312

TITLE SHEET

SHEET NUMBER: G-001 REVISION:

GENERAL CONSTRUCTION NOTES:

- OWNER FURNISHED MATERIALS, VERIZON "THE COMPANY" WILL PROVIDE AND THE CONTRACTOR WILL INSTALL
- BTS EQUIPMENT FRAME (PLATFORM) AND ICEBRIDGE SHELTER (GROUND BUILD/CO-LOCATE ONLY)
 - B. AC/TELCO INTERFACE BOX (PPC)
 - C. ICE BRIDGE (CABLE TRAY WITH COVER) (GROUND BUILD/CO-LOCATE ONLY, GC TO FURNISH AND INSTALL FOR ROOFTOP INSTALLATION)
- D. TOWERS, MONOPOLES
- E. TOWER LIGHTING
- F. GENERATORS & LIQUID PROPANE TANK
- G. ANTENNA STANDARD BRACKETS, FRAMES AND PIPES FOR MOUNTING
- H. ANTENNAS (INSTALLED BY OTHERS)
- I. TRANSMISSION LINE
- J. TRANSMISSION LINE JUMPERS
- K. TRANSMISSION LINE CONNECTORS WITH WEATHERPROOFING KITS
- L. TRANSMISSION LINE GROUND KITS
- M. HANGERS
- N. HOISTING GRIPS
- O. BTS EQUIPMENT
- 2. THE CONTRACTOR IS RESPONSIBLE TO PROVIDE ALL OTHER MATERIALS FOR THE COMPLETE INSTALLATION OF THE SITE INCLUDING, BUT NOT LIMITED TO, SUCH MATERIALS AS FENCING, STRUCTURAL STEEL SUPPORTING SUB-FRAME FOR PLATFORM, ROOFING LABOR AND MATERIALS, GROUNDING RINGS, GROUNDING WIRES, COPPER-CLAD OR NIT CHEMICAL GROUND ROD(S), BUSS BARS, TRANSFORMERS AND DISCONNECT SWITCHES WHERE APPLICABLE, TEMPORARY ELECTRICAL POWER, CONDUIT, LANDSCAPING COMPOUND STONE, CRANES, CORE DRILLING, SLEEPERS AND RUBBER MATTING, REBAR, CONCRETE CAISSONS, PADS AND/OR AUGER MOUNTS, MISCELLANEOUS FASTENERS, CABLE TRAYS, NON-STANDARD ANTENNA FRAMES AND ALL OTHER MATERIAL AND LABOR REQUIRED TO COMPLETE THE JOB ACCORDING TO THE DRAWINGS AND SPECIFICATIONS. IT IS THE POSITION OF VERIZON TO APPLY FOR PERMITTING AND CONTRACTOR RESPONSIBLE FOR PICKUP AND PAYMENT OF REQUIRED PERMITTING AND CONTRACTOR RESPONSIBLE FOR PICKUP AND PAYMENT OF REQUIRED
- ALL WORK SHALL CONFORM TO ALL CURRENT APPLICABLE FEDERAL, STATE, AND LOCAL CODES, INCLUDING ANSI/EIA/TIA-222, AND COMPLY WITH ATC CONSTRUCTION SPECIFICATIONS.
- 4. CONTRACTOR SHALL CONTACT LOCAL 811 FOR IDENTIFICATION OF UNDERGROUND
- 5. CONTRACTOR SHALL BE RESPONSIBLE FOR COORDINATING ALL REQUIRED
- ALL DIMENSIONS TO, OF, AND ON EXISTING BUILDINGS, DRAINAGE STRUCTURES, AND SITE IMPROVEMENTS SHALL BE VERIFIED IN FIELD BY CONTRACTOR WITH ALL DISCREPANCIES REPORTED TO THE ENGINEER.
- 7. DO NOT CHANGE SIZE OR SPACING OF STRUCTURAL ELEMENTS
- 8. DETAILS SHOWN ARE TYPICAL; SIMILAR DETAILS APPLY TO SIMILAR CONDITIONS UNLESS
- THESE DRAWINGS DO NOT INCLUDE NECESSARY COMPONENTS FOR CONSTRUCTION SAFETY WHICH SHALL BE THE SOLE RESPONSIBILITY OF THE CONTRACTOR.
- CONTRACTOR SHALL BRACE STRUCTURES UNTIL ALL STRUCTURAL ELEMENTS NEEDED FOR STABILITY ARE INSTALLED. THESE ELEMENTS ARE AS FOLLOWS: LATERAL BRACING, ANCHOR BOLTS, ETC.
- 11. CONTRACTOR SHALL DETERMINE EXACT LOCATION OF EXISTING UTILITIES, GROUNDS DRAINS, DRAIN PIPES, VENTS, ETC. BEFORE COMMENCING WORK.
- 12. INCORRECTLY FABRICATED, DAMAGED, OR OTHERWISE MISFITTING OR NONCONFORMING MATERIALS OR CONDITIONS SHALL BE REPORTED TO THE VERIZON REP PRIOR TO REMEDIAL OR CORRECTIVE ACTION. ANY SUCH REMEDIAL ACTION SHALL REQUIRE WRITTEN APPROVAL BY THE VERIZON REP PRIOR TO PROCEEDING.
- 13. EACH CONTRACTOR SHALL COOPERATE WITH THE VERIZON REP, AND COORDINATE HIS WORK WITH THE WORK OF OTHERS.
- CONTRACTOR SHALL REPAIR ANY DAMAGE CAUSED BY CONSTRUCTION OF THIS
 PROJECT TO MATCH EXISTING PRE-CONSTRUCTION CONDITIONS TO THE SATISFACTION
 OF THE VERIZON CONSTRUCTION MANAGER
- 15. ALL CABLE/CONDUIT ENTRY/EXIT PORTS SHALL BE WEATHERPROOFED DURING INSTALLATION LISING A SILICONE SEALANT
- WHERE EXISTING CONDITIONS DO NOT MATCH THOSE SHOWN IN THIS PLAN SET, CONTRACTOR SHALL NOTIFY THE VERIZON REP AND ENGINEER OF RECORD IMMEDIATELY.
- 17. CONTRACTOR SHALL ENSURE ALL SUBCONTRACTORS ARE PROVIDED WITH A COMPLETE AND CURRENT SET OF DRAWINGS AND SPECIFICATIONS FOR THIS PROJECT.
- 18. CONTRACTOR SHALL REMOVE ALL RUBBISH AND DEBRIS FROM THE SITE AT THE END OF
- CONTRACTOR SHALL COORDINATE WORK SCHEDULE WITH AMERICAN TOWER CORPORATION (ATC), AND TAKE PRECAUTIONS TO MINIMIZE IMPACT AND DISRUPTION OF OTHER OCCUPANTS OF THE FACILITY.
- CONTRACTOR SHALL FURNISH VERIZON AND AMERICAN TOWER CORPORATION (ATC)
 WITH A PDF MARKED UP AS-BUILT SET OF DRAWINGS UPON COMPLETION OF WORK.
- PRIOR TO SUBMISSION OF BID, CONTRACTOR SHALL COORDINATE WITH VERIZON REP TO DETERMINE WHAT, IF ANY, ITEMS WILL BE PROVIDED. ALL ITEMS NOT PROVIDED SHALL BE PROVIDED AND INSTALLED BY THE CONTRACTOR. CONTRACTOR WILL INSTALL ALL ITEMS PROVIDED.

- 22. PRIOR TO SUBMISSION OF BID, CONTRACTOR SHALL COORDINATE WITH VERIZON REP TO DETERMINE IF ANY PERMITS WILL BE OBTAINED BY CONTRACTOR. ALL REQUIRED PERMITS NOT OBTAINED BY VERIZON MUST BE OBTAINED, AND PAID FOR, BY THE CONTRACTOR.
- CONTRACTOR SHALL INSTALL ALL SITE SIGNAGE IN ACCORDANCE WITH VERIZON SPECIFICATIONS AND REQUIREMENTS.
- 24. CONTRACTOR SHALL SUBMIT ALL SHOP DRAWINGS TO VERIZON FOR REVIEW AND APPROVAL PRIOR TO FABRICATION.
- 25. ALL EQUIPMENT SHALL BE INSTALLED ACCORDING TO MANUFACTURER'S SPECIFICATIONS AND LOCATED ACCORDING TO VERIZON SPECIFICATIONS, AND AS SHOWN IN THESE PLANS
- 26. THE CONTRACTOR SHALL SUPERVISE AND DIRECT THE PROJECT DESCRIBED HEREIN. THE CONTRACTOR SHALL BE SOLELLY RESPONSIBLE FOR ALL THE CONSTRUCTION MEANS, METHODS, TECHNIQUES, SEQUENCES AND PROCEDURES AND FOR COORDINATING ALL PORTIONS OF THE WORK UNDER THE CONTRACT.
- 27. CONTRACTOR SHALL NOTIFY VERIZON REP A MINIMUM OF 48 HOURS IN ADVANCE OF POURING CONCRETE OR BACKFILLING ANY UNDERGROUND UTILITIES, FOUNDATIONS OR SEALING ANY WALL, FLOOR OR ROOF PENETRATIONS FOR ENGINEERING REVIEW AND APPROVAL
- CONTRACTOR SHALL BE RESPONSIBLE FOR SITE SAFETY INCLUDING COMPLIANCE WITH ALL APPLICABLE OSHA STANDARDS AND RECOMMENDATIONS AND SHALL PROVIDE ALL NECESSARY SAFETY DEVICES INCLUDING PPE AND PPM AND CONSTRUCTION DEVICES SUCH AS WELDING AND FIRE PREVENTION, TEMPORARY SHORING, SCAFFOLDING, TRENCH BOXESSLOPING, BARRIERS, ETC.
- 29. THE CONTRACTOR SHALL PROTECT AT HIS OWN EXPENSE, ALL EXISTING FACILITIES AND SUCH OF HIS NEW WORK LIABLE TO INJURY DURING THE CONSTRUCTION PERIOD. ANY DAMAGE CAUSED BY NEGLECT ON THE PART OF THIS CONTRACTOR OR HIS REPRESENTATIVES, OR BY THE ELEMENTS DUE TO NEGLECT ON THE PART OF THIS CONTRACTOR OR HIS REPRESENTATIVES, EITHER TO THE EXISTING WORK, OR TO HIS WORK OR THE WORK OF ANY OTHER CONTRACTOR, SHALL BE REPAIRED AT HIS EXPENSE TO THE OWNER'S SATISFACTION.
- 30. ALL WORK SHALL BE INSTALLED IN A FIRST CLASS, NEAT AND WORKMANLIKE MANNER BY MECHANICS SKILLED IN THE TRADE INVOLVED. THE QUALITY OF OWNKMANSHIP SHALL BE SUBJECT TO THE APPROVAL OF THE VERIZON REP. ANY WORK FOUND BY THE VERIZON REP TO BE OF INFERIOR QUALITY AND/OR WORKMANSHIP SHALL BE REPLACED AND/OR REWORKED AT CONTRACTOR EXPENSE UNTIL APPROVAL IS ORTAINED.
- 31. IN ORDER TO ESTABLISH STANDARDS OF QUALITY AND PERFORMANCE, ALL TYPES OF MATERIALS LISTED HEREINAFTER BY MANUFACTURER'S NAMES AND/OR MANUFACTURER'S CATALOG NUMBER SHALL BE PROVIDED BY THESE MANUFACTURERS AS SPECIFIED
- 32. VERIZON FURNISHED EQUIPMENT SHALL BE PICKED-UP AT THE VERIZON WAREHOUSE. NO LATER THAN 48HR AFTER BEING NOTIFIED INSURED, STORED, UNCRATE, PROTECTED AND INSTALLED BY THE CONTRACTOR WITH ALL APPURTENANCES REQUIRED TO PLACE THE EQUIPMENT IN OPERATION, READY FOR USE. THE CONTRACTOR SHALL BE RESPONSIBLE FOR THE EQUIPMENT AFTER PICKING IT UP.
- 33. VERIZON OR HIS ARCHITECT/ENGINEER RESERVES THE RIGHT TO REJECT ANY EQUIPMENT OR MATERIALS WHICH, IN HIS OWN OPINION ARE NOT IN COMPLIANCE WITH THE CONTRACT DOCUMENTS, EITHER BEFORE OR AFTER INSTALLATION AND THE EQUIPMENT SHALL BE REPLACED WITH EQUIPMENT CONFORMING TO THE REQUIREMENTS OF THE CONTRACT DOCUMENTS BY THE CONTRACTOR AT NO COST TO VERIZON OR THEIR ARCHITECT/ENGINEER.

SPECIAL CONSTRUCTION ANTENNA INSTALLATION NOTES:

- WORK INCLUDED:
 - A. ANTENNA AND COAXIAL CABLES ARE FURNISHED BY VERIZON UNDER A SEPARATE CONTRACT. THE CONTRACTOR SHALL ASSIST ANTENNA INSTALLATION CONTRACTOR IN TERMS OD COORDINATION AND SITE ACCESS. ERECTION SUBCONTRACTOR SHALL BE RESPONSIBLE FOR THE PROTECTION OF PERSONNEL AND
 - B. INSTALL ANTENNA AS INDICATE ON DRAWINGS AND VERIZON SPECIFICATIONS
 - C. INSTALL GALVANIZED STEEL ANTENNA MOUNTS AS INDICATED ON DRAWINGS
 - D. INSTALL FURNISHED GALVANIZED STEEL OR ALUMINUM WAVEGUIDE
 - E. CONTRACTOR SHALL PROVIDE FOUR (4) SETS OF SWEEP TESTS USING ANRITZU-PACKARD 8713B RF SCALAR NETWORK ANALYZER. SUBMIT FREQUENCY DOMAIN REFLECTOMETER(FDR) TESTS RESULTS TO THE PROJECT MANAGER. SWEEP TESTS SHALL BE AS PER ATTACHED RFS "MINIMUM FIELD TESTING RECOMMENDED FOR ANTENNA AND HELIAX COAXIAL CABLE SYSTEMS" DATED 105/93. TESTING SHALL BE PERFORMED BY AN INDEPENDENT TESTING SERVICE AND BE BOUND AND SUBMITTED WITHIN ONE WEEK OF WORK COMPLETION.
 - F. INSTALL COAXIAL CABLES AND TERMINATING BETWEEN ANTENNAS AND EQUIPMENT PER MANUFACTURER'S RECOMMENDATIONS. WEATHERPROOF ALL CONNECTIONS BETWEEN THE ANTENNA AND EQUIPMENT PER MANUFACTURER'S REQUIREMENTS. TERMINATE ALL COAXIAL CABLE THREE (3) FEET IN EXCESS OF ENTRY PORT LOCATION LINESS OTHERWISE STATED.
 - G. ANTENNA AND COAXIAL CABLE GROUNDING:
- 2. ALL EXTERIOR #6 GREED GROUND WIRE "DAISY CHAIN" CONNECTIONS ARE TO BE WEATHER SEALED WITH RFS CONNECTORS/SPLICE WEATHERPROOFING KIT #221213 OR FOLIAL
- ALL COAXIAL CABLE GROUNDING KITS ARE TO BE INSTALLED ON STRAIGHT RUNS OF COAXIAL CABLE (NOT WITHIN BENDS)

ALL DISCREPANCIES FROM WHAT IS SHOWN ON THESE
CONSTRUCTION DRAWINGS SHALL BE COMMUNICATED TO ATC
ENGINEERING IMMEDIATELY FOR CORRECTION OR RE-DESIGN.
FAILURE TO COMMUNICATE DIRECTLY WITH ATC ENGINEERING OR
ANY CHANGES FROM THE DESIGN CONDUCTED WITHOUT PRIOR
APPROVAL FROM ATC ENGINEERING SHALL BE THE SOLE
RESPONSIBILITY OF THE GENERAL CONTRACTOR.



3500 REGENCY PARKWAY SUITE 100 CARY, NC 27518 PHONE: (919) 468-0112 COA: 9053

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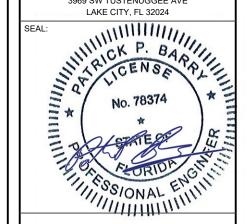
ATC SITE NUMBER: 21806

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COLUMBIA - NEXTEL BTS

VERIZON SITE NAME:

ATC COLUMBIA

SITE ADDRESS: 3969 SW TUSTENUGGEE AVE LAKE CITY, FL 32024





DATE DRAWN:	09/02/21
ATC JOB NO:	13692328_D1
CUSTOMER ID:	ATC COLUMBIA
CUSTOMER #:	131312

GENERAL NOTES

SHEET NUMBER:

REVISION

G-002

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SITE PLAN NOTES:

TRN


- THIS SITE PLAN REPRESENTS THE BEST PRESENT KNOWLEDGE AVAILABLE TO THE ENGINEER AT THE TIME OF THIS DESIGN. THE CONTRACTOR SHALL VISIT THE SITE PRIOR TO CONSTRUCTION AND VERIFY ALL EXISTING CONDITIONS RELATED TO THE SCOPE OF WORK FOR THIS PROJECT
- ICE BRIDGE, CABLE LADDER, COAX PORT, AND COAX CABLE ARE SHOWN FOR REFERENCE ONLY, CONTRACTOR SHALL CONFIRM THE EXACT LOCATION OF ALL PROPOSED AND EXISTING EQUIPMENT AND STRUCTURES DEPICTED ON THIS PLAN. BEFORE UTILIZING EXISTING CABLE SUPPORTS, COAX PORTS, INSTALLING NEW PORTS OR ANY OTHER EQUIPMENT, CONTRACTOR SHALL VERIFY ALL ASPECTS OF THE COMPONENTS MEET THE ATC SPECIFICATIONS.
- IT IS THE RESPONSIBILITY OF THE CONTRACTOR TO COORDINATE WITH THE VERIZON REPRESENTATIVE AND LOCAL UTILITY COMPANY FOR THE INSTALLATION OF CONDUITS, CONDUCTORS, BREAKERS, DISCONNECTS, OR ANY OTHER EQUIPMENT REQUIRED FOR ELECTRICAL SERVICE. ALL ELECTRICAL WORK SHALL BE PERFORMED IN ACCORDANCE WITH LATEST EDITION OF THE STATE AND NATIONAL CODES, ORDINANCES AND REGULATIONS APPLICABLE TO THIS PROJECT.

LEGEND

GROUNDING TEST WELL AUTOMATIC TRANSFER SWITCH ATS **BOLLARD** CSC CELL SITE CABINET D DISCONNECT ELECTRICAL **FIBER** GEN **GENERATOR** GENERATOR RECEPTACAL HH, V HAND HOLE, VAULT ΙB ICE BRIDGE KENTROX BOX LC LIGHTING CONTROL M METER PB PULL BOX PΡ POWER POLE TELCO.


TRANSFORMER

CHAINLINK FENCE

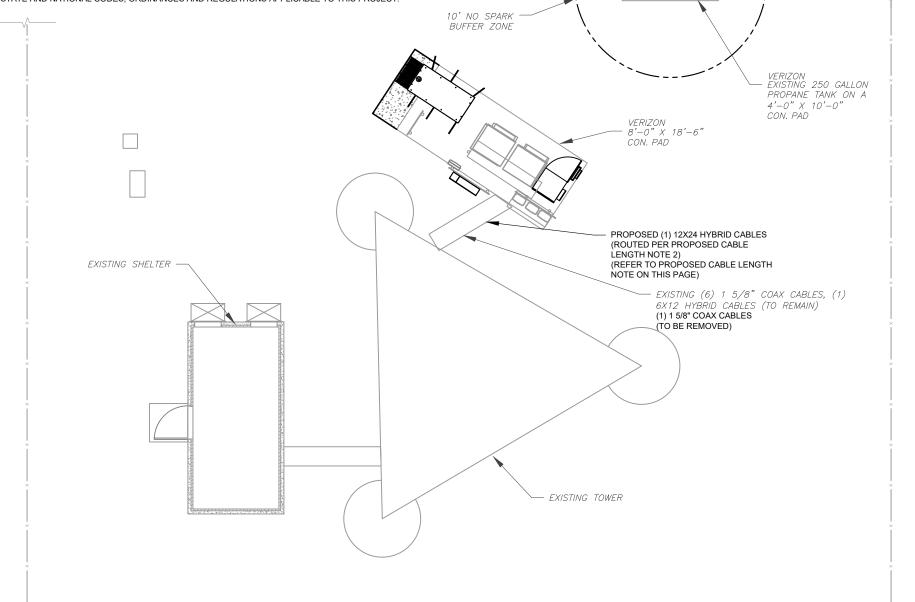

PROPOSED CABLE LENGTH:

- ESTIMATED LENGTH OF PROPOSED CABLE IS <u>280'</u>. ESTIMATED LENGTH OF CABLE WAS PROVIDED BY CUSTOMER OR CALCULATED BY ADDING THE RAD CENTER AND THE DISTANCE FROM THE SHELTER ENTRY PLATE TO THE TOWER (ALONG THE ICE BRIDGE) AND A SAFETY FACTOR MEASUREMENT OF 15% (OF THE TWO PREVIOUS VALUES), CDS DEFER TO GREATEST CABLE LENGTH.
- ROUTE PROPOSED CABLES ALONG SAME PATH AS EXISTING CABLES AND IN ACCORDANCE WITH STRUCTURAL ANALYSIS. WHERE POSSIBLE UTILIZE EXISTING CABLE SUPPORT STRUCTURES AS PROVIDED FOR CARRIER TO ADEQUATELY SECURE CABLES, USING EITHER APPROPRIATELY SIZED STAINLESS STEEL SNAP-INS OR MOUNTING HARDWARE AND BRACKETS AS SPECIFIED BY CABLE MANUFACTURER. OTHERWISE, ATTACH CABLES TO HORIZONTAL OR DIAGONAL TOWER MEMBERS USING PROPOSED STAINLESS STEEL ADAPTERS (DO NOT ATTACH TO TOWER LEG)

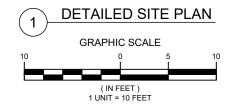





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SITE ADDRESS: 3969 SW TUSTENUGGEE AVE

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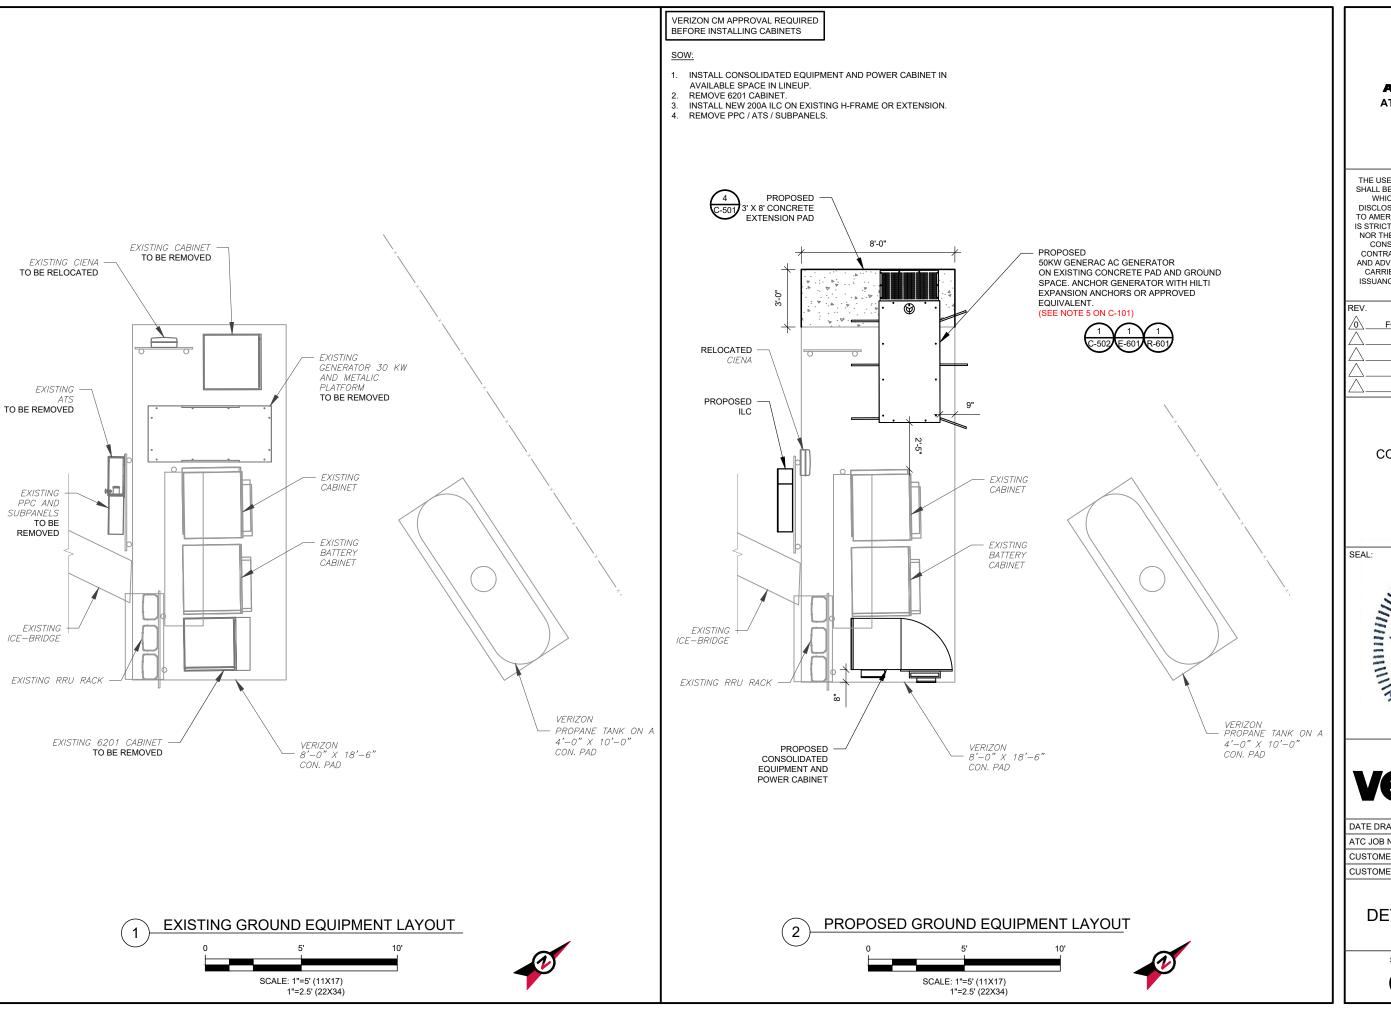
DATE DRAWN:	09/02/21
ATC JOB NO:	13692328_D1
CUSTOMER ID:	ATC COLUMBIA
CUSTOMER #:	131312

DETAILED SITE PLAN

SHEET NUMBER:

C-101

REVISION





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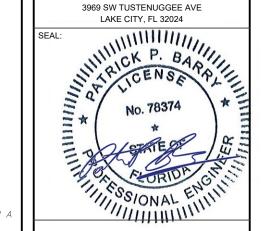
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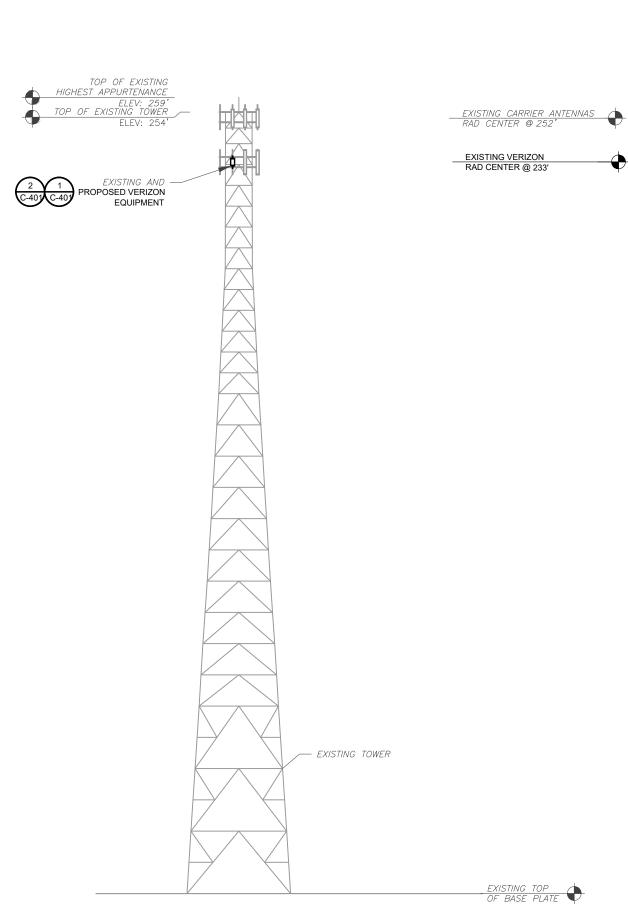
DETAILED SITE PLAN

SHEET NUMBER:

REVISION

C-102

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TOWER ELEVATION

SCALE: N.T.S.

ATC HAS NOT ANALYZED THE EXISTING ANTENNA MOUNT(S) TO DETERMINE ADEQUATE STRUCTURAL CAPACITY FOR PROPOSED CARRIER LOADING.

- TOWER NOTE:

 1. IT IS THE CONTRACTOR'S RESPONSIBILITY TO CONFIRM WITH THE PROJECT MANAGER THAT THEY HAVE THE MOST RECENT VERSION OF THE STRUCTURAL ANALYSIS BEFORE COMMENCING WORK. EXISTING AND PROPOSED TOWER APPURTENANCES, MOUNTS, AND ANTENNAS ARE SHOWN BASED ON THE STRUCTURAL ANALYSIS.
- 2. WHERE APPLICABLE, ALL NEW ANTENNAS, EQUIPMENT, MOUNTS, CABLING, ETC. SHALL BE PAINTED/SOCKED TO MATCH EXISTING EQUIPMENT IN ACCORDANCE WITH FAA, JURISDICTION, AND/OR OTHER LOCAL REQUIREMENTS.
- ROUTE PROPOSED CABLES ALONG SAME PATH AS EXISTING CABLES AND IN ACCORDANCE WITH STRUCTURAL ANALYSIS. WHERE POSSIBLE UTILIZE EXISTING CABLE SUPPORT STRUCTURES AS PROVIDED FOR CARRIER TO ADEQUATELY SECURE CABLES, USING EITHER APPROPRIATELY SIZED STAINLESS STEEL SNAP-INS OR MOUNTING HARDWARE AND BRACKETS AS SPECIFIED BY CABLE MANUFACTURER. OTHERWISE, ATTACH CABLES TO HORIZONTAL OR DIAGONAL TOWER MEMBERS USING PROPOSED STAINLESS STEEL ADAPTERS (DO NOT ATTACH TO TOWER LEG).
- TOWER ELEVATIONS ARE MEASURED FROM TOP OF BASE PLATE TO MATCH STRUCTURAL ANALYSIS. ELEVATIONS DO NOT REFLECT TRUE ABOVE GROUND LEVEL (A.G.L.)



3500 REGENCY PARKWAY SUITE 100 **CARY, NC 27518** PHONE: (919) 468-0112 COA: 9053

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ATC SITE NUMBER: 21806

ATC SITE NAME: **COLUMBIA - NEXTEL BTS**

VERIZON SITE NAME:

ATC COLUMBIA

SITE ADDRESS: 3969 SW TUSTENUGGEE AVE LAKE CITY, FL 32024

No. 78374

*
No. 7




DATE DRAWN: 09/02/21 ATC JOB NO: 13692328 D1 CUSTOMER ID: ATC COLUMBIA CUSTOMER #: 131312


TOWER ELEVATION

SHEET NUMBER:

REVISION

C-201

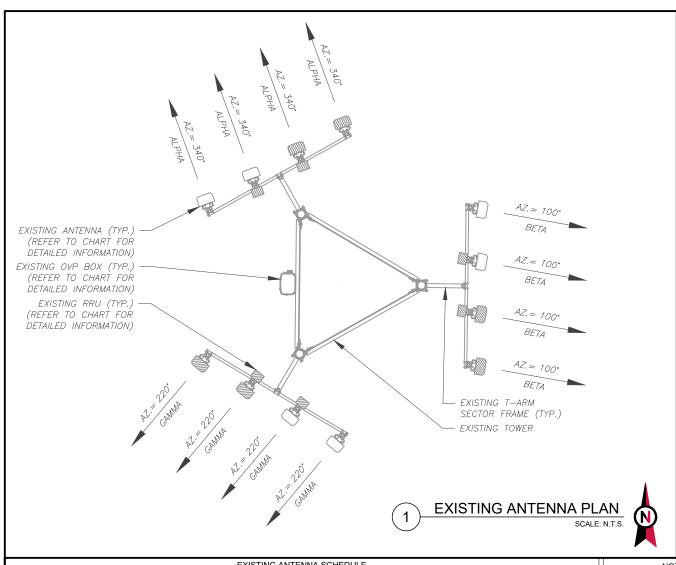

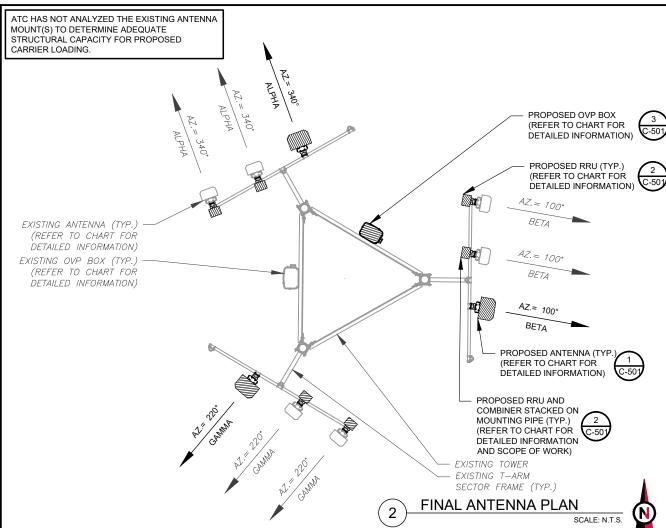

					EXISTING ANTENNA SCI	HEDULE				Π
LOC	LOCATION ANTENNA SUMMARY							NON ANTENNA SUMMA	RY	-
SECTOR	RAD	AZ	POS	ANTENNA	BAND	MECH/ELEC D-TILT	STATUS	ADDITIONAL TOWER MOUNTED EQUIPMENT	STATUS	
			A1	NHH-65C-R2B	1900/AWS/AWS3	-	RMN	-	_	
			A2	NHH-65C-R2B	1900/AWS/AWS3	-	RMN	RRUS32 B2	RMV	
ALPHA	233'	340°	A3	X7CAP-865-C4	850	_	RMV	RRUS32 B66A	RMV	
			A4	X7CAP-865-C4	850	_	RMV	_	_	
			B1	NHH-65C-R2B	1900/AWS/AWS3	-	RMN	_	_	
BETA	233'	100°	B2	NHH-65C-R2B	1900/AWS/AWS3	_	RMN	RRUS32 B2	RMV	
DETA	233	100	B3	X7CAP-865-C4	850	-	RMV	RRUS32 B66A	RMV	
			B4	X7CAP-865-C4	850	-	RMV	_	-	
			C1	NHH-65C-R2B	1900/AWS/AWS3	-	RMN	=	_	
GAMMA	233'	220°	C2	NHH-65C-R2B	1900/AWS/AWS3	-	RMN	RRUS32 B2	RMV	L
GAININA	233	220	C3	X7CAP-865-C4	850	-	RMV	RRUS32 B66A	RMV	
			C4	X7CAP-865-C4	850	_	RMV	_	_]_

NOTES
CONFIRM WITH VERIZON REP FOR APPLICABLE UPDATES/REVISIONS AND MOST RECENT RFDS FOR NSN CONFIGURATION (CONFIG). GC TO CAP ALL UNUSED PORTS.
I O CAP ALL UNUSED PORTS. 2. CONFIRM SPACING OF PROPOSED EQUIP DOES NOT CAUSE TOWER CONFLICTS NOR IMPEDE TOWER CLIMBING PEGS.
STATUS ABBREVIATIONS

STATUS ABBREVIATIONS
RMV: TO BE REMOVED RMN: TO REMAIN REL: TO BE RELOCATED ADD: TO BE ADDED

1	LO	LOCATION ANTENNA SUMMARY						NON ANTENNA SUMMA	RY		
	SECTOR	RAD	AZ	POS	ANTENNA	BAND	MECH/ELEC D-TILT	STATUS	ADDITIONAL TOWER MOUNTED EQUIPMENT	STATUS	
				A1	NHH-65C-R2B	1900/AWS/AWS3	-	RMN	4449	ADD	
	ALPHA	233'	2400	233' 340°	A2	NHH-65C-R2B	1900/AWS/AWS3	_	RMN	8843/TD-850B-LTE78-43	ADD
			255		340	A3	AIR6449	L-SUB6	-	ADD	=
				A4	=	-	-	-	=	-	
		233'			B1	NHH-65C-R2B	1900/AWS/AWS3	_	RMN	4449	ADD
	BETA		100°	B2	NHH-65C-R2B	1900/AWS/AWS3	_	RMN	8843/TD-850B-LTE78-43	ADD	
	DLIA		200	100	В3	AIR6449	L-SUB6	-	ADD	-	-
				B4	-	-	-	-	-	-	
				C1	NHH-65C-R2B	1900/AWS/AWS3	_	RMN	4449	ADD	
	GAMMA	233'	220°	C2	NHH-65C-R2B	1900/AWS/AWS3	_	RMN	8843/TD-850B-LTE78-43	ADD	
	OAWIWA	255	220	C3	AIR6449	L-SUB6	-	ADD	ē	-	

FINAL ANTENNA SCHEDULE

CABLE LENGTHS FOR JUMPERS

JUNCTION BOX TO RRU: 15' RRU TO ANTENNA: 10'

C4

EXISTING FIBER DISTRIBUTION/O	VP BOX	EXISTI	NG CABLING SUMMARY	
MODEL NUMBER	STATUS	COAX	HYBRID	STATUS
_	_	(6) 1 5/8"	(1) 6X12	RMN
_	-	(1) 1 5/8"		RMV

/	\bigcirc	EQUIPMENT SCHEDULES
(્ડ	

FINAL FIBER DISTRIBUTION / OVE	P BOX	FINAL	CABLING SUMMARY	
MODEL NUMBER	STATUS	COAX	HYBRID	STATUS
-	-	(6) 1 5/8"	(1) 6X12	RMN
-	-		(1) 12X24	ADD



ATC TOWER SERVICES, LLC

3500 REGENCY PARKWAY SUITE 100 CARY, NC 27518 PHONE: (919) 468-0112 COA: 9053

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	REV.	REV. DESCRIPTION		DATE
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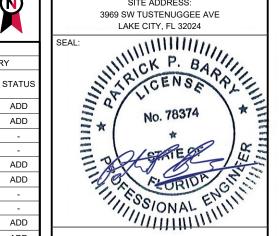
ATC SITE NUMBER: 21806

ATC SITE NAME: **COLUMBIA - NEXTEL BTS**

VERIZON SITE NAME:

ATC COLUMBIA


SITE ADDRESS: 3969 SW TUSTENUGGEE AVE




	DATE DRAWN:	09/02/21
	ATC JOB NO:	13692328_D1
	CUSTOMER ID:	ATC COLUMBIA
	CUSTOMER #:	131312

ANTENNA INFORMATION & SCHEDULE


SHEET NUMBER: C-401 REVISION: 0

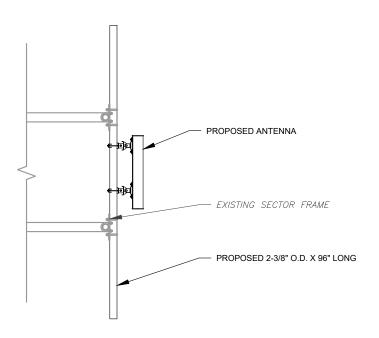


PROPOSED 5G ANTENNA MOUNTING DETAIL - TYPICAL

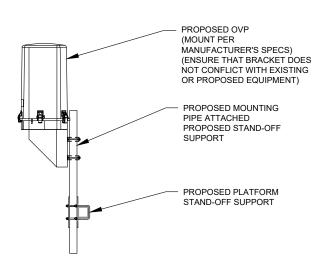

PROPOSED OVP MOUNTING

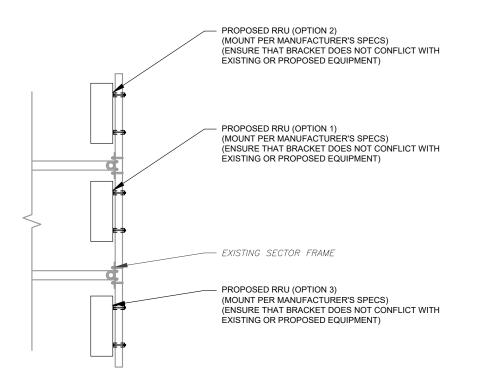

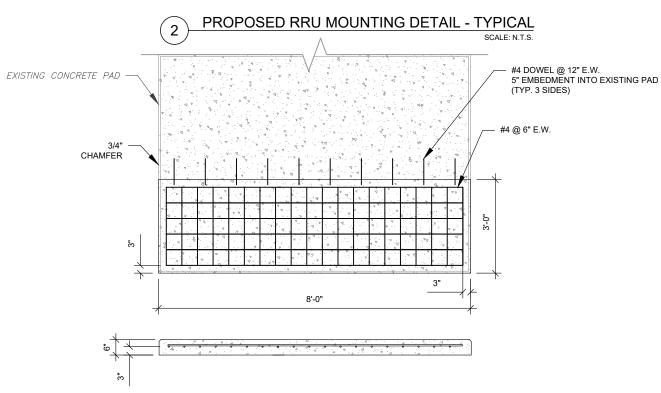

- SUBGRADE AND FILL SHALL CONSIST OF CLEAN SOIL. DELETERIOUS MATERIAL AND ORGANICS SHALL BE REMOVED.
- USE GALVANIZED HILTI EXPANSION ANCHORS OR, APPROVED EQUAL, FOR EQUIPMENT ANCHORAGE.
- FOR SIZE AND LOCATION OF ANCHORS AND OTHER REQUIREMENT, SEE EQUIPMENT VENDOR DRAWINGS.
- DETAIL FOR ILLUSTRATIVE PURPOSES ONLY, MODIFY PER GENERATOR MANUFACTURER SPECIFICATIONS TO ACCOMMODATE STUB UP.





ATC TOWER SERVICES, LLC 3500 REGENCY PARKWAY SUITE 100

CARY, NC 27518 PHONE: (919) 468-0112 COA: 9053

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REV.	DESCRIPTION	BY	DATE
<u> </u>	FOR CONSTRUCTION	<u>JP</u> _	09/02/21
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ATC SITE NUMBER: 21806

ATC SITE NAME: COLUMBIA - NEXTEL BTS

VERIZON SITE NAME:

ATC COLUMBIA

SITE ADDRESS: 3969 SW TUSTENUGGEE AVE

No. 78374 SONAL ENGLIS

verizon sign

	Ш	DATE DRAWN:	09/02/21
	Ш	ATC JOB NO:	13692328_D1
	Ш	CUSTOMER ID:	ATC COLUMBIA
	CUSTOMER #:	131312	

CONSTRUCTION **DETAILS**

SHEET NUMBER:


C-501

REVISION 0

LABEL LIST:


- 1. (4)-11/2" CONDUITS FOR RECTIFIERS IN CONSOLIDATED EQUIPMENT AND POWER CABINET
- 2. (1)-1" CONDUIT FOR GENERATOR AND ILC ALARM FORM ILC TO CONSOLIDATED EQUIPMENT AND
- 3. (1)-1" CONDUIT FOR GENERATOR HEATER & BATTERY CHARGER FROM ILC TO GENERATOR
- 4. (1)-1" CONDUIT FOR ALARM AND CONTROL WIRING FROM ILC TO GENERATOR
- 5. (1)- 2½" CONDUIT FOR POWER FROM ILC TO GENERATOR
- 6. (1)-2" CONDUIT FOR POWER FROM SERVICE DISCONNECT/CIRCUIT BREAKER TO ILC
- 7. (1)-2" CONDUIT FOR BATTERY CABINET FROM CONSOLIDATED EQUIPMENT AND POWER CABINET
- (1)-1" CONDUIT FOR BATTERY CABINET FROM ILC TO BATTERY CABINET. CONTRACTOR TO REUSE CONDUIT AND CONDUIT AND CONDUCTORS IF SUFFICIENTLY SIZED.
- (1)-1½" CONDUIT FOR EXISTING BTS CABINET FROM ILC TO BTS CABINET. CONTRACTOR TO REUSE CONDUIT AND CONDUIT AND CONDUCTORS IF SUFFICIENTLY SIZED.
- 10. LP LINE TO BE SIZED AND INSTALLED BY A QUALIFIED CONTRACTOR

- 1. POWER AND TELCO CONDUITS RECEIVING CONDUCTORS BY OTHERS TO HAVE PULL ROPES.
- 2. ALL TELCO CONDUITS ARE TO BE STUBBED IN D-MARC LOCATION.
- 3. ALL POWER CONDUITS ARE TO BE TERMINATED AT THE METER CENTER.
- 4. THE CONTRACTOR SHALL LOCATE ALL EXISTING UTILITIES PRIOR TO TRENCHING. ANY DAMAGE CAUSED TO THE EXISTING UTILITIES SHALL BE REPAIRED AT THE CONTRACTORS EXPENSE.
- 5. ALL CONDUITS SHALL BE INSTALLED PRIOR TO FINISH GRADING, GEOFABRIC, AND STONE
- CONTRACTOR SHALL INSTALL SWEEPS AT ALL CONDUIT DIRECTION CHANGES UNLESS NOTED
- 7. RUN CONDUITS FROM ILC TO GENERATOR UNDERGROUND AND STUB UP CONDUITS MINIMUM 6" HIGH INSIDE GENERATOR BASE AND TERMINATE WITH MALE ADAPTER AND THREADED BUSHING.

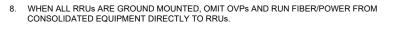

GROUNDING KEYED NOTES:

angle #2 SBTC GROUNDING ELECTRODE CONDUCTOR

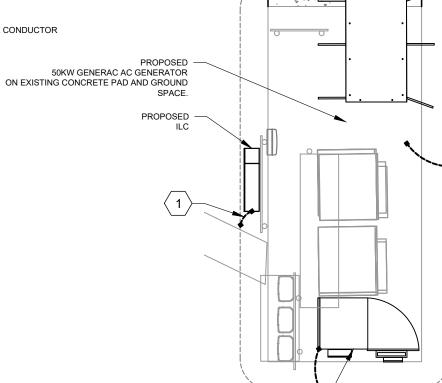

PROPOSED


GROUNDING PLAN

SCALE: N.T.S.

CONSOLIDATED

EQUIPMENT AND

POWER CABINET

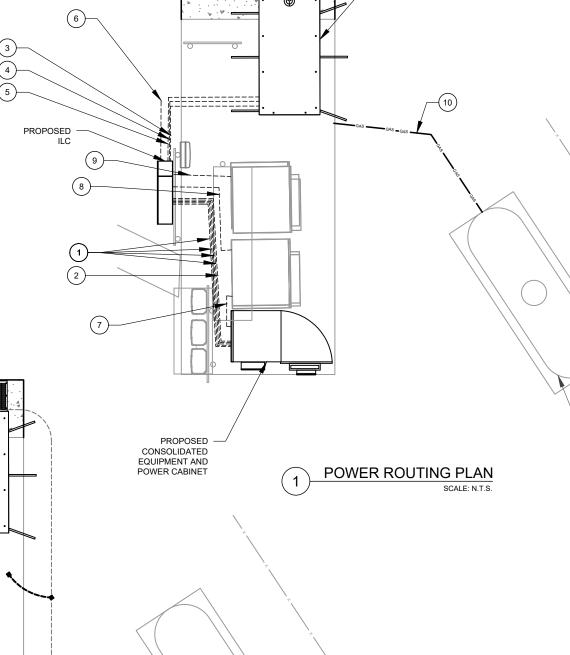

PROPANE TANK ON A 4'-0" X 10'-0" CON. PAD

50KW GENERAC AC GENERATOR

ON EXISTING CONCRETE PAD AND GROUND



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DESCRIPTION	BY	DATE
FOR CONSTRUCTION	_JP_	09/02/21

ATC SITE NUMBER: 21806

ATC SITE NAME: COLUMBIA - NEXTEL BTS

VERIZON SITE NAME:

ATC COLUMBIA

PROPANE TANK ON A

4'-0" X 10'-0" CON. PAD

SITE ADDRESS: 3969 SW TUSTENUGGEE AVE




DATE DRAWN:	09/02/21
ATC JOB NO:	13692328_D1
CUSTOMER ID:	ATC COLUMBIA
CUSTOMER #:	131312
	-

CONDUIT LAYOUT

SHEET NUMBER:

REVISION

E-101

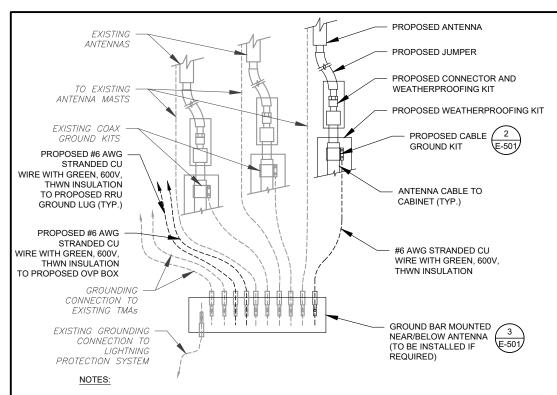

- 1. THIS DETAIL IS INTENDED TO SHOW THE GENERAL GROUNDING REQUIREMENTS. SLIGHT ADJUSTMENTS MAY BE REQUIRED BASED ON EXISTING SITE CONDITIONS. THE CONTRACTOR SHALL MAKE FIELD ADJUSTMENTS AS NEEDED AND INFORM THE CONSTRUCTION MANAGER OF ANY CONFLICTS.
- SITE GROUNDING SHALL COMPLY WITH VERIZON GROUNDING STANDARDS, LATEST EDITION, AND COMPLY WITH VERIZON GROUNDING CHECKLIST, LATEST VERSION. WHEN NATIONAL AND LOCAL GROUNDING CODES ARE MORE STRINGENT THEY SHALL GOVERN.





TO EQUIPMENT

GROUND KIT NOTES: DO NOT INSTALL CABLE GROUND KIT AT A BEND AND ALWAYS DIRECT GROUND WIRE DOWN TO GROUND BAR.

TO ANTENNA

 \bigcirc

2. CONTRACTOR SHALL PROVIDE WEATHERPROOFING KIT (ANDREW PART NUMBER 221213) AND INSTALL/TAPE PER MANUFACTURER'S SPECIFICATIONS.

CABLE GROUND KIT CONNECTION DETAIL

TO GROUND BAR


ANTENNA CABLE 2 1/2"Ø MAX

GROUNDING KIT PER CABLE


MANUFACTURER'S RECOMMENDATIONS (ANDREW OR APPROVED EQUAL)

#6 AWG STRANDED COPPER GROUND

WIRE (GROUNDED TO GROUND BAR)

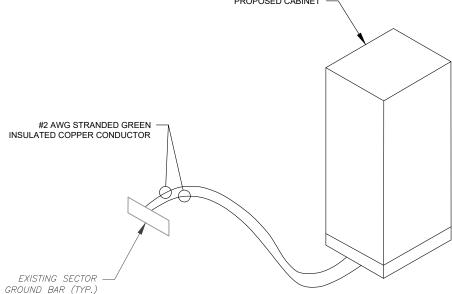


CABINET GROUNDING DETAIL

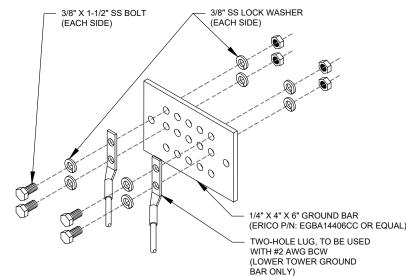

GROUND BAR NOTES:

- GROUND BAR KITS COME WITH ALL HARDWARE, NUTS, BOLTS, WASHERS, ETC. EXCEPT THE STRUCTURAL MOUNTING MEMBER(S).
- 2. GROUND BAR TO BE BONDED DIRECTLY TO TOWER.



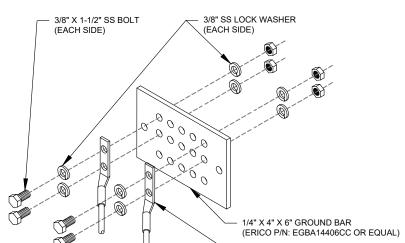



ATC SITE NAME: **COLUMBIA - NEXTEL BTS**

VERIZON SITE NAME:

ATC SITE NUMBER:

21806

AMERICAN TOWER

ATC TOWER SERVICES, LLC

3500 REGENCY PARKWAY

SUITE 100

CARY, NC 27518

PHONE: (919) 468-0112

COA: 9053

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IS STRICTLY PROHIBITED. NEITHER THE ARCHITECT NOR THE ENGINEER WILL BE PROVIDING ON-SITE

CONSTRUCTION REVIEW OF THIS PROJECT.

CONTRACTOR(S) MUST VERIFY ALL DIMENSIONS

AND ADVISE AMERICAN TOWER OR THE SPECIFIED

CARRIER OF ANY DISCREPANCIES. ANY PRIOR

ISSUANCE OF THIS DRAWING IS SUPERSEDED BY

THE LATEST VERSION.

DESCRIPTION

FOR CONSTRUCTION

ATC COLUMBIA

SITE ADDRESS: 3969 SW TUSTENUGGEE AVE

No. 78374 III SSIONAL ENGLIS




	DATE DRAWN:	09/02/21
	ATC JOB NO:	13692328_D1
	CUSTOMER ID:	ATC COLUMBIA
	CUSTOMER #:	131312


GROUNDING DETAILS

SHEET NUMBER:

REVISION E-501

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ATC TOWER SERVICES, LLC
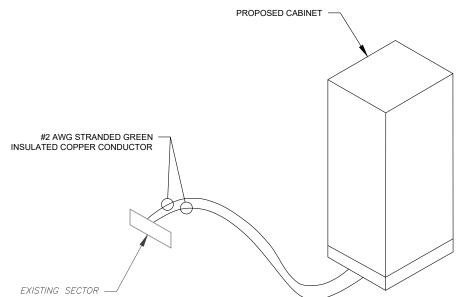
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ATC SITE NUMBER: 21806

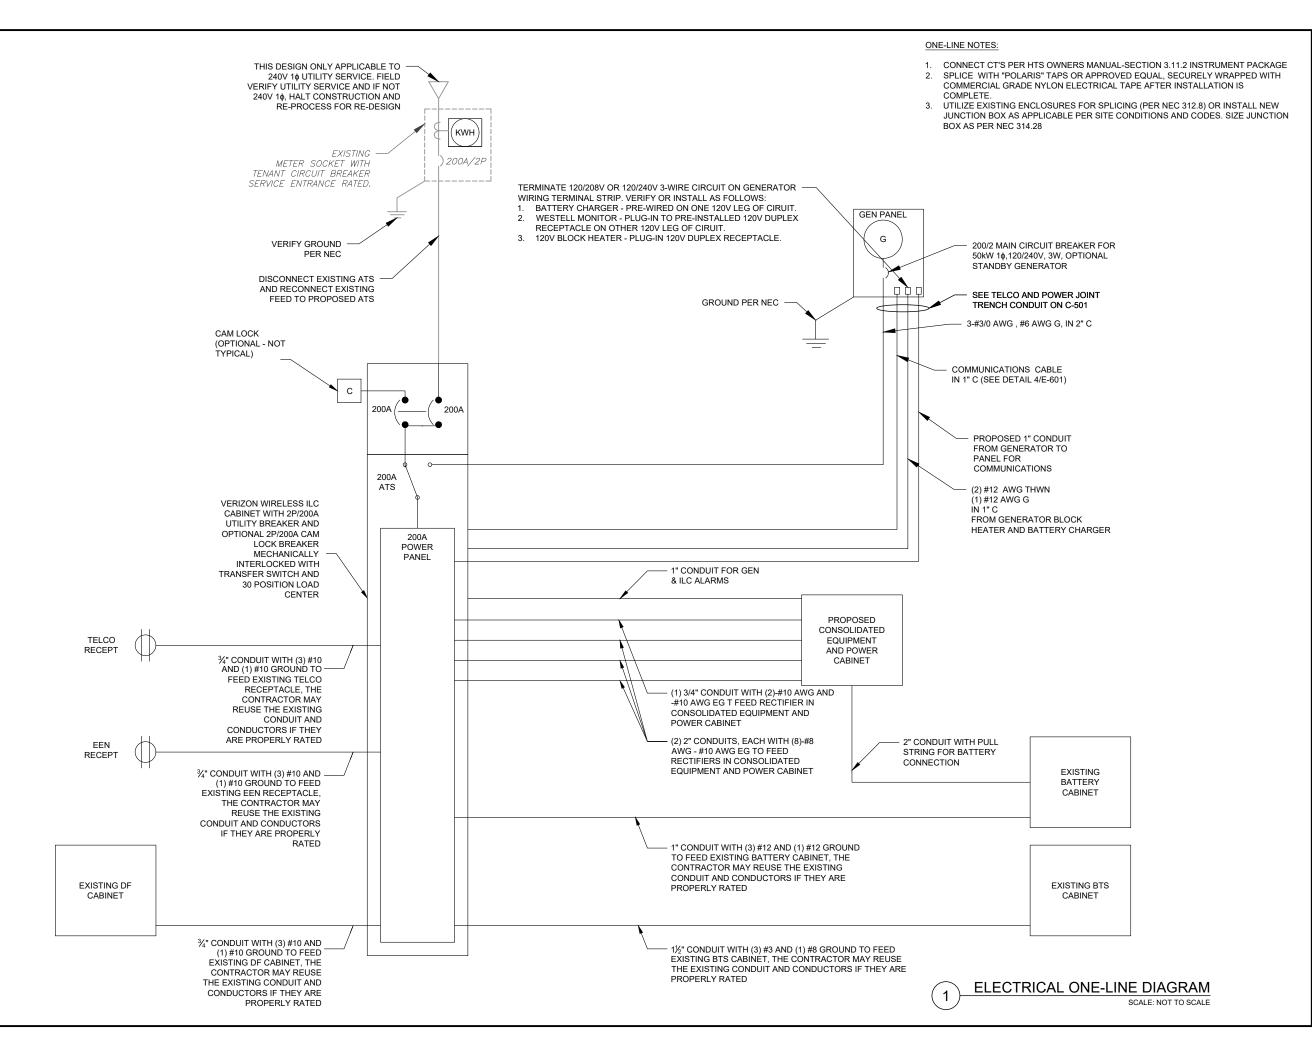ATC SITE NAME: **COLUMBIA - NEXTEL BTS**

VERIZON SITE NAME:

ATC COLUMBIA

SITE ADDRESS: 3969 SW TUSTENUGGEE AVE

No. 78374 FORIDA CHILI



DATE DRAWN:	09/02/21						
ATC JOB NO:	13692328_D1						
CUSTOMER ID:	ATC COLUMBIA						
CUSTOMER #:	131312						

ONE-LINE DIAGRAM

SHEET NUMBER

REVISION

E-601

LIGHTING & APPLIANCE PANEL TYPE: SYSTEM: 120/240V, 1Ø, 3W, 42 CKT LOCATION: VZW LEASE EQUIPMENT AREA VERIZON MOUNTING: SURFACE DESIGNATION: MAIN BREAKER (MB) 200A ENCLOSURE: NEMA 3R MAIN BUS RATING: 200A PANEL NOTES PROPOSED N/A MIN. A.I.C. RATING:

NNECTED	ED FEEDER OR BRANCH CIRCUIT				FEEDER OR BRANCH CIRCUIT							CONN	ECT						
DAD (kVA)	BRIEF DESCRIPTION	BREA	AKER		CIRCUIT		POLE	CIRC.		CIRC.	POLE		CIRCUIT		BREA	AKER	BRIEF DESCRIPTION	LOAD) (kV
В		AMPS	POLES	WIRE	GND	COND.	NO.	NOTES		NOTES	NO.	COND.	GND	WIRE	POLES	AMPS		A	
1.14	RECTIFIER	30	2	3#10	#10	1/2"	3	3		3	4	1/2"	#10	3-#10	2	30	RECTIFIER	1.14	
1.14	RECTIFIER	30	2	3#10	#10	1/2"	5 7	3		3	6 8	1/2"	#10	3-#10	2	30	RECTIFIER	1.14	
1.14	RECTIFIER	30	2	3-#10	#10	1/2"	9	3		3	10 12	1/2"	#10	3-#10	2	30	RECTIFIER	1.14	
1.14	RECTIFIER	30	2	3-#10	#10	1/2"	13 15	3		3	14 16	1/2"	#10	3#10	2	30	EBRE	1.20	
0	BTS	100	2	3-#1	#8	2"	17	- 3		3	18	1/2"	#12	2-#12	1	20	DF CABINET	1.80	
4.00	810	100		3771	110		19	3		3	20	1/2"	#12	2#12	1	20	TELCO RECEPT		
							21			3	22	1/2"	#12	2-#12	1	20	EEN RECEPT	0.18	
0.00							23			3	24	1/2"	#12	2-#12	1	20	GEN BATTERY CHARGER		
							25			3	26	1/2"	#12	2#12	1	20	GEN BLOCK HEATER	1.92	
0.00	_						27				28						_	1170	
)							29				30							0.00	
8.5				70.				Α	В	TO	- Control of the Cont			OAD (kVA	20.3	***		8.5	


CIRCUIT NOTES

- 1) PANEL SCHEDULE BASED ON INFO PROVIDED TO AE; IF PANEL HAS DIFFERENT EXISTING LOADS THAN SHOWN, STOP WORK AND CONTACT EOR
- EXISTING CIRCUIT, UNKNOWN LOAD, MAX DEMAND ASSUMED FOR LOAD CAPACITY ASSESSMENT.
- 3) EXISTING CIRCUIT, KNOWN LOAD FOR LOAD CAPACITY ASSESSMENT
- 4) PROPOSED CIRCUIT, KNOWN LOAD FOR LOAD CAPACITY ASSESSMENT

PANEL SCHEDULE


15.3

32.3

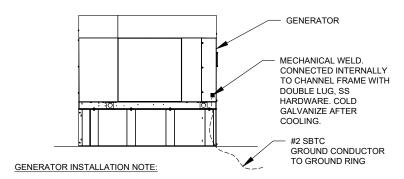

INSTALL GENERATOR AND TRANSFER SWITCH WITH ALL SUPPLIED ACCESSORIES PER MANUFACTURER'S INSTALLATION INSTRUCTIONS AND SPECIFICATIONS. THIS INCLUDES. BUT IS NOT LIMITED TO, ACCESSORIES FOR THE EXHAUST SYSTEM, FUEL SYSTEM, ENCLOSURE INTEGRITY (CAPS, PLUGS, COVERS, ETC.), ELECTRICAL CONNECTIONS, AND GROUNDING CONNECTIONS.

GENERATOR GROUNDING SCALE: NOT TO SCALE

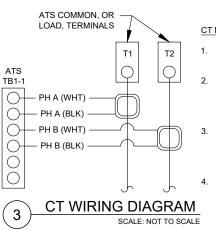

DEMAND LOAD (kVA)

CT'S FURNISHED BY GENERAC WITH LEAD WIRE OPTION, PART NUMBER 0F7784B, 200:1 AMP RATIO.

DERATING FACTOR (80%)

DEMANDLOAD SIZING.

168 AMPS

- WIRING SHOWN FOR SINGLE PHASE TENANT LOAD ON PHASES A-B. ADJUST ACCORDINGLY FOR INDIVIDUAL SITES THAT ARE BALANCING THREE PHASE SERVICES.
- 1-PHASE: MOUNT ONE CT WITH WHITE DOT FACING AWAY FROM, AND OTHER CT WITH WHITE DOT FACING TOWARDS, THE ATS TERMINAL CONNECTIONS
- 3-PHASE: MOUNT ALL CT'S WITH WHITE DOTS ALL FACING AWAY FROM THE ATS TERMINAL CONNECTIONS

AMERICAN TOWER® ATC TOWER SERVICES, LLC 3500 REGENCY PARKWAY SUITE 100

CARY, NC 27518 PHONE: (919) 468-0112 COA: 9053

THE USE AND PUBLICATION OF THESE DRAWINGS SHALL BE RESTRICTED TO THE ORIGINAL SITE FOR WHICH THEY ARE PREPARED. ANY USE OR DISCLOSURE OTHER THAN THAT WHICH RELATES TO AMERICAN TOWER OR THE SPECIFIED CARRIER IS STRICTLY PROHIBITED. NEITHER THE ARCHITECT NOR THE ENGINEER WILL BE PROVIDING ON-SITE CONSTRUCTION REVIEW OF THIS PROJECT. CONTRACTOR(S) MUST VERIEV ALL DIMENSIONS AND ADVISE AMERICAN TOWER OR THE SPECIFIED CARRIER OF ANY DISCREPANCIES, ANY PRIOR ISSUANCE OF THIS DRAWING IS SUPERSEDED BY THE LATEST VERSION.

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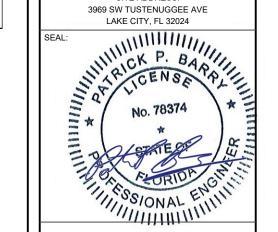
ATC SITE NUMBER: 21806

ATC SITE NAME: **COLUMBIA - NEXTEL BTS**

VERIZON SITE NAME:

ATC COLUMBIA

SITE ADDRESS: 3969 SW TUSTENUGGEE AVE



DATE DRAWN:	09/02/21					
ATC JOB NO:	13692328_D1					
CUSTOMER ID:	ATC COLUMBIA					
CUSTOMER #:	131312					

PANEL SCHEDULE AND **ELECTRICAL DETAILS**

SHEET NUMBER:

E-602

0

REVISION

EPA Certified Stationary Emergency

Prime Power Rating* 45 kW, 56 kVA, 60 Hz







Image used for illustration purposes only

Codes and Standards

Generac products are designed to the following standards:





UL2200, UL508, UL489



CSA 22.2



BS5514 and DIN 6271





NFPA 37, 70, 99, 110



NEC700, 701, 702, 708



ISO 3046, 7637, 8528, 9001

NEMA ICS10, MG1, 250, ICS6, AB1



ANSI C62.41



ANSI

IBC 2009, CBC 2010, IBC 2012, ASCE 7-05, ASCE 7-10, ICC-ES AC-156 (2012)

Powering Ahead

Generac ensures superior quality by designing and manufacturing most of its generator components, such as alternators, enclosures, control systems and communications software. Generac also makes its own spark-ignited engines, and you'll find them on every Generac gaseous-fueled generator. We engineer and manufacture them from the block up - all at our facilities throughout Wisconsin. Applying natural gas and LP-fueled engines to generators requires advanced engineering expertise to ensure reliability, durability and necessary performance. By designing specifically for these dry, hotter-burning fuels, the engines last longer and require less maintenance. Building our own engines also means we control every step of the supply chain and delivery process, so you benefit from singlesource responsibility.


Plus, Generac Industrial Power's distribution network provides all parts and service so you don't have to deal with third-party suppliers. It all leads to a positive owner experience and higher confidence level. Generac spark-ignited engines give you more options in commercial and industrial generator applications as well as extended run time from utility-supplied natural gas.

5.4L | 50 kW

INDUSTRIAL SPARK-IGNITED GENERATOR SET

EPA Certified Stationary Emergency

DIMENSIONS AND WEIGHTS*

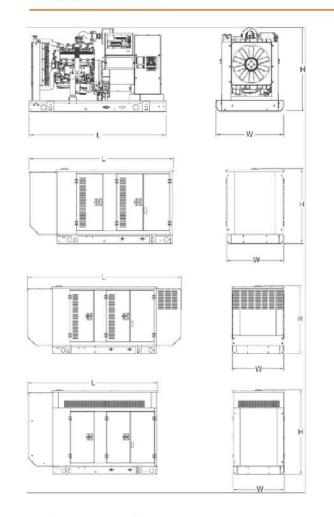

OPEN SET (Includes Exhaust Flex)

L x W x H - in (mm) 76.0 (1,930.0) x 37.4 (950.0) x 46.3 (1,176.0) Weight - Ibs (kg) 2.256 (1.023)

GENERAC INDUSTRIAL

STANDARD ENCLOSURE

94.8 (2,408.9) x 38.0 (965.1) x 49.5 (1,258.1) Steel: 2,697 (1,223) Weight - Ibs (kg) Aluminum: 1,754 (795)


LEVEL 1 ACOUSTIC ENCLOSURE

L x W x H - In (mm) 112.5 (2,857.1) x 38.0 (965.1) x 49.5 (1,258.1) Steel: 2,776 (1,259) Weight - libs (kg) Aluminum: 2,508 (1,138)

LEVEL 2 ACOUSTIC ENCLOSURE

94.8 (2,407.0) x 38.0 (965.1) x 69.1 (1,755.0) Steel: 2,928 (1,329) Weight - Ibs (kg) Aluminum: 2,574 (1,168)

* All measurements are approximate and for estimation purposes only.

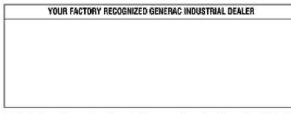

Specification characteristics may change without notice. Please contact a General Power Systems Industrial Dealer for detailed installation drawings.

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Part No. 0K4284 Rev. D 11/16/17

SUPPLEMENTAL

SHEET NUMBER:

R-601

REVISION: 0

NOTICE

DISCONNECT FOR UTILITY POWER TO GENERATOR IS LOCATED INSIDE THIS ENCLOSURE CAUTION: TWO
SOURCES OF SUPPLY.
STANDBY
GENERATOR
LOCATED OUTDOOR.



SHOCK HAZARD EXISTS IF
GROUNDING ELECTRODE CONDUCTOR
OR BONDING JUMPER CONNECTION IN
THIS EQUIPMENT IS REMOVED WHILE
ALTERNATE SOURCE(S) IS ENERGIZED

1 REQUIRED SIGNS
SCALE

SUPPLEMENTAL

SHEET NUMBER

2

0

R-602



THIS UNIT MAY START
AUTOMATICALLY. FOLLOW
OPERATING PROCEDURES TO
DISABLE AUTO-START FUNCTION ON
ALL AVAILABLE A.T.S. BEFORE
SERVICING

ACCESS BY AUTHORIZED PERSONNEL ONLY

1 REQUIRED SIGNS
SCALE: N.T.S.

SUPPLEMENTAL

QUEET NI IMPED

8 0

R-603