


REVISIONS

SOFTPIAN ARCHITECTURAL DESIGN SOFTWARE

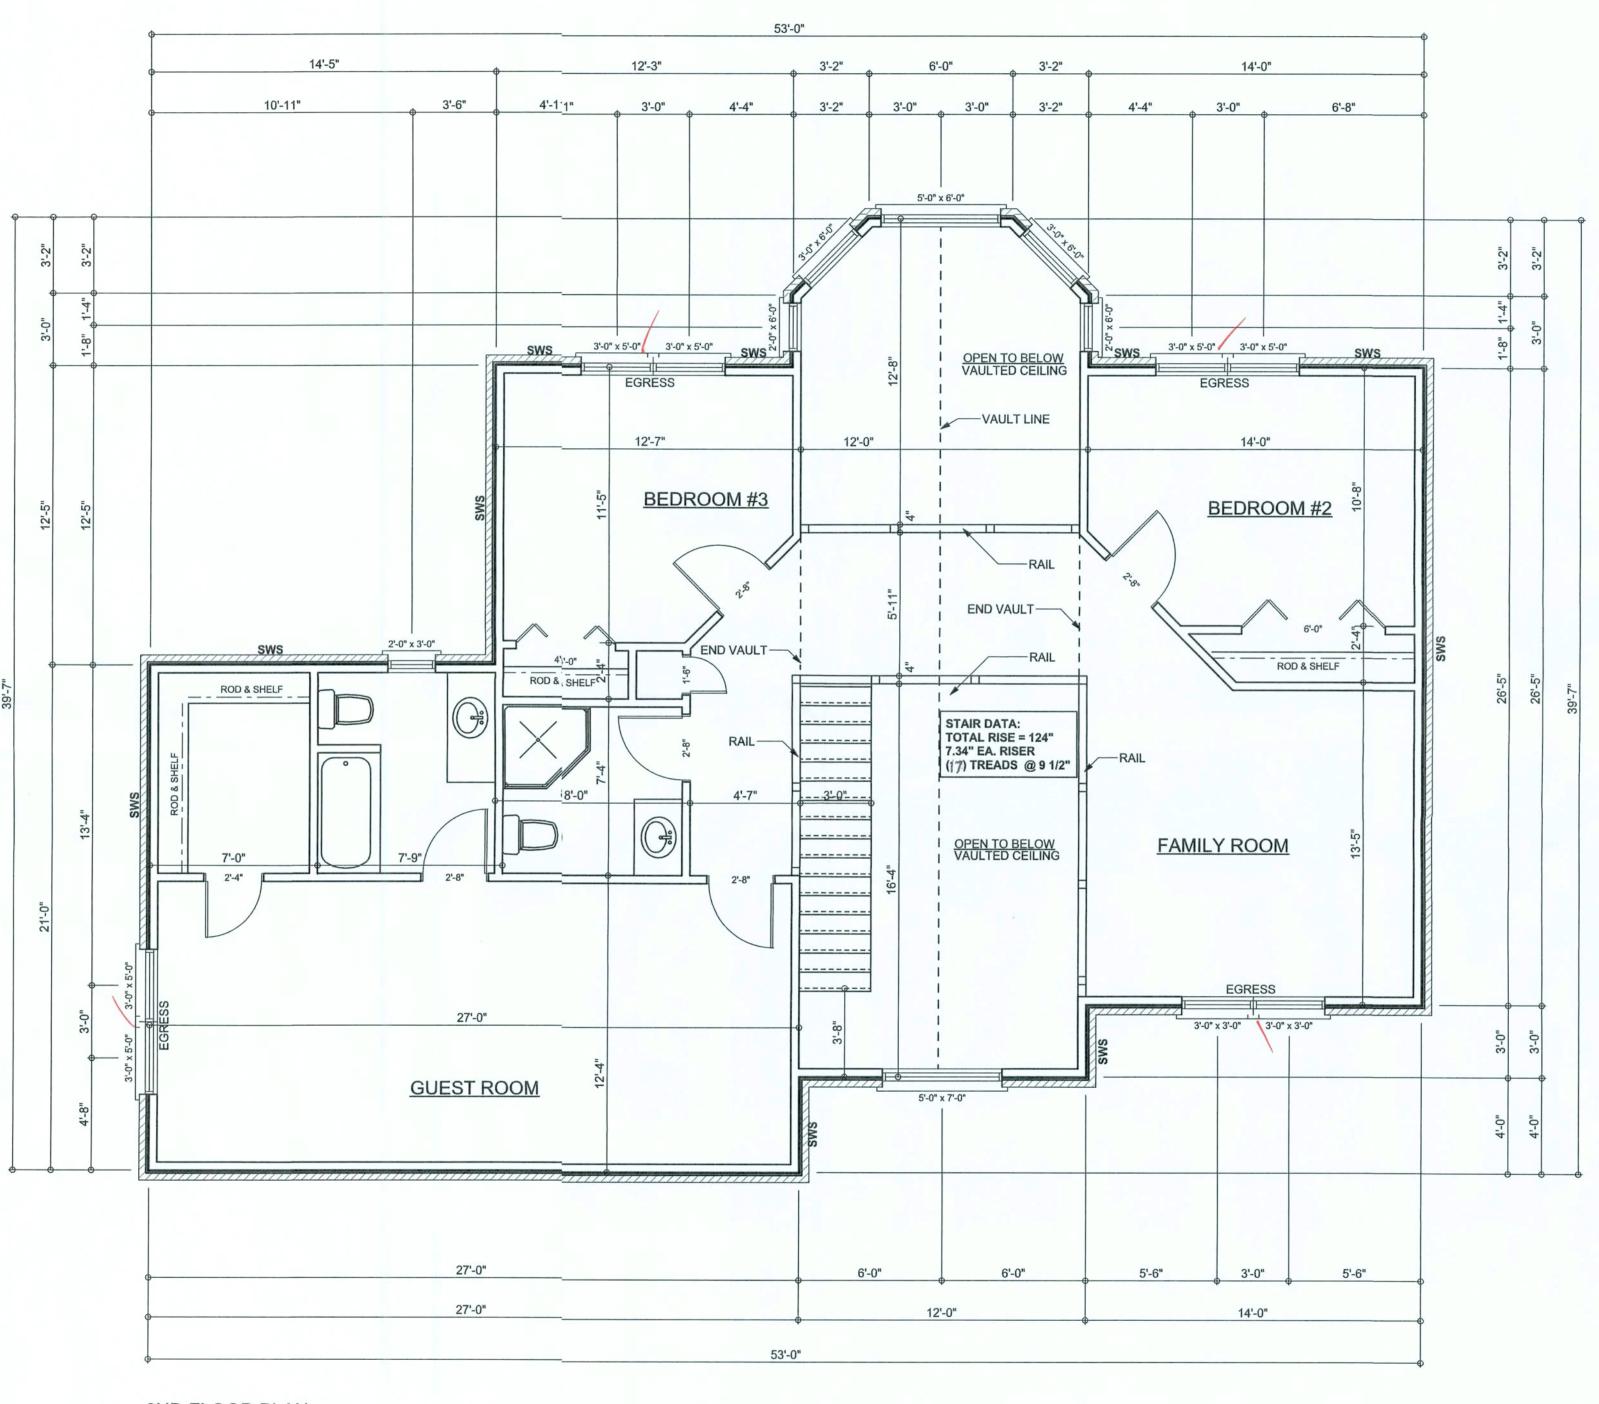

2ND FLOOR PLAN
SCALE: 1/4" = 1'-0"
ALL CEALINGS TO BE 9' UNLESS NOTED OTHERWISE
SWS=SHEAR WALL SEGMENT

CERTIFICATION: These plans and
"Windload Engineering", Sheet S-1, attached,
comply with Florida Building Code 2004,
Section 1609 wind loads, to the best of my
knowledge.

LIMITATION: This design is valid for one
building at specified location. In case of conflict,
structural requirements, scope of work, and
builder responsibilities on sheet S-1 control.

COPYRIGHTS AND PROPERTY RIGHTS:
Mark Disosway, P.E. hereby expressly reserves
its common law copyrights and property right in
these instruments of service. This document is
not to be reproduced, altered or copied in any
form or manner without first the express written
permission and consent of Mark Disosway.

WINDLOAD ENGINEER: Mark Disosway, PE No.53915, POB 868, Lake City, FL 32056, 386-754-5419

dimensions. Refer all questions to Mark Disosway, P.E. for resolution. Do not proceed without clarification.

MARK DISOSWAY
P.E. 53945

ANGEL GOMEZ RESIDENCE

ADDRESS: LAKE CITY, FLORIDA

Mark Disosway P.E.
P.O. Box 868
Lake City, Florida 32025
Phone: (386) 754 - 5419
Fax: (386) 269 - 4871
windloadengineer@bellsouth.net

PRINTED DATE:
March 02, 2006

DRAWN BY: CHECKED BY:
Ben Sparks

DESIGNED BY:
Ben Sparks


FINALES DATE: 10 / OCT / 05 JOB NUMBER:


DRAWING NUMBER

A-3


OF 6 SHEETS

506101

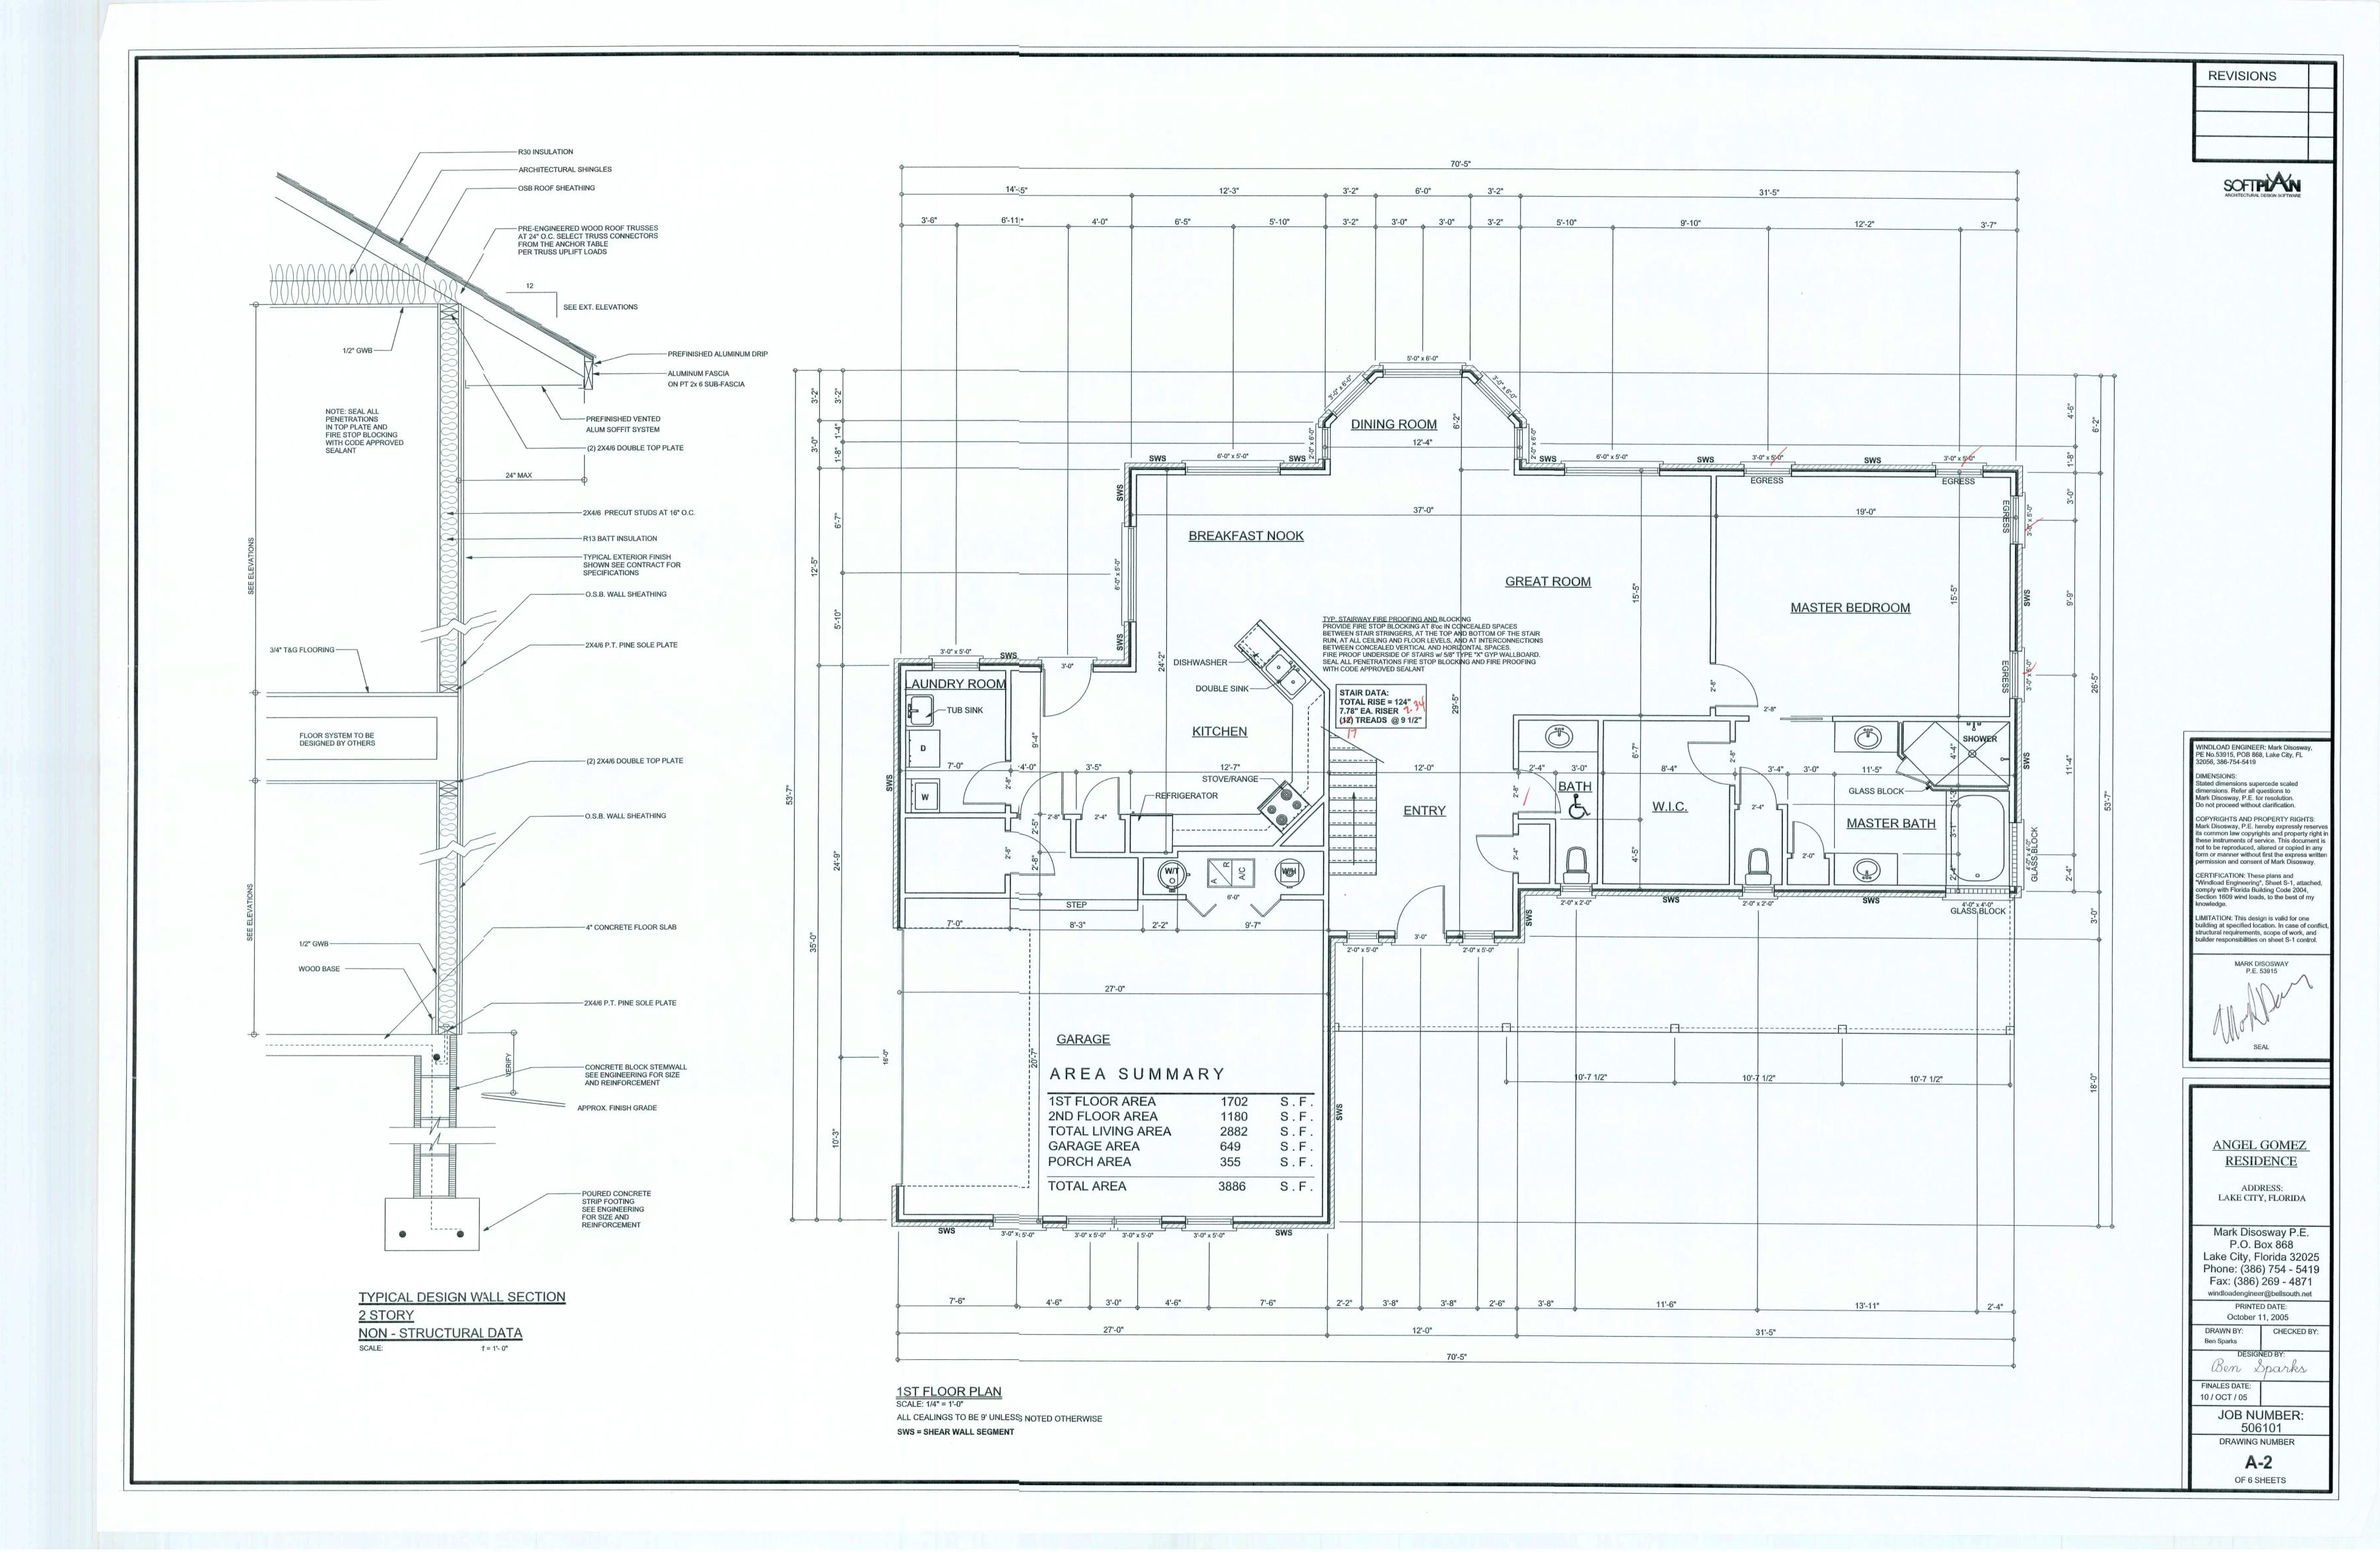

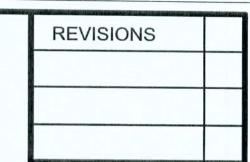

SOFTPIAN ARCHITECTURAL DESIGN SOFTWARE

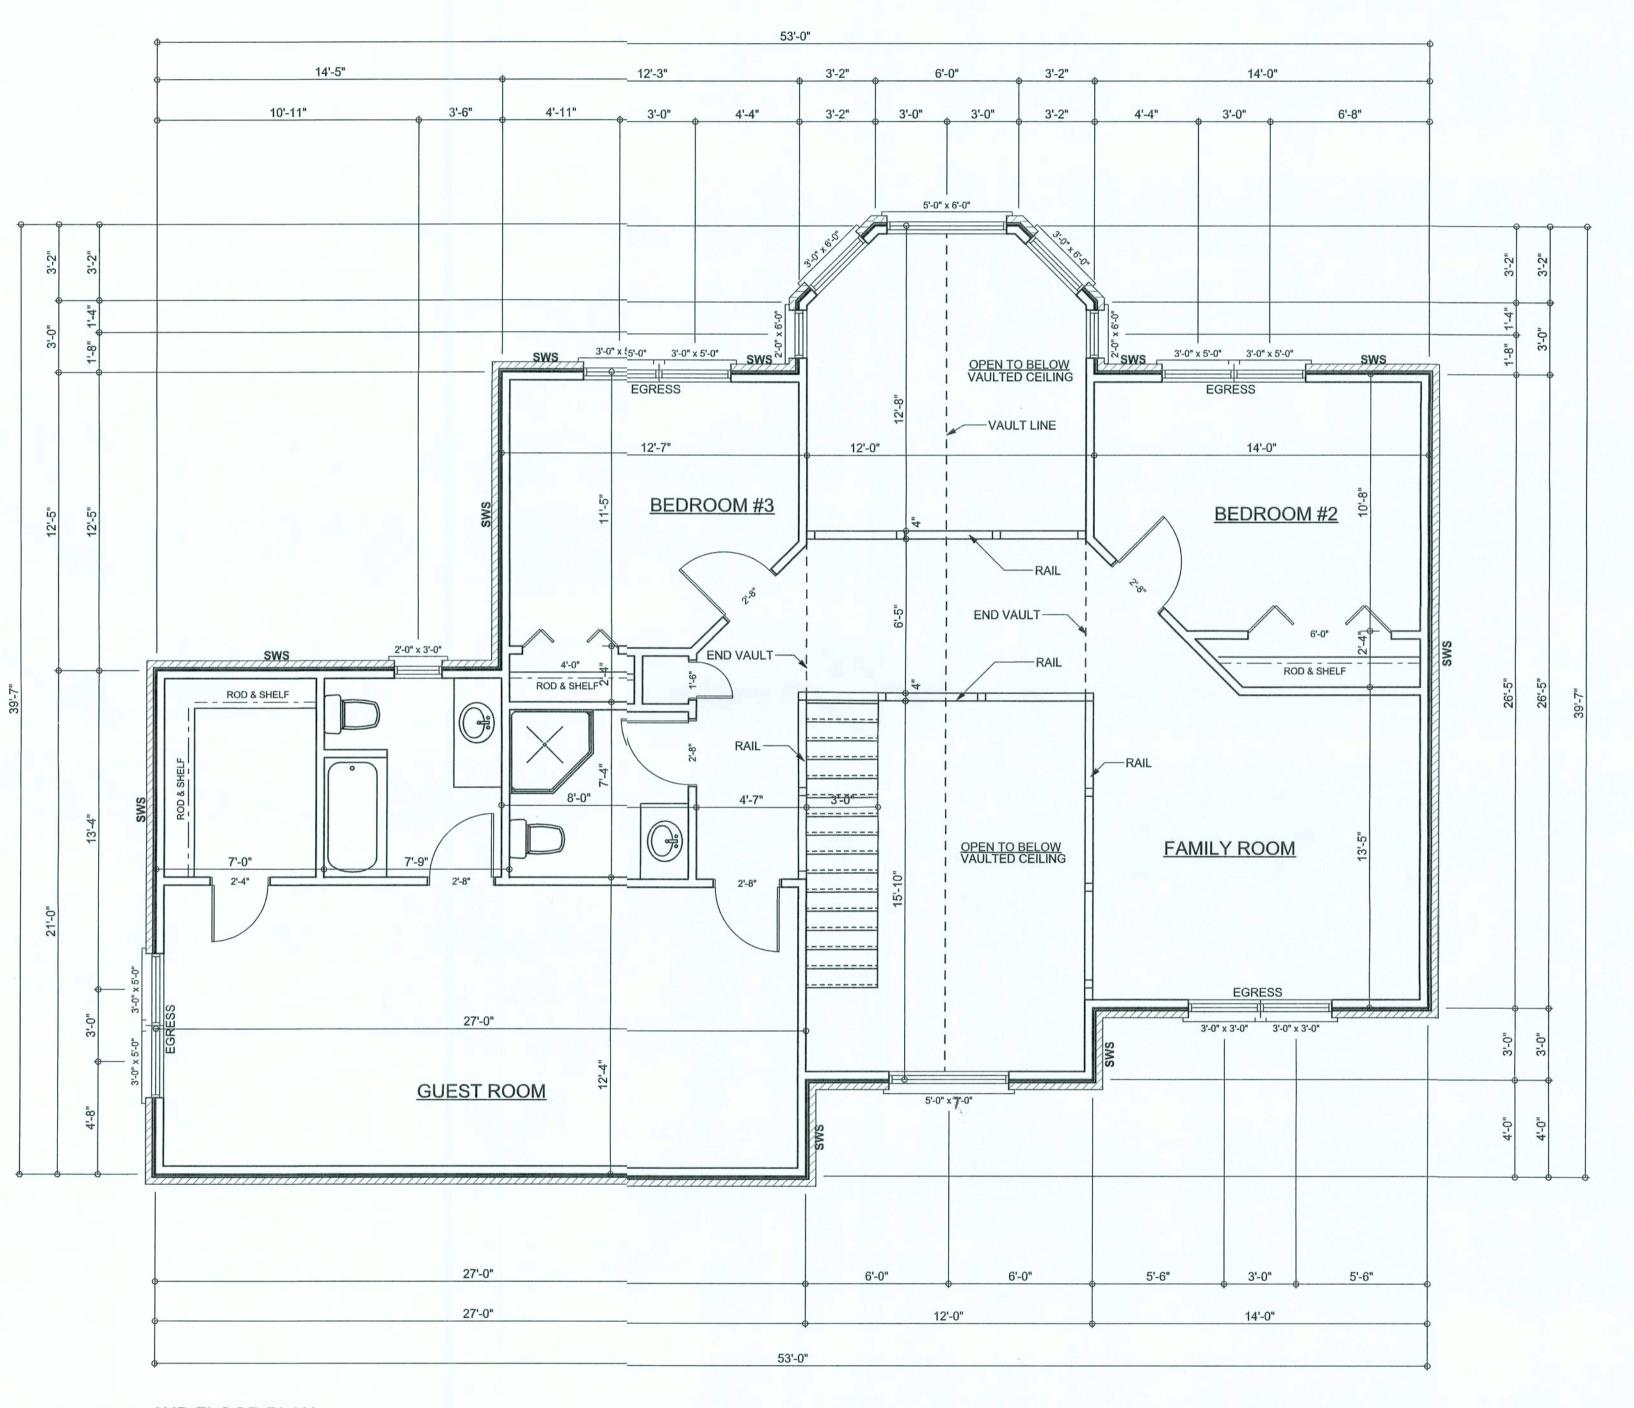

2ND FLOOR PLAN SCALE: 1/4" = 1'-0"

ALL CEALINGS TO BE 9' UNLESS NOTED OTHERWISE

SWS=SHEAR WALL SEGMENT

WINDLOAD ENGINEER: Mark Disosway, PE No.53915, POB 868, Lake City, FL 32056, 386-754-5419


DIMENSIONS: Stated dimensions supercede scaled dimensions. Refer all questions to Mark Disosway, P.E. for resolution. Do not proceed without clarification.

COPYRIGHTS AND PROPERTY RIGHTS:
Mark Disosway, P.E. hereby expressly reserves its common law copyrights and property right in these instruments of service. This document is not to be reproduced, altered or copied in any form or manner without first the express written permission and consent of Mark Disosway.

CERTIFICATION: These plans and "Windload Engineering", Sheet S-1, attached, comply with Florida Building Code 2004, Section 1609 wind loads, to the best of my knowledge.

knowledge.

LIMITATION: This design is valid for one building at specified location. In case of conflict, structural requirements, scope of work, and builder responsibilities on sheet S-1 control.

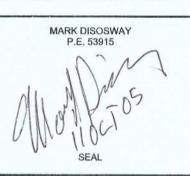

ANGEL GOMEZ RESIDENCE

ADDRESS: LAKE CITY, FLORIDA

Mark Disosway P.E.
P.O. Box 868
Lake City, Florida 32025
Phone: (386) 754 - 5419
Fax: (386) 269 - 4871
windloadengineer@bellsouth.net

PRINTED DATE: October 11, 2005

DRAWN BY:
Ben Sparks

DESIGNED BY:


Ben Sparks


FINALES DATE: 10 / OCT / 05


JOB NUMBER: 506101


DRAWING NUMBER

A-3 OF 6 SHEETS

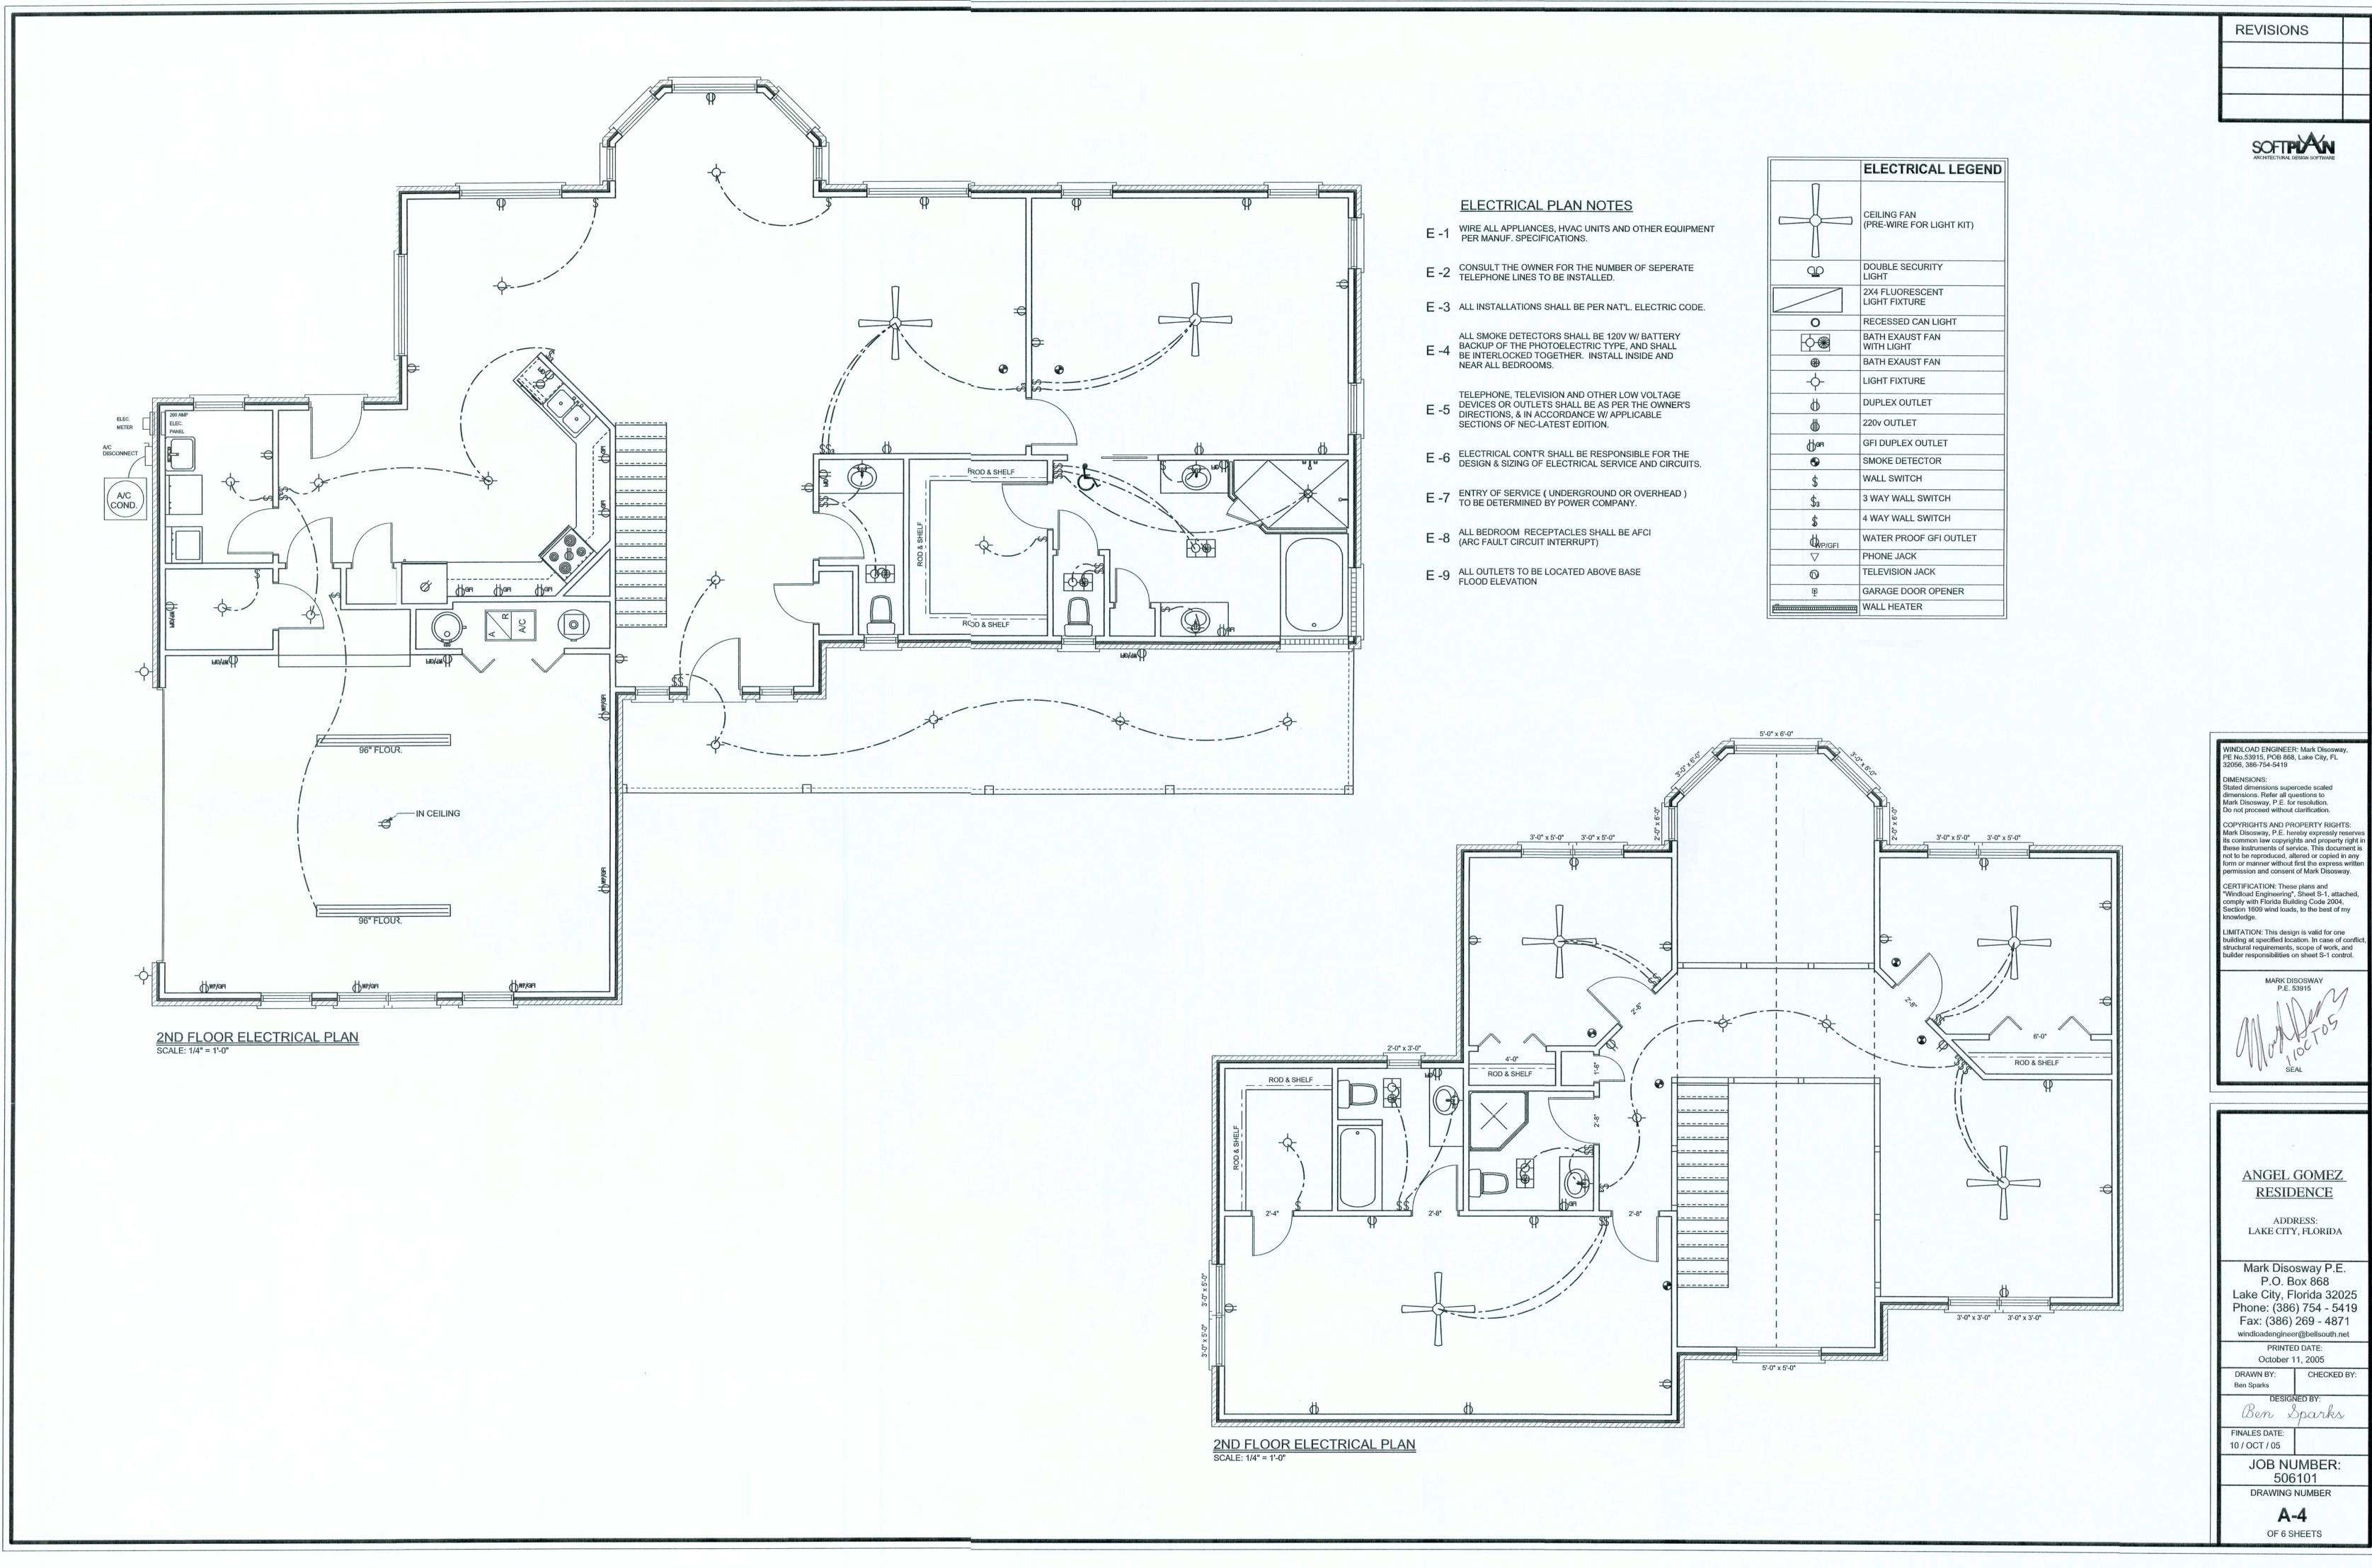

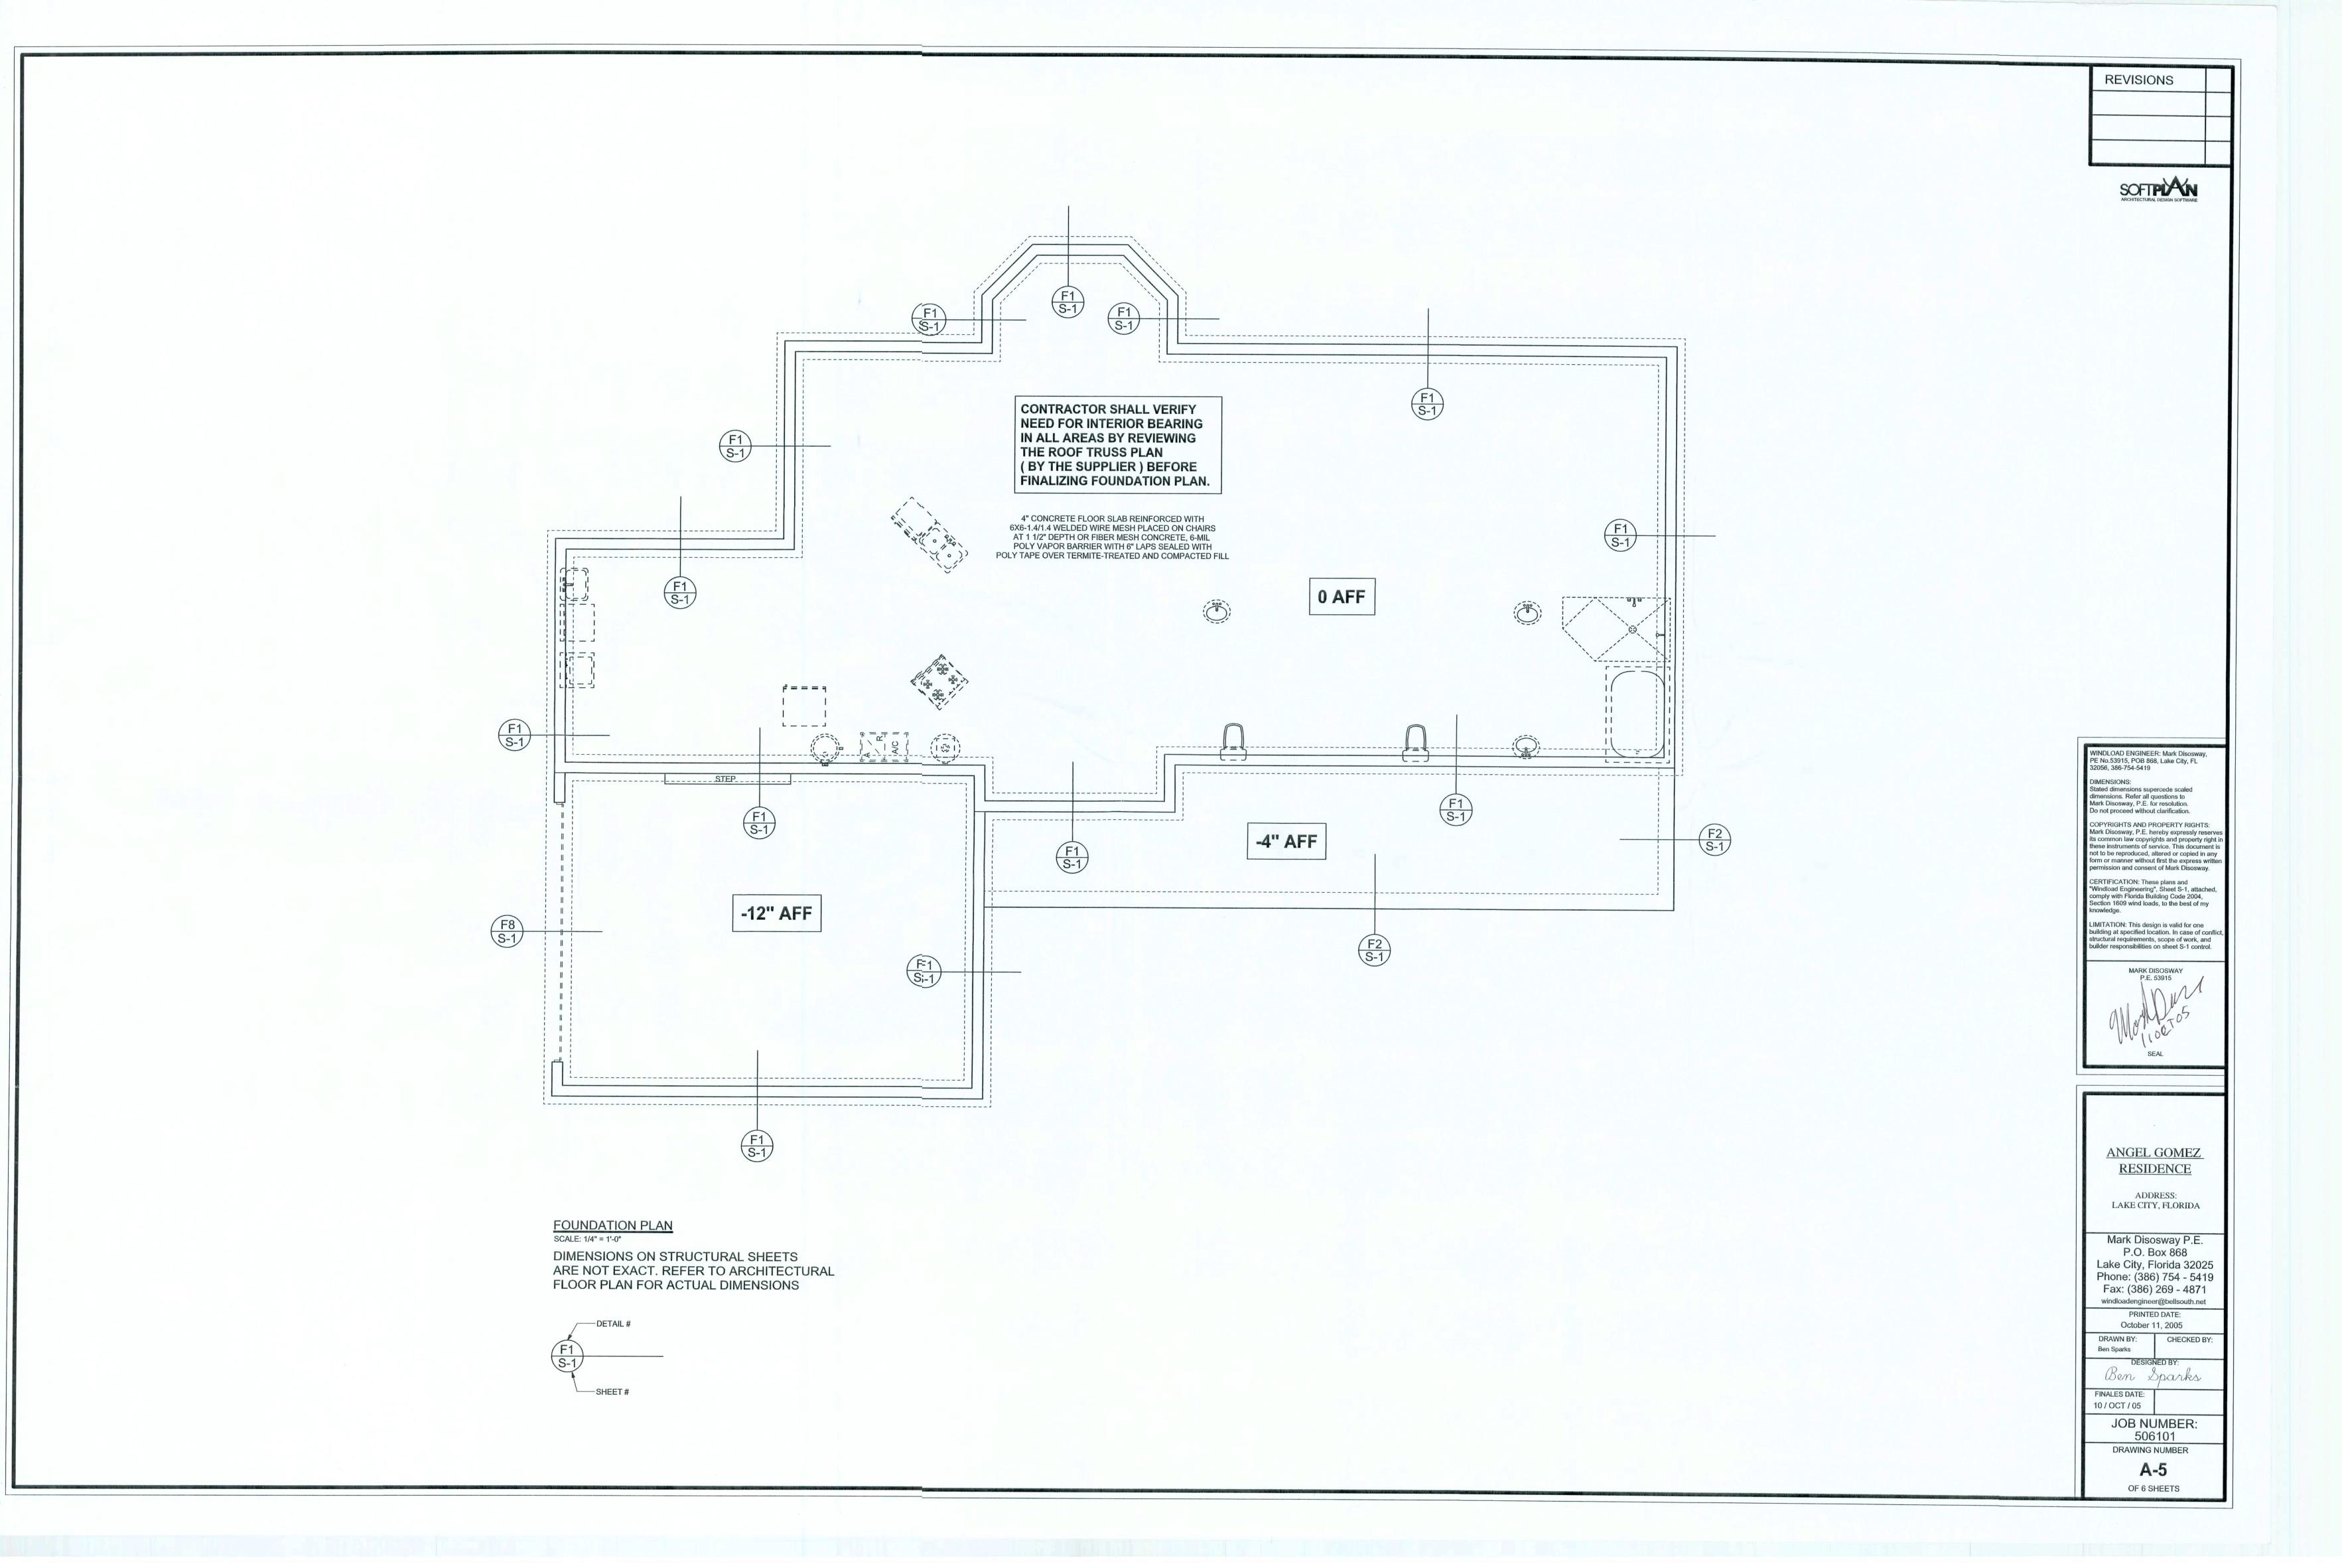

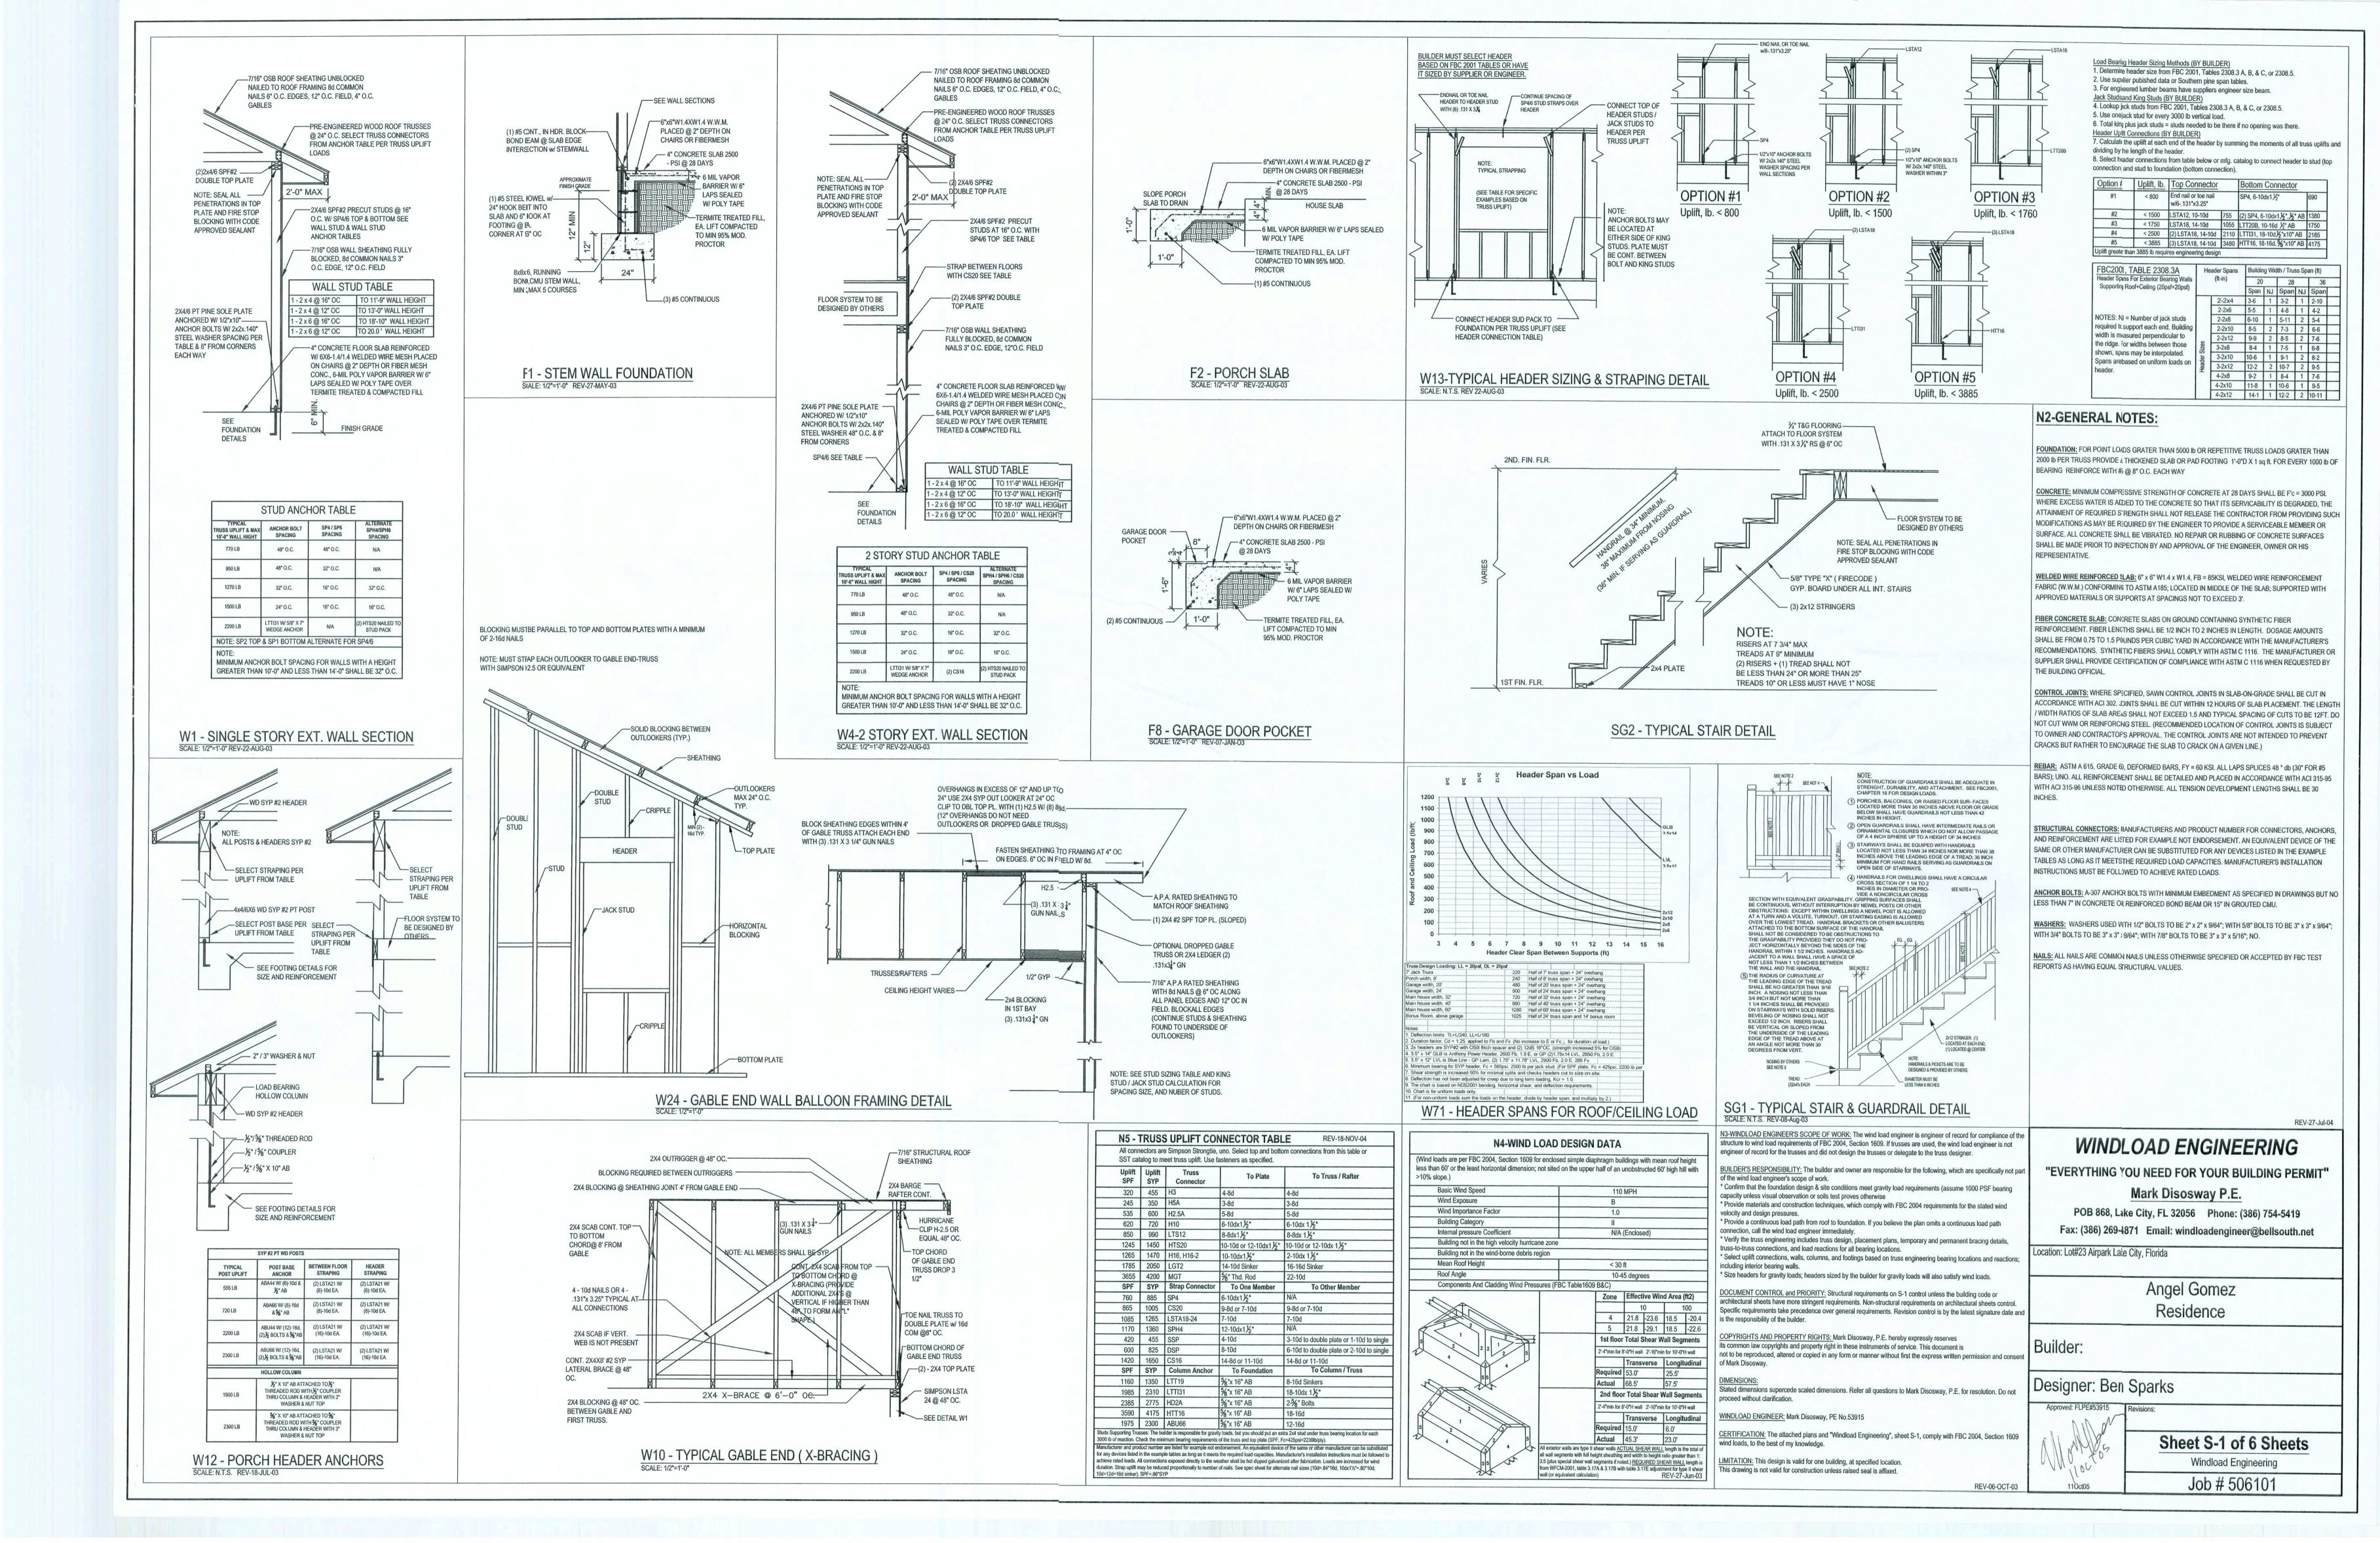

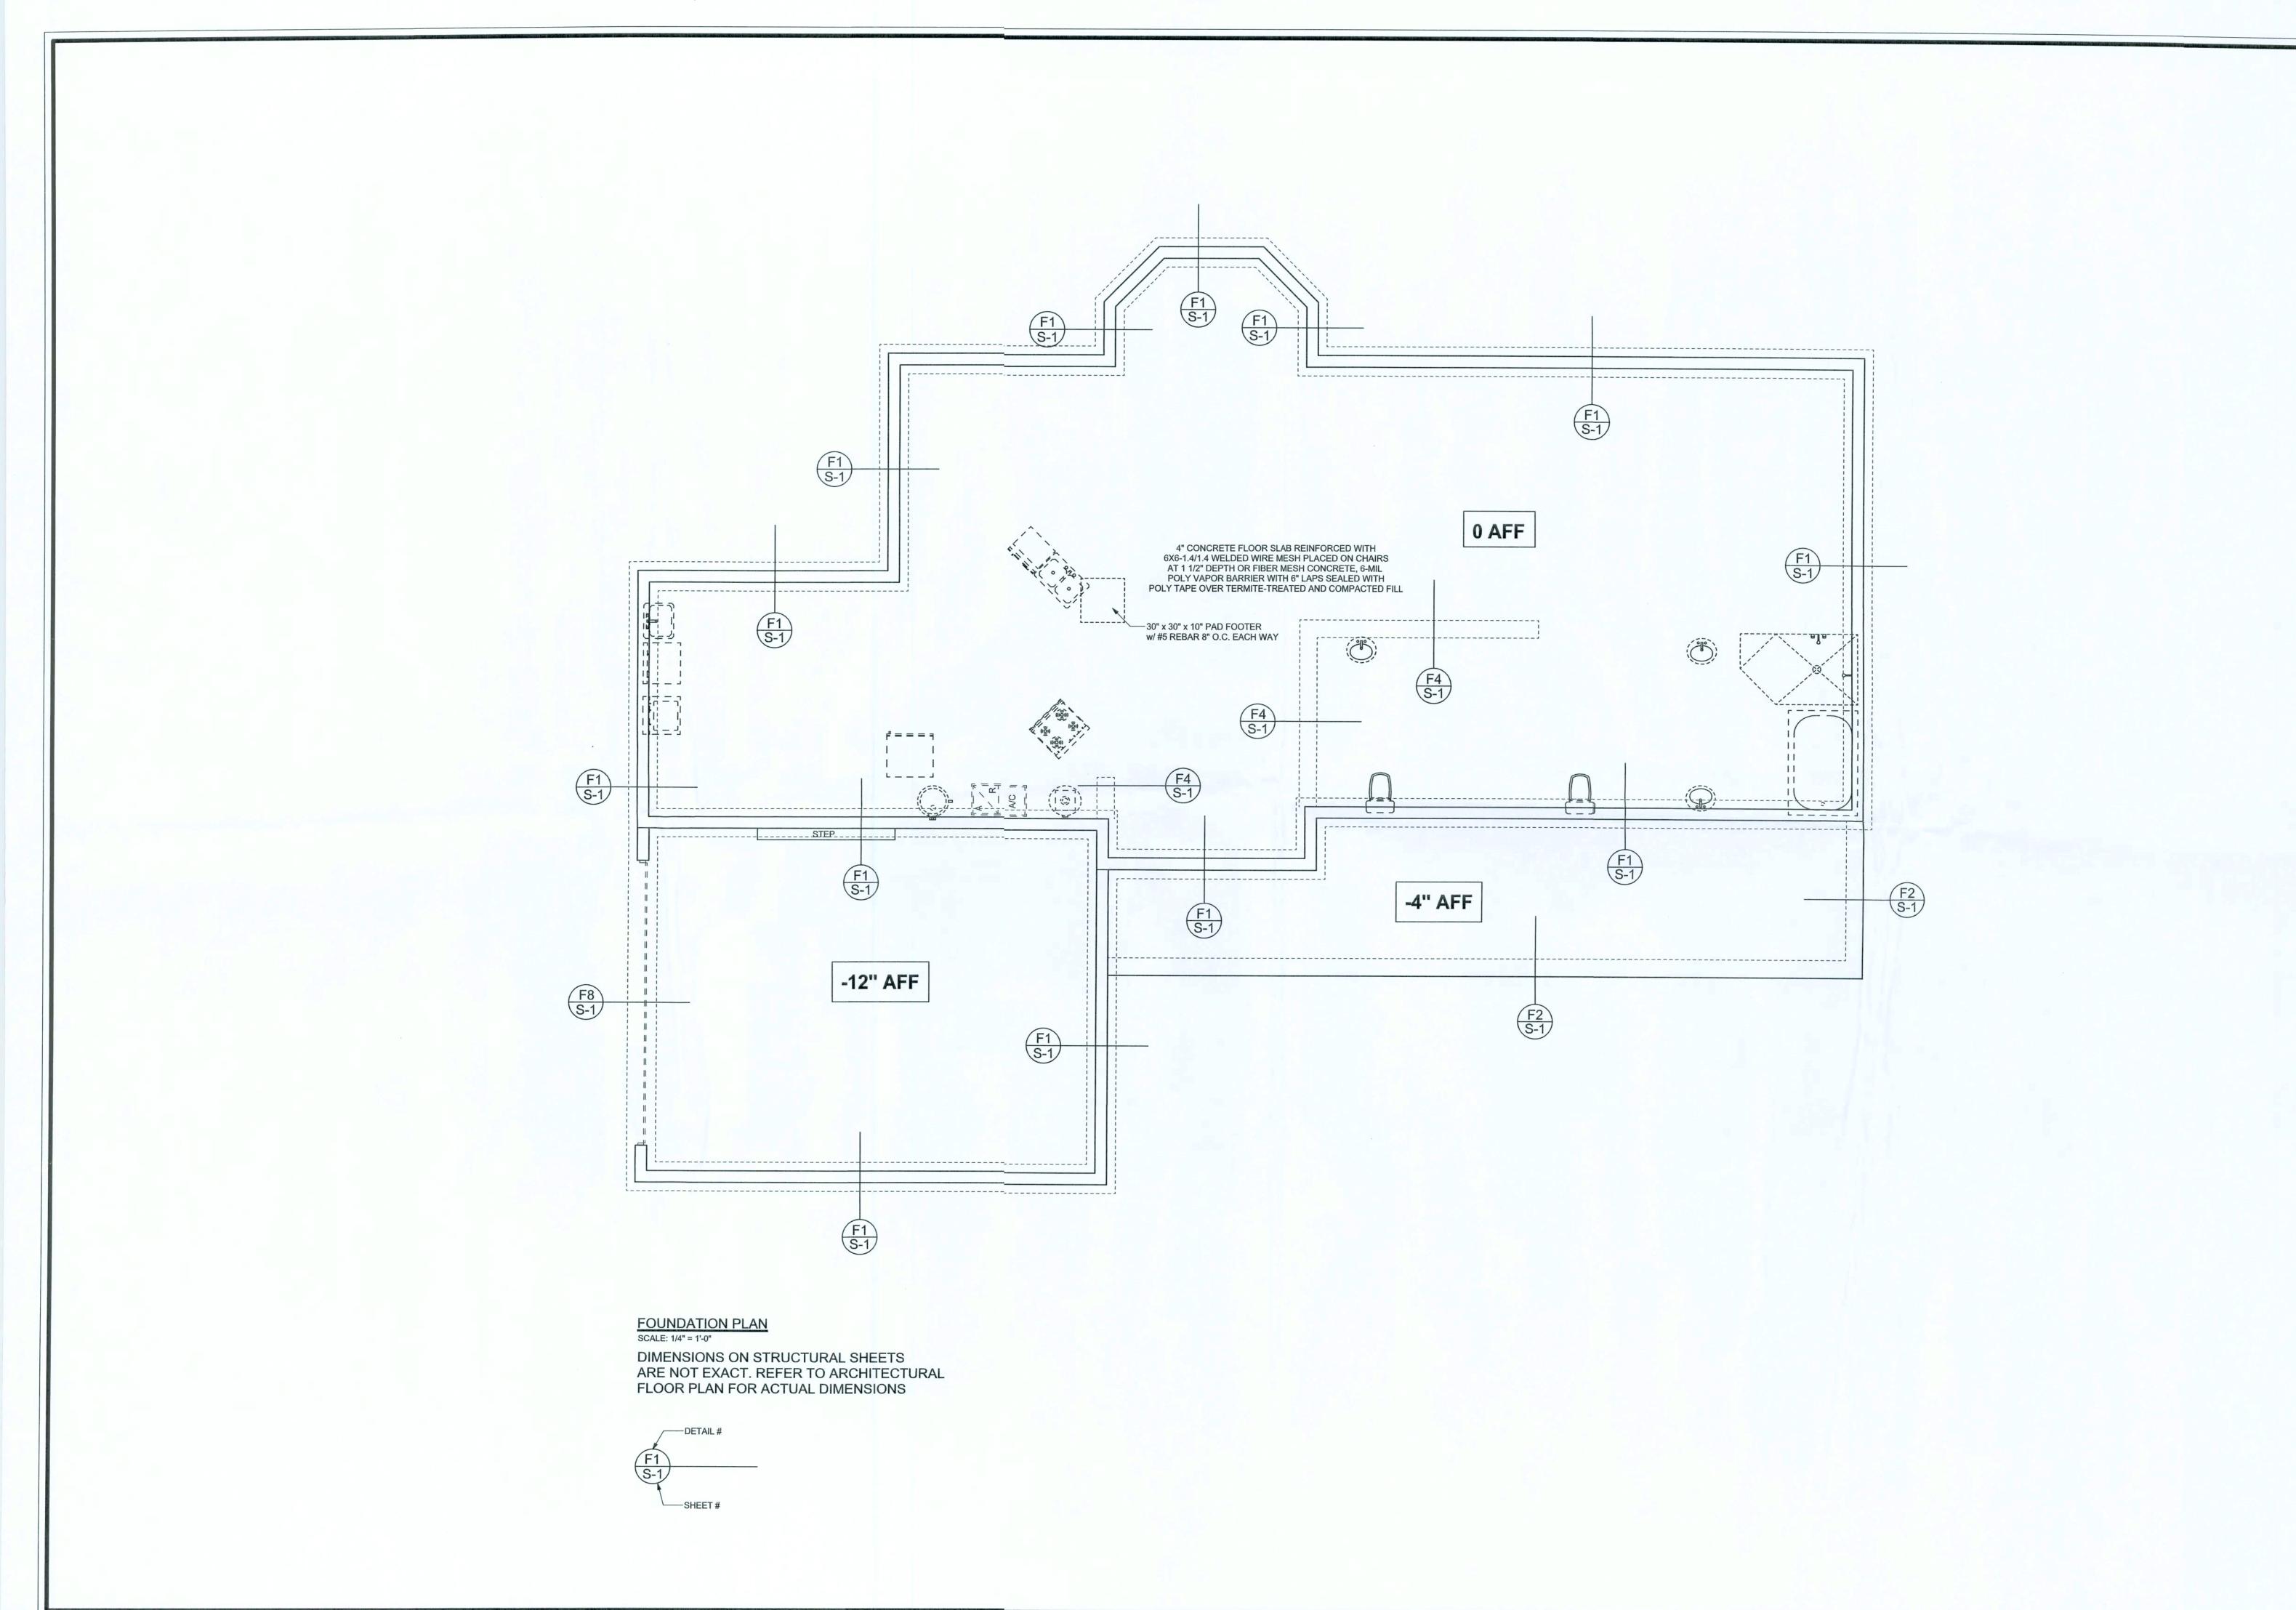

REVISIONS

SOFTPIAN ARCHITECTURAL DESIGN SOFTWARE



WINDLOAD ENGINEER: Mark Disosway, PE No.53915, POB 868, Lake City, FL 32056, 386-754-5419

DIMENSIONS: Stated dimensions supercede scaled dimensions. Refer all questions to Mark Disosway, P.E. for resolution. Do not proceed without clarification.

COPYRIGHTS AND PROPERTY RIGHTS: Mark Disosway, P.E. hereby expressly reserves its common law copyrights and property right in these instruments of service. This document is not to be reproduced, altered or copied in any form or manner without first the express written permission and consent of Mark Disosway.

not to be reproduced, altered or copied in any form or manner without first the express written permission and consent of Mark Disosway.

CERTIFICATION: These plans and "Windload Engineering", Sheet S-1, attached, comply with Florida Building Code 2004, Section 1609 wind loads, to the best of my

LIMITATION: This design is valid for one building at specified location. In case of conflict, structural requirements, scope of work, and builder responsibilities on sheet S-1 control.

MARK DISOSWAY
P.E. 53915

Mark DISOSWAY
P.E. 73915

MARK DISOSWAY
P.E. 73915

SEAL

ANGEL GOMEZ RESIDENCE

ADDRESS: LAKE CITY, FLORIDA

Mark Disosway P.E.
P.O. Box 868
Lake City, Florida 32025
Phone: (386) 754 - 5419
Fax: (386) 269 - 4871
windloadengineer@bellsouth.net

PRINTED DATE:
April 14, 2006

DRAWN BY: CHECKED BY:
Ben Sparks


Ben Sparks


FINALES DATE: 10 / OCT / 05

JOB NUMBER: 506101

DRAWING NUMBER


A-5 OF 6 SHEETS

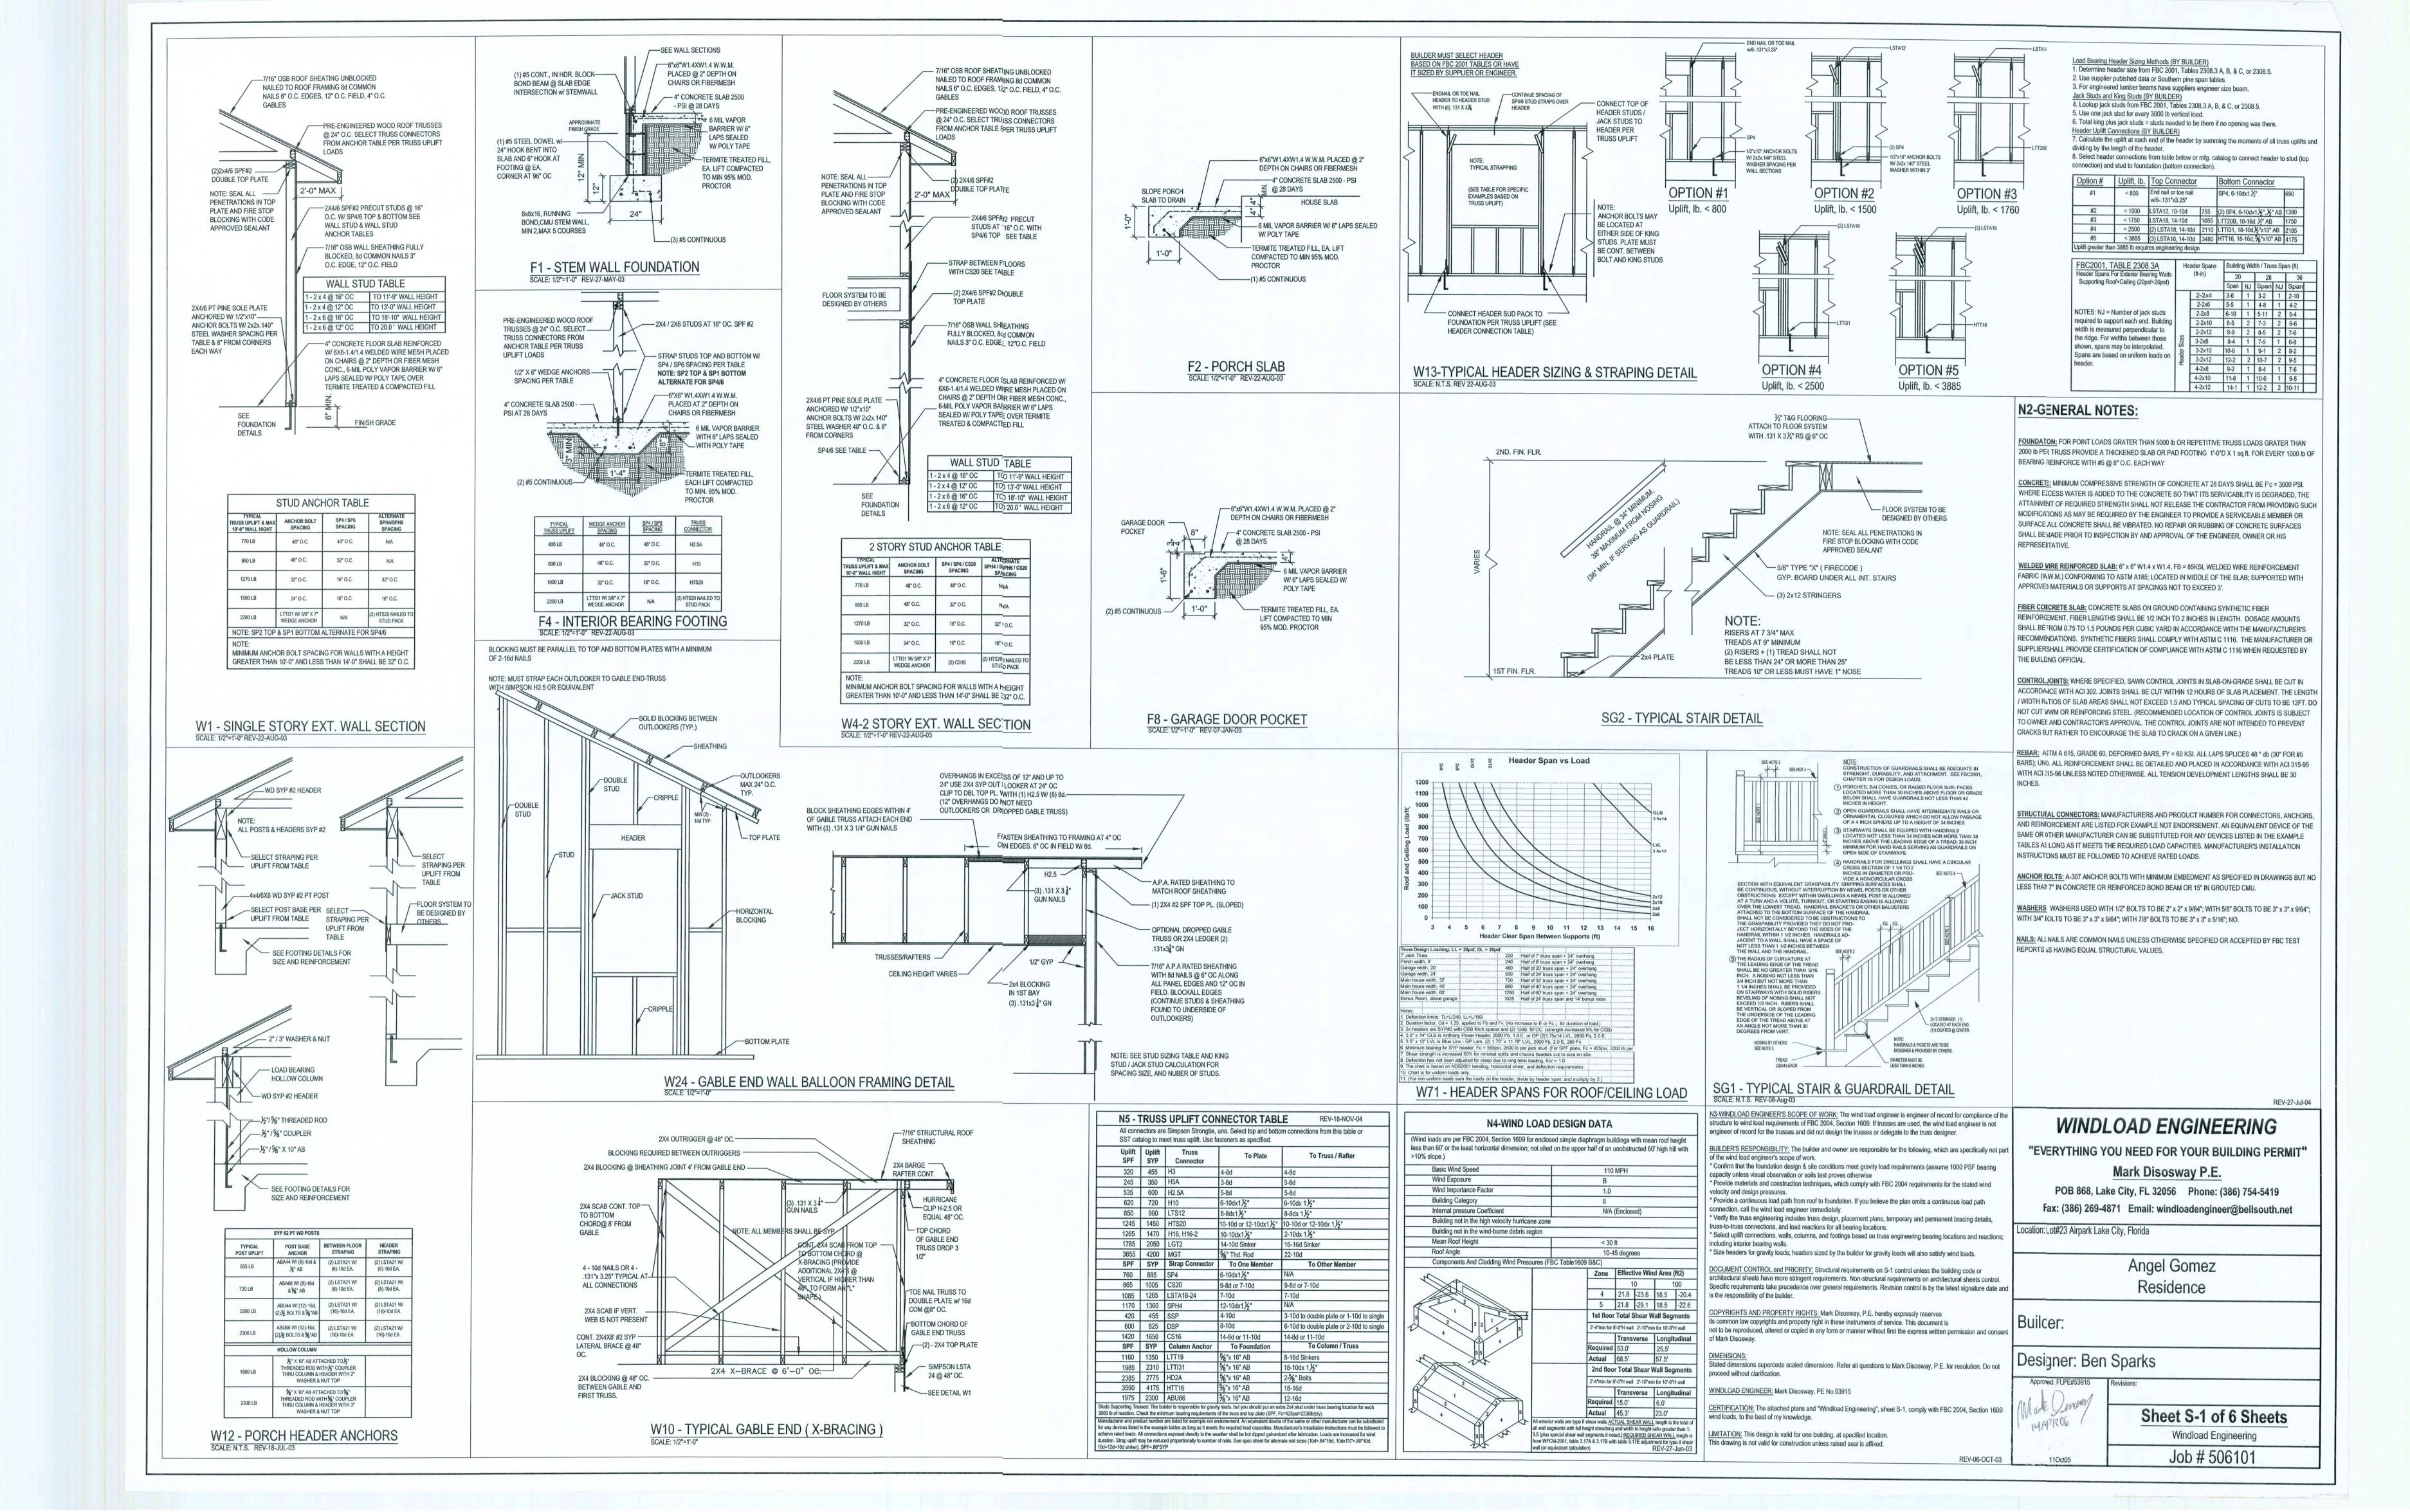

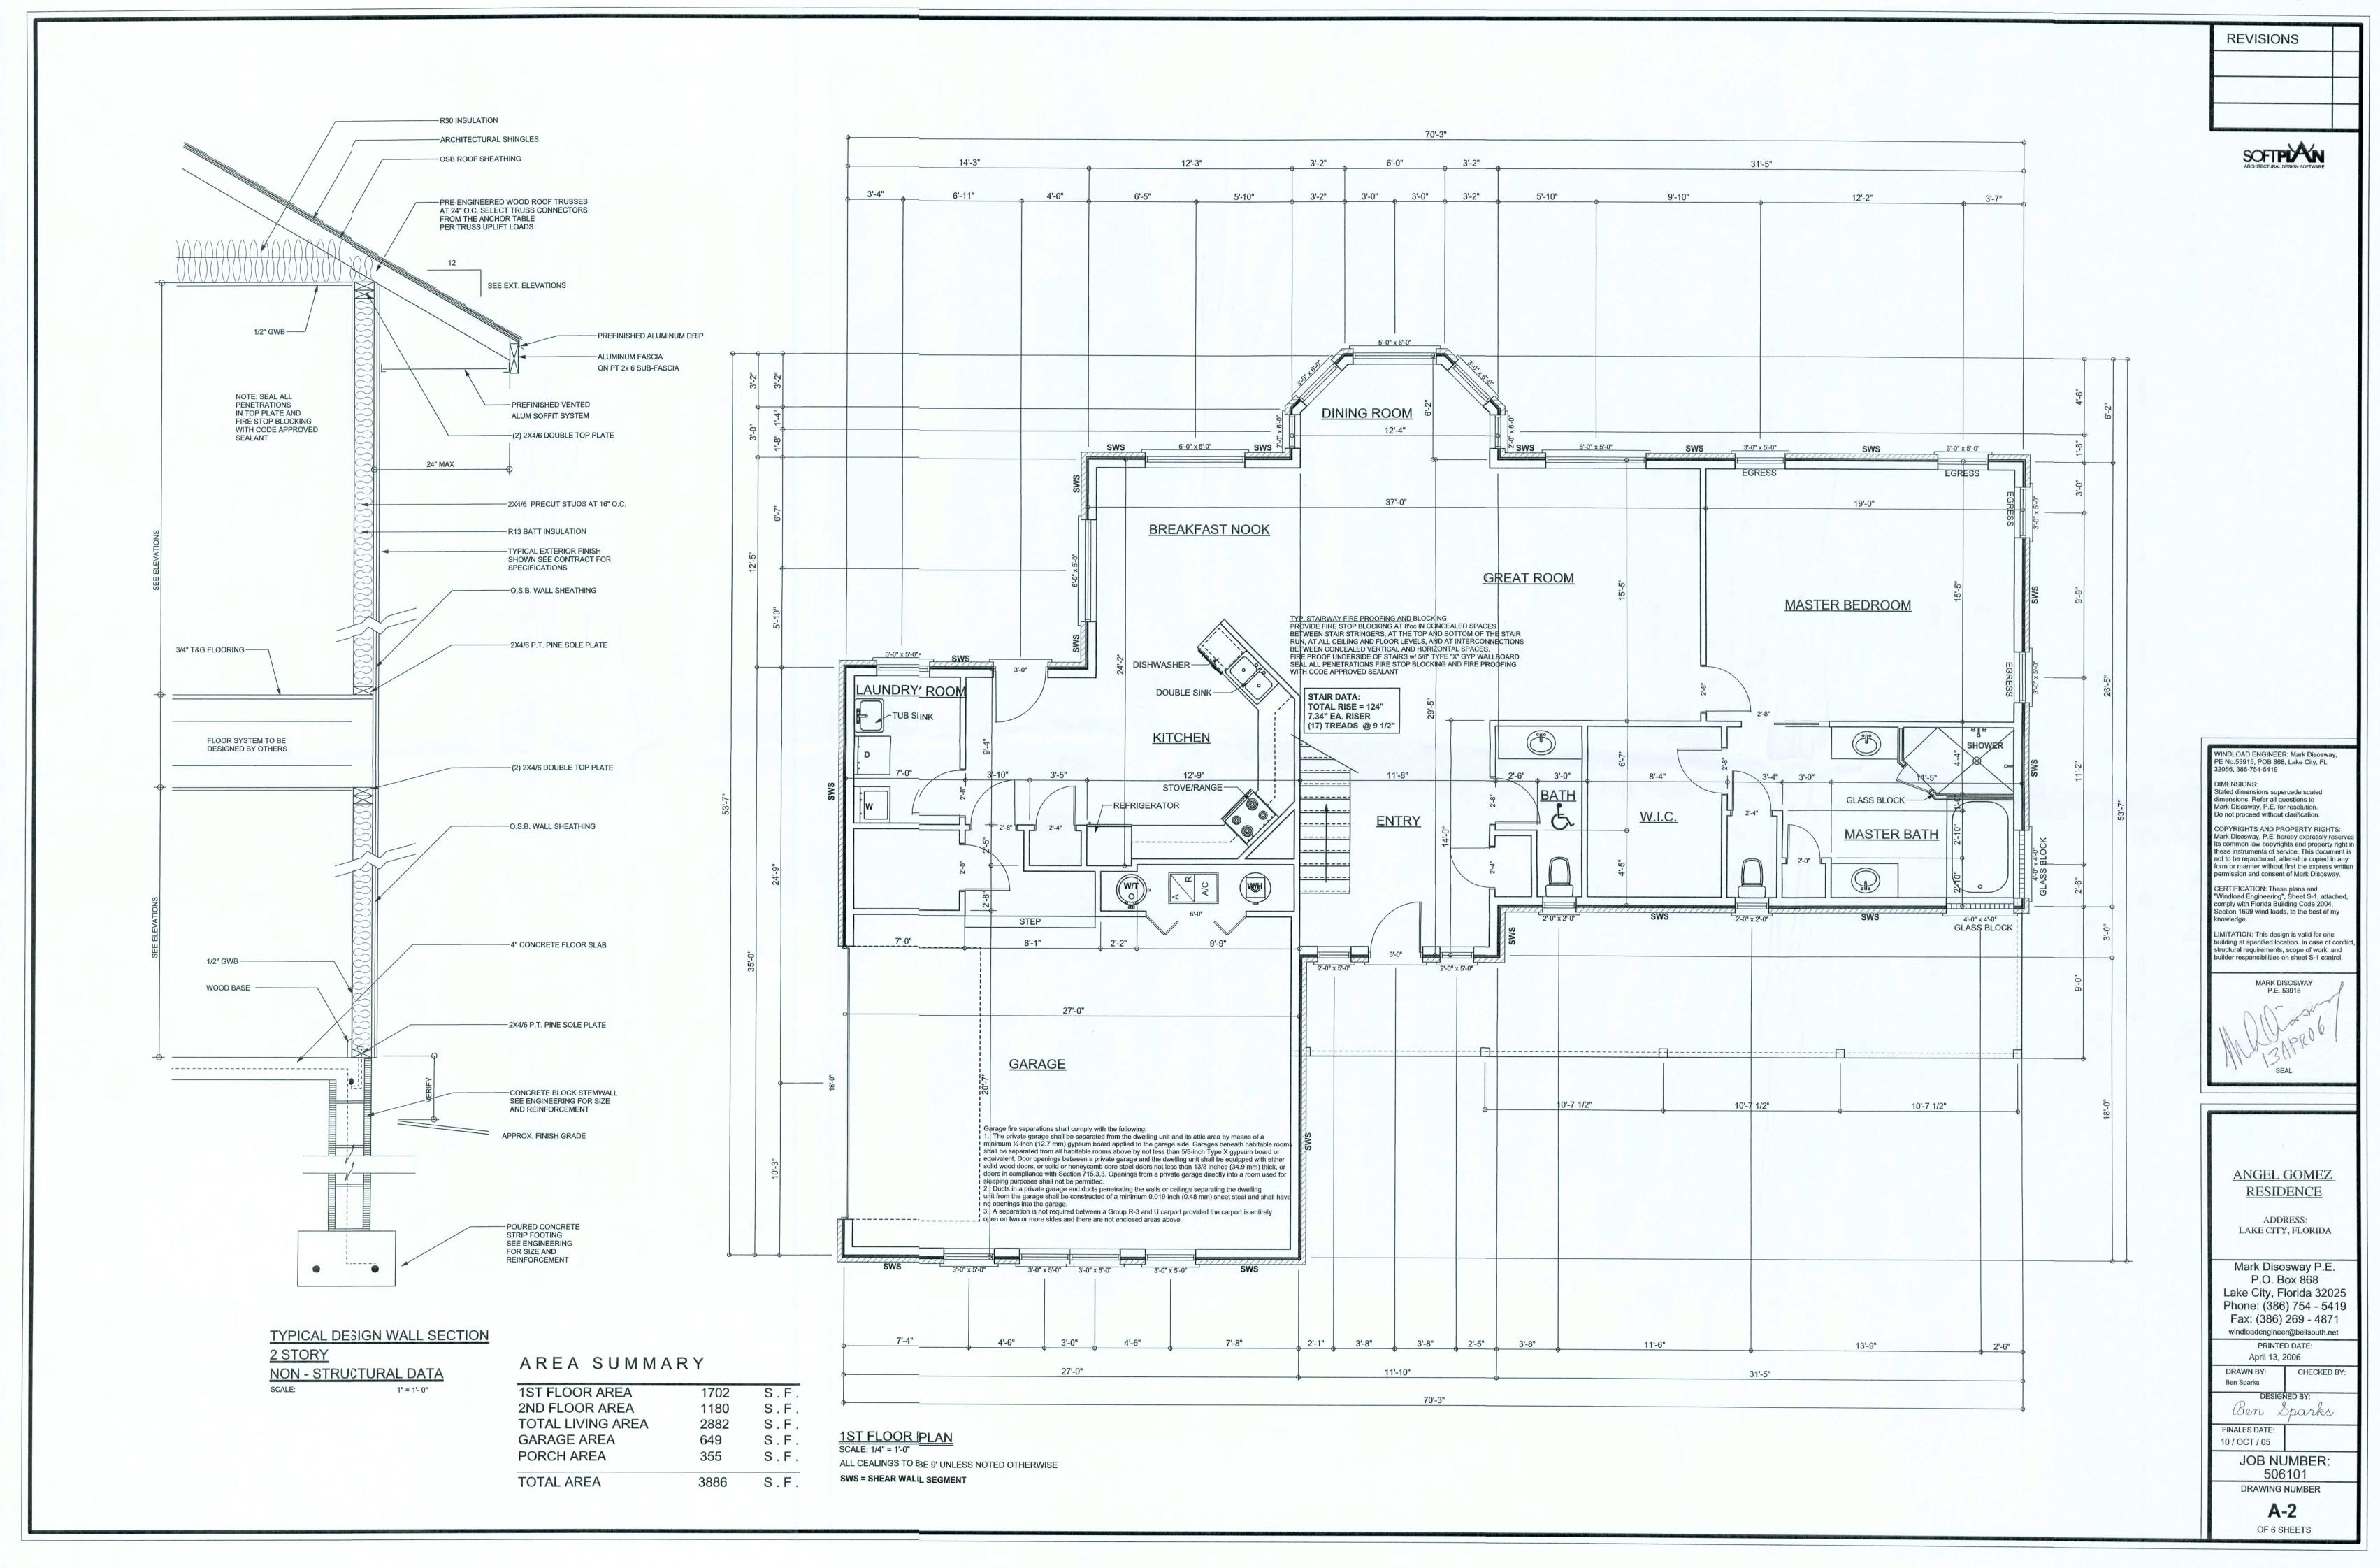

REVISIONS

SOFTPIAN ARCHITECTURAL DESIGN SOFTWARE

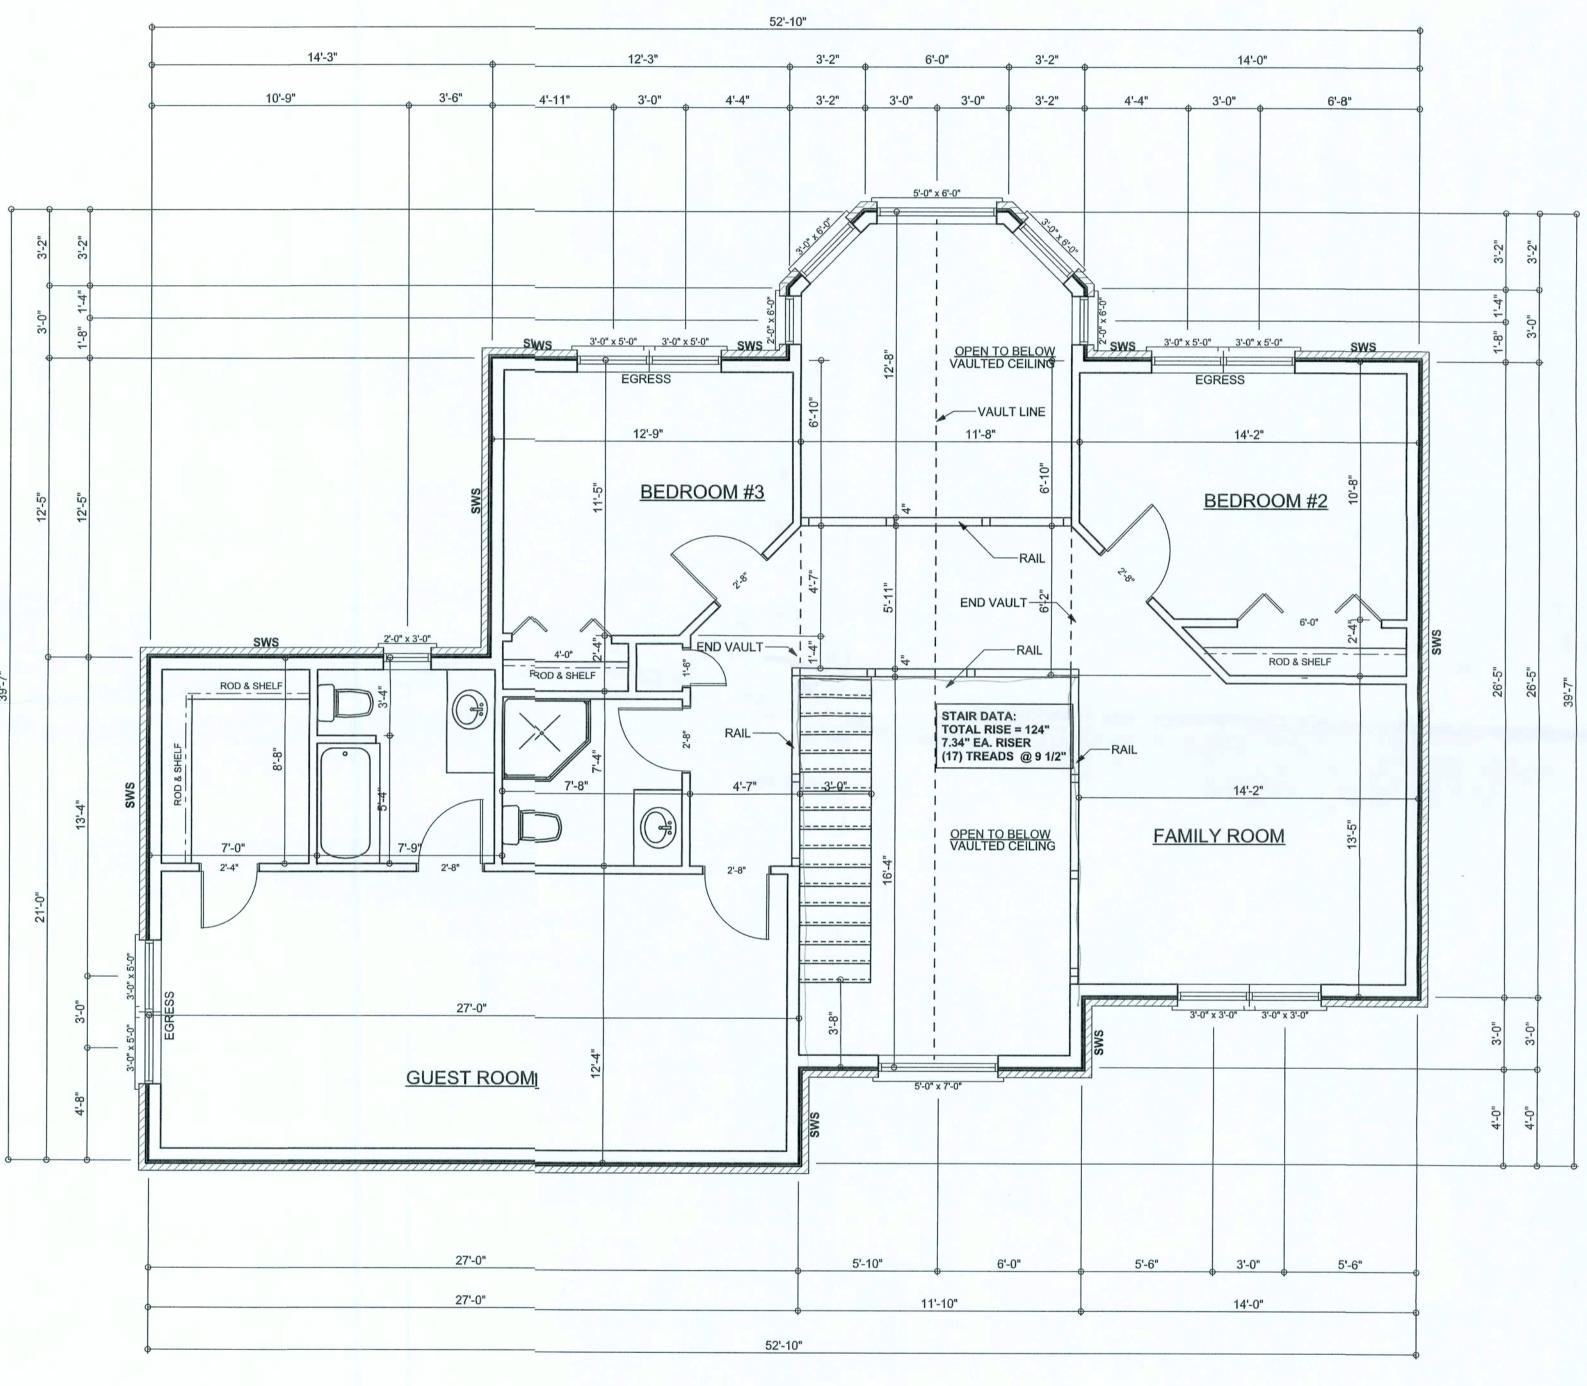

2ND FLOOR PLAN
SCALE: 1/4" = 1'-0"
ALL CEALINGS TO BE 9' UNLESS NOTED OTHERWISE
SWS=SHEAR WALL SEGMENT

WINDLOAD ENGINEER: Mark Disosway, PE No.53915, POB 868, Lake City, FL 32056, 386-754-5419

DIMENSIONS: Stated dimensions supercede scaled dimensions. Refer all questions to Mark Disosway, P.E. for resolution. Do not proceed without clarification.

COPYRIGHTS AND PROPERTY RIGHTS:
Mark Disosway, P.E. hereby expressly reserves its common law copyrights and property right in these instruments of service. This document is not to be reproduced, altered or copied in any form or manner without first the express written permission and consent of Mark Disosway.

CERTIFICATION: These plans and "Windload Engineering", Sheet S-1, attached, comply with Florida Building Code 2004, Section 1609 wind loads, to the best of my knowledge.

LIMITATION: This design is valid for one building at specified location. In case of conflict, structural requirements, scope of work, and builder responsibilities on sheet S-1 control.

MARK DISOSWAY
P.E. 53915

SEAL

ANGEL GOMEZ RESIDENCE

ADDRESS: LAKE CITY, FLORIDA

Mark Disosway P.E.
P.O. Box 868
Lake City, Florida 32025
Phone: (386) 754 - 5419
Fax: (386) 269 - 4871

windloadengineer@bellsouth.net
PRINTED DATE:
April 13, 2006


DRAWN BY: CHECKED BY:
Ben Sparks


DESIGNED BY: Ben Sparks

FINALES DATE: 10 / OCT / 05 JOB NUMBER:


506101 DRAWING NUMBER

> A-3 OF 6 SHEETS

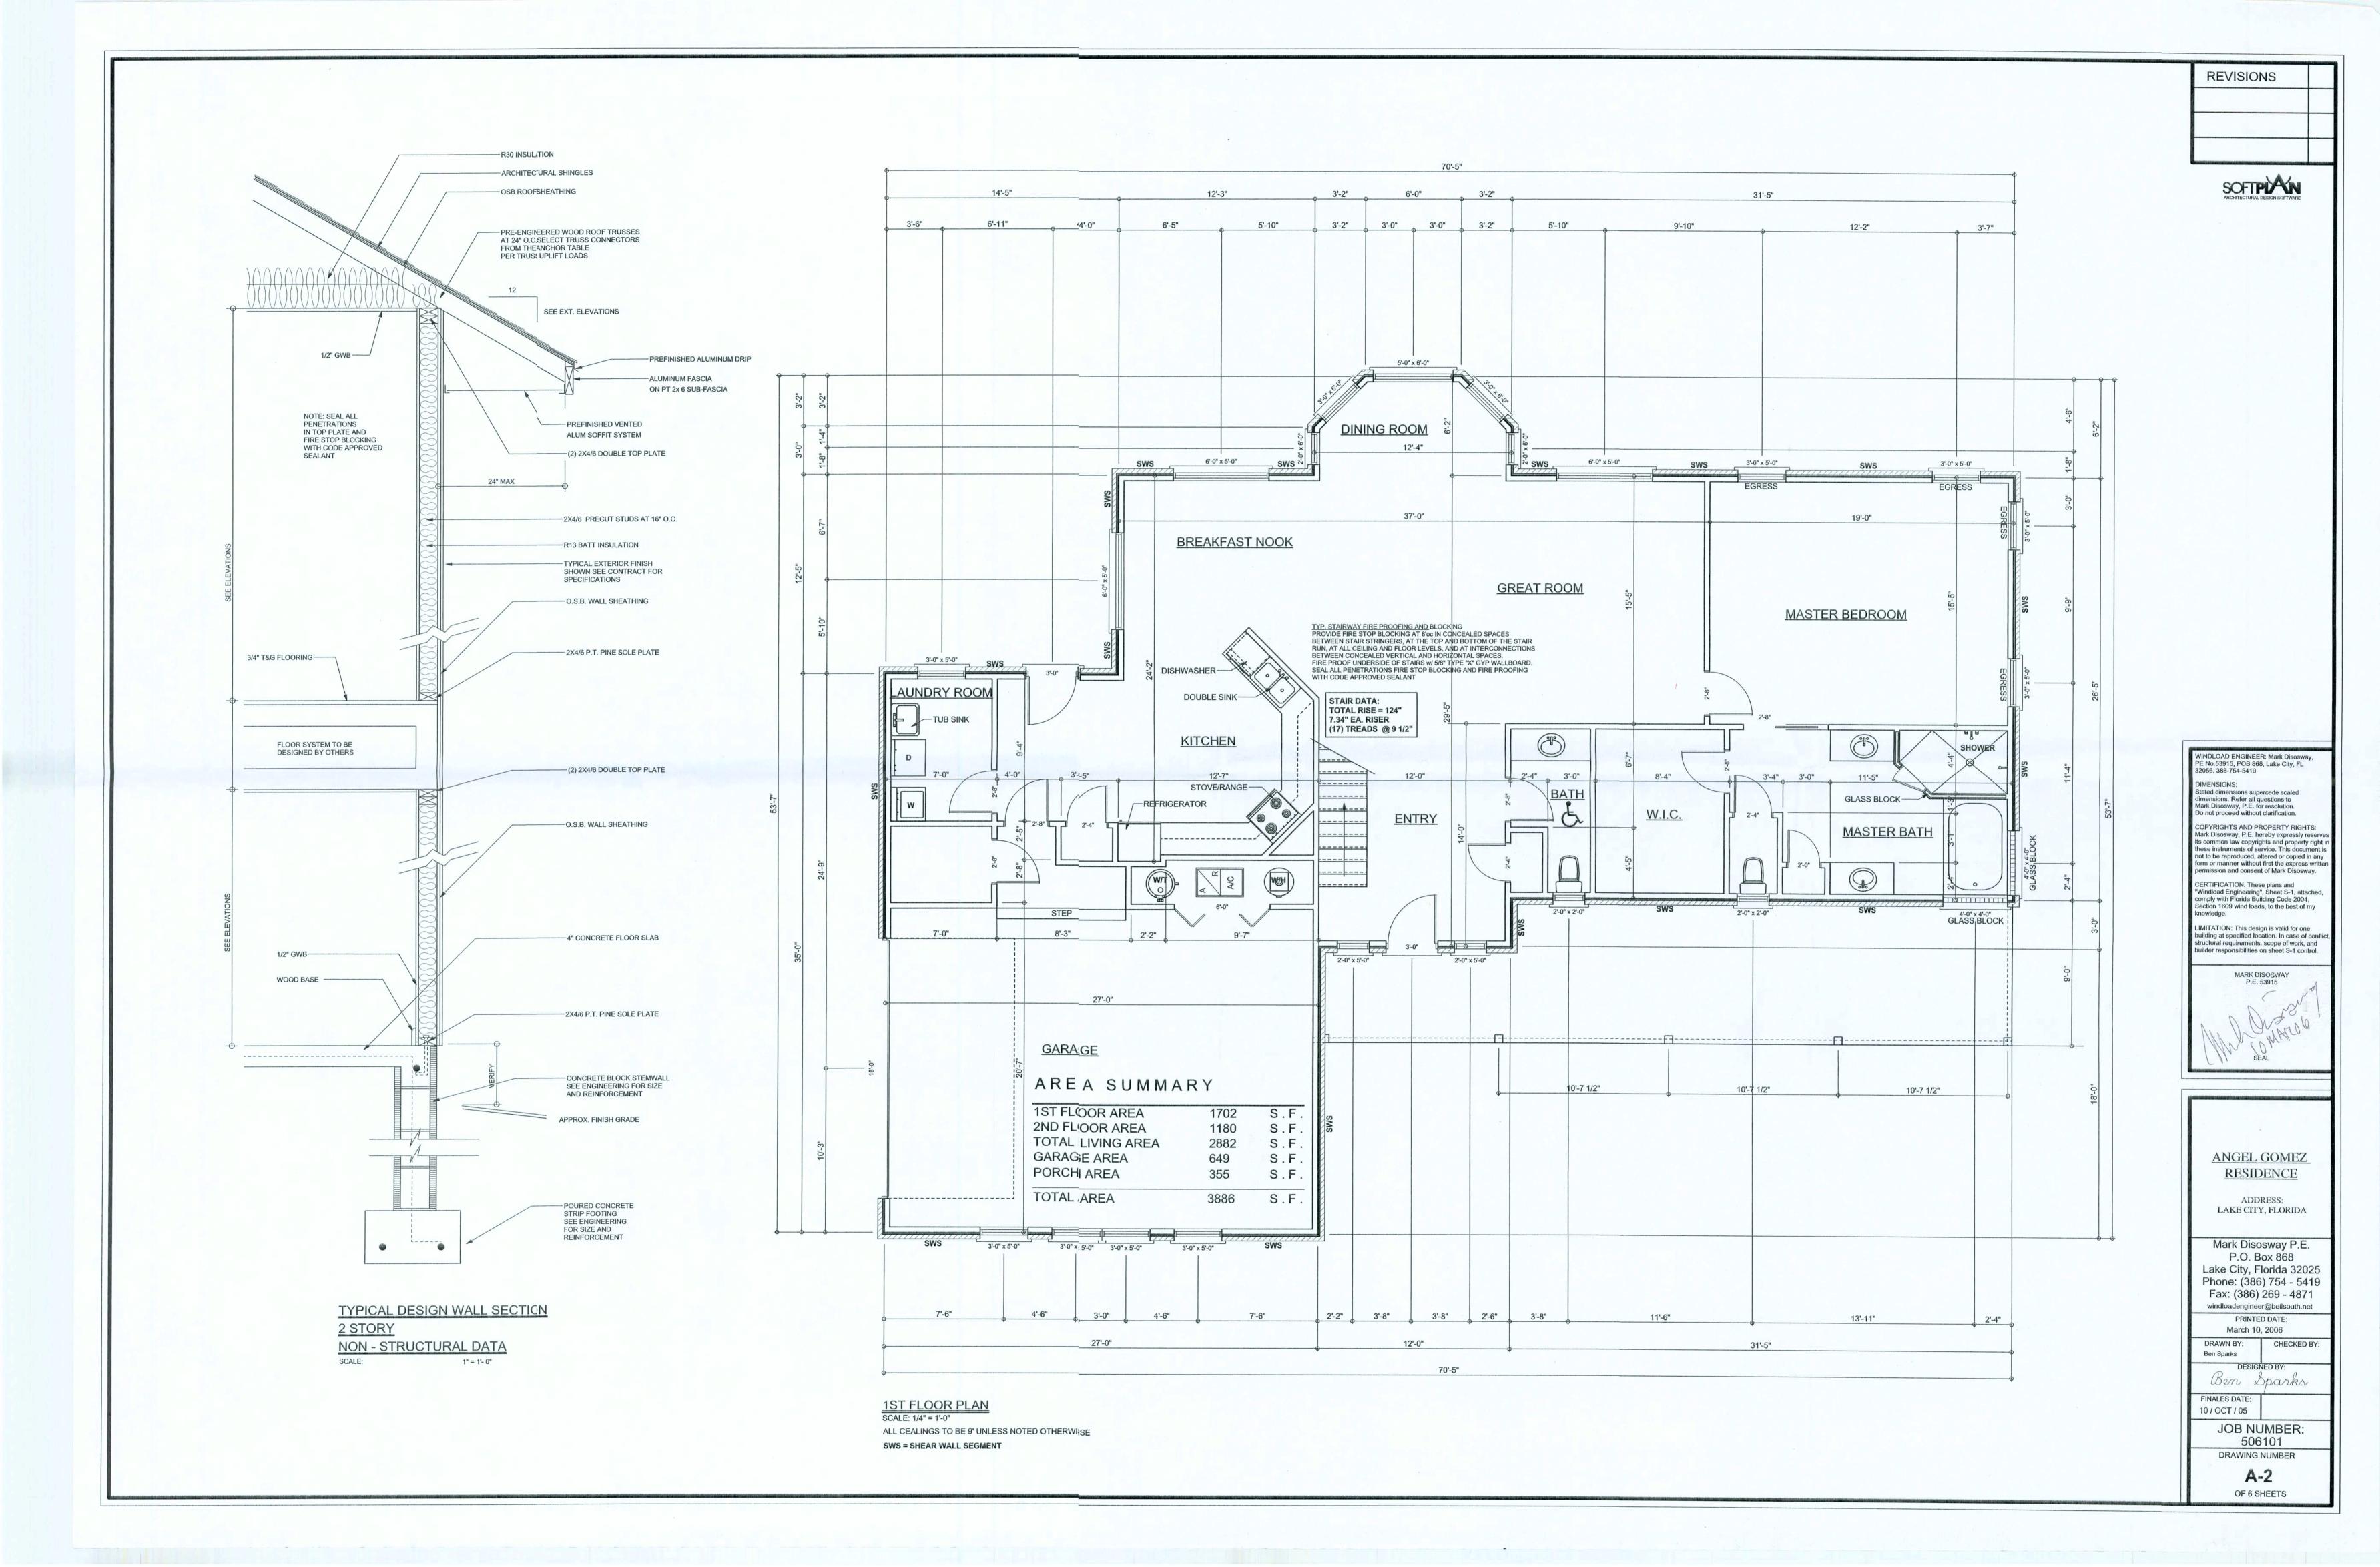

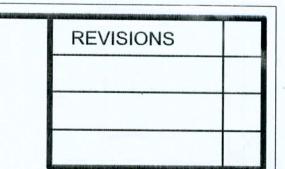

SOFTPIAN ARCHITECTURAL DESIGN SOFTWARE

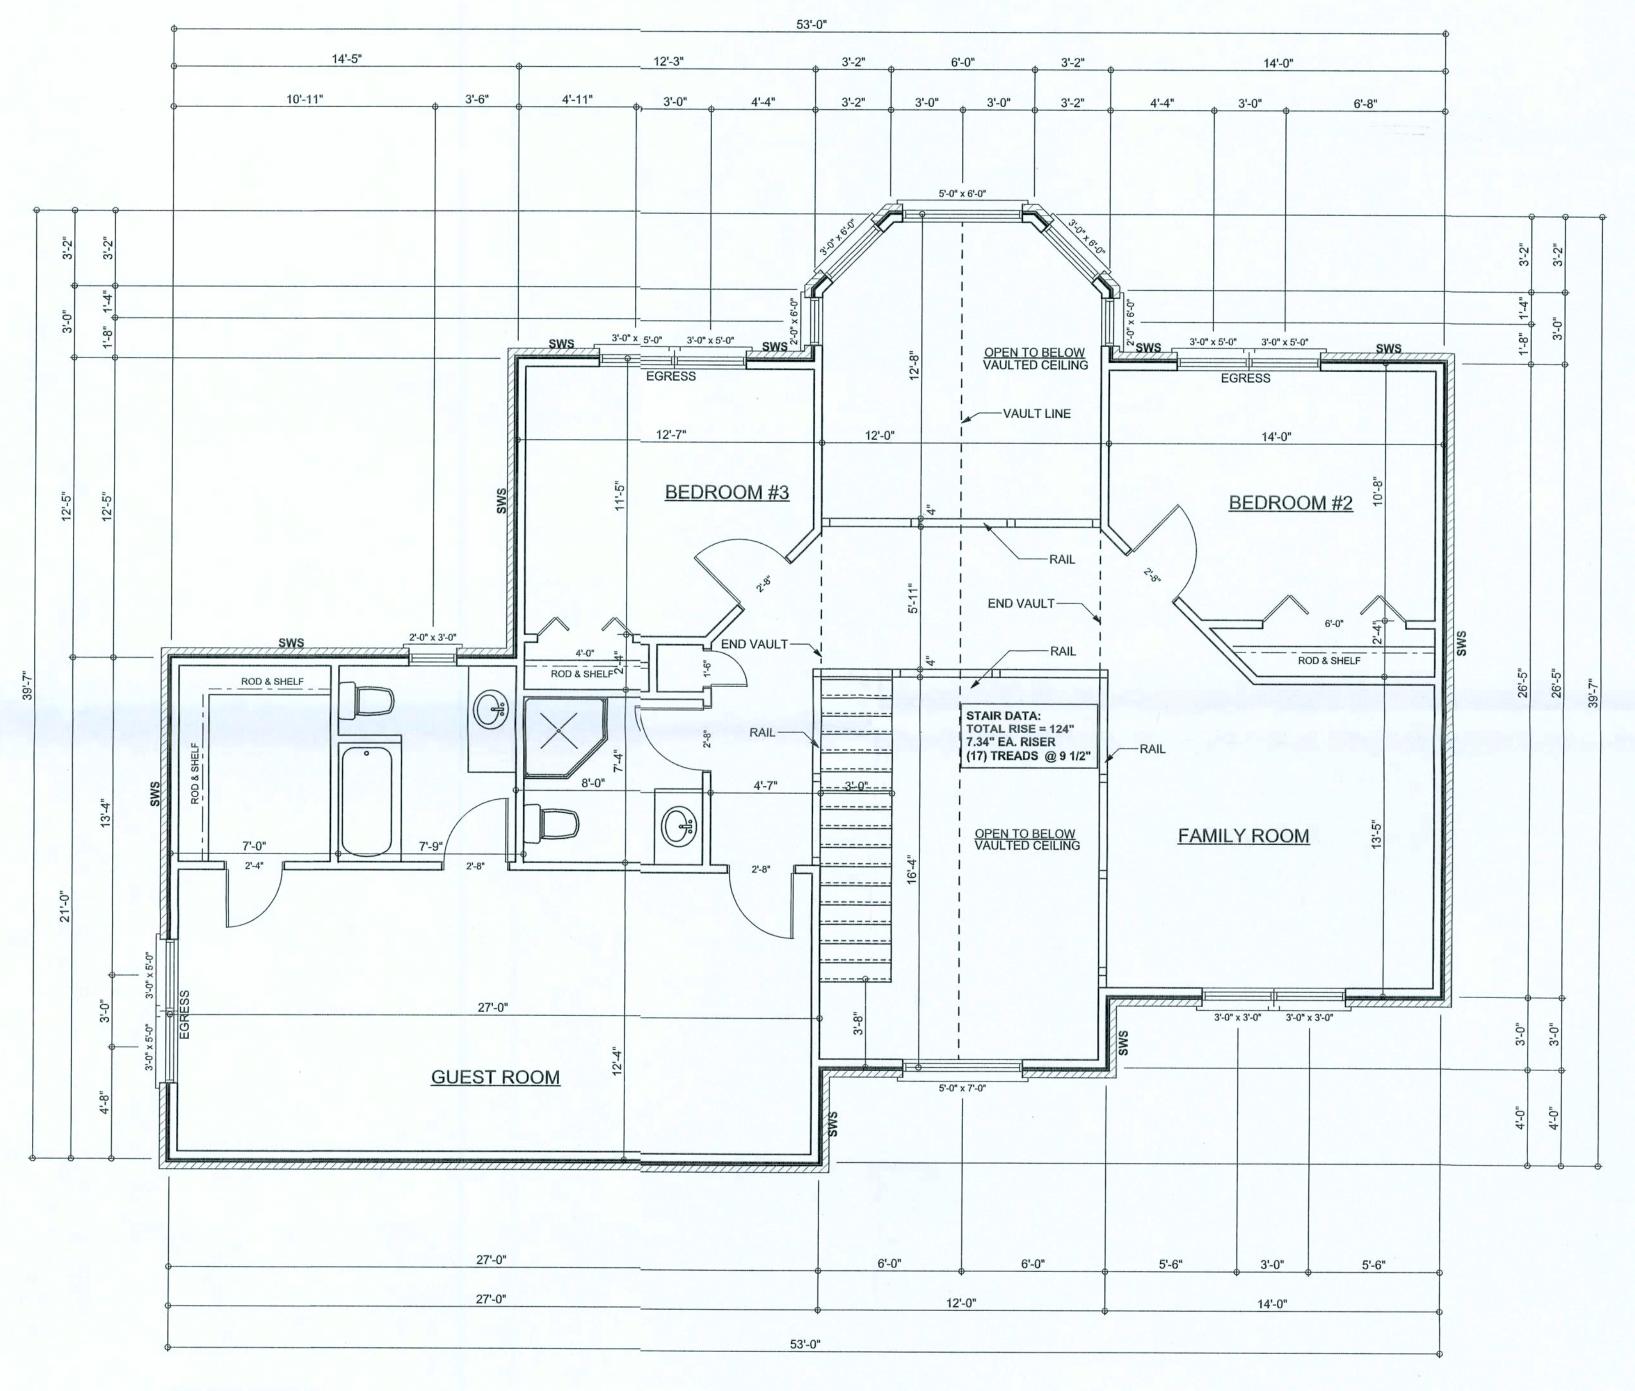

2ND FLOOR PLAN
SCALE: 1/4" = 1'-0"
ALL CEALINGS TO BE 9' UNLESS NOTED OTHERWISE
SWS=SHEAR WALL SEGMENT

WINDLOAD ENGINEER: Mark Disosway, PE No.53915, POB 868, Lake City, FL 32056, 386-754-5419

DIMENSIONS: Stated dimensions supercede scaled dimensions. Refer all questions to Mark Disosway, P.E. for resolution. Do not proceed without clarification.

COPYRIGHTS AND PROPERTY RIGHTS: Mark Disosway, P.E. hereby expressly reservances.

COPYRIGHTS AND PROPERTY RIGHTS:
Mark Disosway, P.E. hereby expressly reserves
its common law copyrights and property right in
these instruments of service. This document is
not to be reproduced, altered or copied in any
form or manner without first the express written
permission and consent of Mark Disosway.

CERTIFICATION: These plans and
"Windload Engineering", Sheet S-1, attached,

CERTIFICATION: These plans and
"Windload Engineering", Sheet S-1, attached,
comply with Florida Building Code 2004,
Section 1609 wind loads, to the best of my
knowledge.

LIMITATION: This design is valid for one
building at specified location. In case of conflict,
structural requirements, scope of work, and
builder responsibilities on sheet S-1 control.

MARK DISOSWAY
P.E. 53915

MARK DISOSWAY
P.E. 53915

ANGEL GOMEZ RESIDENCE

ADDRESS: LAKE CITY, FLORIDA

Mark Disosway P.E.
P.O. Box 868
Lake City, Florida 32025
Phone: (386) 754 - 5419
Fax: (386) 269 - 4871
windloadengineer@bellsouth.net

PRINTED DATE:
March 10, 2006

DRAWN BY: CHECKED BY:
Ben Sparks

DESIGNED BY:
Ben Sparks
FINALES DATE:

JOB NUMBER: 506101

DRAWING NUMBER

A-3

OF 6 SHEETS

