## PETERSEN RESIDENCE

(ADDITION TO EXISTING STRUCTURE)

## 350 SW MEADOW TERRACE LAKE CITY, FLOORIDA

ULTIMA	TE WIND SPEED (3 SEC.	GUST)	120 MPH	
NOMINA	AL WIND SPEED		93 MPH	
RISK C	ATEGORY		II	
WIND E	XPOSURE		В	
INTERN	AL PRESSURE COEFFICIE	ENT	+.18,18	
HEIGHT	AND EXPOSURE AD. OF 30', EXPOSURE E ROOF HEIGHTS)	(SEE R3Ø1.2(3) FOR (	OTHER EXPOSURES A	
	AREA OF OPENINGS (SQ. FT).	HGHT. & EXPOSURE. ADJUSTMENT. COEFF.	DESIGN (PSF)	
INTERIOR	Ø TO 10.00 10.01 TO 20.0 20.01 TO 50.00 50.01 TO 100.00 100.01 TO 500	1.Ø 1.Ø 1.Ø 1.Ø	5.5, -16.9  4.8, -16.1  3.9, -15.2  3.2, -14.5  1.6, -12.9	
END ZONE (WITHIN 4" OF CORNER)	Ø TO 10.00 10.01 TO 20.0 20.01 TO 50.00 50.01 TO 100.00 100.01 TO 500	1.0 1.0 1.0 1.0	5.5, -20.8  4.8, - 9.4  3.9, - 1.6  3.2, - 6.1  1.6, - 2.9	
I. TAB	RAL NOTES: LE VALUES SHALL BE AI PLYING BY THE ADJUST S AND MINUS SIGNS SIGN	MENT COEFFICIENT.		

85 89 93 101 108 116 124 132 139 147 155


<b>AREA TAB</b>	ULATIO	N	INDEX OF	DRAWINGS
Living:			SHEET NO.	DRAWING TITLE
*Existing	1250	sf		
Addition	210	sf	C1	COVER SHEET
Total Area:	1160	sf	A1	<b>EXISTING &amp; PROPOSED FLOOR PLAN</b>
*BRICK & AIR GAP NOT INCLUDED IN SQUARE FOOTAGE CALCULATIONS. IF INCLUDED, THEN EXISTING TOTAL = 1299 SF.		A2	ELEVATIONS & ELECTRICAL FIXTURE LAYOUT	
DETACHED GARAGE ALS CALCULATIONS.		) IN	S1 S2	FOUNDATION PLAN &TRUSS DETAIL ROOF PLAN & DETAILS






07/18/22

scale AS NOTED drawing no.

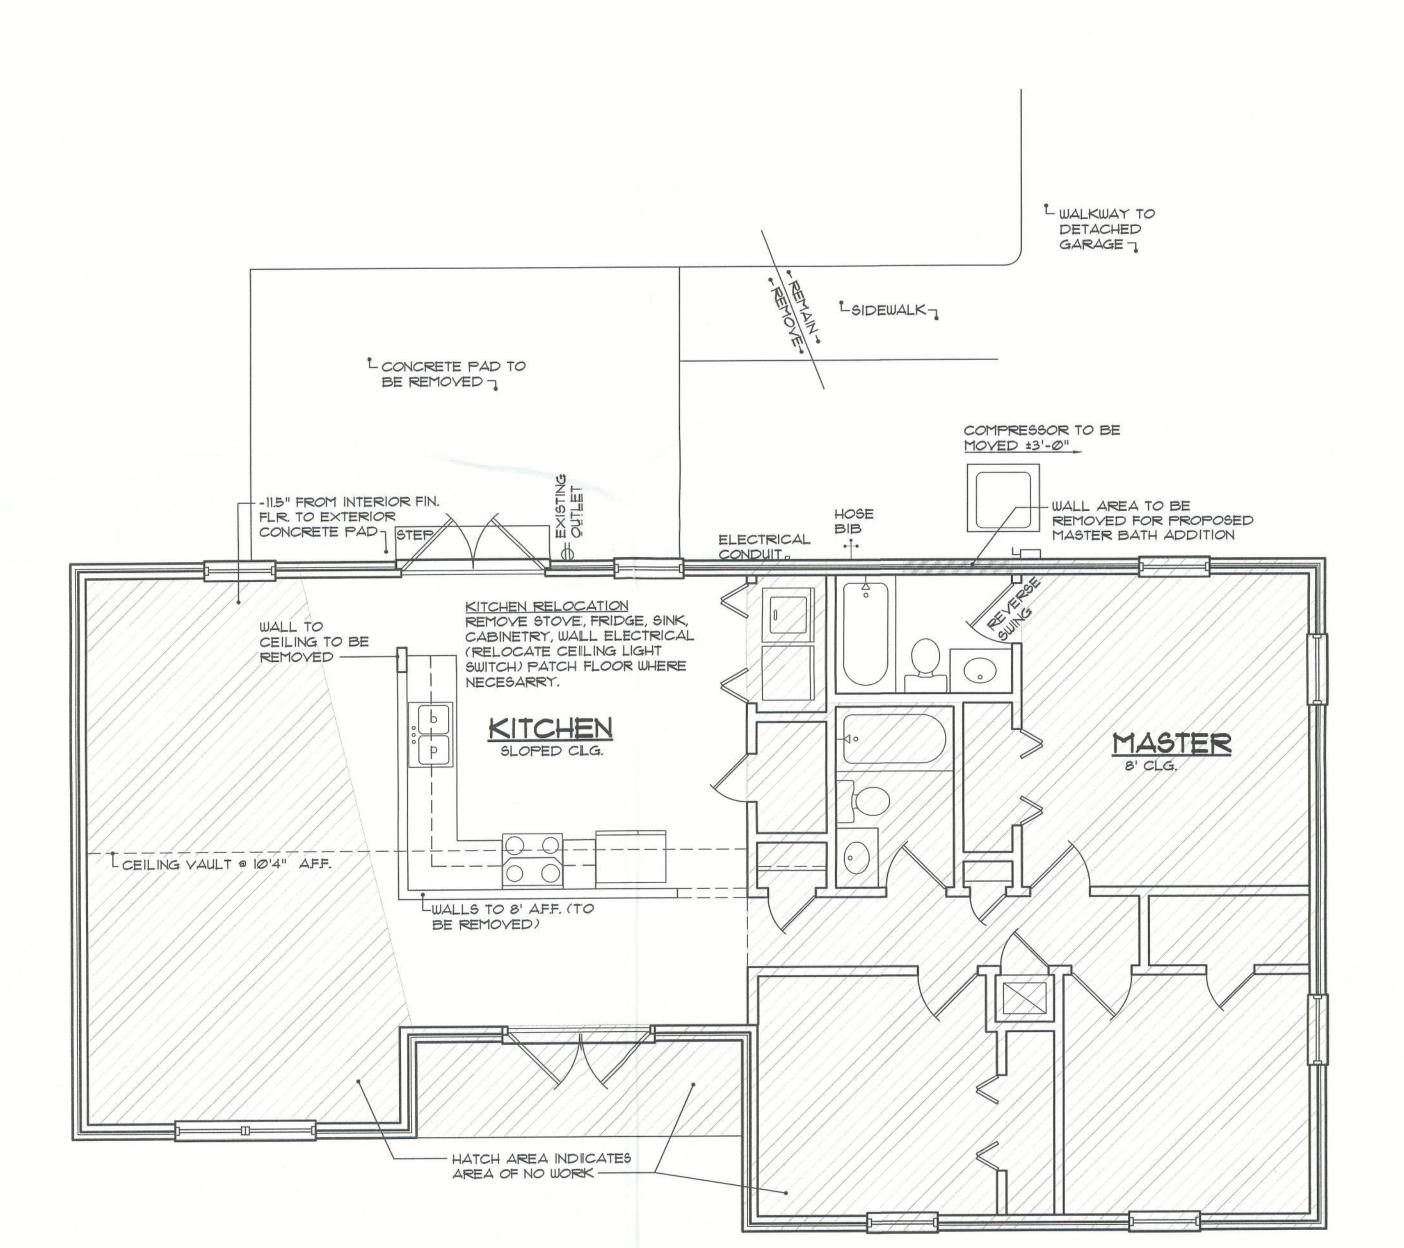

A Existing/Demolition Plan

SCALE: 1/4"=1'-0"

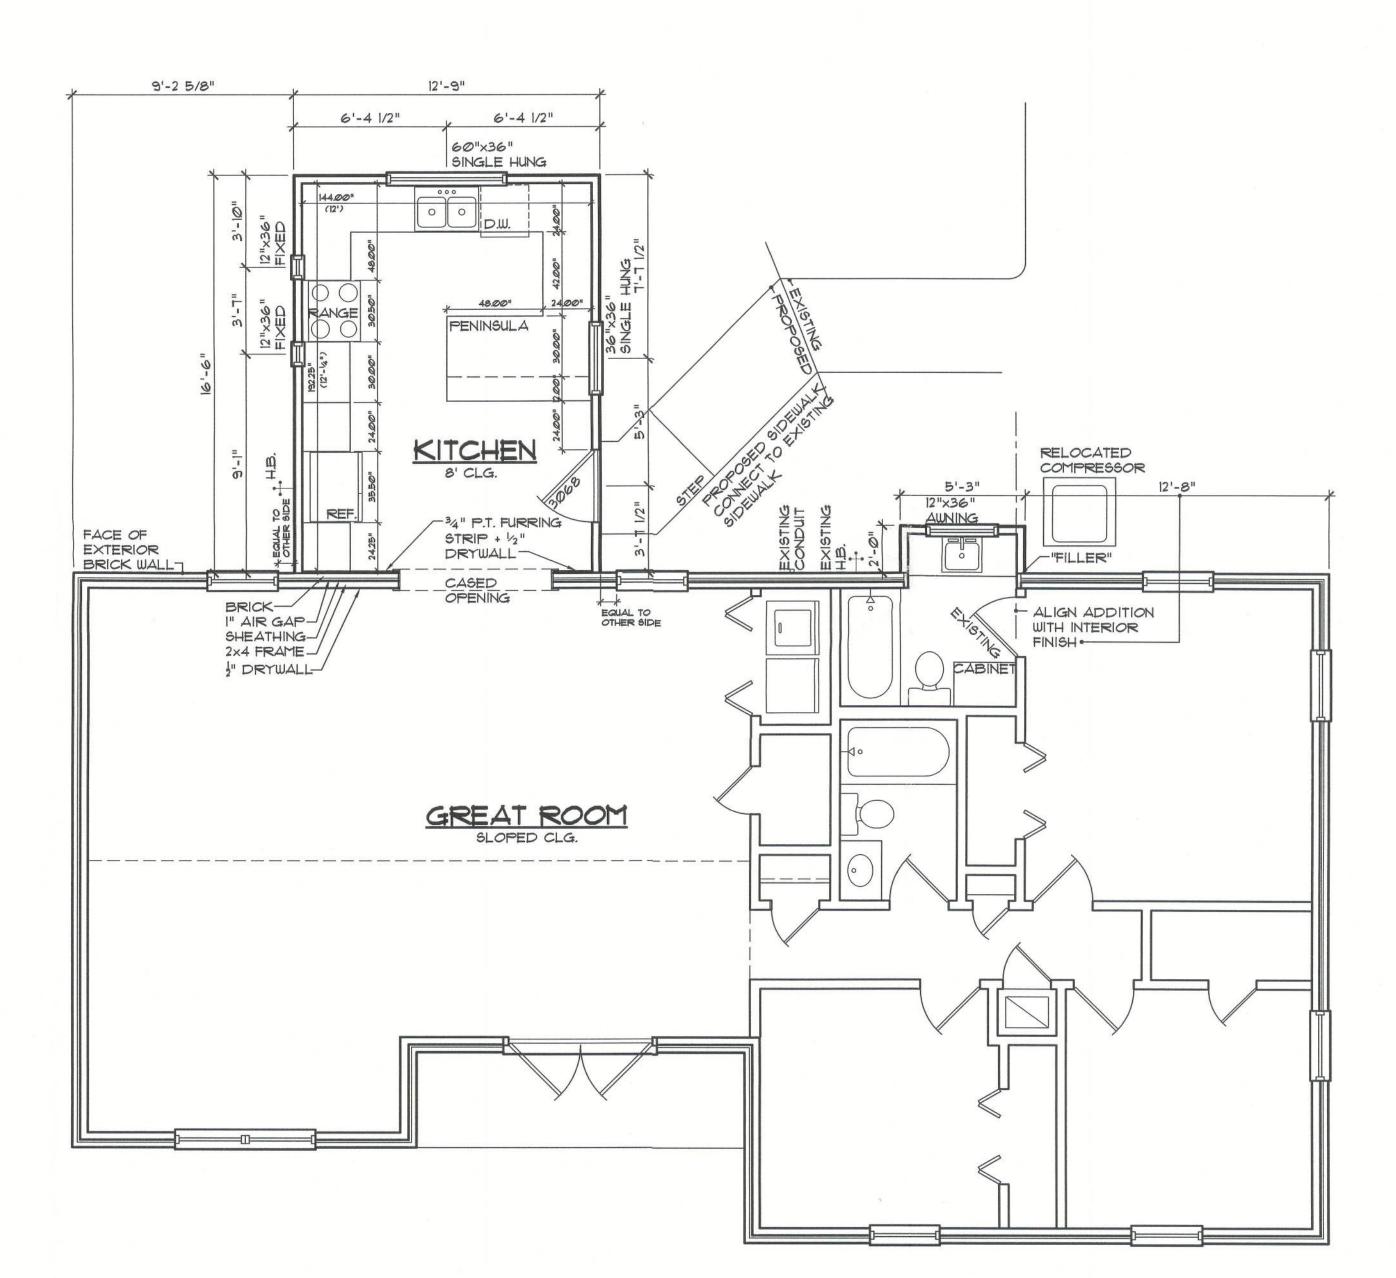

B Proposed Conditions
Al SCALE:1/4"=1'-0"

THE FINALPLAN.COM

revisions

PETERSEN 350 SW MEAN


CUSTOM DESIGNS, SPACE PLANNING TENANT BUILD OUTS, ADDITIONS, REMODELS


scale
AS NOTED
drawing no.


job no PETERSEN drawn by DA


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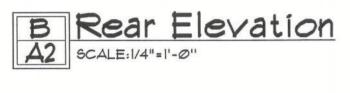
DA date 07/18/22




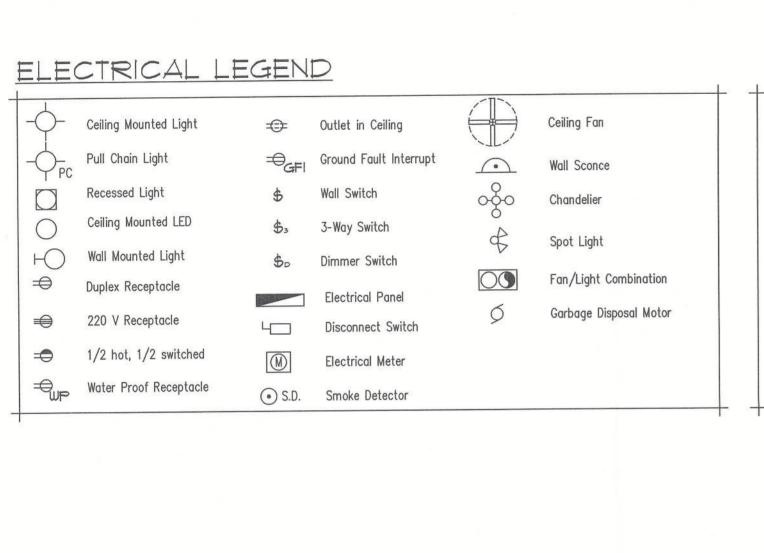

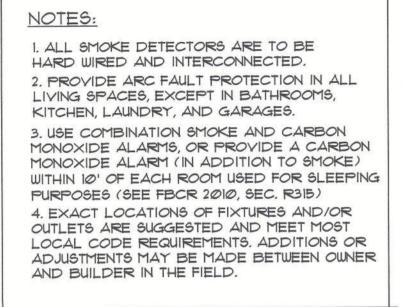


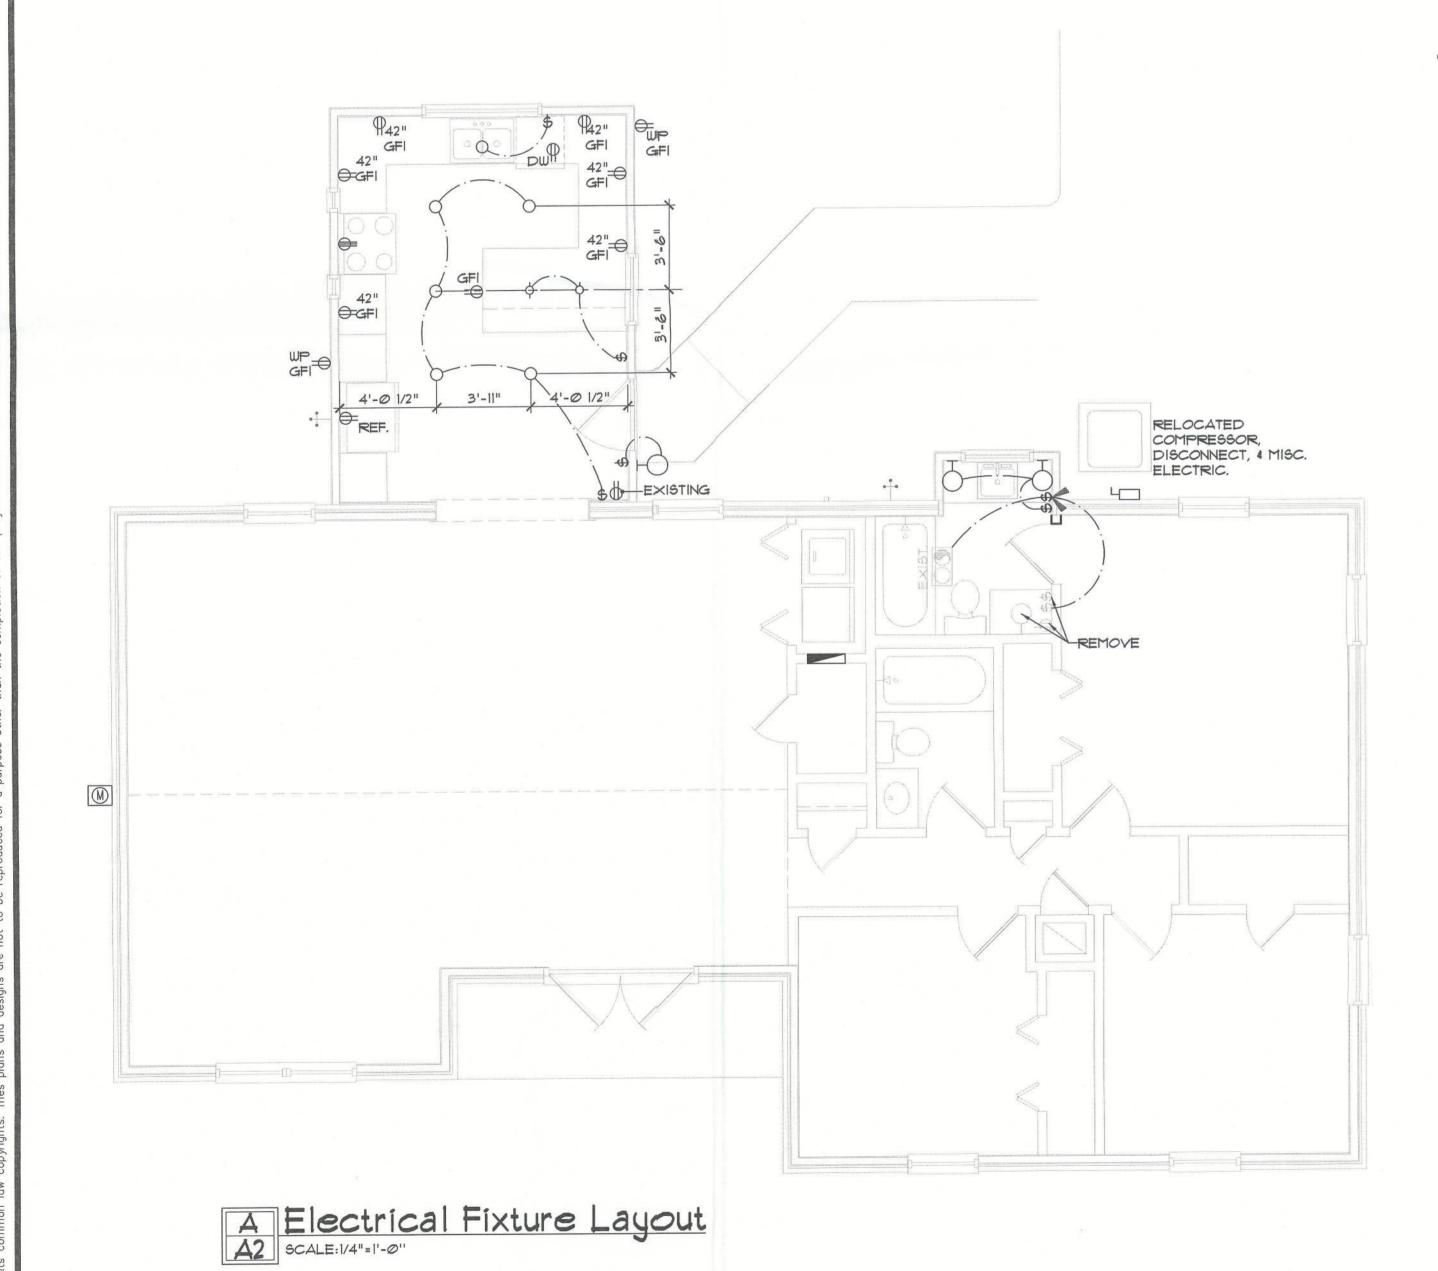

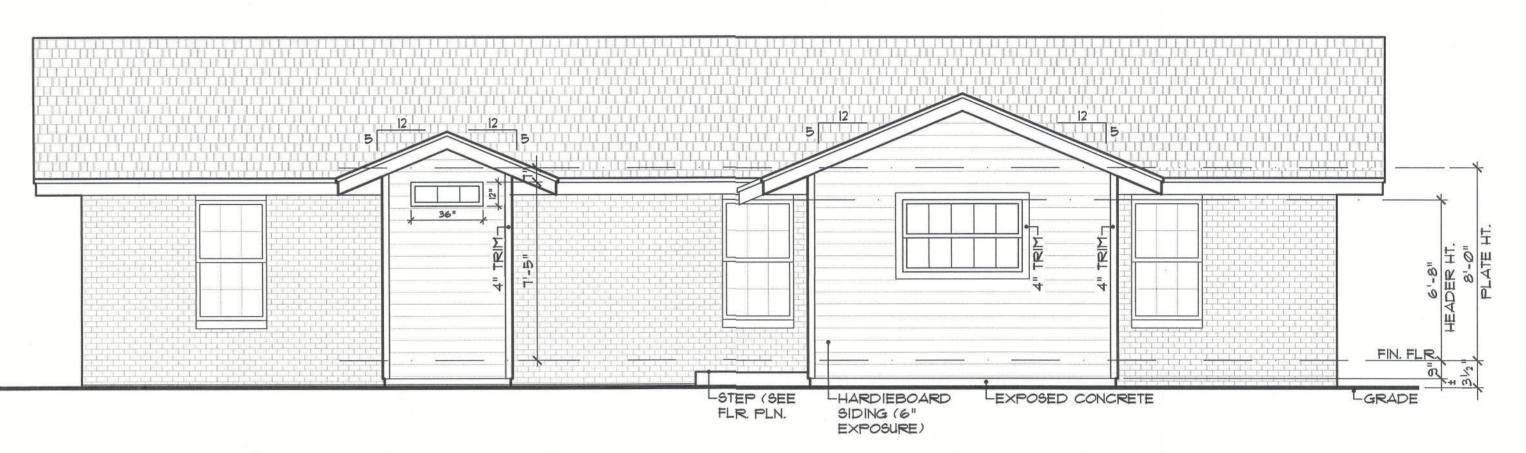

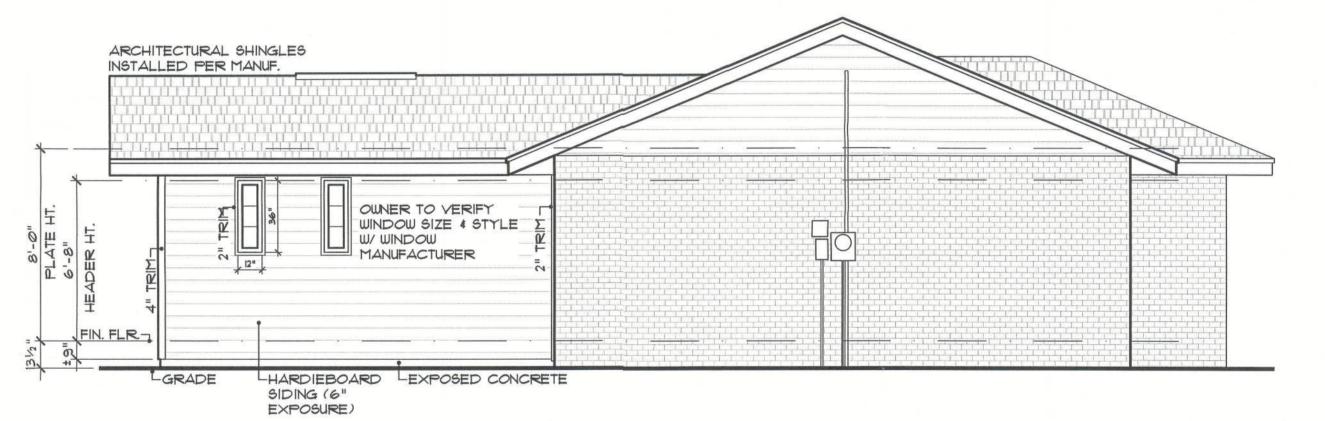

C Left Elevation
SCALE: 1/4"=1'-0"

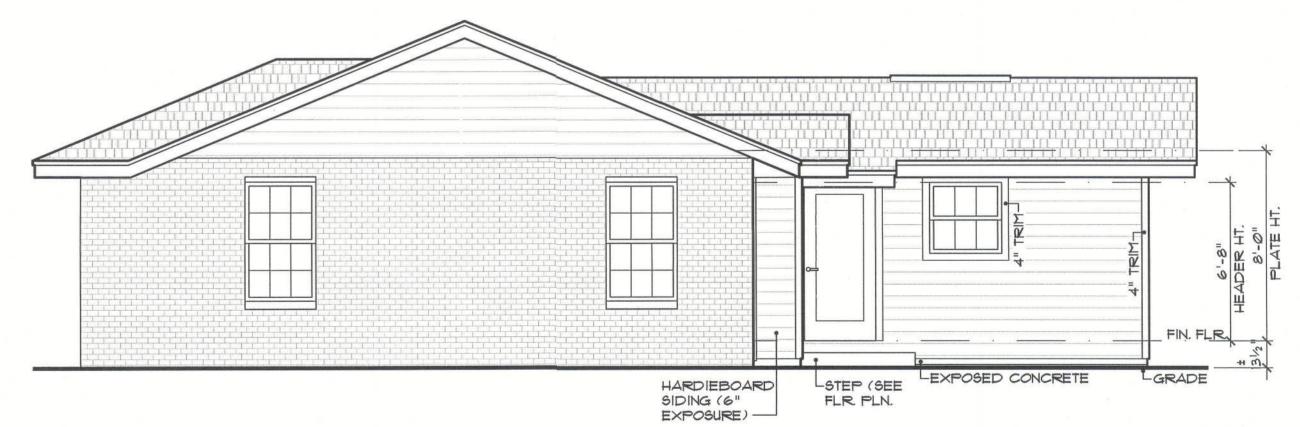

D Right Elevation


SCALE: 1/4"=1'-0"

ACE PLANNING ADDITIONS, RE s, L DESIGNS BUILD OI GUSTOM

revisions

PETERSEN 350 SW MEAD

job no PETERSEN drawn by DA checked DA date 07/18/22 scale AS NOTED drawing no.

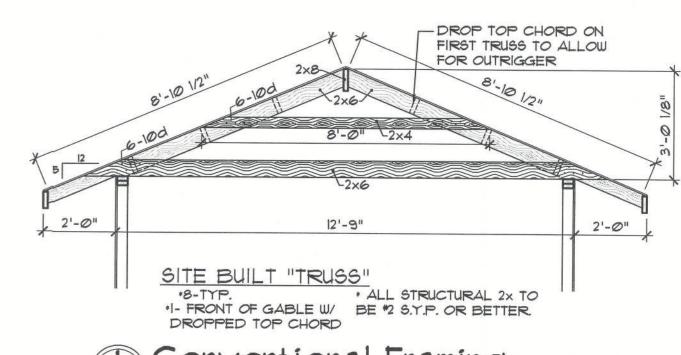


Conventional Framing

SI SCALE:3/8"=1'-0" (MAY BE SUBSTITUDED FOR PRE-MANUFACTURED TRUSS)


FLOOR SLAB OF PLANT MIX CONCRETE 2500 P.S.I. 4" THICK WITH FIBER-MESH REINFORCEMENT OVER TERMITE TREATED SOIL WITH 6 MIL. POLYETHYLENE VAPOR BARRIER OVER COMPACTED CLEAN FILL. OR

FLOOR SLAB OF PLANT MIX CONCRETE
2500 P.S.I. 4" THICK WITH 6x6 10/10
GAUGE REINFORCING MAT. WITH MIN I"
COVER. TERMITE TREATED SOIL WITH
6 MIL. POLYETHYLENE VAPOR BARRIER
OVER COMPACTED CLEAN FILL

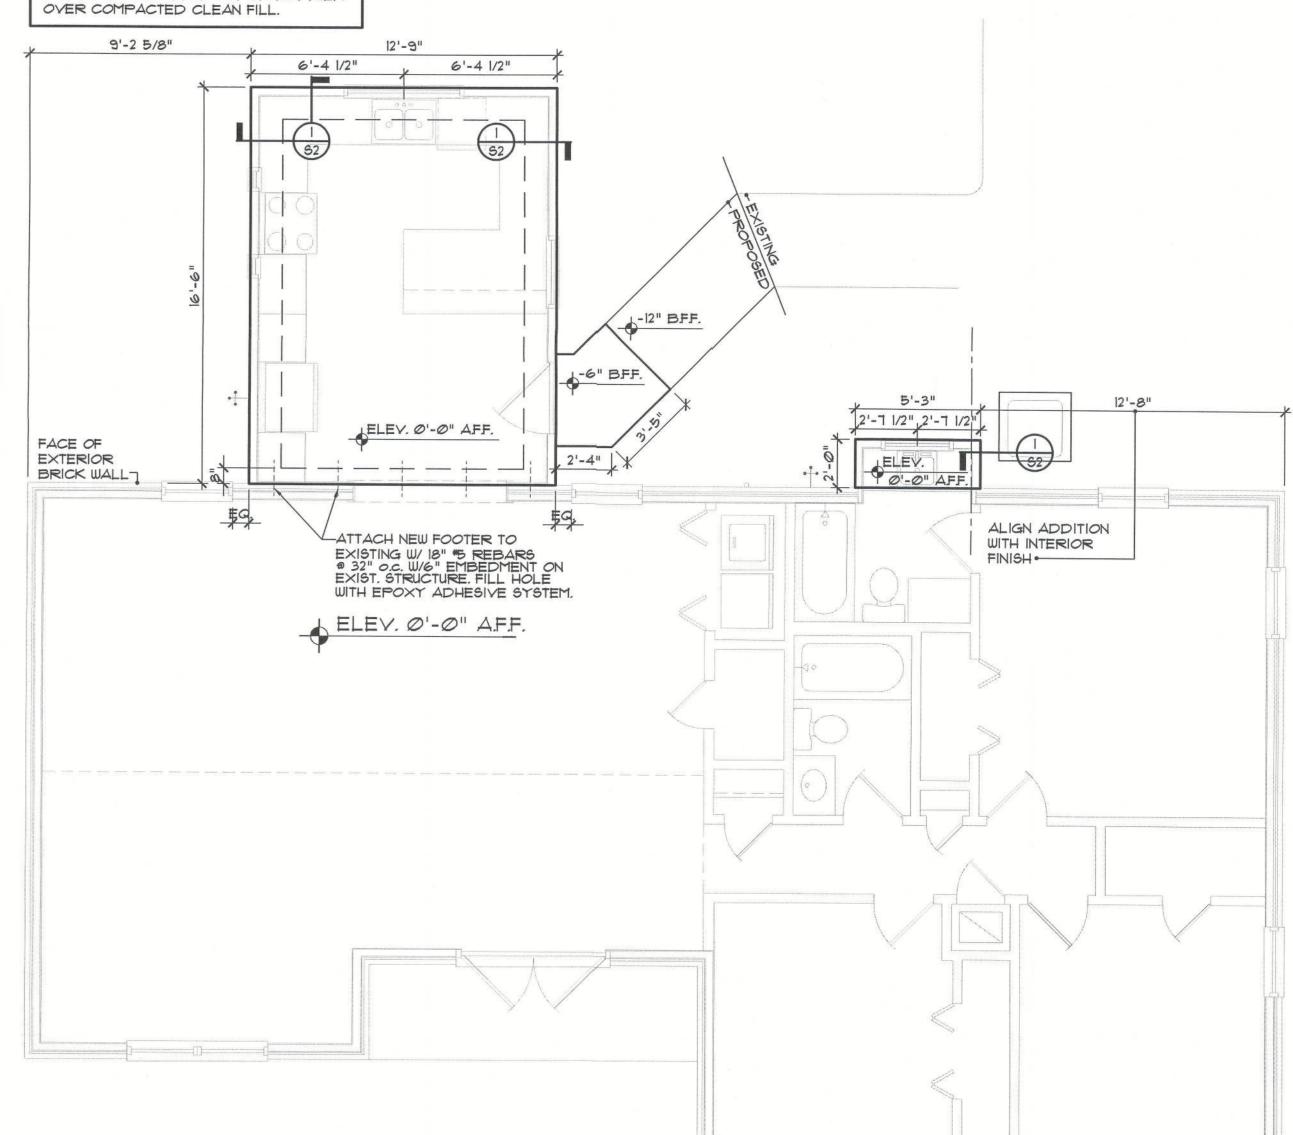

A Foundation Plan SI SCALE:1/4"=1'-0"



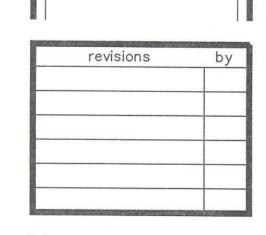


PETERSEN ADDITION
350 SW MEADOW TERRACE
LAKE CITY, FLORIDA


GILL ENGINEERING SERVICES, INC AUTH # 30824 GARY GILL PE #51942 163 SW MIDTOWN PL LAKE CITY, FL 32025 386-590-1242

job no
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drawn by
DA
checked
DA
date
07/18/22


date 07/18/22 scale AS NOTED drawing no.

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VΕ	NT SCHEDULE	FBC RES 1TH EDITION (2020) 8062 NFVA - NET FREE VENTILATED AREA		
	ROOF VENTING REQUIRED FOR		FT. NFVA REQUIRED	
INTAKE	26 LF. 24" VENTED SOFFIT @ EAVE x Ø8 (GEORGIA PACIFIC VINYL VENT)	5Q. FT. PER L.F. =2.08 SQ.	FT. NFVA	
EXHAUST	8 LINEAL FEET OF RIDGE VENT # .118 / (PROFILEVENT)	SF. =.94 SQ.	FT. NFVA	
	TOTAL NEVA PROVIDED	=3.02 SQ.	FT. NEVA	

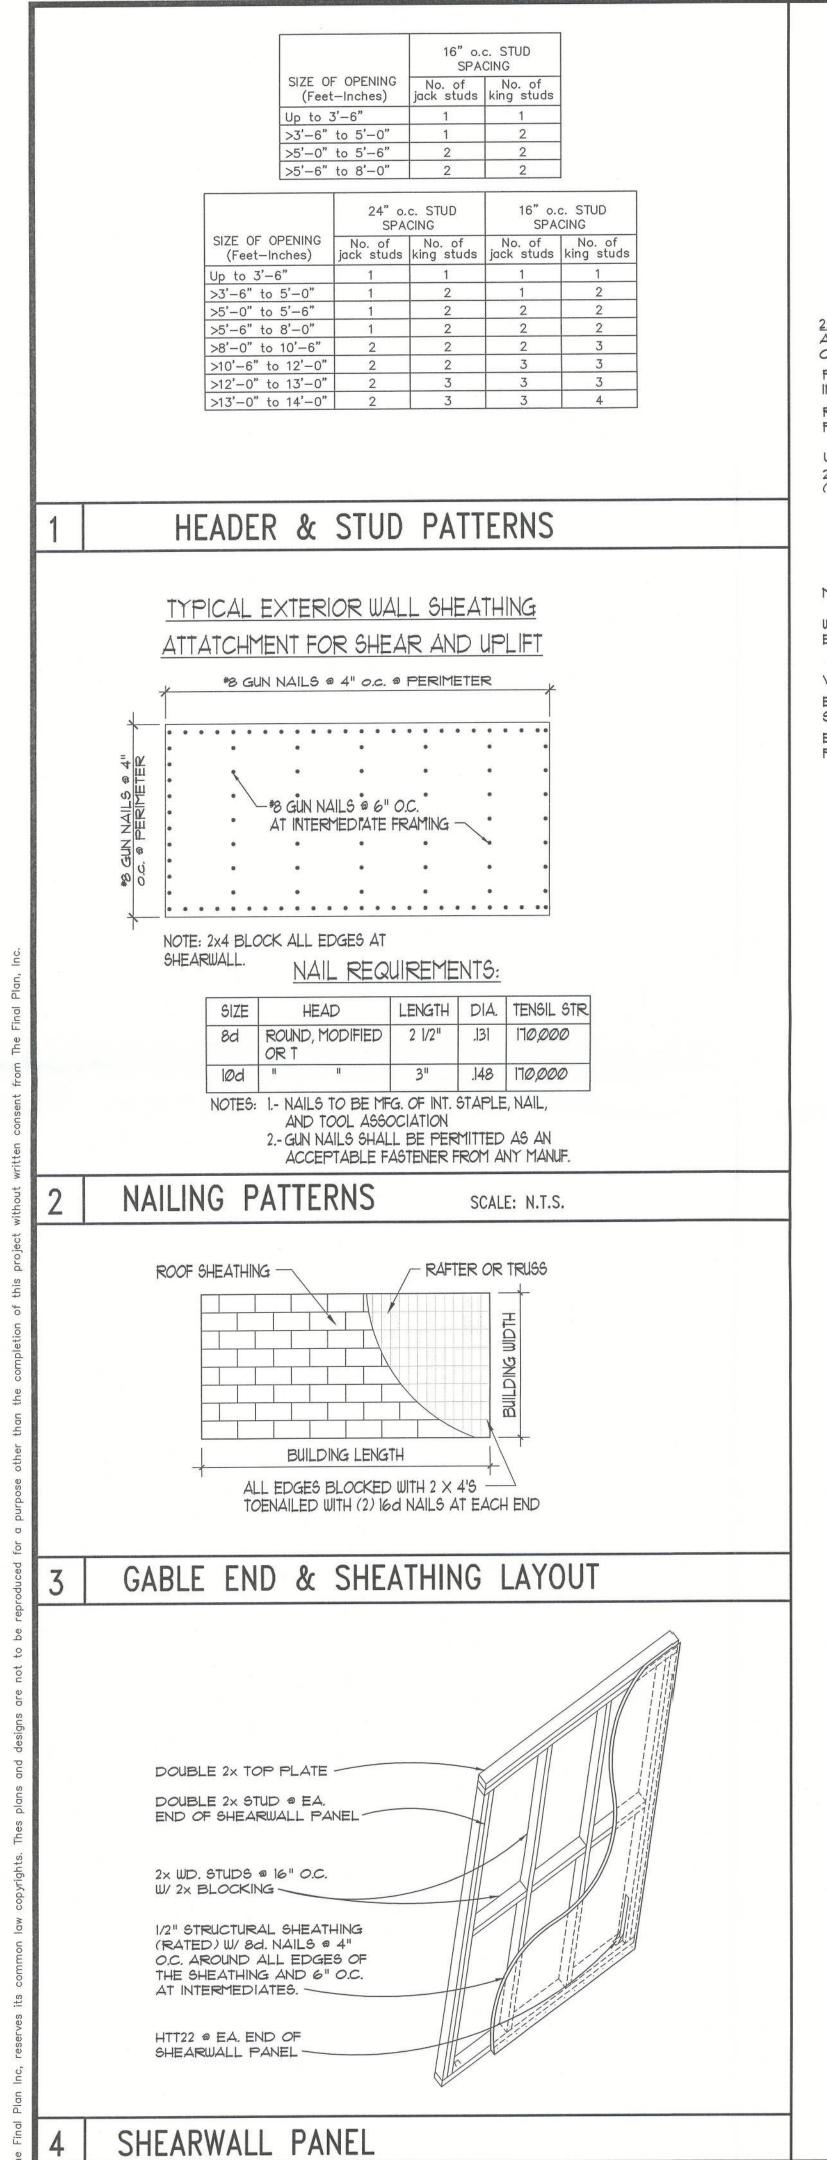

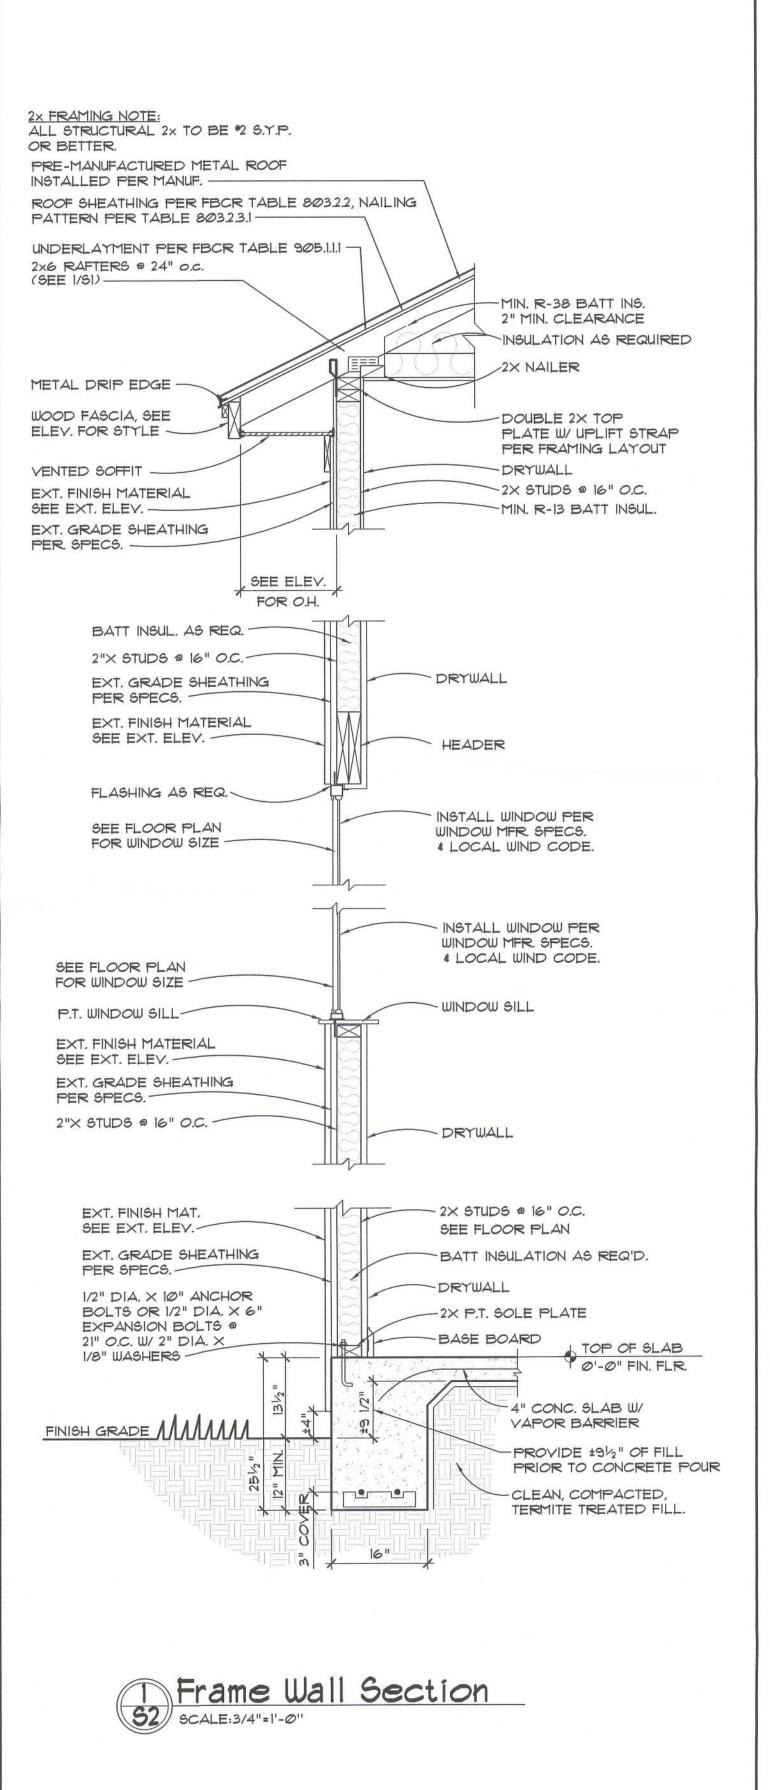

RSEN ADDITION
350 SW MEADOW TERRACE
LAKE CITY, FLORIDA
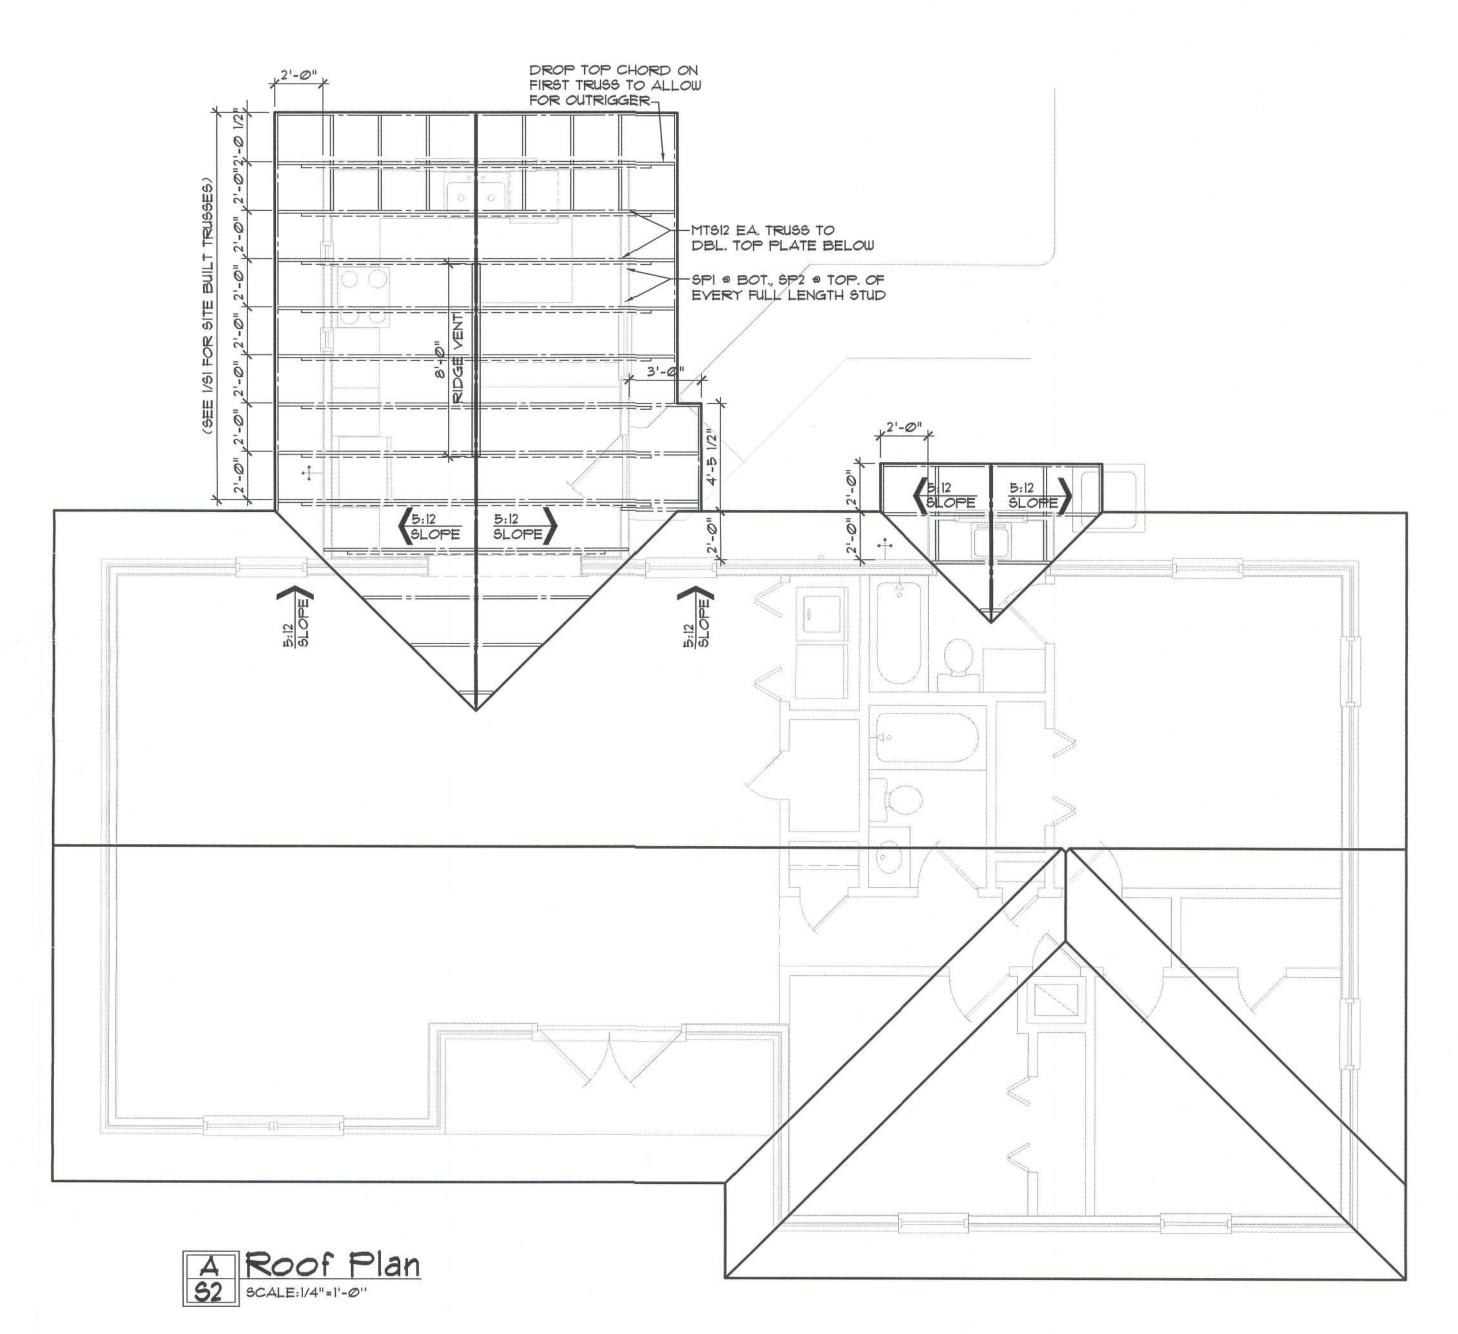
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