



**FRONT ELEVATION**  
SCALE: 1/4" = 1'



**REAR ELEVATION**  
SCALE: 1/4" = 1'

ALL DRAWINGS NOT TO BE SCALED, WRITTEN DIMENSIONS TAKE PRECEDENCE OVER SCALED DIMENSIONS

June 28, 2001

**D.D.S. Studios**  
ARCHITECTURAL DESIGN  
P.O. Box 273  
LAKE CITY FL 32056  
(386) 754-0181  
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ENGINEERED BY:

CUSTOM HOME DESIGNED FOR:  
**JEREMY & SUSIE CADY**  
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DESIGNED FOR:


*Daniel Shahren*  
**Daniel Shahren**

**EXTERIOR ELEVATIONS**

SHEET NUMBER  
1 of 5

All work shall comply with the standard building code and all applicable local codes and ordinances.  
Contractor shall verify all dimensions prior to commencing construction.

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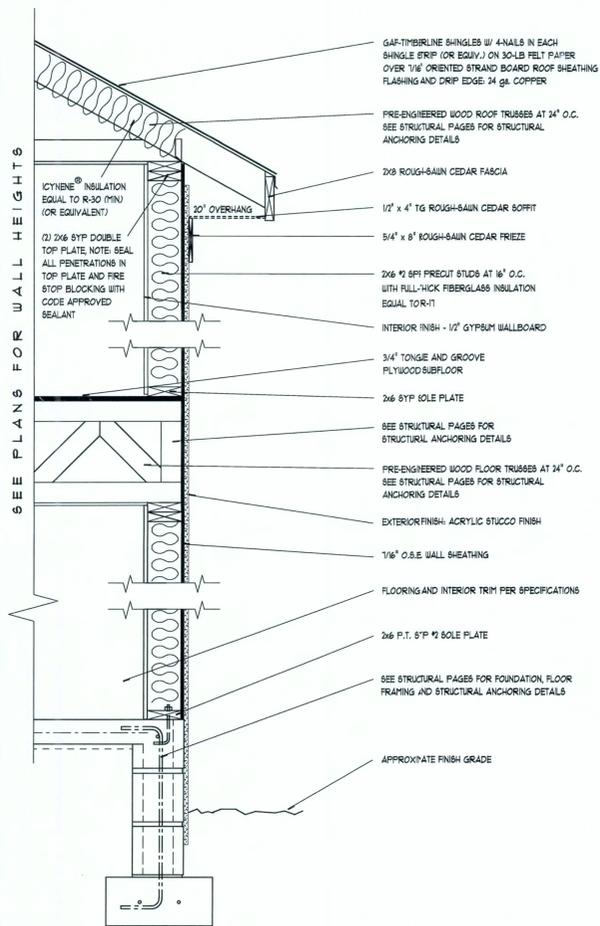
**ROOF PLAN NOTES**

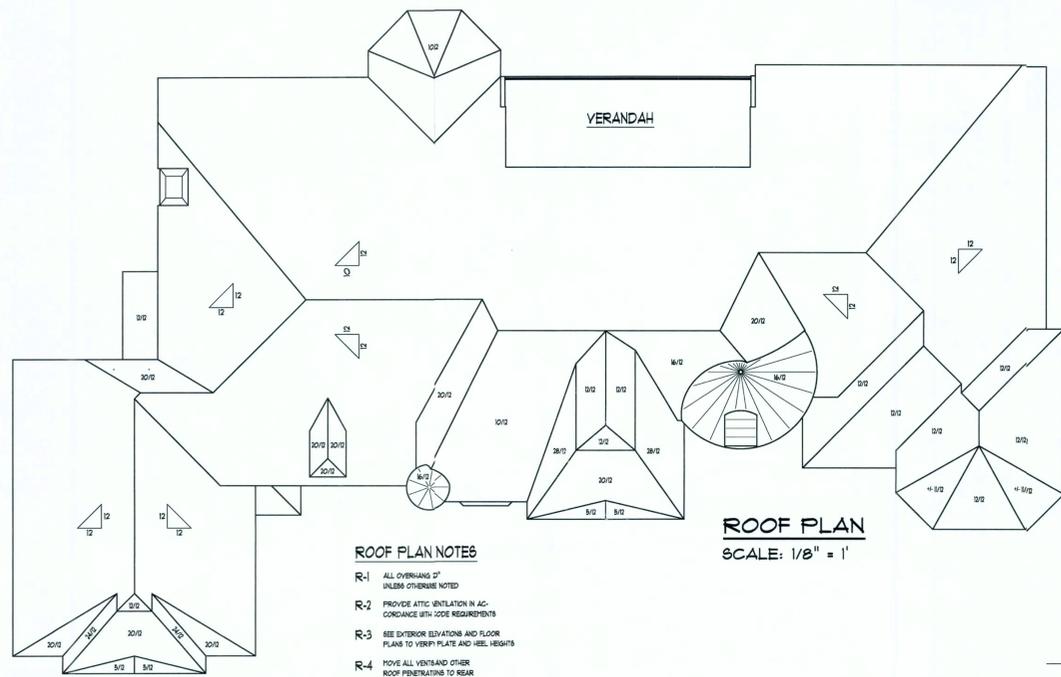- R-1 ALL OVERHANG 2" UNLESS OTHERWISE NOTED
- R-2 PROVIDE ATTIC VENTILATION IN ACCORDANCE WITH CODE REQUIREMENTS
- R-3 SEE EXTERIOR ELEVATIONS AND FLOOR PLANS TO VERIFY PLATE AND RISE HEIGHTS
- R-4 PROVIDE ALL VENTILATION OTHER THAN FURNISHINGS TO SEAR

**ROOF PLAN**  
SCALE: 1/8" = 1'




**LEFT ELEVATION**  
SCALE: 1/4" = 1'




**TWO-STORY TYPICAL WALL SECTION**


SCALE: 1" = 1'  
REFER TO STRUCTURAL PAGE FOR STRUCTURAL SPECIFICATIONS

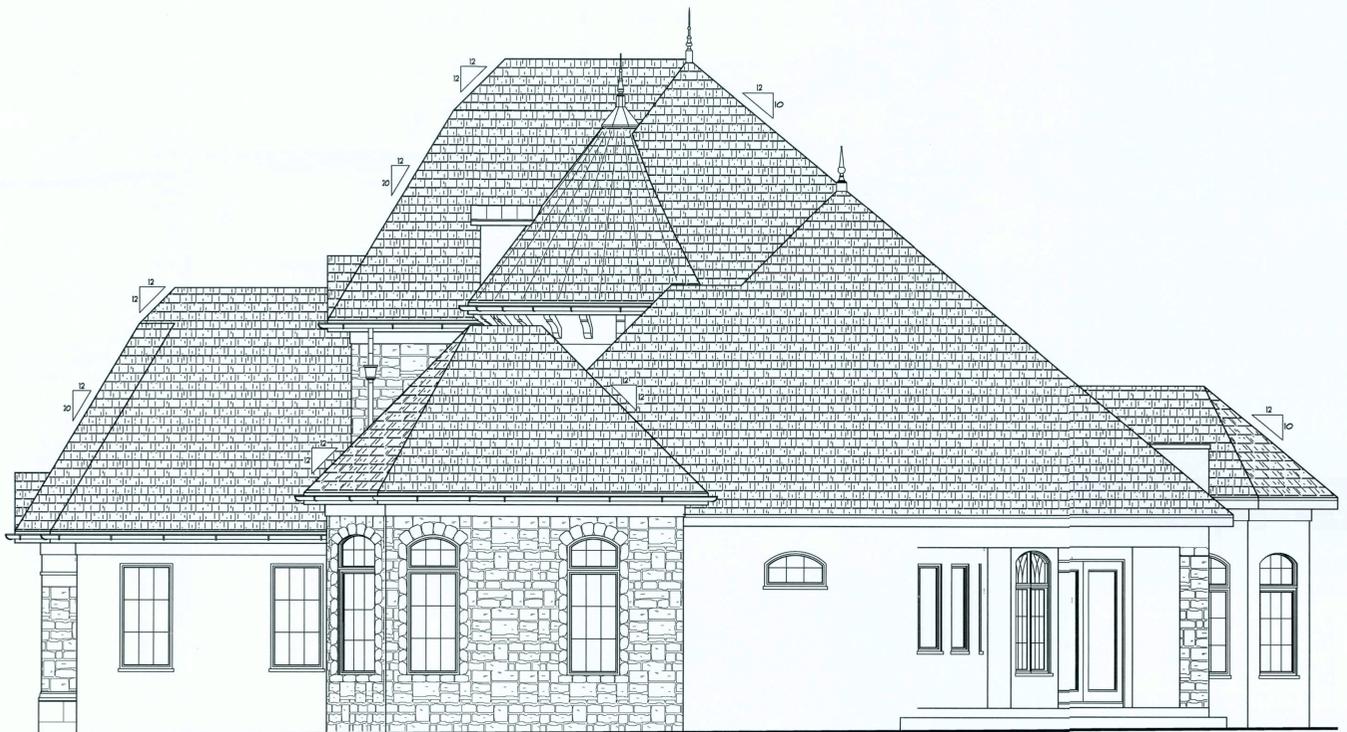

**RIGHT ELEVATION**  
SCALE: 1/4" = 1'

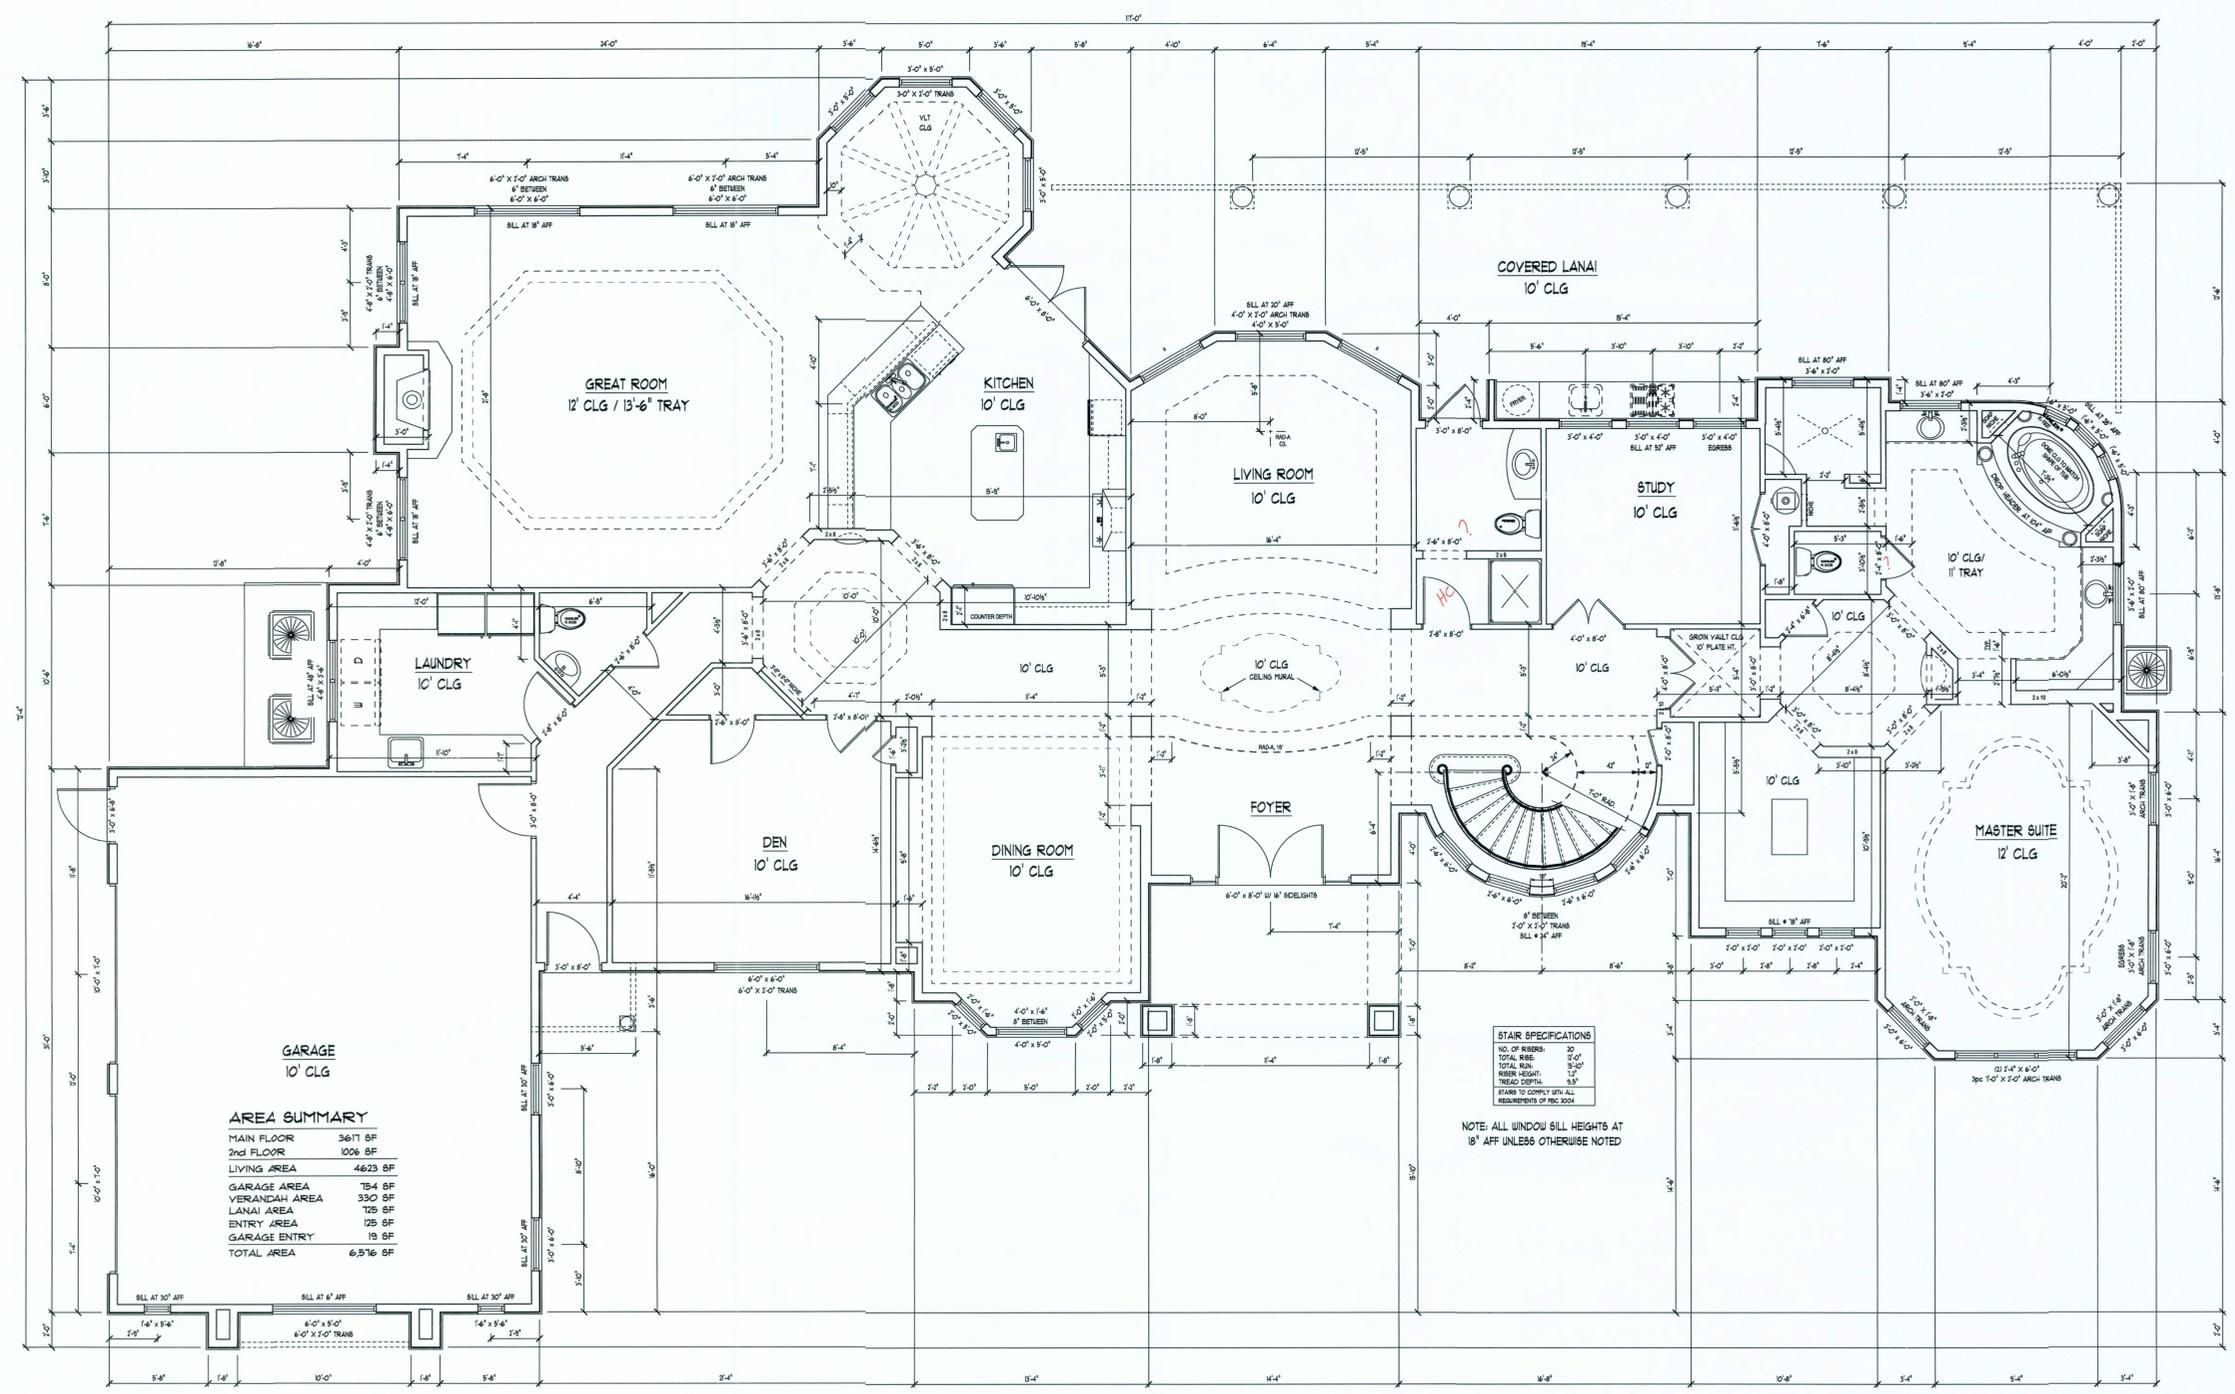


**FLOOR PLAN**  
SCALE: 1/4" = 1'

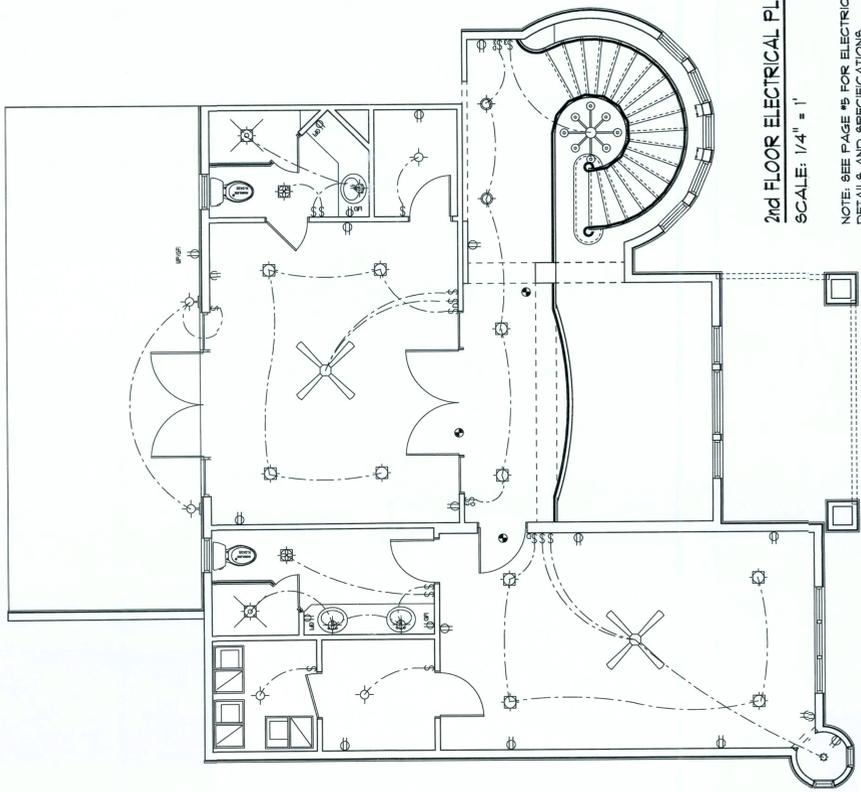


2nd FLOOR ELECTRICAL PLAN  
SCALE: 1/4" = 1'

NOTE: SEE PAGE #5 FOR ELECTRICAL  
DETAILS AND SPECIFICATIONS

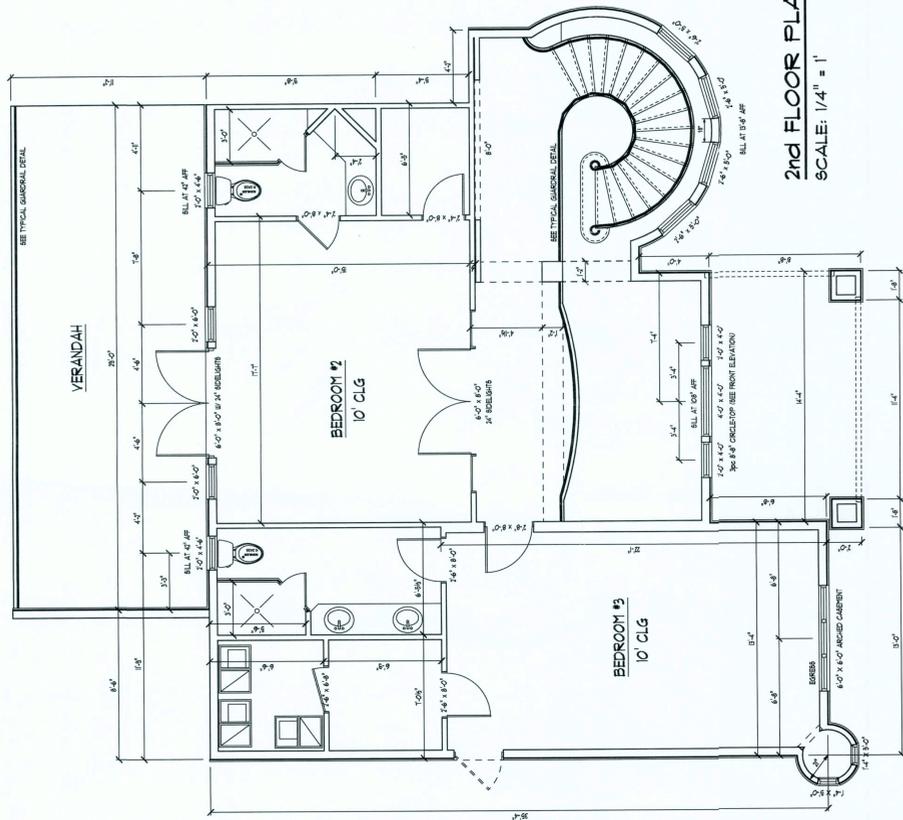

2nd FLOOR PLAN  
SCALE: 1/4" = 1'

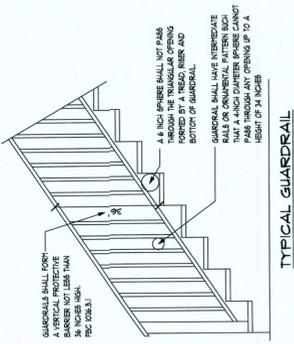

TYPICAL GUARDRAIL  
SCALE: 1/2" = 1'

Daniel Shaheen  
Daniel Shaheen

June 28, 2007  
**D.D.S. Studios**  
ARCHITECTURAL DESIGN  
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DESIGNED FOR:

2nd FLOOR PLAN  
2nd FLOOR ELECTRICAL PLAN

SHEET NUMBER  
4 of 4

All work shall comply with the standard building code, and all applicable local codes and ordinances.  
Contractor shall verify all dimensions prior to commencing construction.



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DESIGNED FOR:

*Daniel Shabben*  
Daniel Shabben

ELECTRICAL PLAN  
SITE PLAN

SHEET NUMBER  
5 of 5


All work shall comply with the standard building code and all applicable local codes and ordinances.  
Contractor shall verify all dimensions prior to commencing construction.

**ELECTRICAL PLAN NOTES**

- E-1 ALL WORK SHALL COMPLY WITH THE NATIONAL ELECTRICAL CODE, LATEST EDITION, AND ALL OTHER APPLICABLE LOCAL CODES AND ORDINANCES.
- E-2 NOTE: ALL SMOKE DETECTORS TO BE WIRED TOGETHER TO ACTIVATE ALL ALARMS IF ANY ONE UNIT IS ACTIVATED.
- E-3 PROVIDE WIRING AS REQUIRED FOR APPLIANCES, AIR CONDITIONING, HEATING AND WATER HEATING EQUIPMENT.
- E-4 ALL BEDROOM RECEPTACLES SHALL BE AFCI (ARC FAULT CIRCUIT INTERRUPT).

**ELECTRICAL LEGEND**

- 2'X4' 4-LAMP FLUORESCENT LIGHT WITH STD. BALLAST
- EXHAUST FAN
- INCANDESCENT LIGHT FIXTURE
- EXHAUST FAN/LIGHT COMBO
- CAN LIGHT
- EYEBALL CAN LIGHT
- WALL SCONCE
- DOUBLE SPOTLIGHT
- TELEPHONE OUTLET
- TELEVISION OUTLET
- LOW WATTAGE LIGHTING
- SMOKE DETECTOR
- SWITCH
- 3-WAY SWITCH
- DIMMER SWITCH
- RECEPTACLE
- RECEPTACLE W/ GROUND FAULT INTERRUPT
- SPLIT RECEPTACLE (1 SWITCHED, 1 CONSTANT)
- 220 VOLT RECEPTACLE

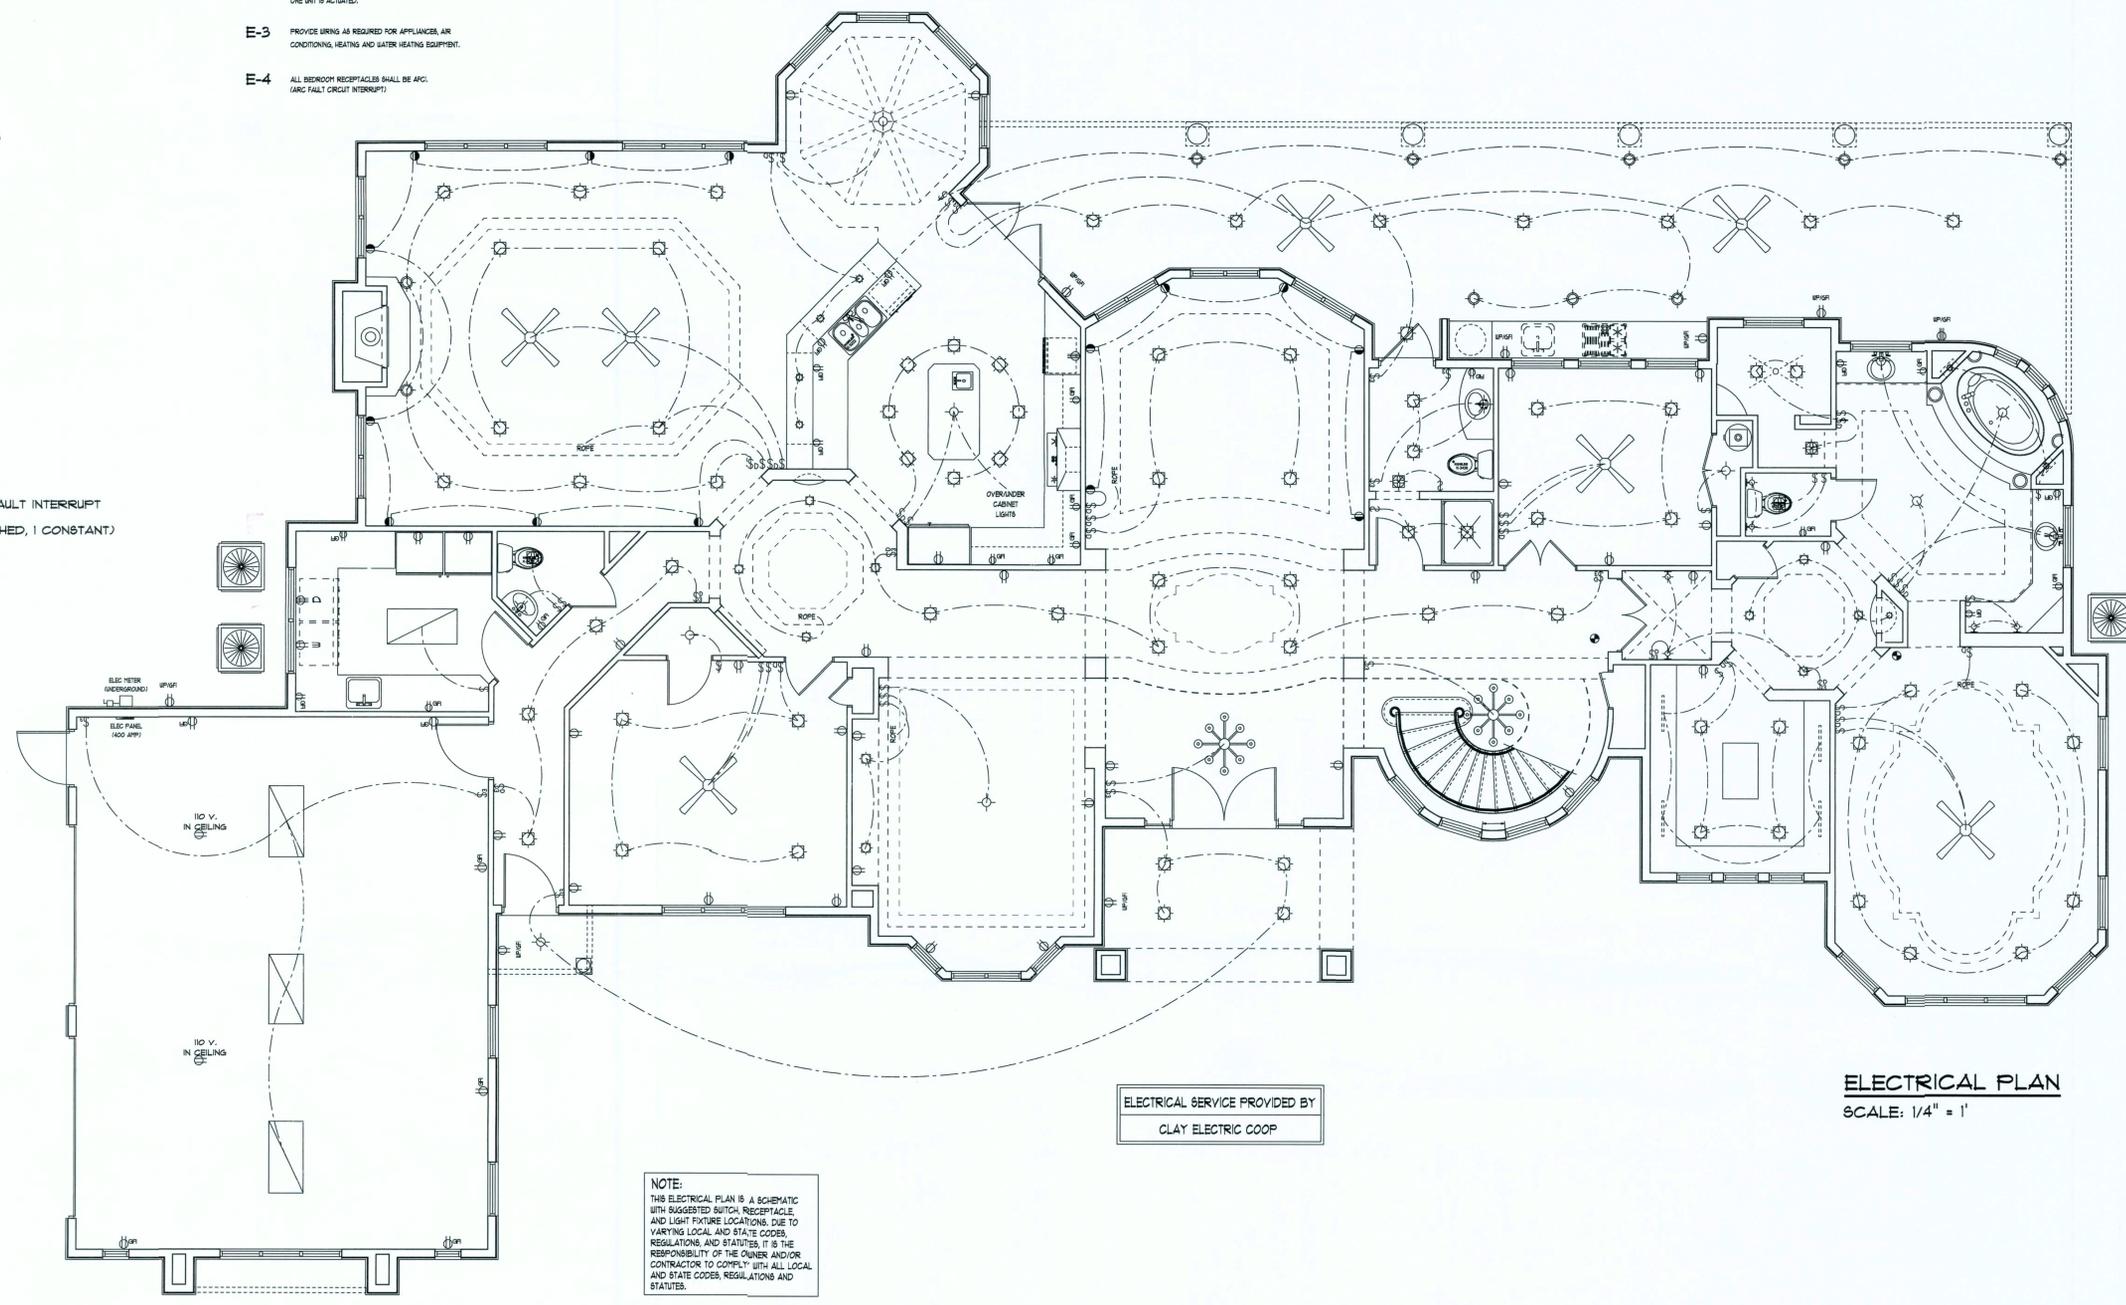

**NOTE:**  
THIS ELECTRICAL PLAN IS A SCHEMATIC WITH SUGGESTED SWITCH, RECEPTACLE AND LIGHT FIXTURE LOCATIONS. DUE TO VARYING LOCAL AND STATE CODES, REGULATIONS AND STATUTES, IT IS THE RESPONSIBILITY OF THE OWNER AND/OR CONTRACTOR TO COMPLY WITH ALL LOCAL AND STATE CODES, REGULATIONS AND STATUTES.


**ELECTRICAL PLAN**  
SCALE: 1/4" = 1'

MTC 05/04




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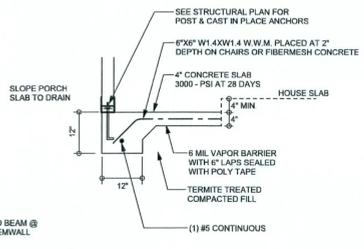
**SOFTPLAN**  
ARCHITECTURAL DESIGN SOFTWARE

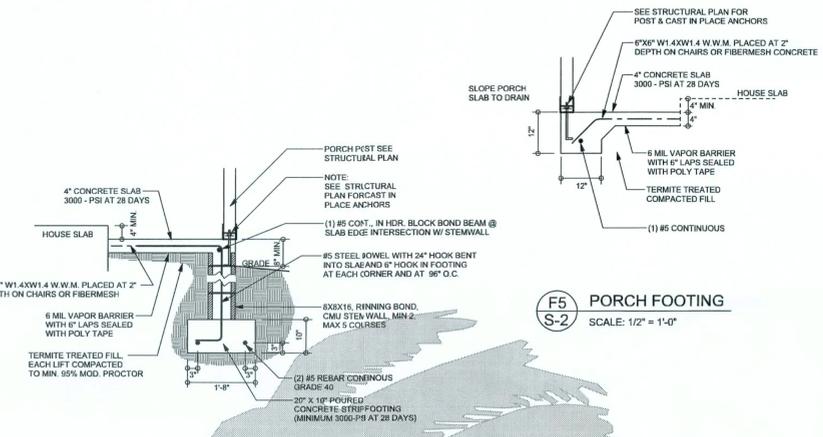

**F5A ALT. STEM WALL PORCH FOOTING**  
SCALE: 1/2" = 1'-0"

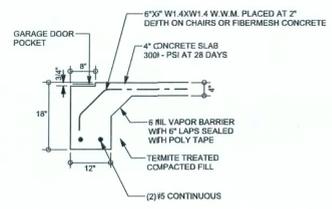


**F4 GARAGE DOOR FOOTING**  
SCALE: 1/2" = 1'-0"




**F5 PORCH FOOTING**  
SCALE: 1/2" = 1'-0"


**FOUNDATION PLAN**  
SCALE: 3/16" = 1'-0"  
DIMENSIONS ON STRUCTURAL SHEETS ARE NOT EXACT. REFER TO ARCHITECTURAL FLOOR PLAN FOR ACTUAL DIMENSIONS.

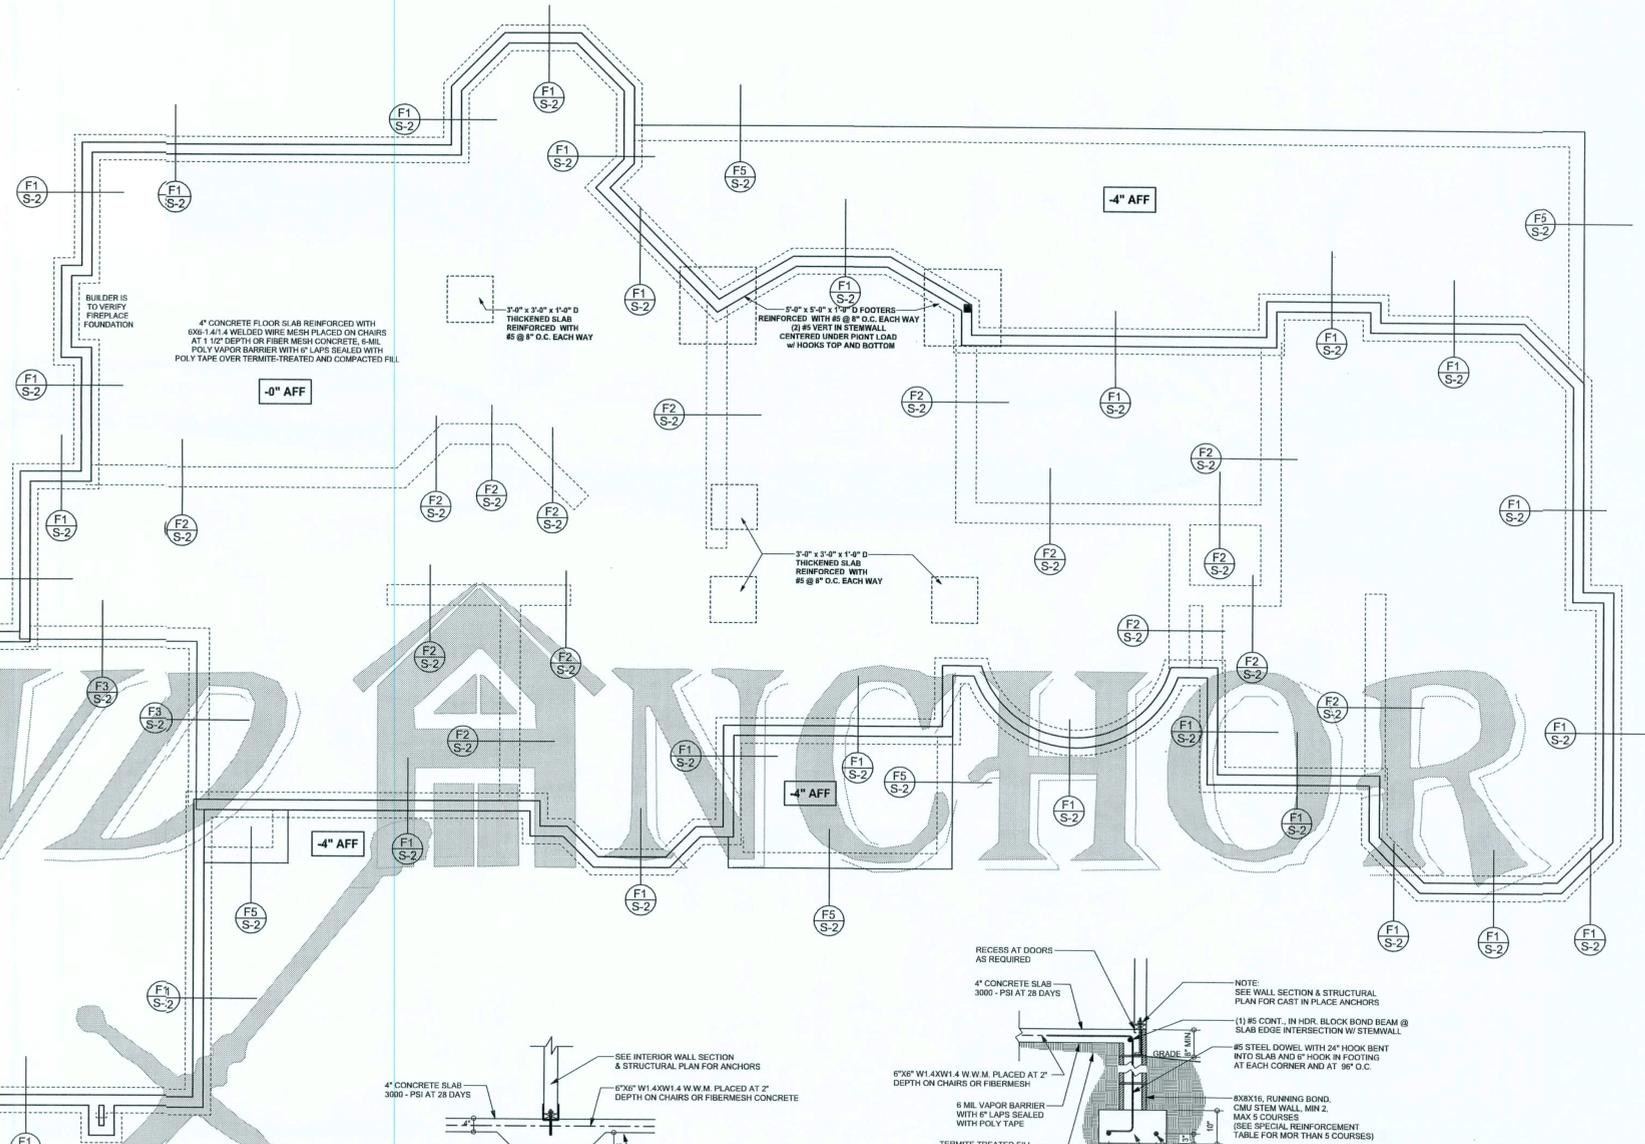


**F2 INTERIOR BEARING FOOTING**  
SCALE: 1/2" = 1'-0"

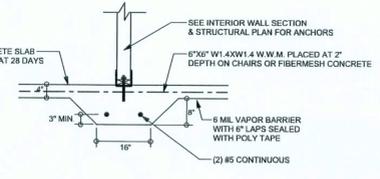

**F3 INTERIOR BEARING STEP FOOTING**  
SCALE: 1/2" = 1'-0"

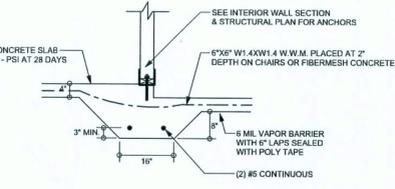

**F1 STEM WALL FOOTING**  
SCALE: 1/2" = 1'-0"

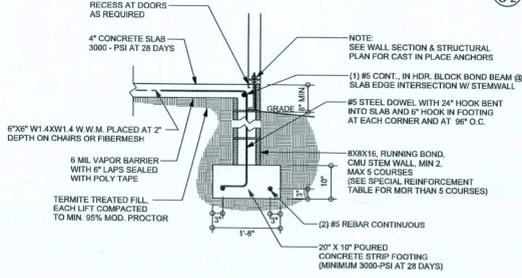

**TALL STEM WALL TABLE**

This table assumes 60 ksi reinforcing bars with 6" hook in the footing and bent 24" into the reinforced slab at the top. The vertical steel is to be placed toward the tension side of the CMU wall (away from the soil pressure, within 2" of the exterior side of the wall). If the wall is over 8' high, add Durwall ladder reinforcement at 16" O.C. vertically or a horizontal band beam with 1#5 continuous at mid height. For higher parts of the wall 12" CMU may be used with reinforcement as shown in the table below.

STEMWALL HEIGHT (FEET)	UNBALANCED BACKFILL HEIGHT	VERTICAL REINFORCEMENT FOR 8" CMU STEMWALL (INCHES O.C.)			VERTICAL REINFORCEMENT FOR 12" CMU STEMWALL (INCHES O.C.)		
		#5	#7	#8	#5	#7	#8
3.3	3.0	96	96	96	96	96	96
4.0	3.7	96	96	96	96	96	96
4.7	4.3	88	96	96	96	96	96
5.3	5.0	56	96	96	96	96	96
6.0	5.7	40	80	96	80	96	96
6.7	6.3	32	56	80	56	96	96
7.3	7.0	24	40	56	40	80	96
8.0	7.7	16	32	48	32	64	80
8.7	8.3	8	24	32	24	48	64
9.3	9.0	8	16	24	16	40	48

WINDLOAD ENGINEER: Mark Disoway, P.E. No. 53915, P.O. Box 868, Lake City, FL 32056, 386-754-5419

**DIMENSIONS:**  
Stated dimensions supercede scaled dimensions. Refer all questions to Mark Disoway, P.E. for resolution. Do not proceed without clarification.

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**CERTIFICATION:** I hereby certify that I have examined this plan, and that the applicable portions of the plan, relating to wind engineering comply with section F301.2.1, Florida building code residential 2004, to the best of my knowledge.

**LIMITATION:** This design is valid for one building, at specified location.

MARK DISOWAY  
P.E. 53915  
*Mark Disoway*  
2/26/07  
SEAL

**Isaac Construction**  
**Jeremy & Susie Cady**  
Residence  
ADDRESS:  
Columbia County, Florida

Mark Disoway P.E.  
P.O. Box 868  
Lake City, Florida 32056  
Phone: (386) 754 - 5419  
Fax: (386) 269 - 4871


PRINTED DATE:  
July 26, 2007  
DRAWN BY: Evan Ewartley  
CHECKED BY:

FINALS DATE:  
July 26, 2007

**JOB NUMBER:**  
705032

**DRAWING NUMBER**  
**S-2**  
OF 4 SHEETS


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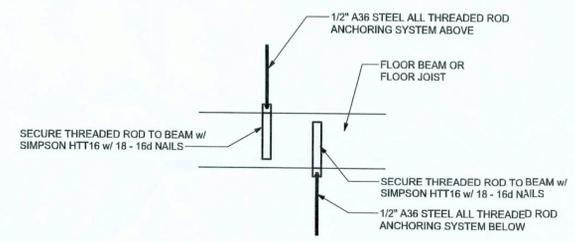
**INTERIOR SHEAR WALL DETAIL**  
SCALE: 1/2" = 1'-0"

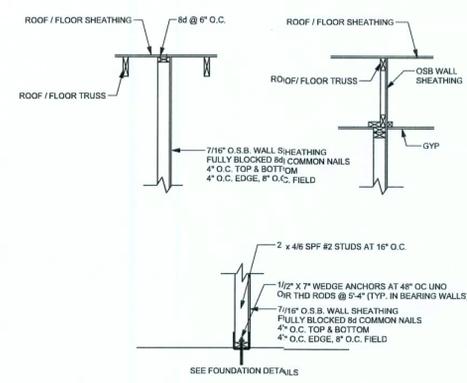NOTE: IF TRUSS TO WALL STRAPS ARE NAILED TO THE HEADER THE SP4/6 @ 48" O.C. ARE NOT REQUIRED


FOR LESS THAN 1500 lb UPLIFT USE 2 X 2 X 1/8" WASHER  
FOR LESS THAN 3750 lb UPLIFT USE 3 X 3 X 1/8" WASHER



**TYPICAL 2 STORY HEADER STRAPPING DETAIL**  
SCALE: 1/2" = 1'-0"

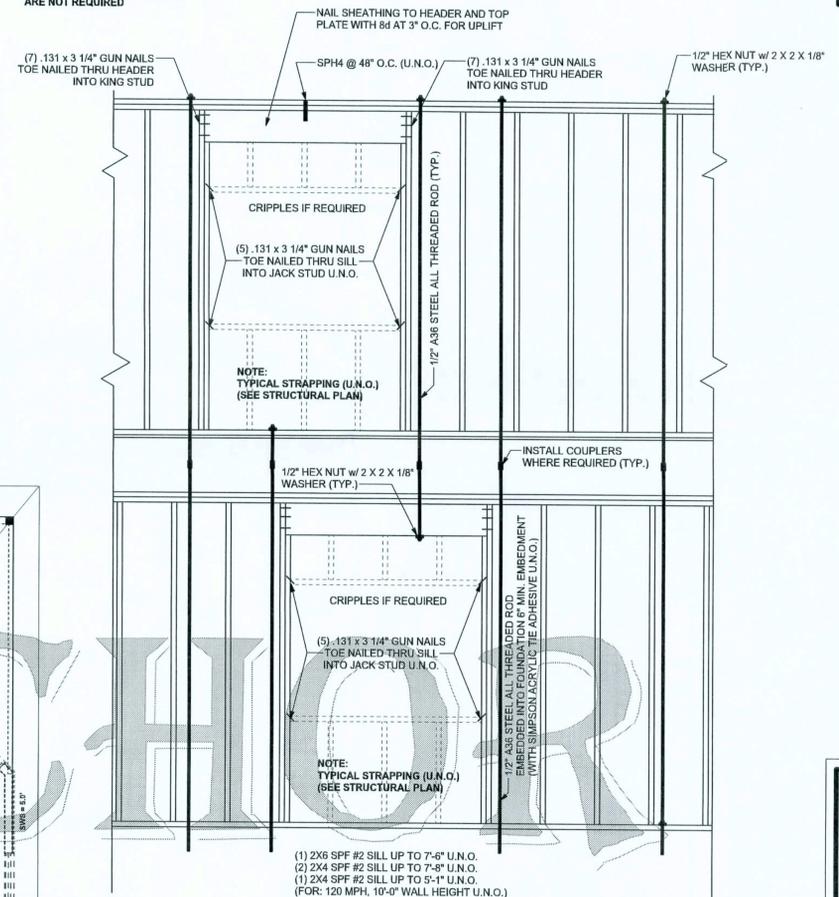

**OPTIONAL THREADED ROD TO FLOOR BEAM OR FLOOR JOIST**  
SCALE: 1/2" = 1'-0"

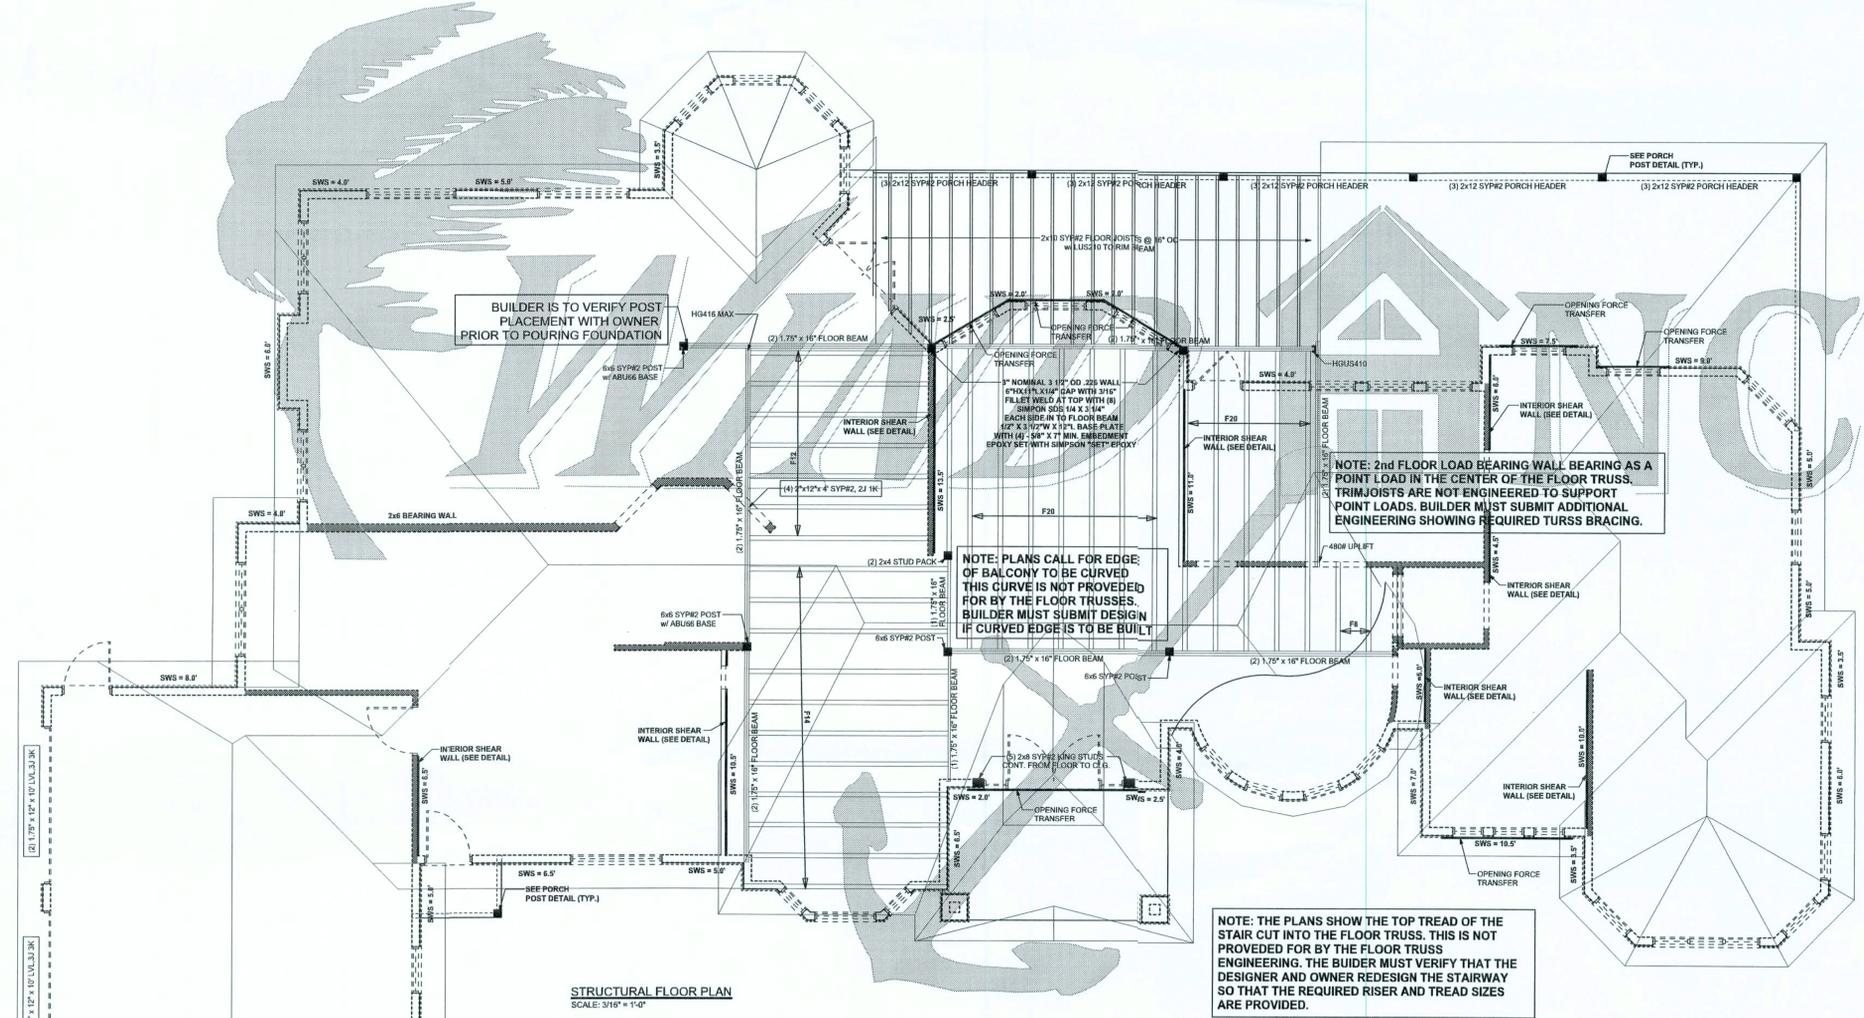

**STRUCTURAL FLOOR PLAN**  
SCALE: 3/16" = 1'-0"

**STRUCTURAL PLAN NOTES**

- SN-1 ALL LOAD BEARING FRAME WALL & PORCH HEADERS SHALL BE A MINIMUM OF (2) 2X12 SYP#2 (U.N.O.)
- SN-2 ALL LOAD BEARING FRAME WALL HEADERS SHALL HAVE (1) JACK STUD & (1) KING STUD EACH SIDE (U.N.O.)
- SN-3 DIMENSIONS ON STRUCTURAL SHEETS ARE NOT EXACT. REFER TO ARCHITECTURAL FLOOR PLAN FOR ACTUAL DIMENSIONS
- SN-4 PERMANENT TRUSS BRACING IS TO BE INSTALLED AT LOCATIONS AS SHOWN ON THE SEALED TRUSS DRAWINGS. LATERAL BRACING IS TO BE RESTRAINED PER BC311.03, BC3181, BC3142 & BC3143, BC3181, BC3142 & BC3143 ARE FURNISHED BY THE TRUSS SUPPLIER, WITH THE SEALED TRUSS PACKAGE

**WALL LEGEND**

SWS = 0.5'	1ST FLOOR EXTERIOR WALL
SWS = 0.9'	2ND FLOOR EXTERIOR
1BW	1ST FLOOR INTERIOR BEARING WALLS SEE DETAILS ON SHEET S-1
2BW	2ND FLOOR INTERIOR BEARING WALLS SEE DETAILS ON SHEET S-1

**THREADED ROD LEGEND**

(●)	INDICATES LOCATION OF 1ST FLOOR 1/2" A307 ALL THREADED ROD
(⊙)	INDICATES LOCATION OF 2ND FLOOR 1/2" A307 ALL THREADED ROD

**HEADER LEGEND**

(2) 2X12X7.14 1K	HEADER-BEAM CALL-OUT (U.N.O.)
—	NUMBER OF KING STUDS (FULL LENGTH)
—	NUMBER OF JACK STUDS (UNDER HEADER)
—	SPAN OF HEADER
—	SIZE OF HEADER MATERIAL
—	NUMBER OF PILES IN HEADER

**1ST FLOOR TOTAL ACTUAL SHEAR WALL**

	TRANSVERSE	LONGITUDINAL
ACTUAL	7875 LB	52905 LB
REQUIRED	71808 LB	37124 LB

CONNECTIONS, WALL & HEADER DESIGN IS BASED ON REACTIONS & UPLIFTS FROM TRUSS ENGINEERING FURNISHED BY BUILDER, ANDERSON TRUSS, JOB # 7-1408

WINDLOAD ENGINEER: Mark Disoway, P.E. No. 53915, P.O. Box 868, Lake City, FL 32056, 386-754-5419

DIMENSIONS: Stated dimensions supersede scaled dimensions. Refer all questions to Mark Disoway, P.E. for resolution. Do not proceed without clarification.

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CERTIFICATION: I hereby certify that I have examined this plan, and that the applicable portions of the plan, relating to wind engineering comply with section 905.2.1, Florida building code residential 2004, to the best of my knowledge.

LIMITATION: This design is valid for one building, at specified location.

MARK DISOWAY  
P.E. 53915  
27 JUL 07  
SEAL

**Isaac Construction**

Jeremy & Susie Cady  
Residence

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Phone: (386) 754 - 5419  
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PRINTED DATE:  
July 26, 2007

DRAWN BY:  
Evan Beamsby


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FINALS DATE:  
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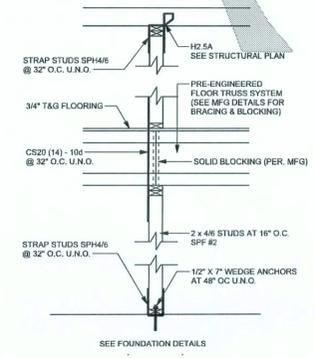
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DRAWING NUMBER  
**S-3**  
OF 4 SHEETS


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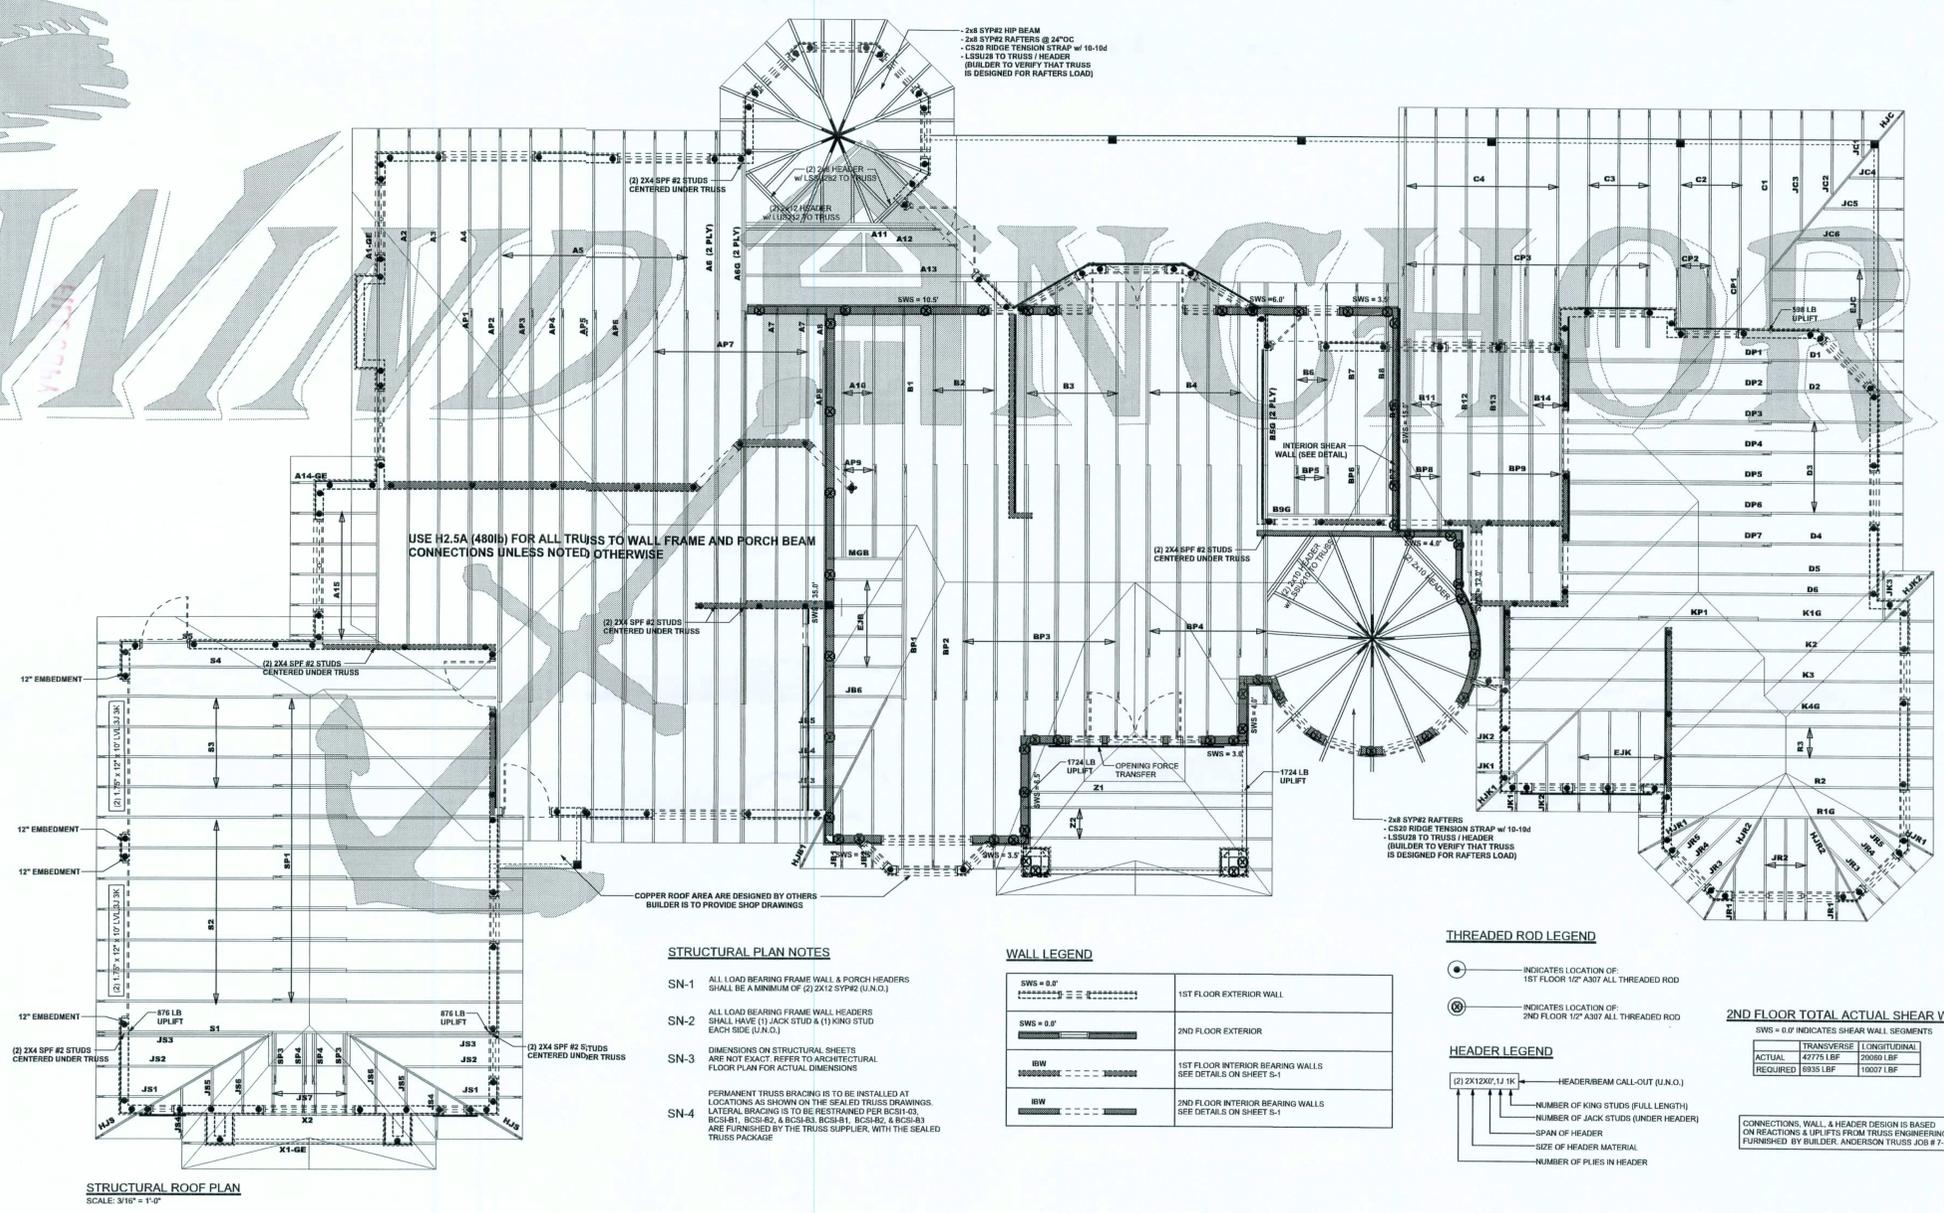
**ALTERNATE WALL TIE CONNECTION WHERE  
THREADED ROD CANNOT BE PLACED IN WALL**  
SCALE: 1/2" = 1'-0"



**(ALT.) 2 STORY INTERIOR BEARING WALL**  
SCALE: 1/2" = 1'-0"

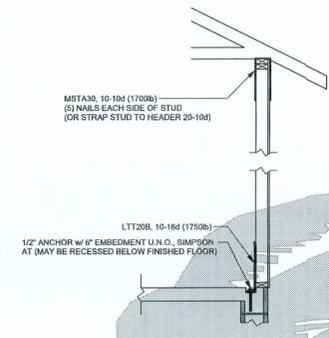

**(ALT.) INTERIOR BEARING WALL TO BEAM**  
SCALE: 1/2" = 1'-0"

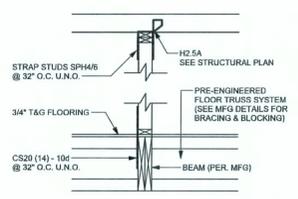

**STRUCTURAL ROOF PLAN**  
SCALE: 3/16" = 1'-0"

- STRUCTURAL PLAN NOTES**
- SN-1 ALL LOAD BEARING FRAME WALL & PORCH HEADERS SHALL BE A MINIMUM OF (2) 2X12 SIPRZ (U.N.O.)
  - SN-2 ALL LOAD BEARING FRAME WALL HEADERS SHALL HAVE (1) JACK STUD & (1) KING STUD EACH SIDE (U.N.O.)
  - SN-3 DIMENSIONS ON STRUCTURAL SHEETS ARE NOT EXACT. REFER TO ARCHITECTURAL FLOOR PLAN FOR ACTUAL DIMENSIONS.
  - SN-4 PERMANENT TRUSS BRACING IS TO BE INSTALLED AT LOCATIONS AS SHOWN ON THE SEALED TRUSS DRAWINGS. LATERAL BRACING IS TO BE RESTRAINED PER BC211-Q3, BC211-B1, BC211-B2 & BC211-B3. BC211-B1, BC211-B2, & BC211-B3 ARE FURNISHED BY THE TRUSS SUPPLIER, WITH THE SEALED TRUSS PACKAGE.

**WALL LEGEND**

SWS = 0.0'	1ST FLOOR EXTERIOR WALL
SWS = 0.0'	2ND FLOOR EXTERIOR
IRW	1ST FLOOR INTERIOR BEARING WALLS SEE DETAILS ON SHEET S-1
IRW	2ND FLOOR INTERIOR BEARING WALLS SEE DETAILS ON SHEET S-1

- THREADED ROD LEGEND**
- INDICATES LOCATION OF 1ST FLOOR 1/2" A307 ALL THREADED ROD
  - ⊙ INDICATES LOCATION OF 2ND FLOOR 1/2" A307 ALL THREADED ROD

- HEADER LEGEND**
- (2) 2X12@1.1 1K → HEADER/BEAM CALL-OUT (U.N.O.)
  - NUMBER OF KING STUDS (FULL LENGTH)
  - NUMBER OF JACK STUDS (UNDER HEADER)
  - SPAN OF HEADER
  - SIZE OF HEADER MATERIAL
  - NUMBER OF PILES IN HEADER

**2ND FLOOR TOTAL ACTUAL SHEAR WALL**

	TRANSVERSE	LONGITUDINAL
ACTUAL	42775 LBF	20680 LBF
REQUIRED	6935 LBF	10071 LBF

CONNECTIONS, WALL & HEADER DESIGN IS BASED ON REACTIONS & UPLIFTS FROM TRUSS ENGINEERING FURNISHED BY BUILDER. ANDERSON TRUSS JOB # 7-140B

WINDLOAD ENGINEER: Mark Disoway, P.E. No. 53915, POB 868, Lake City, FL 32056, 386-754-5419

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**LIMITATION:** This design is valid for one building, at specified location.

MARK DISOWAY  
P.E. 53915  
*Mark Disoway*  
SEAL

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**Jeremy & Susie Cady  
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Evin Beardsley

CHECKED BY:

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July 26, 2007

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705032**

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**S-4**  
OF 4 SHEETS