# **GENERAL**:

T1.E TITLE SHEET OPTION E

## OWNER:

F1.E FIXTURE PLAN OPTION E

# ARCHITECTURAL:

| ,    |                                  |  |
|------|----------------------------------|--|
| A1.E | FLOOR PLAN OPTION E              |  |
| A2.E | EXTERIOR ELEVATIONS OPTION E     |  |
| A3.E | SECTIONS AND DETAILS OPTION E    |  |
| A4.E | SCHEDULES OPTION E               |  |
| A5.E | DOOR DETAILS OPTION E            |  |
| ACE  | TOU ET DI ANI 9 DETAILS OPTION E |  |

# STRUCTURAL:

A7.E SIGN DETAILS OPTION E

| S1.E | STRUCTURAL NOTES OPTION E                   |
|------|---|
| S2.E | CONCRETE SUMMARY OPTION E                   |
| S3.E | RETROPLATE WORKORDER OPTION E               |
| S4.E | FND. STRUCTURAL NOTES & DETS ELLISVILLE, FL |
| S5.E | FOUNDATION PLAN - ELLISVILLE, FL            |

# **ELECTRICAL**:

| E1.E   | POWER PLAN OPTION E                    |
|--------|--|
| E2.E   | LIGHTING PLAN OPTION E                 |
| E3.E   | POWER POLE DETAILS OPTION E            |
| E4.E   | POWER POLE DETAILS OPTION E            |
| E5.E   | ELECTRICAL PANELS OPTION E             |
| EMS1.E | SENSOR LOCATION PLAN OPTION E          |
| EMS2.E | CPU TERMINAL DIAGRAM OPTION E          |
| EMS3.E | EMS PANEL AND CONTROLS OPTION E        |
| EMS4.E | EMS PANEL AND CONTROLS OPTION E        |
| FS1 F  | FLECTRICAL SITE LIGHTING PLAN OPTION E |

# MECHANICAL:

M1.E HVAC LAYOUT & SCHEDULE OPTION E

# PLUMBING:

| P1.E | PLUMBING PLANS OPTION E                    |
|------|--|
| P2.E | PLUMBING DETAILS & RISER DIAGRAMS OPTION E |

| SQUARE FOOTAGE LEGE           | END              |
|-------------------------------|------------------|
| TOTAL SQUARE FOOTAGE          | 8,988 S.F.       |
| OVERALL BUILDING DIMENSIONS   | 70'-0" X 130'-0" |
| SALES FLOOR DIMENSIONS        | 68'-0" X 109'-0" |
| SALES AREA                    | 7,265 S.F.       |
| STOCK ROOM AREA               | 905 S.F.         |
| CLEAR OFFICE AREA             | 70 S.F.          |
| REST RM, BREAK RM & HALL AREA | 337 S.F.         |
| COVERED ENTRY                 | 112 S.F.         |

## NOTE:

BUILDING MUST COMPLY WITH ALL BUILDING (FEDERAL STATE AND LOCAL) FIRE, ADA AND HEALTH DEPARTMENT ALL PR)TOTYPICAL

DIRECED TO THE

**DOLLAI GENERAL** 

**AUTOOD-STORE** 

**DESIGNDEPARTMENT** 

AT (615 855-4753 OR

CONSTRUCTIONCAD@


DOLLAIGENERAL.COM

NO TAPERED OR INTERIOR COLUMNS ALLOWED.

MAINTAIN INTERIOR CLEAR SPACE AS REQUIRED ON PLANS.

METAL BUILDING COLUMNS SHALL BE STRAIGHT TAPERED APPROVAL. MAINTAIN INTERIOR CLEARANCE OF 68'-1 1/4" BETWEEN FACE OF COLUMNS ON SALES FLOOR.

# 70'-0 x 130'-0" CORNER ENTRY WITH LEFT REAR EXIT OPTION "E"

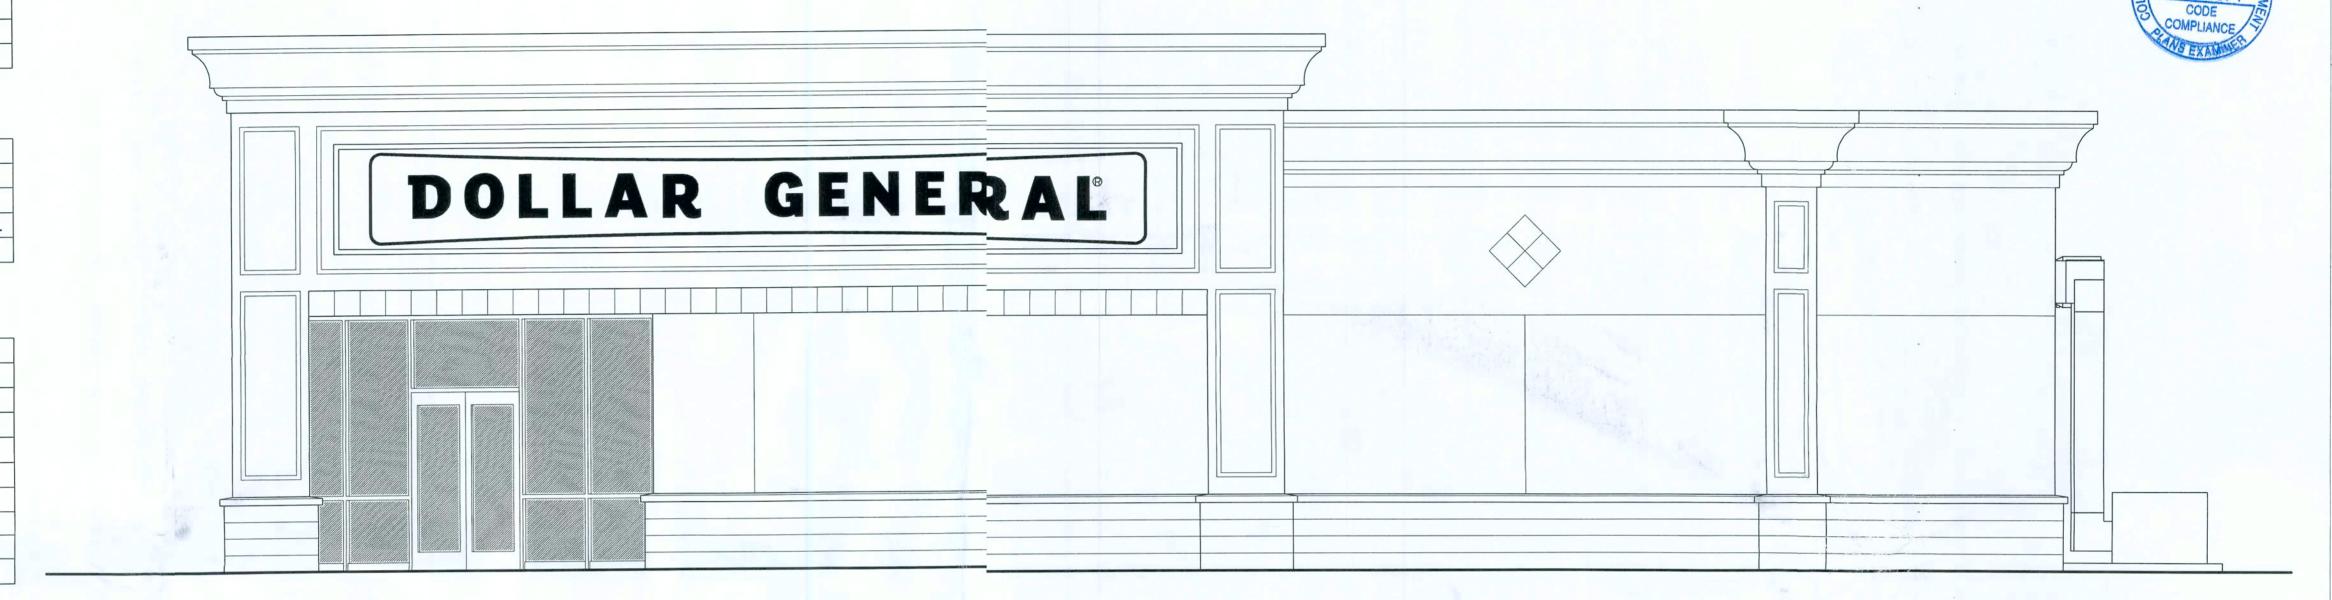

| REQUIRED NATIONAL | ACCOUNT VEINDORS |
|-------------------|------------------|

| COMPANY                              | CONTACTS   | PHONE #                                     | REQUIRED ITEMS  |
|--------------------------------------|--|---|---|
| BASS SECURITY SERVICES, INC.         | NATIONAL ACCOUNT SALES                               | 888-774-3400<br>EXT. 2022                   | DOOR HARDWARE AND RESTROOM ACCESSORIES                      |
| MC CUE CORPORATION                   | DENISE CURRICHAN                                     | 800-800-8503<br>EXT. 290                    | CART BUMPERS AND CORNER GUARDS PART# 9014 TRIMKIT           |
| LENNOX                               | JOSHUA PLUUMMER                                      | 800-367-6285 OPT. 2                         | HVAC UNITS (LOW GAS) KGA060S4B-DG / (ELECTRIC) KCA060S4B-DG |
| CARRIER                              | ALISON HAR TIMAN                                     | 800-690-1081                                | HVAC UNITS (HIGH GAS) 48TCFA06A1A3A0A0A0A1-DG               |
| SHERWIN WILLIAMS                     | LOCAL SHER WIN WILLIAMS STORE                        |   | PAINT, PRIMER, CONCRETE SEALER AND BLOCK FILLER             |
| STANLEY DOORS                        | ART BULLMA <sub>AN</sub> RYAN DRISC <sub>COLL</sub>  | 636-391-1508<br>800-648-1401 OPT. 2, EXT. 6 | AUTOMATIC DOORS AND STORE FRONT<br>GLAZING SYSTEM           |
| D&P CUSTOM LIGHTING                  | NATIONAL ACCCOUNT SALES                              | 800-251-2200                                | CUSTOM POWER POLES  |
| EMERSON CLIMATE TECHNOLOGIES         | PETE STEVEIENS                                       | 770-425-2724                                | EMS SUPPLIER  |
| RETROPLATE SYSTEMS                   | LEO HENDERRSON general-dollar(r@retroplatesystem.com | 888-942-3144                                | CONCRETE POLISHING SYSTEMS                                  |
| CONSOLIDATED ELECTRICAL DISTRIBUTORS | ROBERT DECCKER                                       | 270-781-2229                                | ELECTRICAL, LIGHTING SUPPLIES                               |

## PLAN IQUIRIES MAY BE OPTIONAL NATIONAL ACCOUNT VENDORS

| COMPANY                  | CONTACTS         | PHONE #      | REQUIRED ITEMS                |  |
|--------------------------|------------------|--------------|-------------------------------|--|
| LIBERTY BUILDING SYSTEMS | DAVID ENGLI_ISH  | 877-505-4596 | PRE-ENGINEERED METAL BUILDING |  |
| STAR BUILDING SYSTEMS    | JEFF HORN        | 866-664-8899 | PRE-ENGINEERED METAL BUILDING |  |
| NUCOR BUILDING SYSTEMS   | TY DAVENPOORT    | 803-799-9708 | PRE-ENGINEERED METAL BUILDING |  |
| CASCO                    | JOHN HARRI\(\)IS | 314-821-1100 | PROFESSIONAL SERVICES         |  |

NATIONAL ACCOUNT & CONTACT INFORMATION SUBJECT TO CHANGE

TITLE SHEET OPTION "E"






DATE

18 JAN 2010

SHEET NUMBER

T1.E

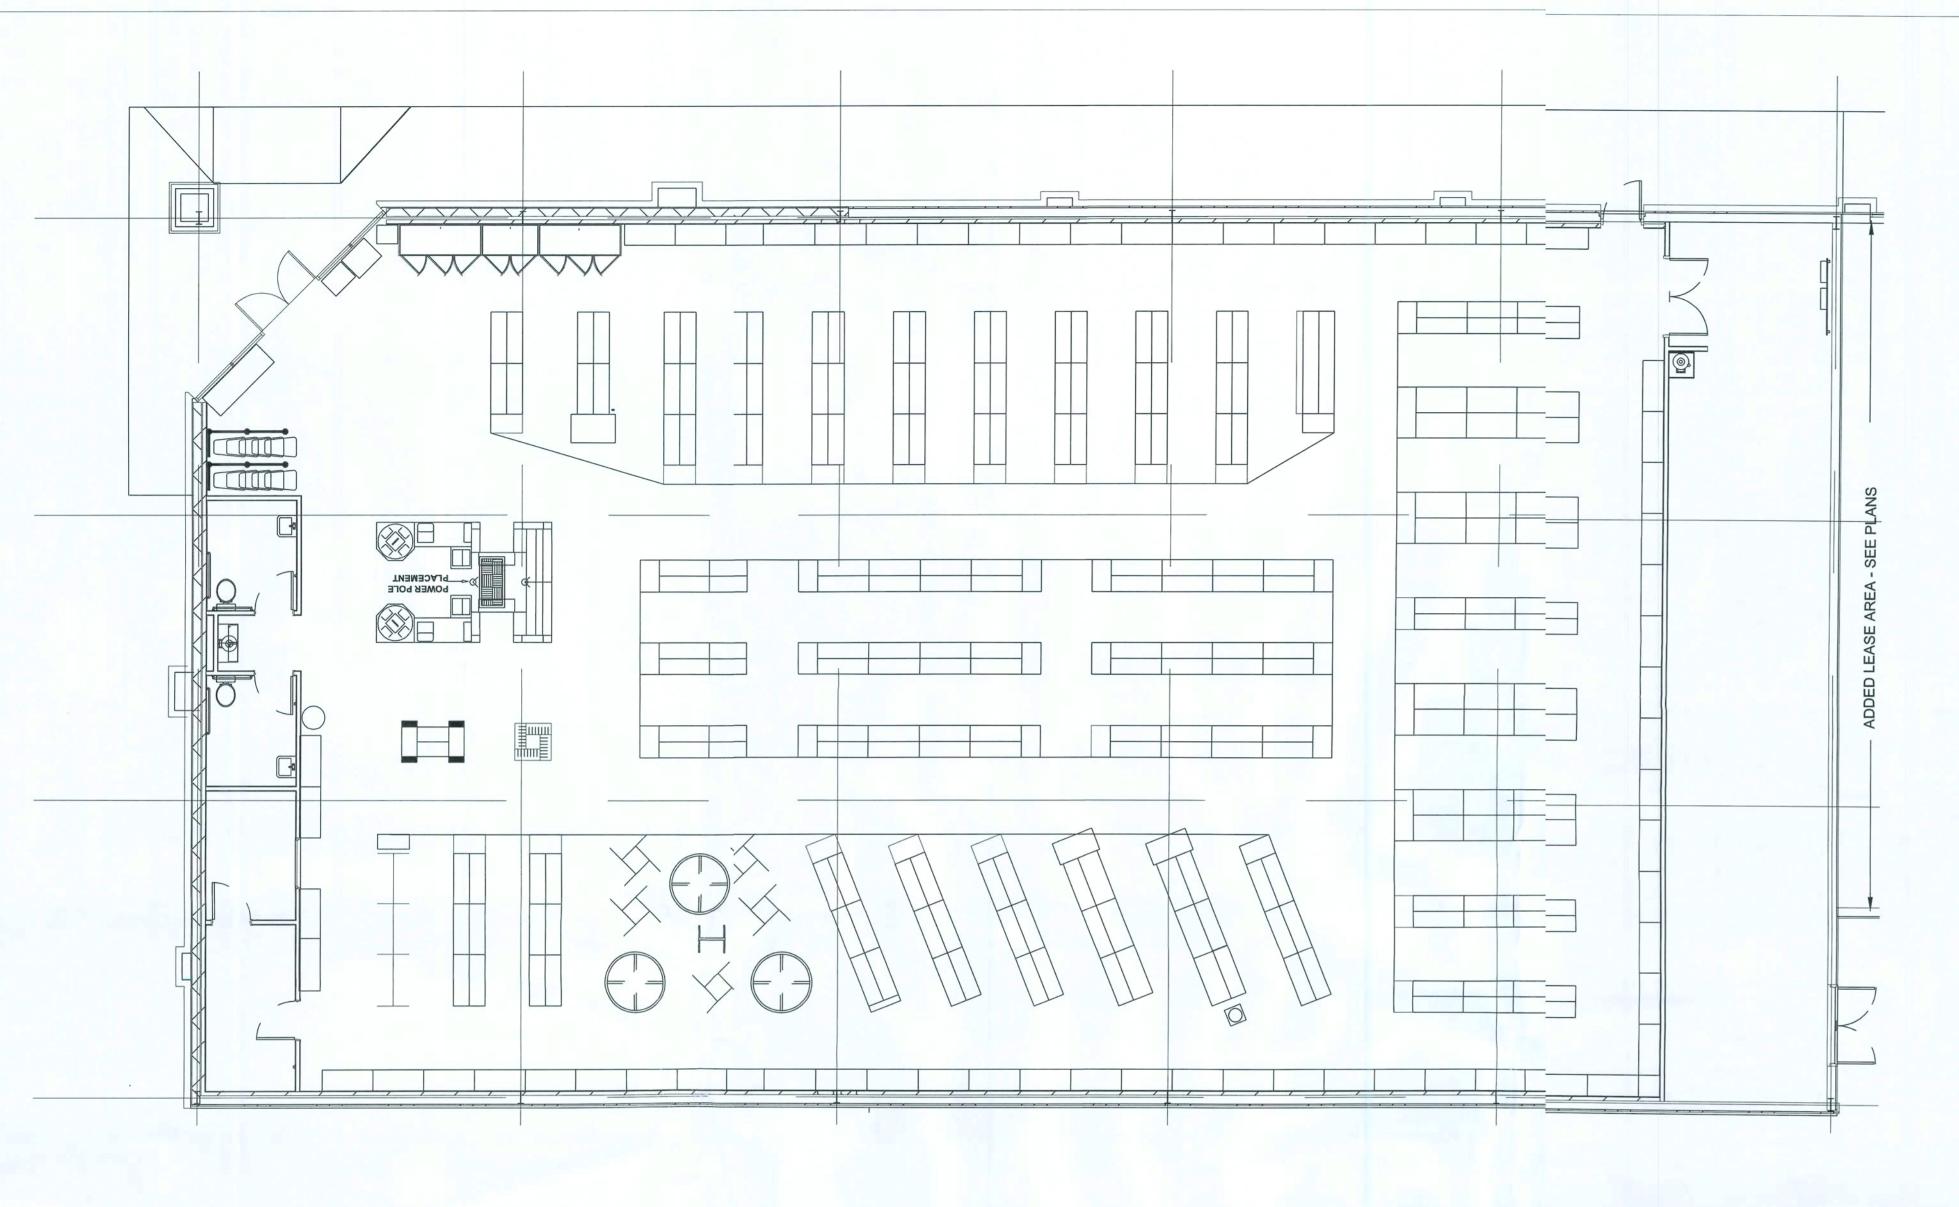

FIXTURE PLAN 1/16" = 1'-0"

NOTE: IF THE LOCATION OF ANY ITEM INCLUDING DOORS) CHANGES, PLEASE CONSULTIHE DOLLAR GENERAL CONSTRUCTION DEPARTMENT FOR COOLER RECEPTACLE LOCATION.

NOTE: PLEASE NOTE THAT THE ORIENTATION OF THE RESTROOMS AND THE OFFICE ALWAYS
STAY THE SAME REGARD)LESS OF THE LOCATION
OF THE RECEIVING DOORS.




DATE

18 JAN 2010


SHEET NUMBER

F1.E

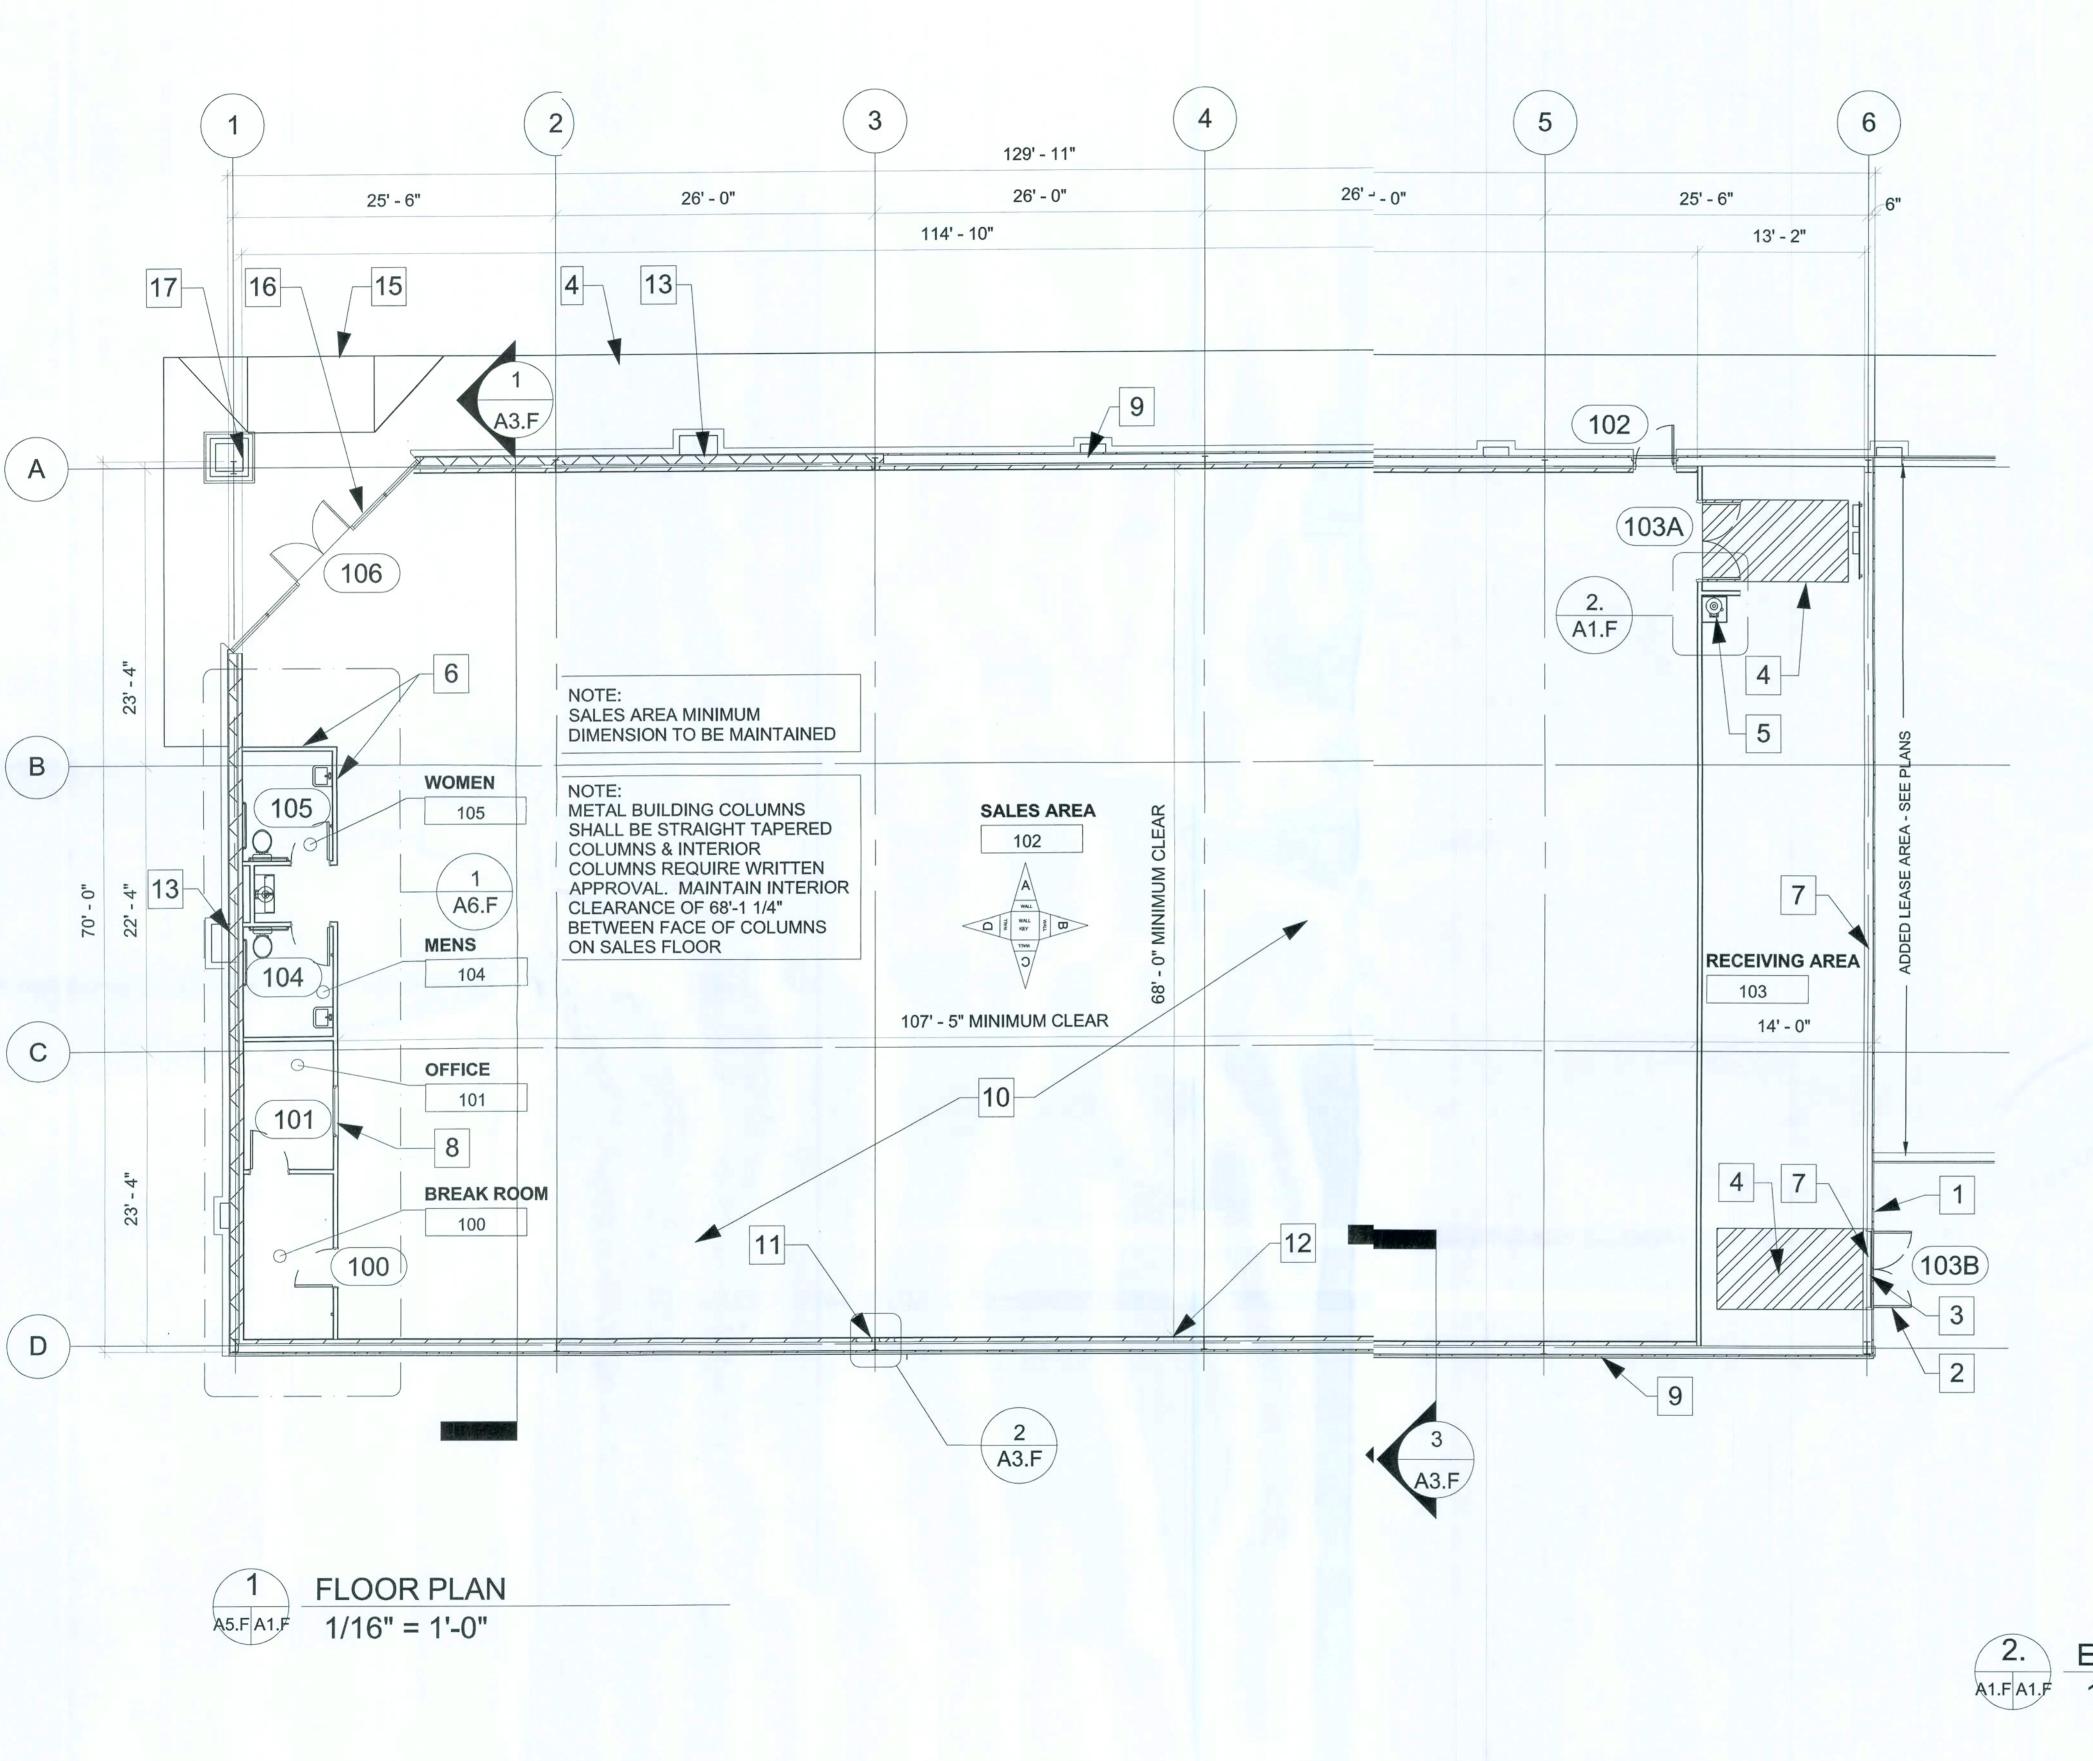

# FLOOR PLAN KEYED NOTES

- 1 RECEIVING DOOR BUZZER TORK MDL.#TA725 OR EQUAL
- 2 2" DOOR SCOPE, BASS SECURITY DS/1000MB.
- 3 WEATHER STRIP & LOW PROFILE THRESHOLD LESS THAN 1/2"
- 4 STRIPE FLOOR FOR DESIGNATED EGRESS PATH (PAINT YELLOW)
- 5 PROVIDE AND INSTALL A TEN GALLON WATER HEATER (OR LARGER IF REQUIRED BY CODE) ABOVE THE MOP SINK.
- 6 METAL STUD / GYP. BD. PARTITION TO DECK.
- 7 METAL LINER PANELS TO UNDERSIDE OF ROOF DECK. (BY PRE-ENGINEERED BUILDING MANUFACTURER).
- 8 2'X4' ONE WAY WINDOW
- 9 METAL BUILDING PANELS (BY PRE-ENGINEERED BUILDING MANUFACTURER).
- 10 CONCRETE SLAB WITH 6X6XW1.4 WELDED WIRE MESH OVER POLYETHYLENE VAPOR BARRIER (MIN. 4 MM THICK) OVER CRUSHED STONE BASE, TYP.
- 11 ÄLIGN FACE OF STUDS WITH COLUMN, TYP. AT EXTERIOR WALL. PROVIDE 5/8" GYP. BD. TO 6" A.F.C. AND INFILL WITH R-11 BATT INSULATION WITH VAPOR BARRIER.
- 12 METAL STUDS PARTITION WITH 5/8" GYP. BD. TO DECK ABOVE (INFILL EXTERIOR SIDE WITH R-11 BATT INSULATION WITH VAPOR BARRIER).
- 13 8" SPLITFACE CMU PAINTED TO MATCH MTL. SIDING. ALING FACE OF BLOCK WITH STEEL GIRT.
- 14 BROOM FINISH CONCRETE SIDEWALK, TYP.
- 15 A.D.A. COMPLIANT H.C. RAMP WITH YELLOW PAINTED SIDES TO H.C. PARKING STALLS
- 16 BRONZE STOREFRONT SYSTEM. REFER TO SHEETS A4.D AND A5.D FOR ADDITIONAL INFORMATION. CONTINUE TO DECK AS IN NOTE 12
- 17 LINE OF SOFFIT ABOVE

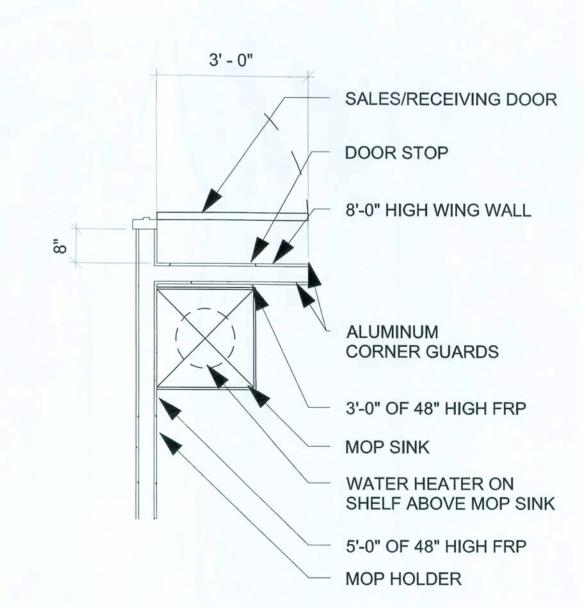

2. ENLARGED DETAIL 1/4" = 1'-0"

FLOORPLAN OPTION "E"



LLAR GENERAL ELISVILLE, FLORIDA


2010 PROT Store Design

DATE

18 JAN 2010

SHEET NUMBER

A1.E

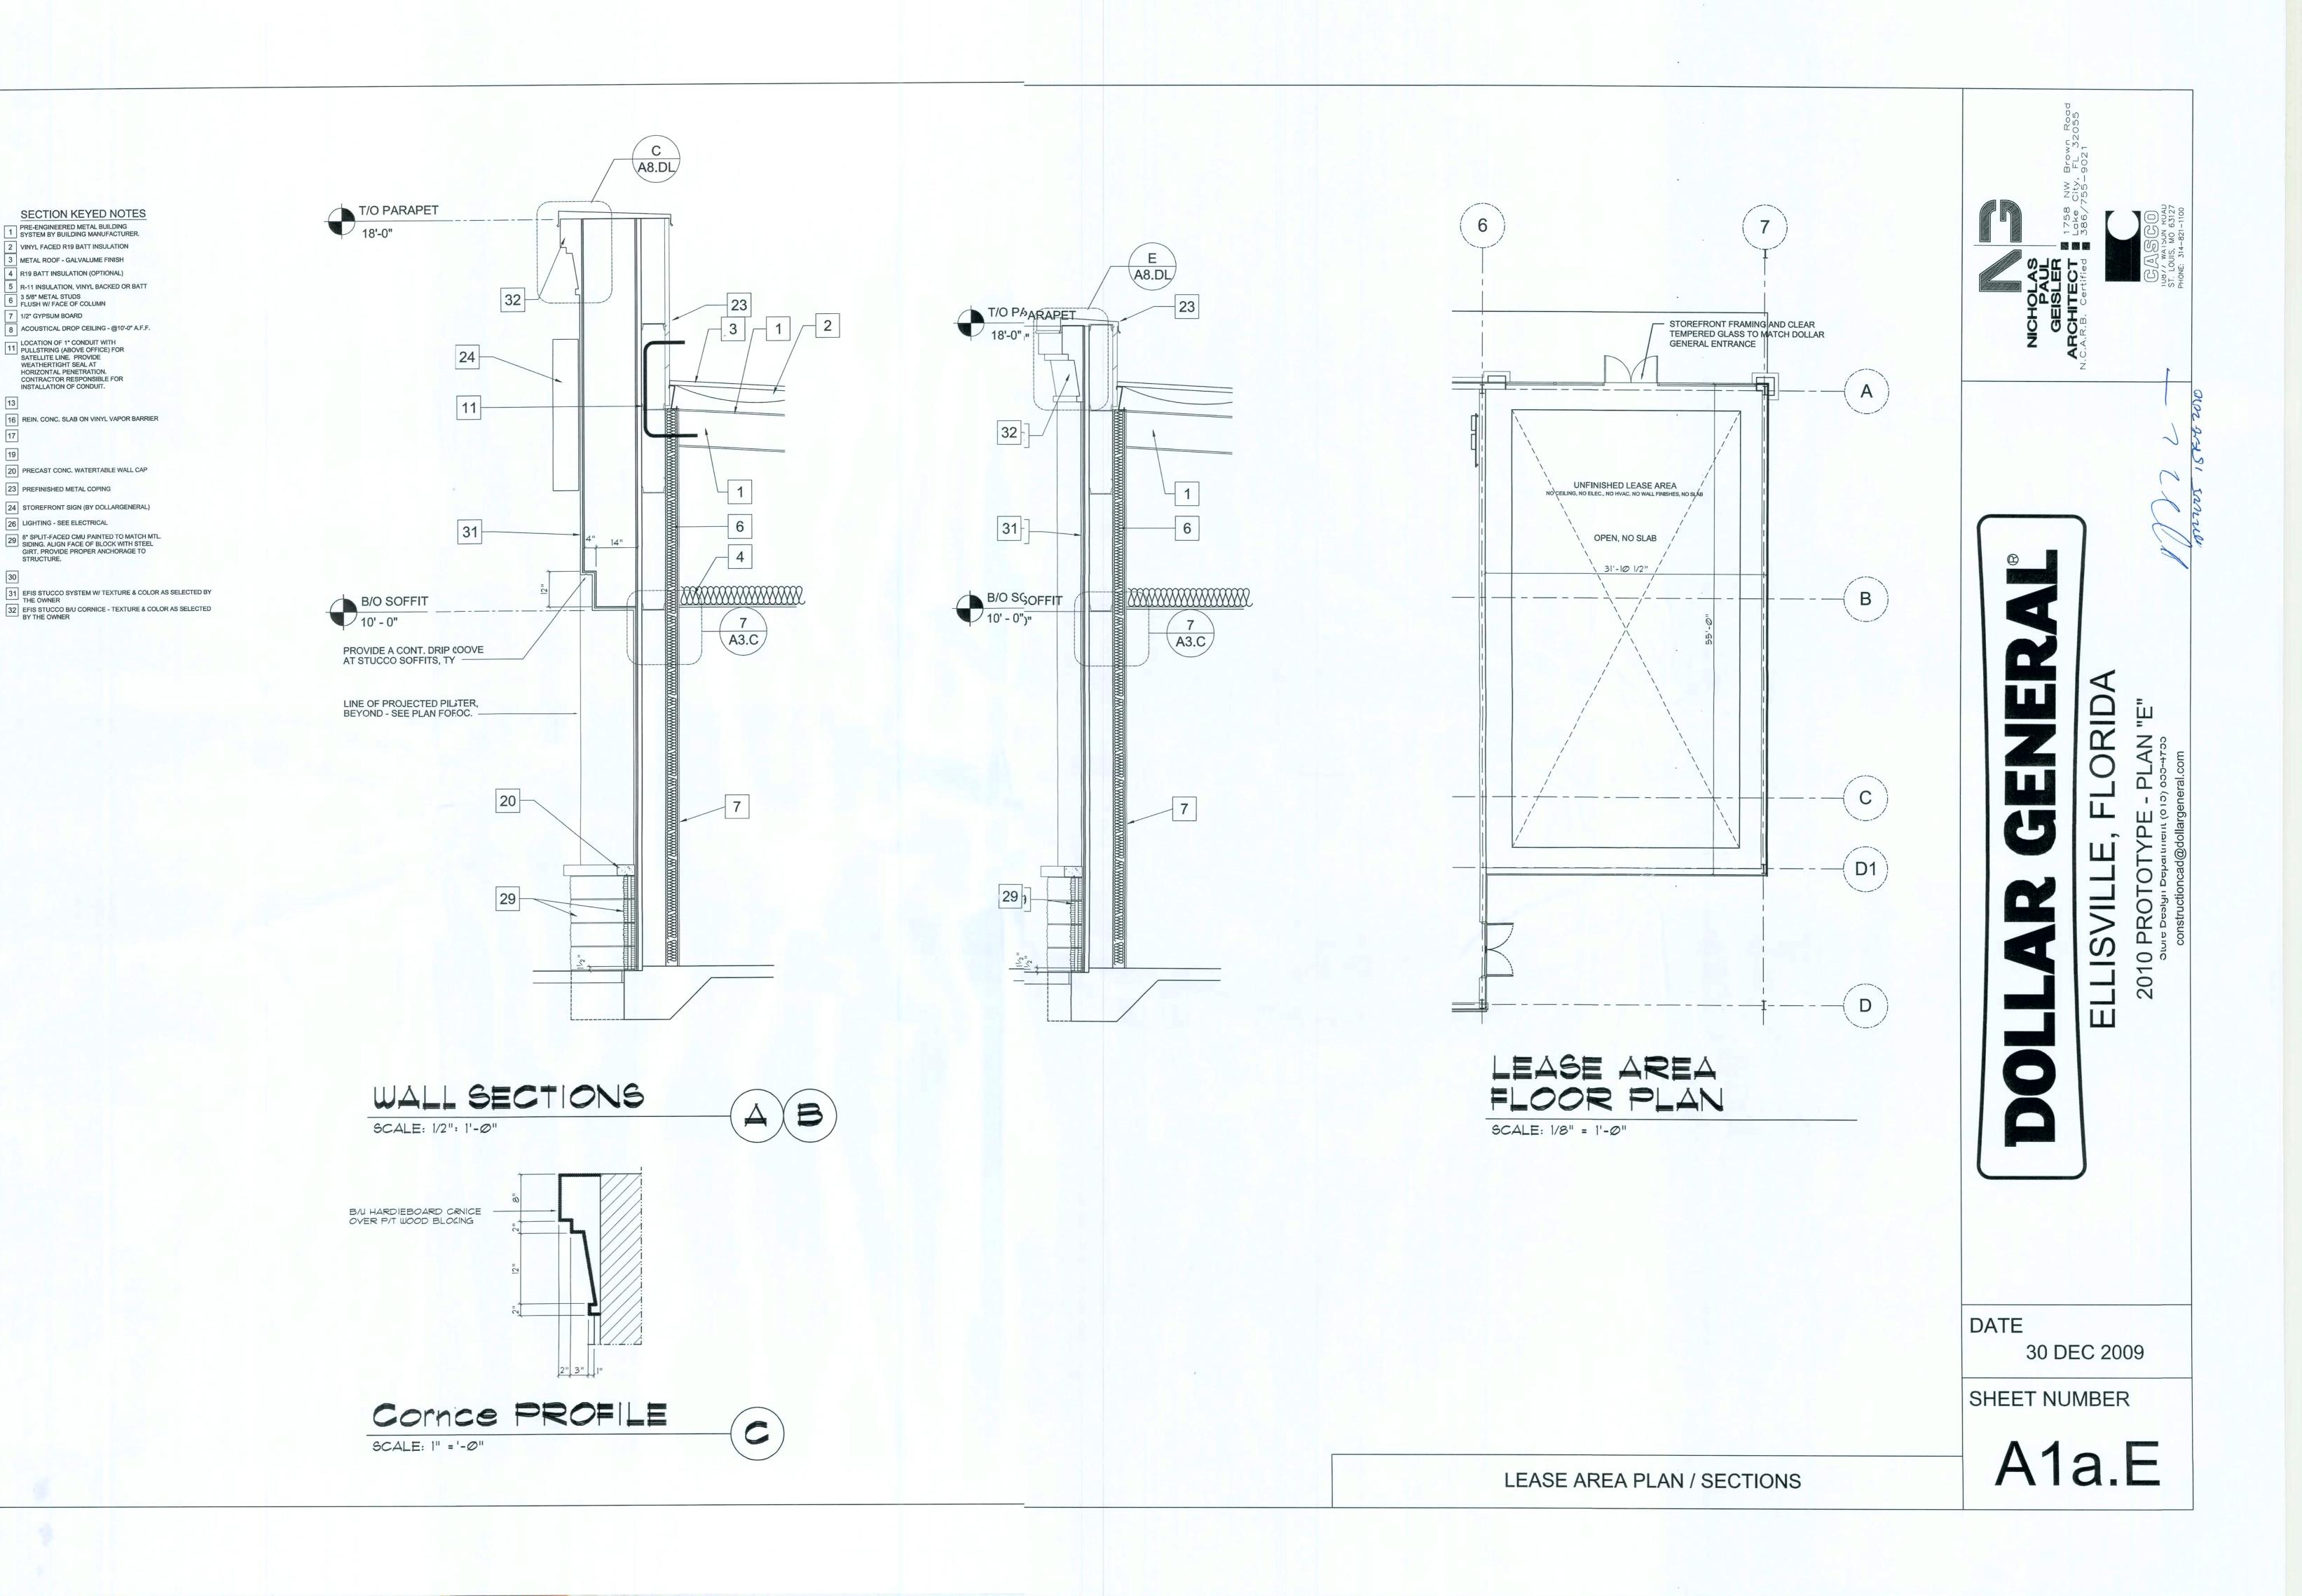

SECTION KEYED NOTES PRE-ENGINEERED METAL BUILDING SYSTEM BY BUILDING MANUFACTURER. 2 VINYL FACED R19 BATT INSULATION 3 METAL ROOF - GALVALUME FINISH 4 R19 BATT INSULATION (OPTIONAL)

3 5/8" METAL STUDS FLUSH W/ FACE OF COLUMN


LOCATION OF 1" CONDUIT WITH
PULLSTRING (ABOVE OFFICE) FOR
SATELLITE LINE. PROVIDE
WEATHERTIGHT SEAL AT
HORIZONTAL PENETRATION.
CONTRACTOR RESPONSIBLE FOR
INSTALLATION OF CONDUIT.

23 PREFINISHED METAL COPING


26 LIGHTING - SEE ELECTRICAL

STRUCTURE.

7 1/2" GYPSUM BOARD

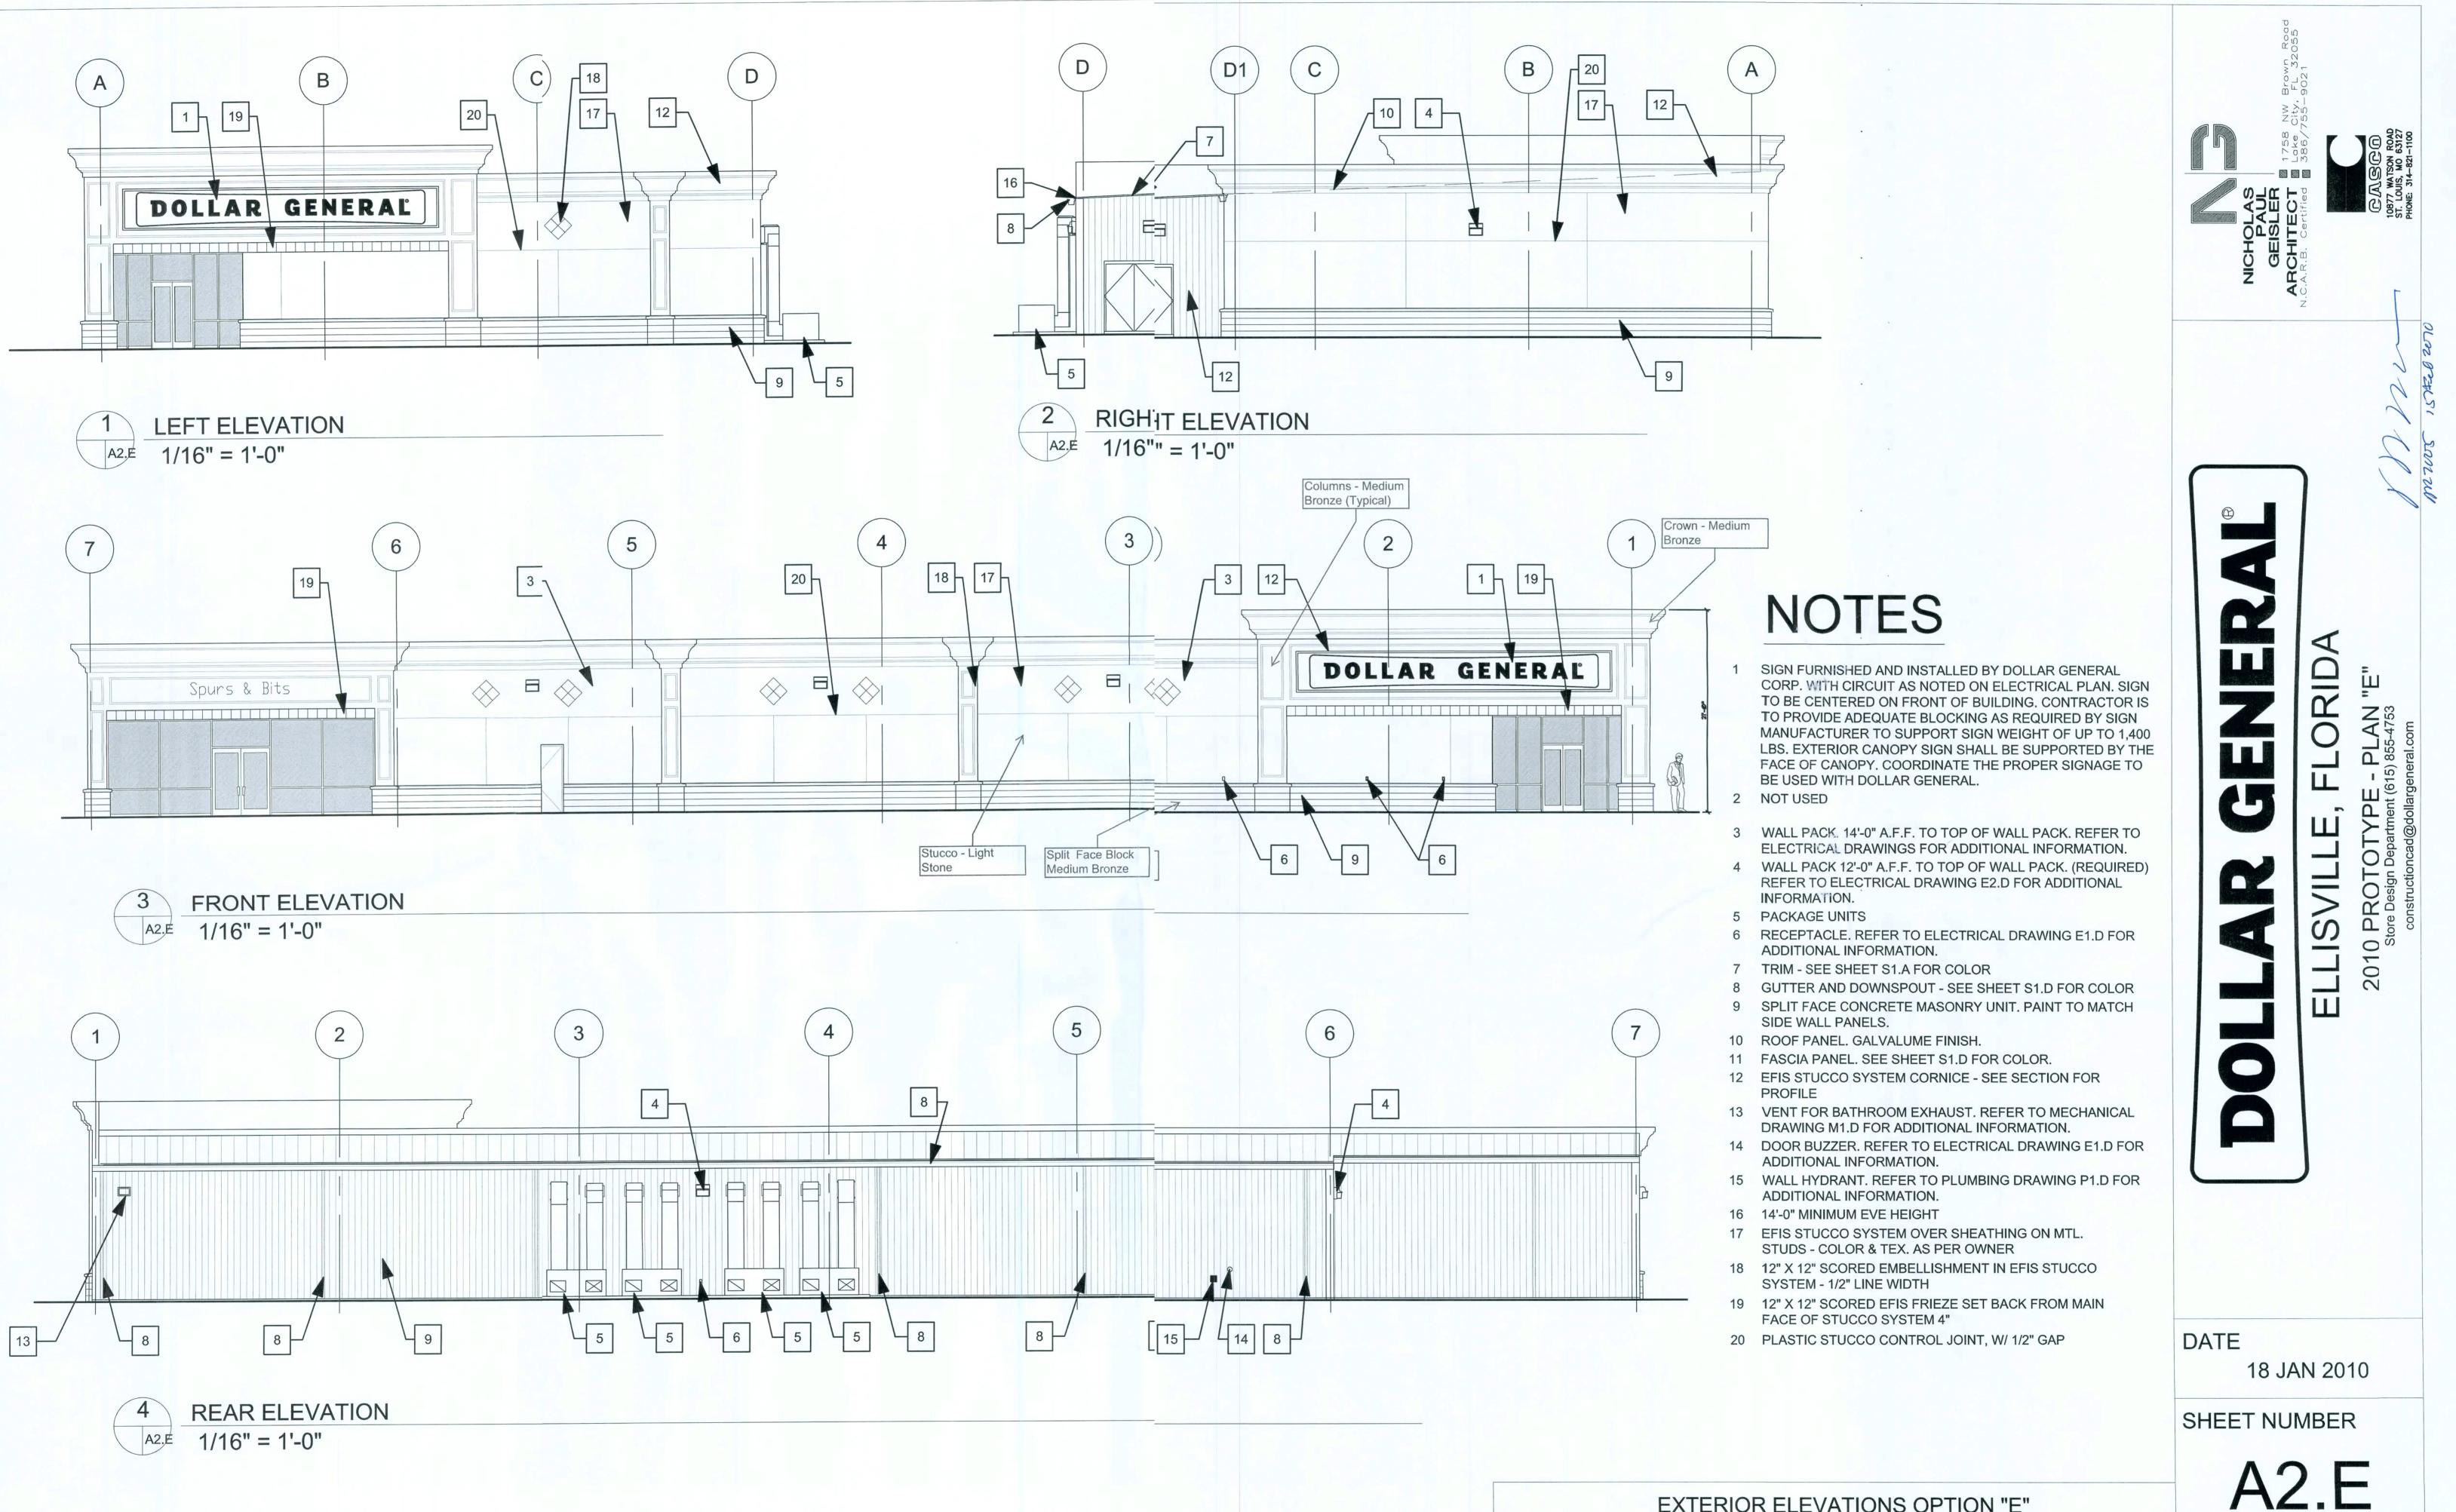

EXTERIOR ELEVATIONS OPTION "E"

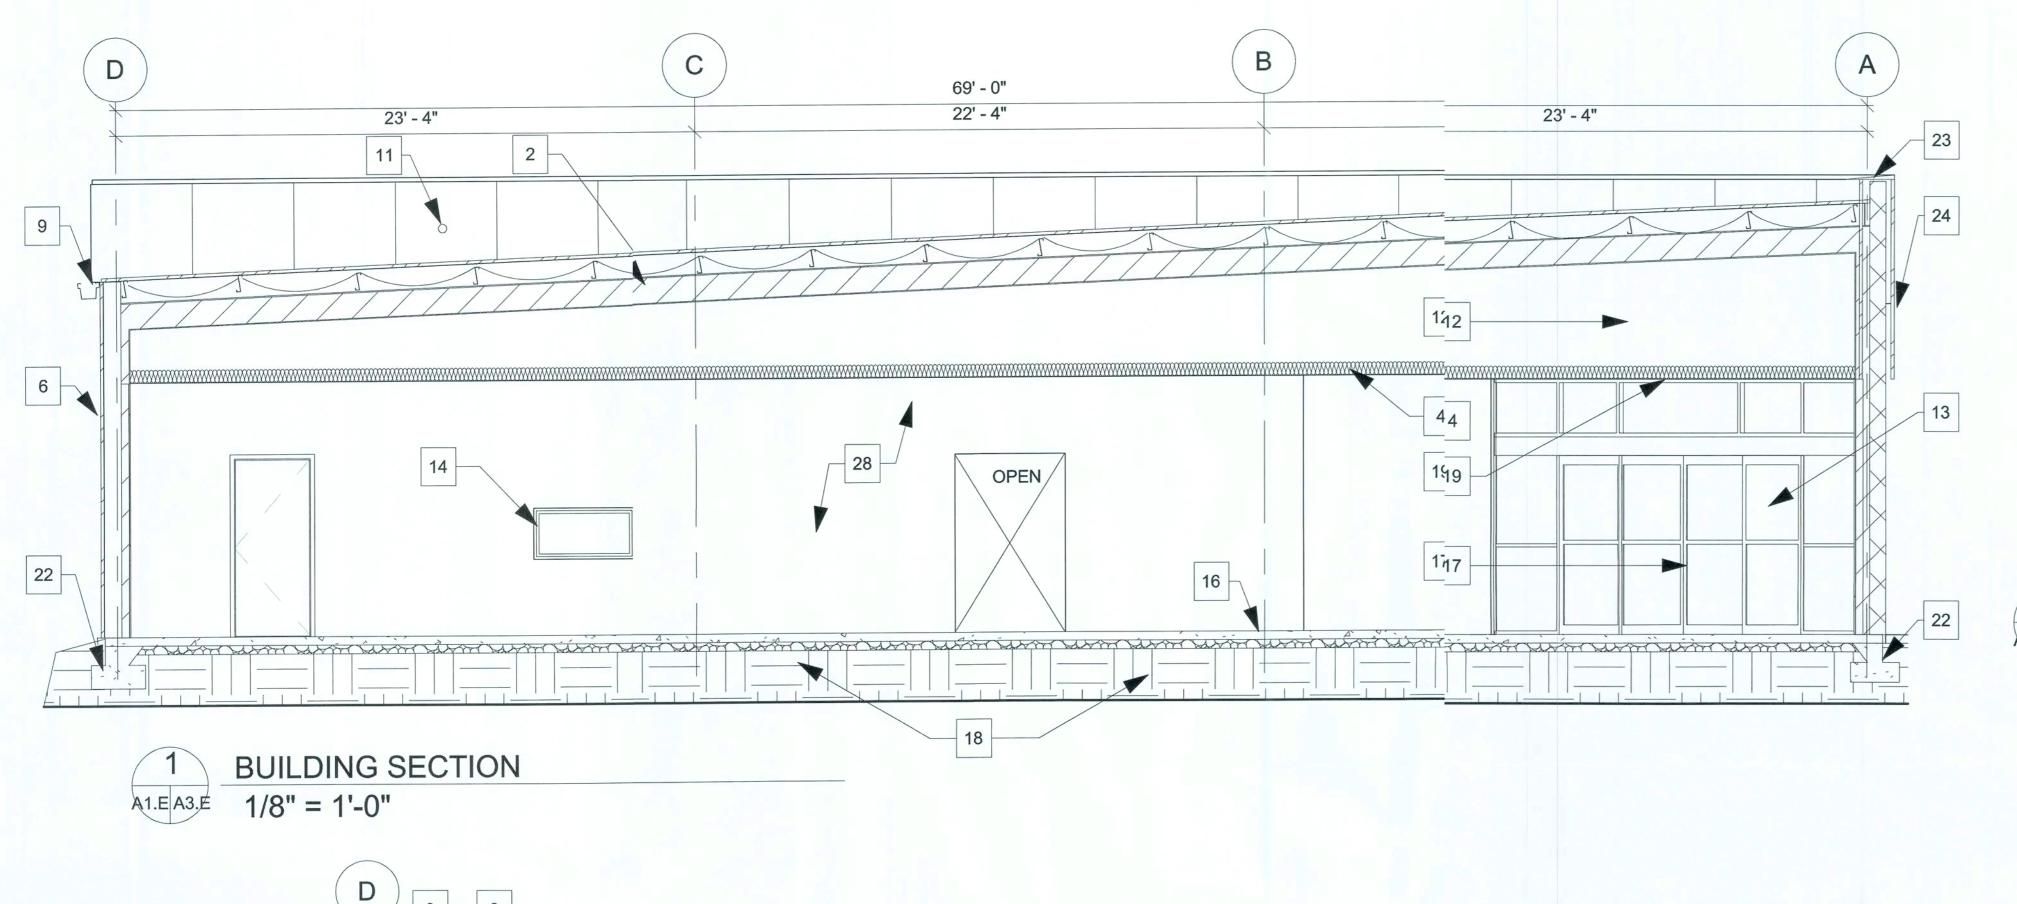


ALIGN FACE OF STUDS WITH COLUMN TYP.

AT EXTERIOR WALL. PROVIDE 5/8" GYP. BD.

TO 6" A.F.C. AND INFILL WITH R-11 BATT

INSULATION WITH VAPOR BARRIOR.

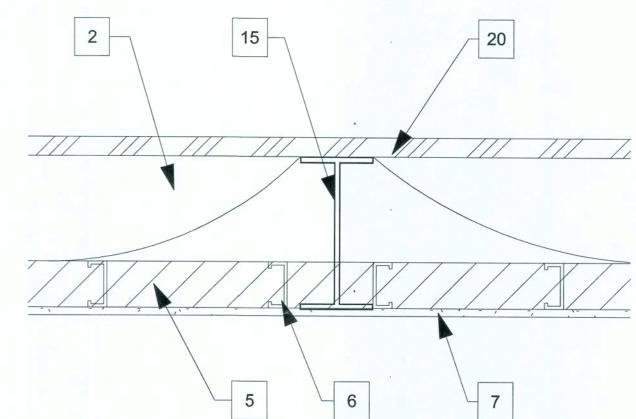

2 A1.E A3.E DETAIL @ COLUMN 3/4" = 1'-0"

# **KEYED NOTES**

- PRE-ENGINEERED METAL BUILDING SYSTEM BY BUILDING MANUFACTURER.
- 2 VINYL FACED R19 BATT INSULATION
- 3 METAL ROOF GALVALUME
- 4 R19 BATT INSULATION (OPTIONAL)
- 5 R-11 BATT INSULATION
- 6 METAL STUDS @ 16" O.C. FLUSH W/ FACE OF COLUMN
- GYPSUM BOARD
- 8 ACOUSTICAL DROP CEILING @10'-0" A.F.F.
- 9 PREFINISHED DOWNSPOUT & GUTTER
- 10 PROVIDE METAL CLOSURE, SEAL, AND CAULK TO RODENT PROOF BUILDING
- 11 LOCATION OF 1" CONDUIT WITH PULLSTRING
  (ABOVE OFFICE) FOR SATELLITE LINE. PROVIDE
  WEATHER TIGHT SEAL AT PARAPET
  PENETRATION. CONTRACTOR RESPONSIBLE FOR
  INSTALLATION OF CONDUIT
- 12 SHEET ROCK TO DECK AT THE STOREFRONT ENTRY TYP.
- 13 ALUM. STOREFRONT 2" TYP. WITH BRONZE FINISH
- 4 2'x4' WINDOW WITH ONE WAY GLASS.
- METAL BUILDING COLUMNS SHALL BE STRAIGHT.
   TAPERED COLUMNS & INTERIOR COLUMNS
   REQUIRE WRITTEN APPROVAL. MAINTAIN
   INTERIOR CLEARANCE OF 68' 1 1/2" BETWEEN
   FACE OF COLUMNS ON SALES FLOOR.
   REIN. CONC. SLAB ON VINYL VAPOR BARRIER
- 17 STANLEY DURAGLIDE 2000 BIPART DOOR AND
- GLAZING SYSTEM

  18 UNDISTURBED EARTH AND COMPACTED SUB
- GRADE
- 9 SOFFIT PROVIDED BY PRE-ENGINEERED BUILDING MANUFACTURER
- 20 PRE-FINISHED METAL WALL PANELS
- 21 GRANULAR FILL
- 22 REINF. CONCRETE FOOTING
- 23 PREFINISHED METAL COPING
- EXTERIOR SIGNAGE
- 25 FINISH GRADE SEE CIVIL DRAWINGS
- INTERIOR WALL PAINTED SEE ROOM SCHEDULE FOR MORE INFORMATION

ОТУР

2010

DATE

18 JAN 2010

SHEET NUMBER

A3.E

3 A1.E A3.E WALL SECTION 1/4" = 1'-0"

9

10

25

22

SECTIONS AND DETAILS OPTION "E"

|     |                | V-11-                      |  |                           |          |  |   | ROOM   | SCHEDULE   |                                  |  |  |                                |                                   |                          |   |
|-----|----------------|----------------------------|--|---------------------------|----------|--|---|--|--|----------------------------------|--|--|--------------------------------|-----------------------------------|--------------------------|---|
|     |                | FLO                        | OR   | BA                        | S.       | А  | WALL  | В  | WALL   |                                  | CWALL  | D  | WALL                           | CEILING                           | CEILING                  |   |
| NO  | ROOM NAME      | MATERIAL                   | FINISH   | MATERIAL                  | . FINISH | MATERIAL   | FINISH  | MATERIAL   | FINISH   | MATERIAL                         | FINISH   | MATERIAL   | FINISH                         | MATERIAL                          | FINISH                   | REMARKS   |
|     | BREAK ROOM     | CONCRETE FLOOR<br>SEALED   | RETROPLATE 99<br>SEALER                                | 4" RUBBER /<br>VINYL BASE | LACK     | GYPSUM BOARD                                       | SHERWIN WILLIAMS PAINT ANTIQUE WHITE, LATEX SEMI GLOSS PRODUCT #B31W404 | GYPSUM BOARD                                       | SHERWIN WILLIAMS 3 PAINT ANTIQUE WHI'ITE, LATEX SEMI GLOSS 3 PRODUCT #B31W404)4        | GYPSUM BOARD                     | SHERWIN WILLIAMS PAINT<br>ANTIQUE WHITE, LATEX<br>SEMI GLOSS PRODUCT<br>#B31W404 | GYPSUM BOARD                                       |                                | 2' X 4'<br>ACCOUSTICAL<br>CEILING | WHITE @ 8'-0"<br>A.F.F.  | FINISH ALL WALLS<br>TO 6" ABOVE<br>FINISHED CEILING |
| 101 | OFFICE         | CONCRETE FLOOR<br>SEALED   | RETROPLATE 99<br>SEALER                                | 4" RUBBER /<br>VINYL BASE | LACK     | GYPSUM BOARD                                       | SHERWIN WILLIAMS PAINT ANTIQUE WHITE, LATEX SEMI GLOSS PRODUCT #B31W404 | GYPSUM BOARD                                       | SHERWIN WILLIAMS 3 PAINT ANTIQUE WHITE, LATEX SEMI GLOSS 3 PRODUCT #B31W404)4          | GYPSUM BOARD                     | SHERWIN WILLIAMS PAINT<br>ANTIQUE WHITE, LATEX<br>SEMI GLOSS PRODUCT<br>#B31W404 | GYPSUM BOARD                                       | PAINT ANTIQUE WHITE,           | 2' X 4'<br>ACCOUSTICAL<br>CEILING | WHITE @ 8'-0"<br>A.F.F.  | FINISH ALL WALLS<br>TO 6" ABOVE<br>FINISHED CEILING |
| 102 | SALES AREA     | CONCRETE FLOOR<br>POLISHED | RETROPLATE POLISHED CONCRETE WITH RETROPLATE 99 SEALER | 4" RUBBER /<br>VINYL BASE | LACK     | 011 00111 - 0111                                   | SHERWIN WILLIAMS PAINT ANTIQUE WHITE, LATEX SEMI GLOSS PRODUCT #B31W404 | GYPSUM BOARD<br>TO ROOF DECK                       | SHERWIN WILLIAMS S<br>PAINT ANTIQUE WHITE,<br>LATEX SEMI GLOSS ;<br>PRODUCT #B31W404)4 | GYPSUM BOARD<br>TO 10'-0" A.F.F. | SHERWIN WILLIAMS PAINT<br>ANTIQUE WHITE, LATEX<br>SEMI GLOSS PRODUCT<br>#B31W404 | GYPSUM BOARD<br>TO 10'-0"                          | PAINT ANTIQUE WHITE,           | 2' X 4'<br>ACCOUSTICAL<br>CEILING | WHITE @<br>10'-0" A.F.F. | FINISH ALL<br>WALLS TO THE<br>ROOF DECK             |
| 103 | RECEIVING AREA | CONCRETE FLOOR<br>SEALED   |  | N/A                       | /A       | METAL LINER<br>PANEL                               |   | METAL LINER<br>PANEL                               | LIGHT STONE  | METAL LINER<br>PANEL             | LIGHT STONE  | GYPSUM BOARD                                       |                                | EXPOSED TO<br>STRUCTURE<br>ABOVE  | N/A                      | FINISH ALL<br>WALLS TO THE<br>ROOF DECK             |
| 104 | MENS           | CONCRETE FLOOR<br>SEALED   | RETROPLATE 99<br>SEALER                                | 4" RUBBER /<br>VINYL BASE | LACK     | GYPSUM BOARD/<br>FIBERGLASS<br>REINFORCED<br>PANEL | FIBERGLASS<br>REINFORCED PANEL  | GYPSUM BOARD/<br>FIBERGLASS<br>REINFORCED<br>PANEL | FIBERGLASS REINFORCED PANEL  |                                  | FIBERGLASS REINFORCED<br>PANEL   | GYPSUM BOARDA<br>FIBERGLASS<br>REINFORCED<br>PANEL | FIBERGLASS<br>REINFORCED PANEL | 2' X 4'<br>ACCOUSTICAL<br>CEILING | WHITE @ 8'-0"<br>A.F.F.  | FINISH ALL WALLS<br>TO 6" ABOVE<br>FINISHED CEILING |
| 105 | WOMEN          | CONCRETE FLOOR<br>SEALED   | RETROPLATE 99<br>SEALER                                | 4" RUBBER /<br>VINYL BASE | LACK     | GYPSUM BOARD/<br>FIBERGLASS<br>REINFORCED<br>PANEL | FIBERGLASS<br>REINFORCED PANEL  | GYPSUM BOARD/<br>FIBERGLASS<br>REINFORCED<br>PANEL | FIBERGLASS REINFORCED PANEL_L  |                                  | FIBERGLASS REINFORCED<br>PANEL   | GYPSUM BOARD<br>FIBERGLASS<br>REINFORCED<br>PANEL  | FIBERGLASS<br>REINFORCED PANEL |                                   | WHITE @ 8'-0"<br>A.F.F.  | FINISH ALL WALLS<br>TO 6" ABOVE<br>FINISHED CEILING |

| DOOK SCHEDULE | <b>DOOR</b> | SCHEDULE |
|---------------|-------------|----------|
|---------------|-------------|----------|

|     |      |             | DOOF      | 3           |   |   |
|-----|------|-------------|-----------|-------------|---|---|
| 10. | Type | WIDTH       | HEIGHT    | THICKNESS   | DOOR HARDWARE   | REMARKS   |
| 100 | A    | 3' - 0"     | 7' - 0"   | 0' - 1 3/4" | LEVER: DOOR HANDLIFALCON PASSAGE MODEL #E101S-DANE-626 (NO KEY REQ'D), DOOR CLOSER: "DOR "O" MATIC MODEL #SC94-AL, WALL STOPTACO DOOR VIEWER MODEL #TA3310PC  | SOLID CORE WOOD DOOR OR HOLLOW CORE METAL DOOR PAINTED TO MATCH THE WALL SURFACE.                             |
| 01  | Α    | 3' - 0"     | 7' - 0"   | 0' - 1 3/4" | LEVER: DOOR HANDLFALCON STOREROOM MODEL #W581PD-DANE-626 (KEY #1), DOOR CLOSER: DOR "O" MATIC MODEL #SC94-AL, WALL STOP, TACO DOR VIEWER MODEL #TA3310PC  | SOLID WOOD DOOR OR HOLLOW CORE METAL DOOR PAINTED TO MATCH THE WALL SURFACE.                                  |
| 02  | С    | 3' - 0"     | 7' - 0"   | 0' - 1 3/4" | DOOR CLOSER: DOR "" MATIC MODEL #SC94-AL, PANIC HARDWARE: VON DUPRIN GUARD X LOCK MODEL #2670-US28 3  | FIRE RATED DOORS, SOLID CORE WOOD DOOR OR HOLLOW CORE METAL DOOR PAINTED TO MATCH THE CORRESPONDING SURFACES. |
| 3A  | В    | 6' - 0"     | 7' - 0"   | 0' - 1 3/4" | PULL HANDLE, 8" KICKLATE, DOOR CLOSER: DOR "O" MATIC MODEL #SC94-AL, PUSH PLATE, 4" KICK DOWN DOOR STC-OP   | FIRE RATED DOORS, SOLID CORE WOOD DOOR OR HOLLOW METAL DOOR PAINTED TO MATCH THE WALL SURFACE.                |
| 3B  | D    | 6' - 0"     | 7' - 0"   | 0' - 1 3/4" | PANIC HARDWARE: VQ DUPRIN GUARD X LOCK MODEL #2670-US28, DETEX: DOUBLE DOOR HOLDER MODEL #DDH-22550 TOP & BOTTOM, DOOR CLOSR: DOR "O" MATIC MODEL #SC94-AL, PULL HANDLE, 2" DOOR SCOPE: MODEL #DS 1000MB, 8" KICCK DOWN DOOR STOP MODEL #612Z FDM BASS SECURITIES HD LOW PROFILE HC THRESHOLD, 1/2" MAX. WITH SMOOTH TRANSITION I | PAINTED TO MATCH THE CORRESPONDING SURFACES.  |
| 4   | Α    | 3' - 0"     | 7' - 0"   | 0' - 1 3/4" | LEVER: DOOR HANDLFALCON STOREROOM MODEL #W581PD-DANE-626 (KEY #2), DOOR CLOSER: DOR "O" MATIC MODEL #SC94-AL, WALL STOP   | SOLID CORE WOOD DOOR OR HOLLOW CORE METAL DOOR PAINTED TO MATCH THE WALL SURFACE.                             |
| 05  | А    | 3' - 0"     | 7' - 0"   |             | LEVER: DOOR HANDLFALCON STROEROOM MODEL #W581PD-DANE-626 (KEY #2), DOOR CLOSER: DOR "O" MATIC MODEL #SC94-AL, WALL STOP   | SOLID CORE WOOD DOOR OR HOLLOW CORE METAL DOOR PAINTED TO MATCH THE WALL SURFACE.                             |
| 06  | Е    | . 6' - 0" . | 7' - 0" . |             | BY DOOR MANUFACTRER TO BE RE-KEYED BY DOLLAR GENERAL AREA MANAGER W/ INSTA-KEY LOCKING CYLINDER R   | STANLEY DURA-GLIDE SERIES 2000 21'-0" BI-PART WITH TRANSOM AND GLASS. BRONZE FINISH                           |

| COMPANY                              | CONTACTS  | PHONE #                     | REQUIRED ITEMS  |
|--------------------------------------|---|-----------------------------|---|
|                                      | NATIONAL ACCOUNT SALES                            | 888-774-3400                | DOOR HARDWARE AND RESTROOM                                    |
| BASS SECURITY SERVICES, INC.         |   | EXT. 2022                   | ACCESSORIES   |
| MC CUE CORPORATION                   | DENISE CURRMAN                                    | 800-800-8503                | CART BUMPERS AND CORNER GUARDS                                |
|                                      |   | EXT. 290                    | PART# 9014 TRIMKIT  |
| LENNOX                               | JOSHUA PLUMMER                                    | 800-367-6285 OPT. 2         | HVAC UNITS (LOW GAS) KGA060S4B-DG / (ELECTRIC) KCA06630S4B-DG |
| CARRIER                              | ALISON HARTMAN                                    | 800-690-1081                | HVAC UNITS (HIGH GAS) 48TCFA06A1A3A0A0A0A1-DG                 |
| SHERWIN WILLIAMS                     | LOCAL SHERWIN WILLIAMS STORE                      |                             | PAINT, PRIMER, CONCRETE SEALER AND BLOCK FILLER               |
| STANLEY DOORS                        | ART BULLMAN                                       | 636-391-1508                | AUTOMATIC DOORS AND STORE FRONT                               |
|                                      | RYAN DRISCOLL                                     | 800-648-1401 OPT. 2, EXT. 6 | GLAZING SYSTEM  |
| D&P CUSTOM LIGHTING                  | NATIONAL ACCOUNT SALES                            | 800-251-2200                | CUSTOM POWER POLES  |
| EMERSON CLIMATE TECHNOLOGIES         | PETE STEVENS                                      | 770-425-2724                | EMS SUPPLIER  |
| RETROPLATE SYSTEMS                   | LEO HENDERSON general-dollar@retroplatesystem.com | 888-942-3144                | CONCRETE POLISHING SYSTEMS                                    |
| CONSOLIDATED ELECTRICAL DISTRIBUTORS | ROBERT DECKER                                     | 270-781-2229                | ELECTRICAL, LIGHTING SUPPLIES                                 |

| COMPANY                  | CONTACTS      | PHONE #      | REQUIRED ITEMS                |
|--------------------------|---------------|--------------|-------------------------------|
| LIBERTY BUILDING SYSTEMS | DAVID ENGLISH | 877-505-4596 | PRE-ENGINEERED METAL BUILDING |
| STAR BUILDING SYSTEMS    | JEFF HORN     | 866-664-8899 | PRE-ENGINEERED METAL BUILDING |
| NUCOR BUILDING SYSTEMS   | TY DAVENPORT  | 803-799-9708 | PRE-ENGINEERED METAL BUILDING |
| CASCO                    | JOHN HARRIS   | 314-821-1100 | PROFESSIONAL SERVICES         |

WALL WALL WALL WALL OF THE PROPERTY OF THE PRO

SCHEDULES OPTION "E"





DATE

18 JAN 2010

SHEET NUMBER

A4.E

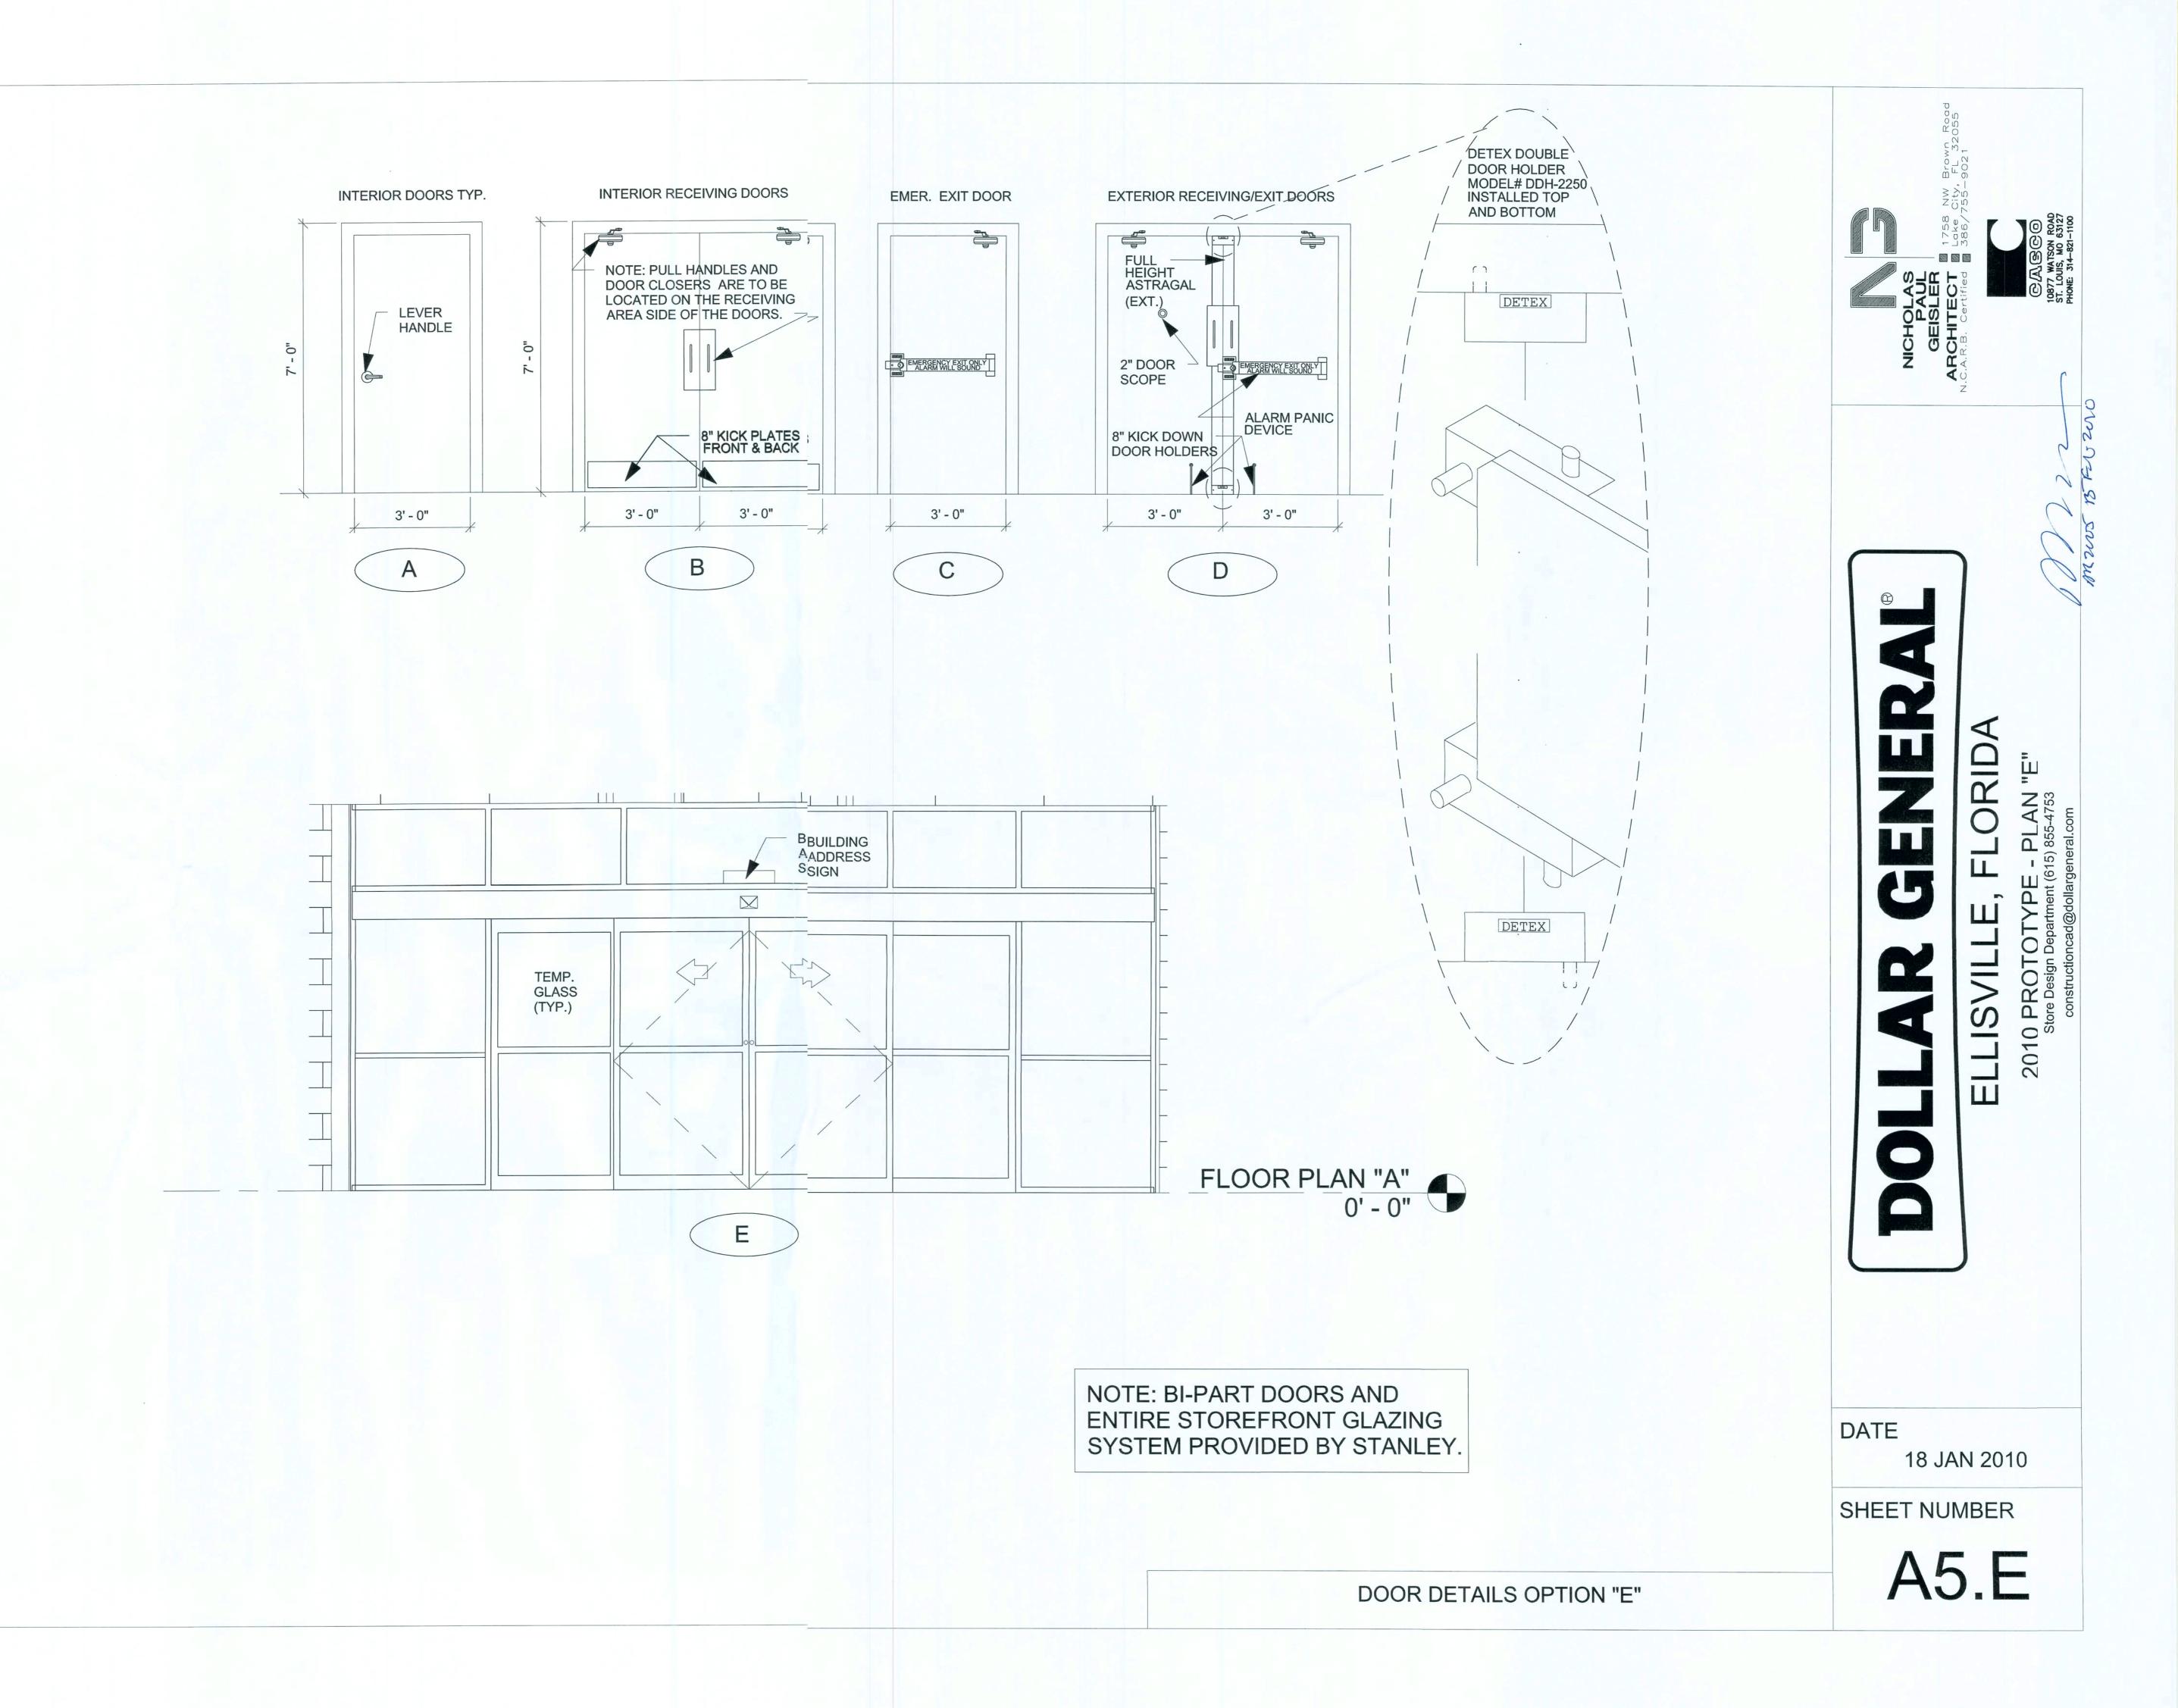

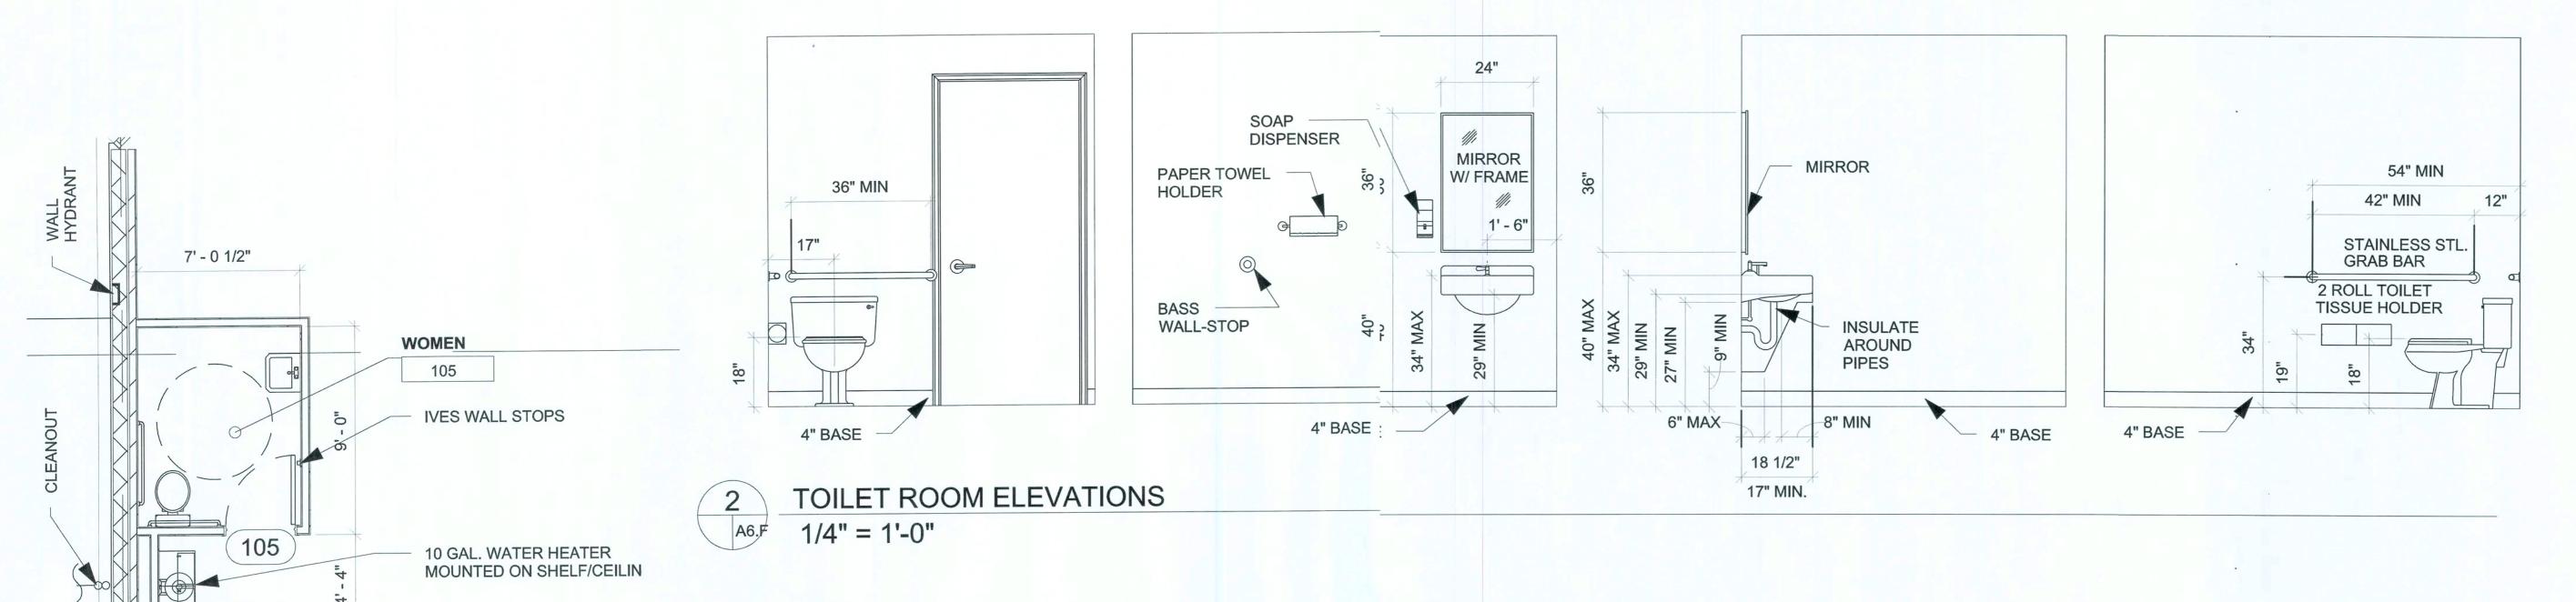

48" MIN

CLEAR FLOOR SPACE

**GRAB BAR DETAIL** 

3" = 1'-0"

| BASS              | SECURITY PARTS                        |
|-------------------|---------------------------------------|
| 402-1/2B-26D      | IVES WALL STOP                        |
| 54-US32D          | BURNS PUSḤ PLATE                      |
| 8400-S32D-10X34   | IVES KICK PLATE                       |
| 5410-32D-26D-GRIP | BURNS PULL PLATE                      |
| W101S-DANE-626    | FALCON PASSAGE LEVERSET               |
| W581PD-DANE-626   | FALCON STOREROOM LEVERSET             |
| 2670-28           | VON DUPRIN GUARD X EXIT ALARM LOCK    |
| 7015SC8-26D       | IICO RIM CYLINDER                     |
| 2609 **           | VON DUPRIN GUARD-X DOUBLE DOOR STRIKE |
| DDH-2250 **       | DETEX DOUBLE DOOR HOLDER              |
| SC94-AL           | DOOR O MATIC CLOSER                   |
| TA3310PC          | TACO DOOR VIEWER                      |
| DS/1000MB         | DOOR SCOPE                            |
| 452B26D-4         | IVES 4" DOOR HOLDER                   |
| 608Z-6122         | 8" DOOR HOLDER                        |
| B155              | BOBRICK 24 OZ. SOAP DISPENSER         |
| B165-2436         | BOBRICK STAINLESS MIRROR              |
| B7686             | INTERDESIGN TOILET TISSUE HOLDER      |
| B253              | BOBRICK PAPER TOWEL HOLDER            |
| B6806-36"         | BOBRICK 36" GRAB BAR                  |
| B6806-42"         | BOBRICK 42" GRAB BAR                  |

|                 | 105            | — 10 GAL. WATER HEATER<br>MOUNTED ON SHELF/CEILIN  | 1/4 - 1-0  |
|-----------------|----------------|--|--|
|                 | 104            | - IVES WALL STOPS  | 48" MAX  |
| L STOPS         | 06             | MENS<br>104  | CLEAR FLOOR SPACE FOR LAVATORY FIXTURE  NIW "54" |
| IVES WALL STOPS |                | OFFICE<br>101  |  |
|                 | 2'-61/2" 4'-0" | CONTRACTOR SHALL LEAVEAN AS-BUILT SET OF CONSTRUCTION PLANS, ROLLED UP AND PLACED INIDE A 4" X 36" PVC PIPE WHICH I MOUNTED HORIZONTALLY TO THE WALL ABOVE THE DOO, INSIDE THE OFFICE. | 3 A.D.A. CLEARANCES<br>1/4" = 1'-0"              |
|                 | 94 1/2"        | 100  |  |
|                 | 100            |  | 1 1/2" 1 1/2"                                    |
|                 | 4'-0"          |  | 34" A.F.F.                                       |
|                 | 7' - 0 1/2"    |  |  |

RESTROOM/OFFICE PLAN

1/8" = 1'-0"

| REST | FROOMS |
|------|--------|
|      |        |

1. ALL STORRES MUST INCLUDE 2 REST ROOMS, EVEN WHEN NOT REQUIRED BY CODE. ANY VARIATION MUST BE APPROVEDD, IN WRITING, BY THE DOLLAR GENERAL CONSTRUCCTION AUTOCAD DEPARTMENT.

2. REST RODOMS MUST COMPLY WITH ALL BUILDING (FEDERAL, STATE, AND LOCAL) FIRE, AND HEALTH DEPARTMENT CODES. ADA REQUII/IREMENTS MUST ALSO BE MET IN BOTH RESTROOMMS. SOME CODES MAY REQUIRE ADDITIONAL TOILETS OF LAVATORIES. PLEASE CONTACT DOLLAR GENERAL CONSTRUCTION AUTOCAD DEPARTMENT FOR ALTERNATE PLANS FOR THESE SITUATIONS.

3. PROVIDE AND INSTALL 3' X 2' MIRROR (OR LARGER IF REQUIRED BY CODE) IN REST ROOMS ABOVE LAVATORY.

4. CONTRACTOR TO INSTALL SOAP DISPENSERS, TOILET PAPER HOLDERS, DOOR CLOSERS, DOOR HOLDERS, EXHAUST FANS, AND ALL BASS SECURITY PARTS IN BOTH RESTROOMS.

DATE

18 JAN 2010

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A6.E

TOILET PLAN & DETAILS OPTION "E"

#### STANDARD SIGN SPECIFICATIOS

| BOX SIGNS      |                      |           |  |  |  |
|----------------|----------------------|-----------|--|--|--|
| SIZE           | AMPS / WATTS         | WEIGHT    |  |  |  |
| 3' × 23'       | 2.5 AMPS / 292 WATTS | 485 LBS.  |  |  |  |
| 3'-9" × 26'    | 5.0 AMPS / 584 WATTS | 695 LBS.  |  |  |  |
| 4'-6" × 33'-3" | X AMPS / X WATTS     | X LBS.    |  |  |  |
| 5' × 40'       | 10 AMPS / 1168 WATTS | 1400 LBS. |  |  |  |
| 1' × 4'        | 0.70 AMPS / 65 WATTS | 30 LBS.   |  |  |  |

## INDIVIDUAL LETTERS

| 0175        | WARM CLIMATE AMPS | WEIGHT    |
|-------------|-------------------|-----------|
| SIZE        | COLD CLIMATE AMPS | VVLIOITI  |
| 104 1 700   | 30MA - 7.88 AMPS  | 210 LBS.  |
| 18" LTRS.   | 60MA - 15.75 AMPS | CIU LDS.  |
|             | 30MA - 7.88 AMPS  | 0.45 + 70 |
| 24" LTRS.   | 60MA - 15.75 AMPS | 245 LBS.  |
|             | 30MA - 9.75 AMPS  | 330 LBS   |
| 30" LTRS.   | 60MA - 19.00 AMPS | 330 LBS,  |
|             | 30MA - 12.00 AMPS | 400 L DS  |
| 36" LTRS. — | 60MA - 24.00 AMPS | 400 LBS.  |

|          | PYLON SIGNS          |          |
|----------|----------------------|----------|
| SIZE     | AMPS / WATTS         | WEIGHT   |
| 4' × 8'  | 1.7 AMPS / 198 WATTS | 250 LBS. |
| 5' × 10' | 3.4 AMPS / 396 WATTS | 389 LBS. |
| 6' × 16' | 5.0 AMPS / 584 WATTS | 750 LBS. |

# SIGN SPECIFICATIONS

- 1. BUILDING SIGNS: PROVIDE CONDUIT FROM ELECTRAL PANEL TO THE CENTER OF THE SIGN CANOPY. THE CONDUIT TO BE 1" AND HAVE ONE SET OF 10/2 WIRE WITH GROUND AND £0-AMP BREAKER AT THE PANEL. BUILDING CANOPY MUST BE SUFFICIENTLY BUILT TO SUPPORT THE DOLLAR GENERL SIGN OF UP TO 1400 LBS. NOTE: IF THE LEASE SPECIFIES A 5)" X 40'-0" BUILDING SIGN OR 24" LETTER SET (OR LARGER); qty.-10/2 WIRE WITH GROUND AND 2 qty. 20 AMP CIRCUITS REQUIRED.
- 2. PYLON SIGNS: PROVIDE CONDUIT FROM ELECTRIC\_ PANEL TO LOCATION OF THE PYLON SIGN BASE. BURY CONDUIT NDER PARKING AREA. THE CONDUIT IS TO BE 1" AND HAVE CE SET OF 10/2 WIRE WITH GROUND AND A 20-AMP BREAKER A THE PANEL.
- 3. FINAL ELECTRICAL CONNECTIONS FOR SIGN SHALBE THE OWNERS RESPONSIBILITY AFTER SIGNS ARE INSTALLE.
- 4. SEE CHART ABOVE FOR SIGN SPEC'S.
- 5. SEE SHEET A8.A FOR SIGN BRACING DETAILS.

33'-0"

# DOLLAR GENERAL

BUILDING DISTANCE FROM STREET: 275' AND ABOVE



THIS SIGN IS TO BE PROVIDED AND INSTALLED BY THE DEVELOPER OR CONTRACTOR AT THE BEGINNING OF CONSTRUCTION PROJECT.



OLLAR GENERAL ELLISVILLE, FLORIDA

2010 PROT Store Design E

DATE

18 JAN 2010

SHEET NUMBER


A7.E

|   | PEMB        | LIBRTY BUILDI | NG SYSTEN  | //S        |        | STAF      | BUILDING   | SYSTEMS  | i        |        | NUC      | OR BUILDI  | NG SYSTE | EMS       |        |
|---|-------------|---------------|------------|------------|--------|-----------|------------|----------|----------|--------|----------|------------|----------|-----------|--------|
|   | VENDOR      | AT1: DAVID EN | IGLISH 8   | 77-505-459 | 06     | ATTN      | I: JEFF HC | RN       | 866-664  | 1-8899 | ATT      | N: TY DAVE | ENPORT   | 1-803-79  | 9-9708 |
| EXTERIOR FINISHES   |             | HED SLATE,    |            |            |        | WEDIUM BE | OO TONZE   |          | WHITE    |        |          | BRONZE     |          | HITE ALL  |        |
| EXTERIOR FINISHES ARE TO MATCH OR BE EQUAL TO LIBERTY METAL BUILDING SYSTEM'S FINISH SELECTION  | LIGHT STONE | APINAR 500    | POLAR WELL | GALVALL.   | ALMOND | KNAPUN    | BROWZE     | PO(4P/W) | GALVALUM | ALMOND | MEDIUM   | BROWZE     | SNOWW    | SALVALLIA |        |
| GUTTERS   | 0           |               |            |            | 0      |           |            |          |          | 0      |          |            |          |           |        |
| DOWN SPOUTS   | 0           |               |            |            | 0      |           |            |          |          | 0      |          |            |          |           |        |
| SIDE AND REAR METAL WALL PANELS<br>RECEIVING & EMER. EXIT DOORS   | 0           |               |            |            | 0      |           |            |          |          | 0      |          |            |          |           |        |
| ARCHITECTURAL BLOCK AT BUILDING FACADE SHOULD BE PRE FINISHED OR PAINTED (2 COATS - LOXON XP MASONRY COATING A24W400 SERIES) TO MATCH THE WALL MTL. PANEL | 0           |               |            |            | 0      |           |            |          |          | 0      |          |            |          |           |        |
| FLAT METAL SOFFIT AT STOREFRONT<br>VESTIBULE  |             |               | 0          |            |        |           |            | 0        |          |        |          |            | 0        |           |        |
| BUILDING CANOPY   |             | 0             |            |            |        | 0         |            |          |          |        |          |            |          |           |        |
| STANLEY STOREFRONT SYSTEM   |             | 0             |            |            |        |           | 0          |          |          |        | <u> </u> | 0          |          |           |        |
| ROOF  |             |               |            | 0          |        |           |            |          | 0        |        |          |            |          | 0         |        |

#### PHONE # CONTCTS COMPANY PRE-ENGINEERED METAL BUILDING 877-505-4596 DAVID ENGLISH LIBERTY BUILDING SYSTEMS PRE-ENGINEERED METAL BUILDING 866-664-8899 JEFF HORN STAR BUILDING SYSTEMS PRE-ENGINEERED METAL BUILDING TY DAVENPORT 803-799-9708 NUCOR BUILDING SYSTEMS PROFESSIONAL SERVICES 314-821-1100 JOHN HARRIS

# NATIONAL ACCOUNT & CONTACT INFORMATION SUBJECT TO CHANGE

OPTIONAL NATIONAL ACCOUNT VENDOR

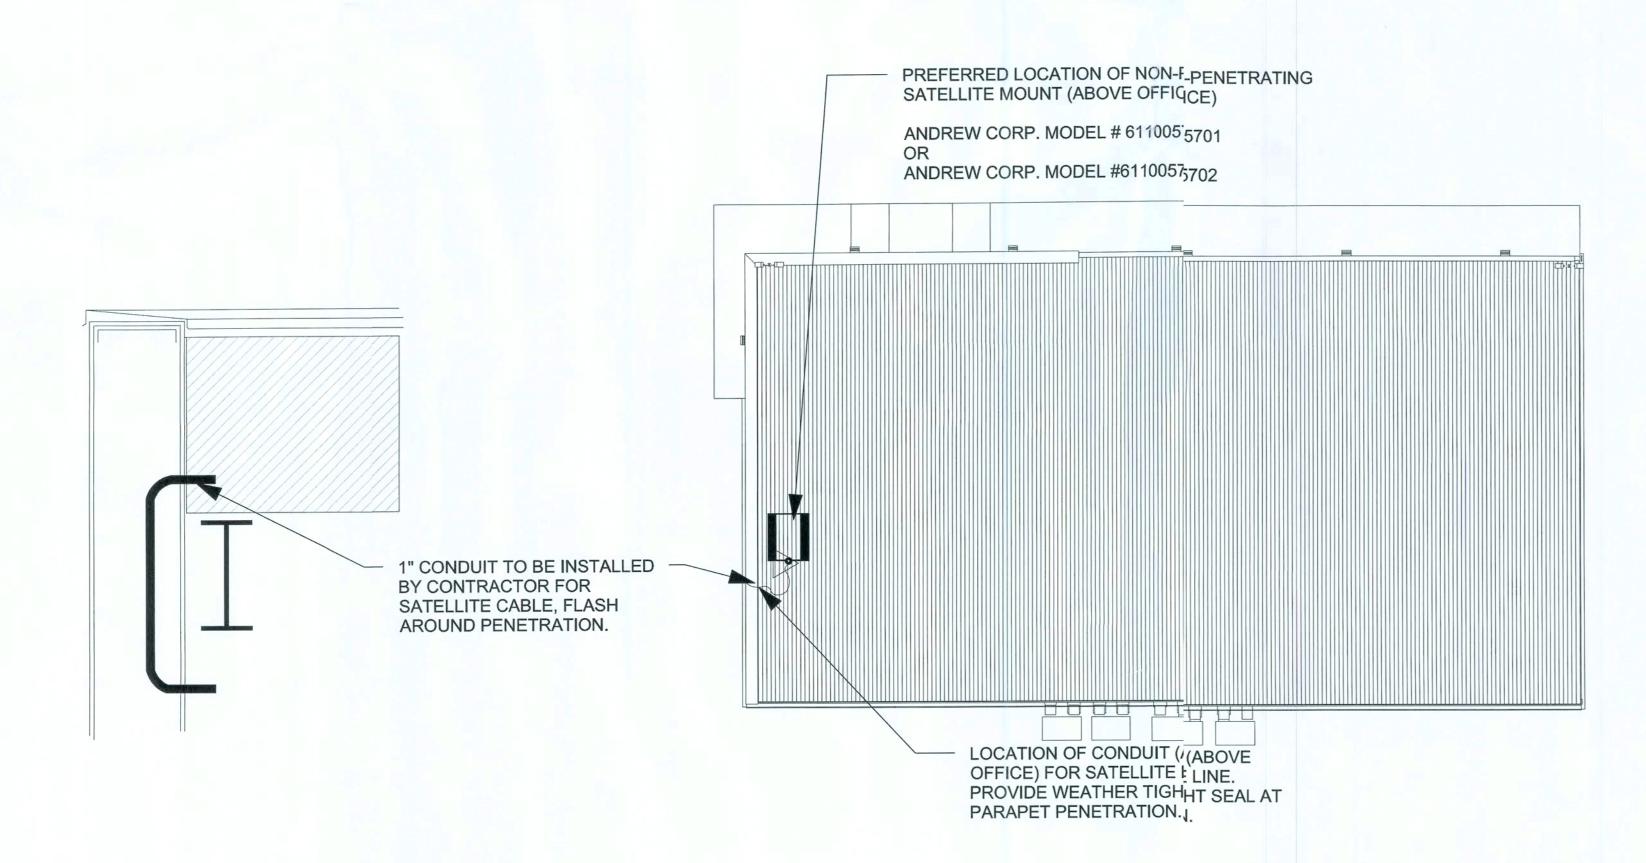

REQUIRED ITEMS

**DETAIL** 1/2" = 1'-0"

SATELLITE LOCATION KEY A5.E S1.E 1/32" = 1'-0"


## STRUCTURAL NOTES:

The pre-manufactured metal building structure, concrete foundation, and interior concrete slab shall be designed, detailed, fabricated, and constructed in accordance with all applicable codes, standards and regulations. The most stringent requirements apply where inconsistencies occur between the Applicable Standards. In the absence of other criteria, loadings shall conform to the 2006 edition of the International Building Code.

The scope of the pre-manufactured metal building structure shall include the design, engineering, fabrication, delivery, and erection of the complete structural steel framing and exterior skin package. The metal building manufacturer shall be certified by American Institute of Steel Construction (AISC) Metal Building Certification Program.

The front fascia shall have (3) 12" perlins (mounted vertically so that the 12" face is against the building metal siding. These perlins shall be centered over the entrance and spaced 96" apart to provide adequate support for signage which may weigh up to 1,400 lbs.

The HVAC pad at the rear of the building is to be constructed of: 5" 3,000 psi concrete on a 4" compacted aggregate base on compacted sub grade. Slab is to have reinforcing as recommended by geotechnical consultant. See note 3 on sheet C4.D.

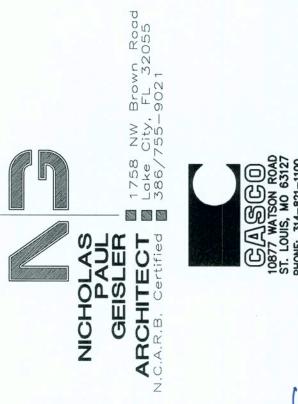



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#### **FLOOR SLAB**

The concrete foundation and interior concrete slab shall be designed, dealed, and constructed to provide the safe and serviceable support of the pre-manuactured metal building structure and all prescribed loads applied thereto and shall confrm to the latest editions of all applicable standards of the American Concrete Institute. Te soil sub-grade shall be prepared in accordance with site specific written recommendations provided by a registered Professional Geotechnical Engineer licensed in the state whee the project is located. In the absence of such recommendations, the soil sub-grade shill be prepared in accordance with the prescriptive requirements of the applicable model bilding code. Maintain 68' 1 1/2" from face of column to face of column width on salesloor.

The concrete foundation and concrete slab construction shall meet the fllowing minimum performance requirements:

- (A) Minimum foundation bearing depths relative to final adjacent grade:
  - (1) Site specific maximum frost penetration.
- (2) Depth required to attain minimum recommended/prescribed seaing pressure.
- (3) Depth required to limit settlement/heave to maximum valuesestalished herein.
- (B) Maximum vertical settlement/heaving of foundation and/or interior cocrete slab over the time span of 25 years:
- (1) 1" total.
- (2) 1/2" differential across a horizontal distance of fifty feet.
- (C) Floor slab thickness shall be a minimum of 4" thick with WWM.
- (1) No fiber reinforced concrete is allowed.
- (D) Interior concrete slab levelness and flatness requirements:
- (1) Levelness factor, 1/8" in 20'-0".

#### POLISHED CONCRETE FLOOR SUMMARY

- A. This section includes the following:
- 1. Grinding & Polishing of Concrete
- 2. Application of Retroplate 99 Densifier
- 3. Application of Retro Guard. 4. Installation of standard gray Polyurea joint fill.
- 5. Mandatory pre slab meeting.

### B. Related Work:

- 1. Section 03300 Cast-In-Place Concrete
- C. CORPORATE ACCOUNT MANAGER: LEO HENDERSON

PH 888-942-3144

EMAIL: LEO@RETROPLATESYSTEM.COM < mailto: LEO@RETROLATESYSTEM.COM >

\*\*\*ALL APPLICATORS ARE TO BE APPROVED IN WRITING ON ADVINCED FLOOR PRODUCTS LETTERHEAD REFERENCING DOLLAR GENERAL.

#### A. Pre-Installation Conference:

- 1. Schedule and conduct pre-installation conference at Project site trestablish guidelines and expectations for scheduling of floor treatment applicationdegree of polish, concrete finish specifications, floor flatness, and similar issues. Ensure tendance at Pre-Installation Conference by at least:
  - A. Dollar General Project Manager
  - B. Flatwork Contractor
  - C. Land lord's representative
  - D. Prime Contractor
  - E. Applicable subcontractors
  - F. Certified applicator

## **B. Product Variations: RetroPlate**

1. The variegated colors and appearance are unique to each concress surface and depend on the chemical composition, mix design, porosity, agetextue and color of the concrete substrate. Mottling and wide variations in color and intensit may occur. If contaminants remain on the surface, the penetration of the RetroPlate my be blocked. Concrete from different loads or ours, and in patched areas, may appea significantly different from adjacent areas, when treated with RetroPlate.

#### C. Fly Ash:

No more than 20% of the weight of the Portland Cement should e substituted with fly ash. If fly ash is to be substituted, Class C is minimum.

#### **QUALITY ASSURANCE**

#### A. Installer Qualifications:

- 1. Use a Dollar General certified installer and adequate number of skilled workman who are approved in writing by the manufacturer for Dollar General projects, NO EXCEPTIONS
- 2. Applicator shall be familiar with the specified requiremnents and the methods needed for proper performance of work of this section. Applicator must have avvailability of proper equipment to perform work within scope of this project on a timely basis. Applicatoor should have successfully performed a minimum of 5 projects of at least 5000 square feet each.

#### B. Manufacturer's Certification:

1. Provide letter of certification from Advanced Floor Products stating that installer is certified for Dollar General Project Not all applicators are approved

#### C. Protection:

- 1. No satisfactory chemical or cleaning procedure is available to remove petroleum stains from the concrete surface. Prevention is therefore essential.
  - A. All Hydraulic powered equipment must be diaper; red to avoid staining of the concrete.
  - B. No trade will park vehicles on the inside slab. If nnecessary to complete their scope of work, drop cloths will be placed under vehicles, at all times
  - C. No pipe cutting machine will be used on the inside floor slab.
  - D. Steel will not be placed on interior slab to avoid rigust staining.
  - E. All equipment must be equipped with non-markinng tires.
  - F. Do not drag or drop equipment or material acrosss the slab which will scratch or chip it.
  - G. Protect the floor from drywall mud splatters.

#### DELIVERY, STORAGE AND HANDLING

A. Deliver materials in original containers, with seals unbrokeen, bearing manufacturer labels indicating brand name and directions for storage.

B. Dispense special concrete finish material from factory nunmbered and sealed containers. Maintain record of container numbers.

#### PROJECT CONDITIONS

- A. Environmental limitations: Comply with manufacturer's wwritten instructions for substrate temperature and moisture content, ambient temperature and humidity, ventilation, and other conditions affecting topping performance.
  - Concrete must have an average Floor Flatness rating of at least 40 +/- 5.
  - 2. Concrete must have an average Floor Levelness ratilting of at least 40 +/- 5.
  - 3. Concrete must be cured a minimum of 28 days or as<sub>s</sub> directed by the manufacturer before application of Retro Plate can begin.
  - 4. Application of Retro-Plate shall take place prior to insstallation of equipment, thus providing a complete, uninhibited concrete slab for application.
  - B. Close areas to traffic during floor application.
- C. The completed Retroplate slab will be covered to preevent damage by the other trades during store completion.
  - D. Land lord will be responsible for providing a dumpsteer for disposal of products.

#### PART 2 - PRODUCTS

## MATERIALS AND MANUFACTURERS

- A. HARDENING/SEALING AGENT (No substitution)
- 1. RetroPlate 99 manufactured by Advanced Floor Produucts, Inc., P.O. Box 50533, Provo, Utah 84605 LEO HENDERSON 801.602.0095 CELL: 888.942.3144:

DOLLAR GENERAL@RETROPLATESYSTEM.COM

#### A. Performance Criteria:

- I. Abrasion Resistance: ASTM C779 Up to 400% in abrasion resistance.
- II. Impact Strength: ASTM C805 Up to 21% increase impact strength.
- III. Ultra Violet Light and Water Spray: ASTM G23-811 No adverse effect to ultra violet and water
- IV. Reflectivity: Up to 30% increase in reflectivity.
- 2. Polyurea joint filler to be used in all control joints. Stanndard grey color. All joints are to be filled at the discretion of the certified installer.
- 3. Retroguard Heavy Duty Stain Inhibitor and Sealer: (Noo substitution)
- 4. Ameripolish "Edge Tint" (Concrete Gray)

#### B. DIAMOND GRINDING AND POLISHING DISCS

Only grinding and polishing discs distributed by Advanced Floor Products are to be used. (No Substitutions).

## RELATED MATERIALS

- A. Water:
- 1. Potable and on site
- B. Temporary power for grinding and polishing equipmennt will be provided by installer.

#### PART 3- EXECUTION

#### SURFACE CONDITIONS:

A. GC or rep. to examine substrate, with installer present, for conditions affecting performance of finish. Correct conditions detrimental to timely and proper work. Do not proceed until unsatisfactory conditions are corrected.

B. GC or rep. to verify that base slab meet finish and surface profile requirements in Division 3 Section

Cast-In-Place Concrete, and Project Conditions above.

C. Prior to application, verify that floor surfaces are free of construction latent's. ONCE

APPLICATOR ACCEPTS THE FLOOR THEY AND THEY ALONE ARE SOLELY RESPONSIBLE FOR THE SPECIFICATIONS TO BE MET.

#### **EQUIPMENT:**

- A. PLANITARY EQUIPMENT ONLY, NO EXCEPTIONS'
- 1. Initial grinding will be done with a machine with Planetary concrete grinding
- It gives the best preliminary scratch pattern needed for a good finished sheen. 2. Machines with at least 32 inch grinding area are required.

#### B. SCOPE OF WORK

The following RetroPlate process must be used. The following process will be used depending on the condition of the slab. Floors should be started using a 50 or 80 Grit Resin pad. A concrete grinding machine with Planetary Heads must be used. The remaining process follows:

#### **New Construction**

- 1. This process will require the use of 50 or 80 Grit resin diamond. Multiple passes may be required. Salt & Pepper aggregate will be exposed.
- 2. Grind the floor with 120 grit resin diamonds. Multiple passes may be required. 3. Clean/scrub the floor via automatic scrubber with soft brushes/white pads to
- remove all dirt and debris from the floor. Allow floor to air dry. 4. Apply a Retroplate to entire surface at 200 sq. ft per gallon and maintain wet
- state for a minimum of 60 minutes.
- 5. Flush floor clean after material is spent and allow to air dry.
- 6. Grind the floor with 220 grit resin diamonds. Multiple passes may be required.
- Polish the floor with 400 grit resin diamonds. Multiple passes may be required.
- Polish the floor with 800 grit resin diamonds. Multiple passes may be required
- 9. Apply Retro Guard at a rate of 1200-1500 sq. ft per gallon.
- 10. High speed burnish with 800 grit or higher Twister pad. Multiple passes may be required.
- 11. Chase and fill grout joints with Polyurea.
- 12. Use "Edge Tint" around the edges.
- \*\*\* Applicator reserves the right to alter or add any steps in order to ensure that the floor is 100% acceptable to the owner and meets required specifications for a "level two shine."

#### **WORKMANSHIP AND CLEANING:**

- A. The premises shall be kept clean and free of debris at all times.
- B. Remove spatter from adjoining surfaces, as necessary.
- C. Repair damages to surface caused by cleaning operations. D. Remove debris from jobsite in accordance with local regulations.
- SPECIFIC QUALIFICATIONS / EXCLUSIONS( NOTE: This section, though not
- mandatory, will greatly improve the understanding and necessary procedures for performing this work properly.)
- A. No other trades will be allowed in the area being worked on due to possible safety and floor contamination issues.
- B. The areas to receive the RetroPlate 99 System will be delivered to the applicator in clean and swept condition. All equipment and supplies will be removed prior to turning the space over to the applicator. If the applicator is required to clean the space, and/or move other's supplies, staging and equipment, it will be done at time and materials.
- C. PROTECTION OF THE FLOOR FOLLOWING THE APPLICATION OF THE RETROPLATE 99 SYSTEM AND POLISHING IS THE RESPONSIBILITY OF THE OWNER.
- Upon completion the applicator will deliver a "level two shine" defined as at a distance of 30-35 feet. Light reflection will be well defined.

CONCRETE SUMMARY OPTION "E"





ORID,

SVILL OW

DATE

18 JAN 2010

SHEET NUMBER

#### ADVANCED FLOOR PRODUCTS CORPORATE ACCUNT DOLLAR GENERAL STORES WORK ORDER

National Account Number 2008-07

Revisd 05/07/09

New Store Construction - Approximately 7352 Sq Feet of RetroPlatPer Store

The Sales area and hall will be finished to a High gloss level 3 shin

#### Definition of expected shine

High Gloss: Reflective shine in which, at a distance of 30', the refletivity is clearly defined.

- 1) The sales area and hall are the only areas to Receive Polishing
- 2) The receiving area, offices and restrooms will be finished by th landlords GC with Silicone Acrylic Concrete sealer
- 3) Polyurea joint fill (Standard Gray) will be required.
- 4) Control joints installed per recommendation of structural enginer at slab design per "Slab on Grade" notes on sheet S2.A and minimum erformance requirements. The exact placement of control joints shall be in ccordance with

the site specific recommendation of the Registered ProfessionaStructural Engineer as part of the slab design. Control joints shall be placed per the Engineer's recommendation to limit cracking based on the site secific structural slab design. The minimum spacing layout is shown blow.

Projects will be completed using only Advanced Floor Products proacts

#### **Product Requirements**

- 1) RetroPlate 99 (no substitute densifier) 55 Gals per store.
- 2) RetroGuard 2-5 Gallon pails
- 3) Ameripolish Edge Tint (Part A&B) (Midnight Black)
- 4) Standard Poly Urea Gray joint fill (Applicators choice)
- 5) Diamonds purchased in sets to equip the particular machine. Gts needed: a) 40, 50 or 80 metal diamonds
- b) 100/120, 200/220, 400. 800 resin diamonds
- c) 800, 1500 and 3000 grit Twister pad is to be used to burnish.


All work will be completed per this work order.

# Qualifications:

- 1) All applicators of the RetroPlate System must have the work exerience and be
- certified by Advanced Floor Products of Springville, Utah.
- 2) Applicator must possess a letter of Certification from Advance Floor Products
- 1203 W, Spring Creek Place, Springville, UT 84663.
- a) The Applicator must have satisfactorily installed RetroPlate 1 a minimum of 5 projects of at least 6,000 sq feet.
- b) The Certified person in the company must be present on the b during all phases of the installation.
- c) Applicator will provide the recommended grinding machine and Advanced Floor Products Diamonds

## 3) EQUIPMENT:

a) Minimum number of machines need for the projects (2-32" lanetary)

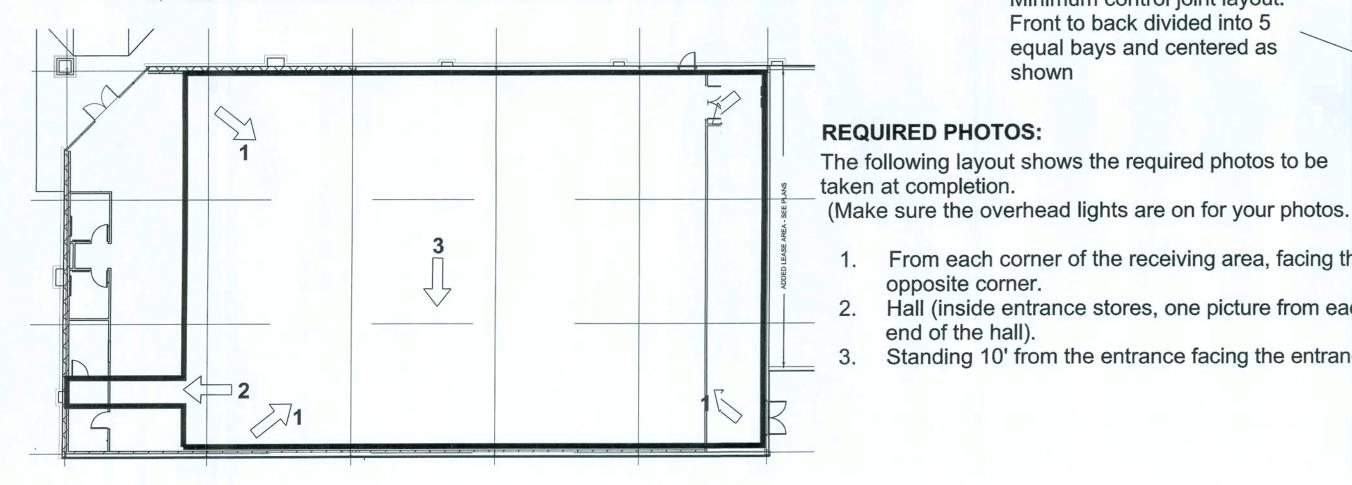

a) minimum number of machines need for the Pprojecto (2 32 1 miletary) b) Applicators will provide the electrical generators as necessary for their

# equipment.

#### SCOPE OF WORK

The following RetroPlate process will be used as a guide for RetroPlate process and is the Manufacturers application recommendation. Kζeep in mind that the applicator will finish the floor to a nice level 3 high gloss shine. Applicators will alter the steps as necessary to achieve the required level 3 hhigh gloss shine. (See definition of shine)

- 1) Start the Grind using 40, 50 or 80 grit Metal paged depending on the need. (Multiple passes will be required for each step) Make sure that the previous "Scratch Pattern" is taken out before proceedingg.
- 2) Clean the floor.
- 3) Grind floor using 100/120 grit pad.
- 4) Clean the floor

Minimum control joint layout:

Left to right at column lines

and centered in between

Minimum control joint layout: Front to back divided into 5

equal bays and centered as

1. From each corner of the receiving area, facing the

Hall (inside entrance stores, one picture from each

Standing 10' from the entrance facing the entrance.

as shown

shown

opposite corner.

end of the hall).

- 5) Grind the floor with a 200/220 grit pad. 6) Clean floor
- 7) Apply RetroPlate 99 to the surface at 200 sq ft pper gallon, scrubbing product in
- into floor and allowing product to soak until turning slick. If it becomes sticky, dampen the sticky areas with water and scrub inn, leaving the product on the floor for 60 minutes.
- 8) Clean up excessive RetroPlate 99. Let the floor r dry, overnight if possible.
- 9) Continue the polishing process using 400 and 8\square 00 Grit pads. (800/1500/3000 Grit Twister pad, multiple passes, to finish.)
- 10) Ameripolish Edge Tint (Midnight Black) will 1 be applied around the perimeter of the sales floor and hall extending oout 4 inches.
- 11) Edge tint will be applied using a Paasche spra'ayer at 40psi.
- 12) Edge tint will be applied with a cut off line unnder the door edge at the receiving, office and restroom entrances.
- 13) Chase, clean and fill all control joints with Statandard Gray polyurea joint fill.
- 14) Apply RetroGuard sealer to the entire sales flqoor and hall surface at a rate of 1200-1500 ft per gallon.

### FLOORS WILL BE FINISHED TO A MINIMUM LEVEL 3 HIGH GLOSS SHINE

- 1) High Gloss: Reflective shine in which, at a distance of 30', the reflectivity is clearly defined.
- 2) Sample photos attached of required results

#### CONCRETE FLOOR CONDITIONS:

- 1) Sealing, Hardening and Polishing of Concrete Surface.
- a) Concrete must be in place a minimum of 28 days or as directed by the manufacturer before application can begin.
- b) Concrete Floor will be finished to a minimum FF of 35 +/- 5 and FL of 30 +/-5.
- c) Only a certified applicator shall apply RetroPlate 99. Applicable procedures must be followed as recommended by the product manufacturer and as required to match approved test sample.
- d) Polish to the required level 3 high gloss shine.

#### WORKMANSHIP AND CLEANING

- 1) The premises shall be kept clean and free of debris at all times.
- 2) Remove spatter from adjoining surfaces.
- 3) Remove debris from jobsite. Dispose of materials in separate, closed containers
  - in accordance with local regulations.
- 4) Upon completion of the installation of the Retroplate system, the Applicator will meet with the Supervisor of Construction and /or the Dollar General Construction Manager. They will walk through and will sign off that the work is satisfactory.
- 5) Upon completion email completion photos with store location, address and date completed to:
  - a) michael@retroplatesystem.com
  - b) cprojmgr@dollargeneral.com

## (See the last page of this document for required photos)

Questions regarding this work order procedure: contact Michael Greenfield at (817) 470-7335 or Jim Walton at (865) 604-6800 at Corporate Accounts.



DATE


18 JAN 2010

SHEET NUMBER

S3.E

CCONTROL JOINT SPACING PLAN

RETROPLATE WORK ORDER OPTION "E"

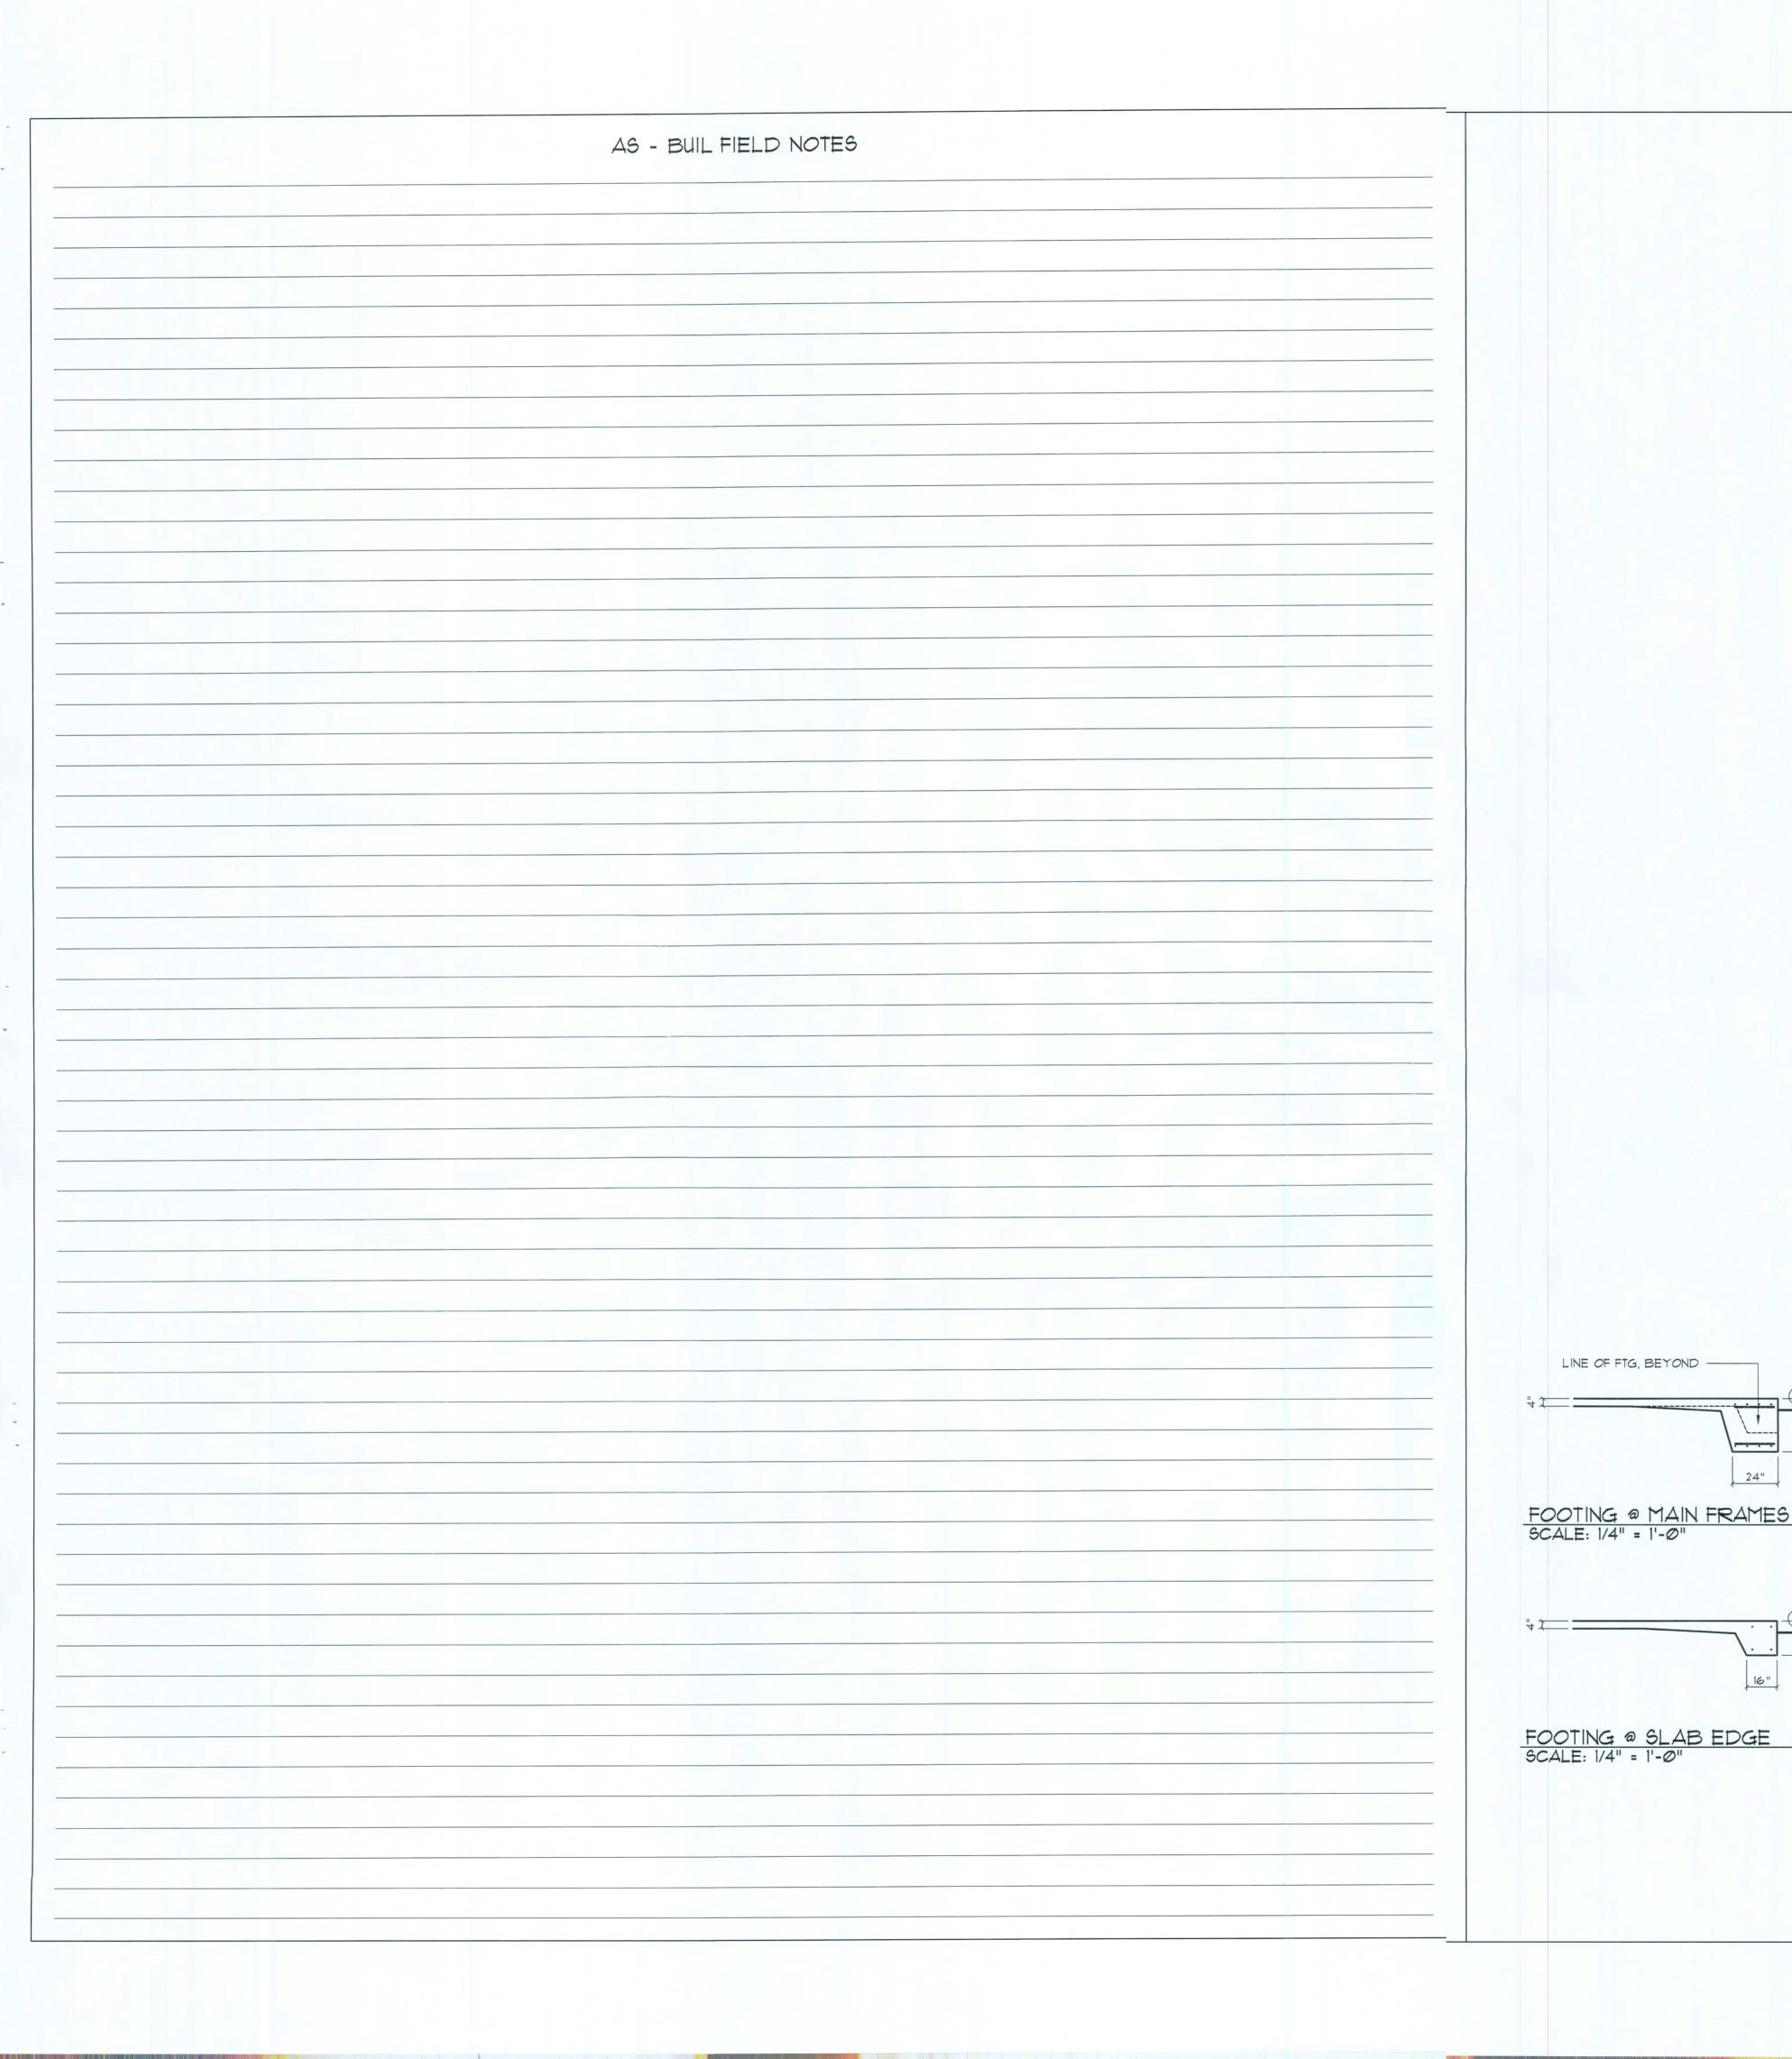

#### GENERAL STRUCTURAL NOTES

GENERAL:

DESIGN AND EXTENT OF THE WORK AND ARE PARTIALLY DIAGRAMMATIC. TO SERVE AS SHOP DRAWINGS OR PORTIONS THEREOF.

2. ALL DETAILS AND SECTIONS SHOWN ON THE DRAWINGS ARE INTENDED TO BE TYPICAL AND SHALL BE CONSTRUED TO APPLY TO ANY SIMILAR SITUATION ELSEWHERE ON THE PROJECT, EXCEPT WHERE A DIFFERENT DETAIL

3. PRIOR TO START OF CONSTRUCTION, THE CONTRACTOR AND ALL THE SUBCONTRACTORS SHALL VERIFY ALL GRADES, LINES, LEVELS, DIMENSIONS AND COORDINATE EXISTING CONDITIONS AT THE JOB SITE WITH THE PLANS AND SPECIFICATIONS. THEY SHALL REPORT ANY INCONSISTENCIES OR ERRORS IN THE ABOVE TO THE ARCHITECT/ENGINEER BEFORE COMMENCING WORK. THE CONTRACTOR AND HIS SUBCONTRACTORS SHALL LAY OUT THEIR WORK FROM ESTABLISHED REFERENCE POINTS AND BE RESPONSIBLE FOR ALL LINES,

4. IF ANY ERRORS OR OMISSIONS APPEAR IN THE DRAWINGS, GENERAL NOTES OR OTHER DOCUMENTS, THE CONTRACTOR SHALL NOTIFY THE ARCHITECT IN WRITING OF SUCH OMISSION OR ERROR PRIOR TO PROCEEDING WITH ANY WORK WHICH APPEARS IN QUESTION. IN THE EVENT OF THE CONTRACTOR'S FAILING TO GIVE SUCH AN ADVANCED NOTICE, HE SHALL BE HELD RESPONSIBLE FOR THE RESULTS OF ANY SUCH ERRORS OR OMISSIONS AND THE COST OF RECTIFYING THE SAME.

SPECIFICATIONS TOGETHER WITH THE ARCHITECTURAL, MECHANICAL, ELECTRICAL AND OTHER TRADE DRAWINGS AND SHOP DRAWINGS, TO LOCATE DEPRESSED SLABS, SLOPES, DRAINS, OUTLETS, RECESSES, OPENINGS, BOLT SETTING, SLEEVES, DIMENSIONS, ETC. NOTIFY ARCHITECT/ENGINEER, IN WRITING, OF ANY POTENTIAL CONFLICTS BEFORE PROCEEDING WITH THE

#### SHOP DRAWINGS AND DELEGATED ENGINEERING:

STRUCTURAL PLANS (RELATED TO THE DELEGATED DESIGN) INCLUDING ALL DESIGN LOADS, IN ADDITION TO THE INFORMATION REQUIRED BY THE DELEGATED ENGINEER'S DESIGN.

SIGNED AND SEALED BY THE CONTRACTOR'S DELEGATED ENGINEER, ONLY FOR GENERAL COMPLIANCE WITH THE DESIGN INTENT, REQUIRED LOADING AND COORDINATION WITH THE STRUCTURAL DESIGN.

PRINTS OF THE STRUCTURAL SHOP DRAWINGS FOR ARCHITECT REVIEW. BEFORE STARTING FABRICATION. THE ARCHITECT WILL RETURN ONE MARKED UP AND STAMPED COPY TO THE CONTRACTOR. THE MARKED-UP COPY SHALL BE USED TO MAKE THE PRINTS REQUIRED FOR SHOP DRAWING DISTRIBUTION.

#### CONSTRUCTION MEANS AND METHODS:

1. THE CONSTRUCTION MEANS, METHODS, TECHNIQUES, SEQUENCE OR PROCEDURES, SAFETY PRECAUTIONS, SHORES, RESHORES, LATERAL NOR ASSURE LIABILITY FOR THE JOB SAFETY, TEMPORARY SHORING AND BRACING AND THE PERFORMANCE OF THE CONTRACTOR.

3. PROVIDE ALL SHORING, BRACING AND SHEETING AS REQUIRED FOR SAFETY, STRUCTURAL STABILITY AND FOR THE PROPER EXECUTION OF THE WORK. REMOVE WHEN WORK IS COMPLETED.

4. PROVIDE AND MAINTAIN GUARD LIGHTS AT ALL BARRICADES, RAILINGS, OBSTRUCTIONS IN THE STREETS, ROADS OR SIDEWALKS AND ALL TRENCHES OR PITS ADJACENT TO PUBLIC WALKS OR ROADS.

5. AT ALL TIMES, PROVIDE PROTECTION AGAINST WEATHER (RAIN, WIND, STORMS OR THE SUN), SO AS TO MAINTAIN ALL WORK, MATERIALS, APPARATUS AND FIXTURES FREE FROM INJURY OR DAMAGE.

DAMAGED. ANY WORK DAMAGED BY FAILURE TO PROVIDE PROTECTION SHALL BE REMOVED AND REPLACED WITH NEW WORK AT THE CONTRACTOR'S

7. THE CONTRACTOR SHALL PAY FOR ALL DAMAGES TO ADJACENT

BASED ON ANSI/ASCE 7-97. BASIC WIND VELOCITY IIO MPH,

SUPERIMPOSED LIVE LOADS: . . 4. FLOOR DESIGN LOADS: SUPERIMPOSED DEAD LOADS: . . ..... 25 PSF SUPERIMPOSED LIVE LOADS: 40 PSF RESIDENTIAL BALCONIES

5. WIND NET UPLIFT: ARE AS INDICATED ON PLANS

I. THE DRAWINGS ARE INTENDED TO SHOW THE GENERAL ARRANGEMENT, THEY ARE NOT INTENDED TO BE SCALED FOR ROUGH-IN MEASUREMENTS, OR

OR SECTION IS SHOWN.

ELEVATIONS AND MEASUREMENTS IN CONNECTION WITH THEIR WORK.

5. THE CONTRACTOR SHALL USE THE STRUCTURAL DRAWINGS AND

1. ALL SHOP DRAWINGS SHALL BE SUBMITTED FOR ARCHITECT'S REVIEW ONLY AFTER THEY HAVE BEEN THOROUGHLY REVIEWED BY THE CONTRACTOR. FOR CONSTRUCTION METHODS. DIMENSIONS AND OTHER TRADE REQUIREMENTS, AND STAMPED WITH THE CONTRACTOR'S APPROVAL STAMP. THE ARCHITECT ASSUMES NO RESPONSIBILITY FOR DIMENSIONS, QUANTITIES, ENGINEERING DESIGN BY DELEGATED ENGINEERS, ERRORS OR OMISSIONS AS A RESULT OF REVIEWING ANY SHOP DRAWINGS. ANY ERRORS OR OMISSIONS MUST BE MADE GOOD BY THE CONTRACTOR, IRRESPECTIVE OF RECEIPT, CHECKING OR REVIEW OF DRAWINGS BY THE ENGINEER AND EVEN THOUGH WORK IS DONE IN ACCORDANCE WITH SUCH DRAWINGS.

2. BEFORE STRUCTURAL INSPECTIONS CAN BE MADE ON A PORTION OF THE STRUCTURE, ALL RELATED SHOP DRAWINGS, DELEGATED ENGINEERING, PRODUCT APPROVAL, MANUFACTURER'S DATA AND OTHER RELATED INFORMATION, MUST BE REVIEWED AND ACCEPTED BY THE ARCHITECT-OF-RECORD AND APPROVED BY THE BUILDING DEPARTMENT.

3. SHOP DRAWINGS SHALL CONTAIN ALL INFORMATION SHOWN ON THE

4. ARCHITECT WILL REVIEW ALL SUBMITTED SHOP DRAWINGS, PREPARED AND

5. CONTRACTOR SHALL SUBMIT TO THE ARCHITECT TWO SETS OF BLUE

BRACING AND PROGRAMS IN CONNECTION WITH THE PROJECT, ARE THE SOLE RESPONSIBILITY OF THE CONTRACTOR. OUR SERVICES DO NOT GUARANTEE

2. THE CONTRACTOR IS RESPONSIBLE AND SHALL COMPLY WITH THE SAFETY REQUIREMENTS OF THE 2004 FLORIDA BUILDING CODE AND APPLICABLE FOOTINGS: LOCAL, STATE AND FEDERAL LAWS.

6. AT THE END OF THE DAYS WORK, COVER ALL WORK LIKELY TO BE

STRUCTURES, SIDEWALKS AND TO STREETS OR OTHER PUBLIC PROPERTY OR

#### STRUCTURAL DESIGN CRITERIA:

I. THE DESIGN COMPLIES WITH THE REQUIREMENTS OF THE 2004 FLORIDA BUILDING CODE - SECTION 1609 AND OTHER REFERENCED CODES AND SPECIFICATIONS. ALL CODES AND SPECIFICATIONS SHALL BE LATEST EDITION AT TIME OF PERMIT.

WIND LOAD CRITERIA:

3. ROOF DESIGN LOADS: SUPERIMPOSED DEAD LOADS: . . . . 20 PSF

..... 60 PSF

#### FOUNDATIONS: (SPREAD FOOTINGS)

I. FOUNDATIONS ARE DESIGNED TO BEAR ON WELL COMPACTED GRADE OR CLEAN FILL OF AN ALLOWABLE BEARING CAPACITY OF 1,000 PSF MINMUM. FOR REQUIRED SOIL BEARING CAPASITIES GREATER THAN 1,000 PSF, A CERTIFIED TESTING LABORATORY SHALL BE ENGAGED BY THE OWNER TO VERIFY THAT THE REQUIRED BEARING CAPACITY WAS OBTAINED. SAID SOIL CAPACITY SHALL BE CERTIFIED AND TESTED BY A FLORIDA REGISTERED FOUNDATION ENGINEER, PRIOR TO CASTING OF CONCRETE IN

2. NATURAL GRADE (OR FILL) BELOW FOOTINGS SHALL BE 

3. TOP OF WALL FOOTINGS TO BE AT THE SAME ELEVATION AS TOP OF COLUMN PAD FOOTINGS. STEP WALL FOOTING FROM HIGHER COLUMN FOOTING TO THE LOWER ONE (AS DETAILED ON THE PLANS).

4. BOTTOM OF ALL FOOTINGS TO BE A MINIMUM I'-6" BELOW THE TOP OF CONCRETE SLAB ON GRADE (UNLESS OTHERWISE NOTED) OR MINIMUM 1'-0" BELOW FINISHED GRADE, WHICHEVER IS LOWER. IN THE EVENT THAT THE SLAB STEPS ON EACH SIDE OF THE FOOTING, THE FOOTING SHALL BE 1'-6" BELOW TOP OF THE LOWER SLAB.

5. REINFORCING IN THE CONTINUOUS WALL FOOTINGS (MONOLITHIC AND NON-MONOLITHIC) SHALL BE SPLICED 40 BAR DIAMETERS MINIMUM AND SHALL EXTEND CONTINUOUSLY THRU ALL FOOTING PADS.

6. ALL LONGITUDINAL REBARS IN THE CONTINUOUS WALL FOOTINGS, SHALL BE CONTINUED AT BENTS AND CORNERS BY BENDING THE REBARS 48 BAR DIAMETERS AROUND THE CORNERS OR ADDING MATCHING CORNER BARS, EXTENDING 48 BAR-DIAMETERS INTO FOOTING EACH SIDE OF CORNER OR BENT.

ALL FOOTINGS SHALL BE 12<sup>st</sup> MINIMUM THICKNESS.

#### CONCRETE SLABS ON GRADE:

I. ALL INTERIOR AND EXTERIOR SLABS AND WALKWAYS AS SHOWN ON THE STRUCTURAL OR ARCHITECTURAL PLANS, SHALL BE FOUR INCHES THICK MINIMUM REINFORCED WITH 6 X 6 - WI.4 X WI.4 WELDED WIRE FABRIC (UNLESS OTHERWISE NOTED).

2. ALL SLABS ON GRADE TO BE CONSTRUCTED IN ACCORDANCE WITH LATEST A.C.I - "GUIDE FOR CONCRETE FLOOR AND SLAB CONSTRUCTION" (A.C.I.

3. JOINTS SHALL BE PROVIDED IN ALL INTERIOR SLABS ON GRADE AT LOC. INDICATED ON THE PLANS DIVIDING THE SLAB INTO SQUARE PANELS NOT TO EXCEED 20 X 20 FT. IN SIZE. CAST SLAB IN LONG ALTERNATE STRIPS. PROVIDE A CONTRACTION JOINT BETWEEN EACH STRIP. SEE PLAN FOR SAW-CUT,

4. PROVIDE SAW-CUT JOINTS AT ALL SIDEWALKS AT A MAXIMUM SPACING OF FIVE FEET ON CENTERS AND ISOLATION JOINTS AT 20 FEET O.C.

5. FILL MATERIAL SHALL BE PLACED IN LIFTS NOT EXCEEDING 12" AND COMPACTED TO 98 % MODIFIED PROCTOR (ASTM D-1557) WITHIN A DISTANCE OF 3 FEET BEYOND ALL FOOTING EDGES. TAKE AT LEAST ONE DENSITY TEST FOR EACH 1,600 SQ.FT. OF AREA AND 12" BELOW SURFACE. SEND RESULTS OF THE TEST TO OWNER, ARCHITECT AND ENGINEER.

#### CONCRETE AND REINFORCING:

CONTRACTION AND ISOLATION JOINT DETAILS.

. CONCRETE DESIGN AND REINFORCEMENT IN ACCORDANCE WITH "BUILDING CODE REQUIREMENTS FOR REINFORCED CONCRETE" (A.C.I. 318 -LATEST EDITION) AND WITH "DETAILS AND DETAILING OF CONCRETE REINFORCEMENT" - (A.C.I. 315 - LATEST EDITION).

2. ALL CONCRETE WORK IN ACCORDANCE WITH "SPECIFICATIONS FOR STRUCTURAL CONCRETE FOR BUILDING" (A.C.I. 301 - LATEST EDITION). PRODUCTION OF CONCRETE, DELIVERY, PLACING AND CURING TO BE IN ACCORDANCE WITH "HOT WEATHER CONCRETING" (A.C.I. 305R - LATEST EDITION).

3. ALL CONCRETE TO BE REGULAR WEIGHT WITH A DESIGN STRENGTH OF 3,000 P.S.I. AT 28 DAYS. MAXIMUM SLUMP 5".

4. ALL REINFORCING TO BE NEW BILLET STEEL CONFORMING TO THE LATEST A.S.T.M. A-615 GRADE 60, FABRICATED IN ACCORDANCE WITH C.R.S.I. MANUAL OF STANDARD PRACTICE AND PLACED IN ACCORDANCE WITH A.C.I. 315 AND C.R.S.I. MANUAL OF STANDARD PRACTICE.

5. CONCRETE COVER UNLESS OTHERWISE DETAILED ON DRAWINGS:

(TOP & SIDES) . . .

SLABS ON GRADE: CENTERED W/SLAB

6. BEAM REINFORCEMENT: LAPPED 36 BAR DIAMETER OR MINIMUM 18 INCHES. BOTTOM BARS SPLICED ONLY AT SUPPORTS, TOP BARS SPLICED ONLY AT MID-SPAN. ALL TOP BARS HOOKED AT NONCONTINUOUS EDGES (U.O.N.). ALL HOOKS TO BE STANDARD 90 DEGREE HOOKS AS REQUIRED

7. ADDED REINFORCEMENT: PROVIDE ADDITIONAL CORNER BARS BENT 36 INCHES MINIMUM EACH WAY AT "L" AND "T" CORNERS IN OUTER FACES OF ALL BEAMS TO MATCH ALL HORIZONTAL BAR (TOP, BOTTOM AND INTERMEDIATE REBARS).

8. SEE PLAN FOR MINIMUM SIZE CONCRETE TIE BEAM REQUIREMENTS.

REFER TO THE METAL BUILDING SHOP DRAWINGS PREPARED BY BUTLER METAL BUILDINGS, INC., FOR EXACT LOCATION OF ALL EMBEDDED ANCHOR BOLTS.

ADDED FILL SHALL BE APPLIED IN 12" LIFTS -EA. LIFT SHALL BE CONPACTED TO 98% DRY COMPACTION PER THE "MODIFIED PROCTOR" METHOD.

#### NOTE!

THE DESIGN WIND SPEED FOR THIS PROJECT IS 110 MPH PER 2004 FBC 1609 AND LOCAL JURISDICTION REQUIREMENTS

ALL ANCHOR BOLTS ARE ASTM GRADE A36 STEEL ROD, THREADED 3 1/2", BLACK AND FREE FROM RUST AND SCALE

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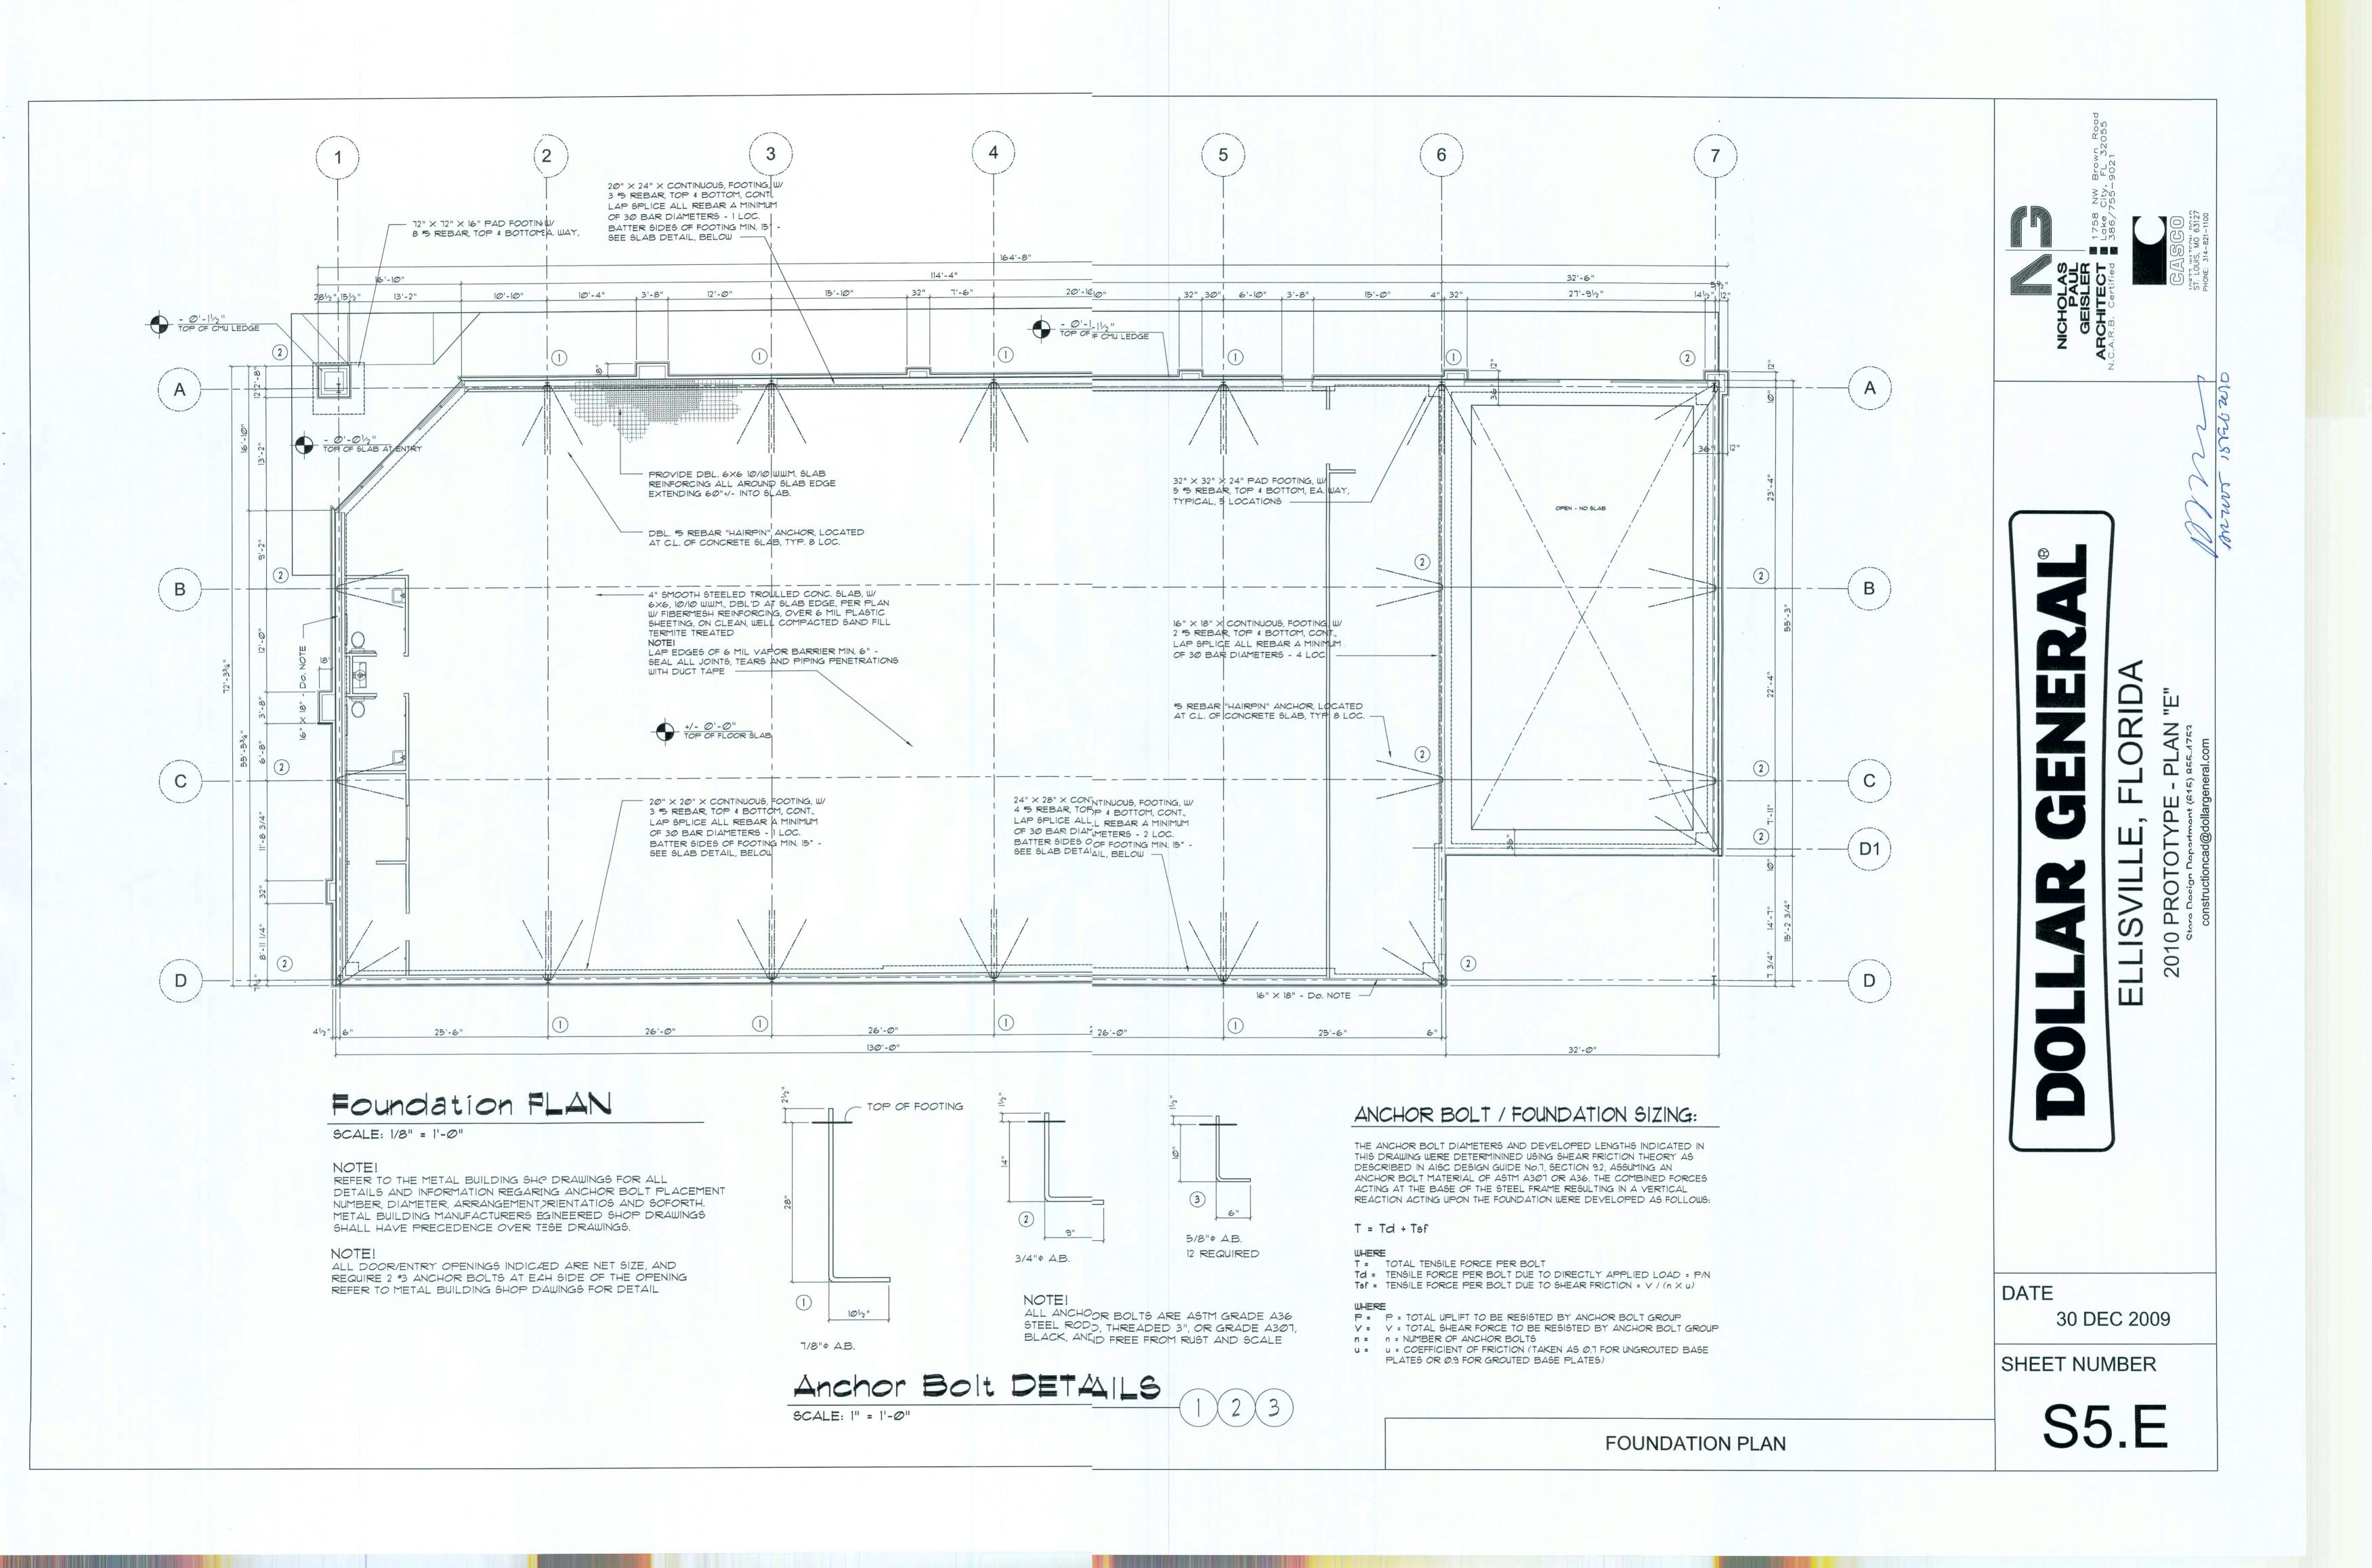
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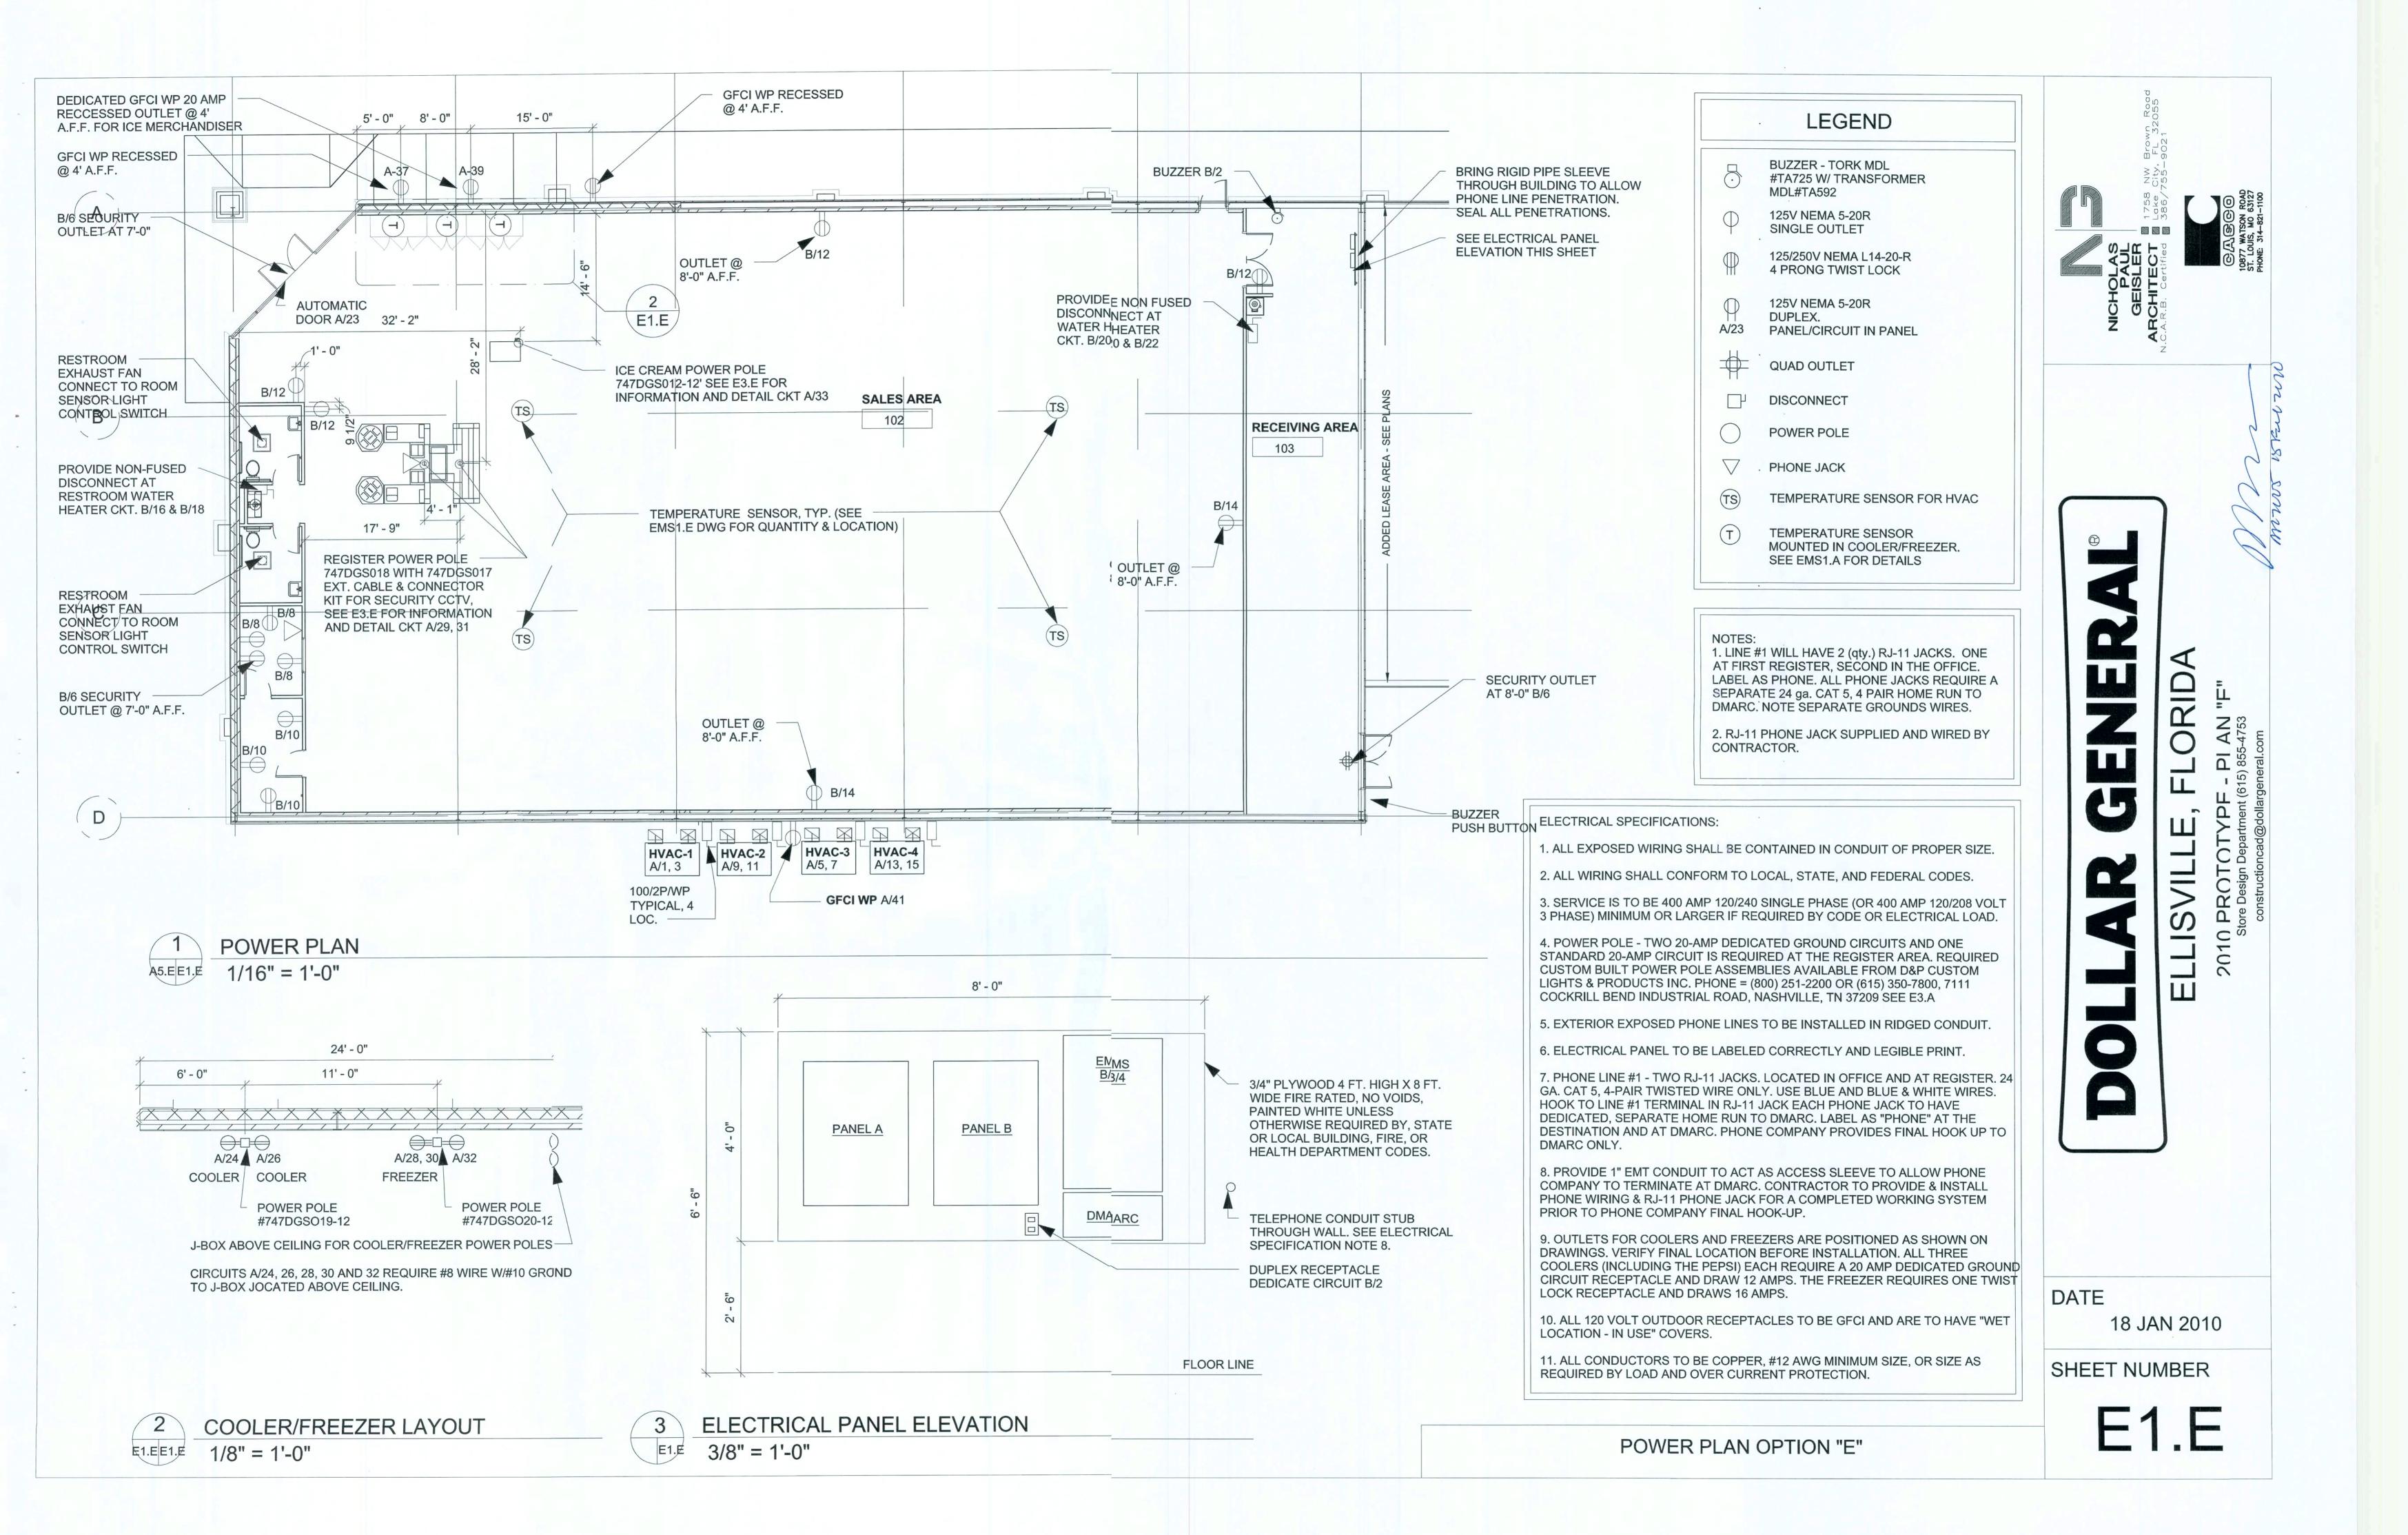
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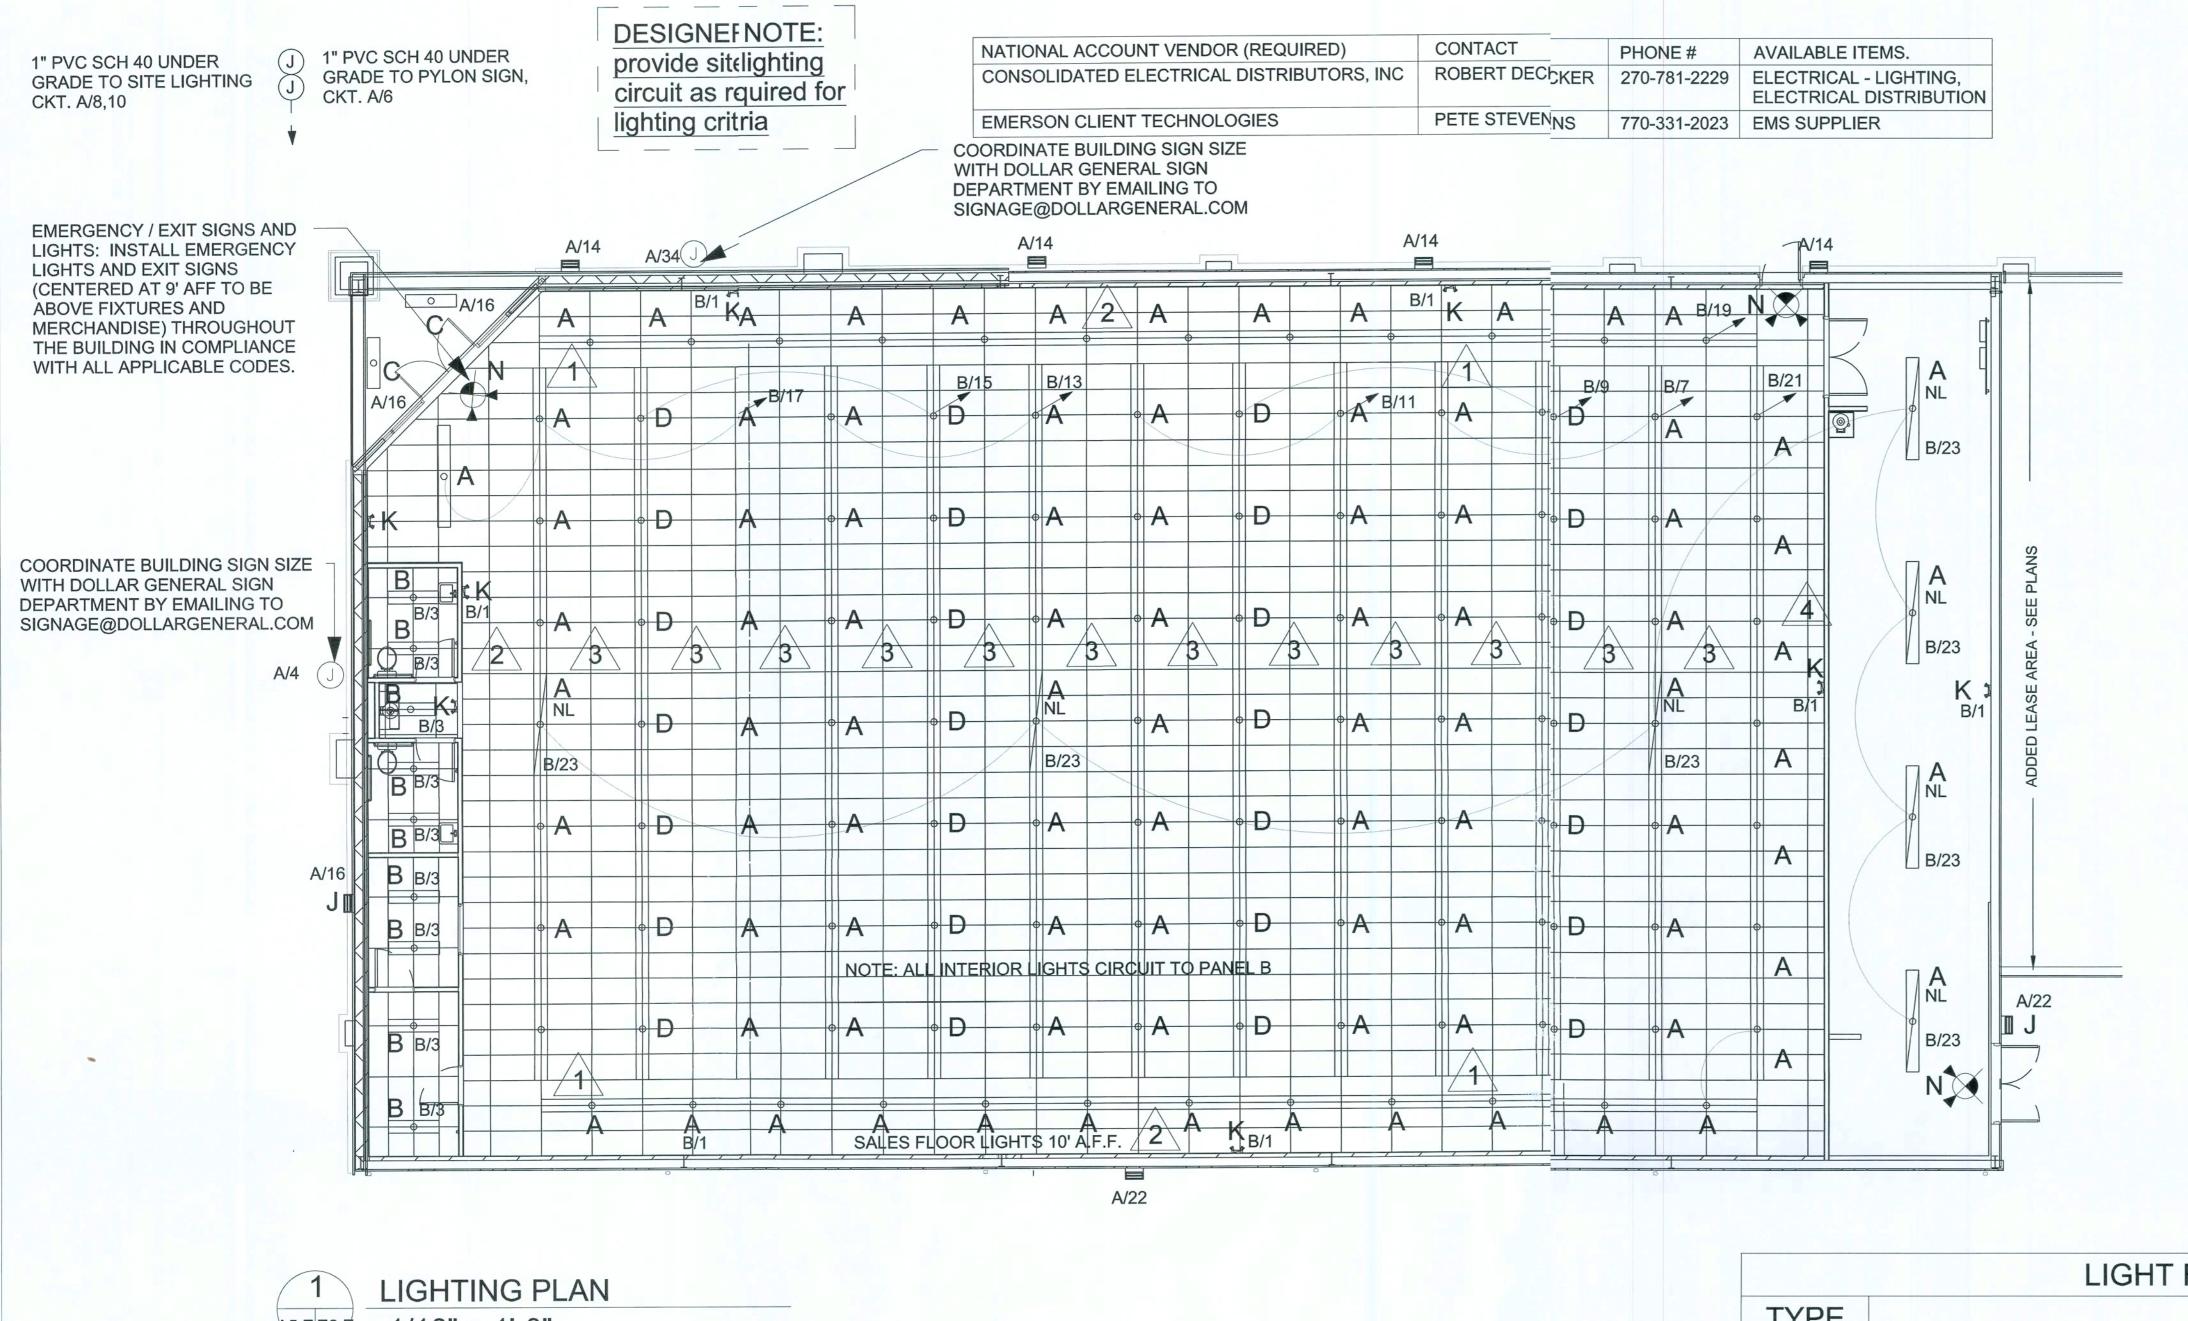
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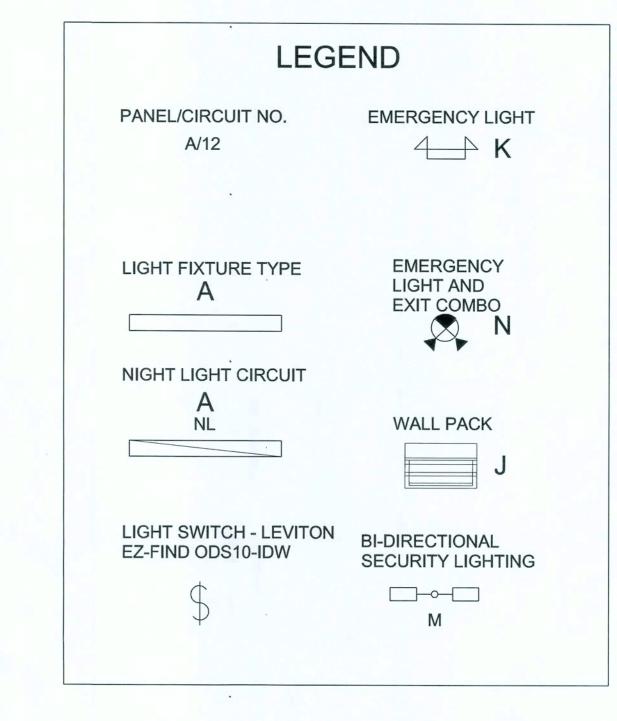
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FOUNDATION PLAN









# LIGHT SPACING NOTES

- DISTANCE BETWEEN PERIMETER ROW OF LIGHTS TO BE NO MORE THAN 2'-0" AT ANY POINT FROM AN ADJACENT LIGHT FIXTURE.
- PERIMETER ROWS OF LIGHTS TO BE NO CLOSER THAN 4'-0" FROM THE ADJACENT SIDE WALLS.
- DISTANCE BETWEEN PARALLEL ROWS OF LIGHTS TO BE NO MORE THAN 8'-0"
- RECEIVING AREA LIGHTS TO BE SPACED EVENLY BETWEEN FRONT AND REAR WALL OF THE RECEIVING AREA.

1/16" = 1'-0"

|      | LIGHT FIXTURE DESCRIPTION   |       |
|------|---|-------|
| TYPE | DESCRIPTION   | Count |
| А    | 8' LIGHT FIXTURES - HUBBELL CS8132EB8MVDGO OR LITHONIA LIGHTING TC132MVOSISHDGO WITH SYLVANIA BRAND BALLAST RATED-20 DEGREES # 49843 QTP2x32T8/UNV ISH-SC AND (2) SYLVANA LAMPS EACH. (NO. F032/841/XP/ECO) | 92    |
| В    | 4' LIGHT FIXTURES - HUBBELL CS4132EB8MVDGO OR LITHONIA LIGHTING TC132MVOSISHDGO WITH SYLVANIA BRAND BALLAST-20 DEGREES # 49841 QTP1x32T8/UNV ISH-SC AND (2) SYLVANA LAMPS EACH. (NO. F032/841/XP/ECO)       | 9     |
| С    | 4' LIGHT FIXTURES - HUBBELL CS4232EB81MVDGO OR LITHONIA LIGHTING C232MVOSISDGO WITH SYLVANIA BRAND BALLAST-20 DEGREES # 49843 QTP2x32T8/UNV ISH-SC AND (2) SYLVANA LAMPS EACH. (NO. F032/841/XP/ECO)        | 2     |
| D    | 8' LIGHT FIXTURES - HUBBELL CS82324EB8MVDGO OR LITHONIA LIGHTING TC232MV1/40SSSDGO WITH SYLVANIA BRAND BALLAST-20 DEGREES # 49947 QTP4x32T8/UNV ISN-SC AND (4) SYLVANA LAMPS EACH. (NO. F032/841/XP/ECO)    | 28    |
| J    | HUBBELL PGL - 400H - 128-I-LP DGN, 400 WATT METAL HALIDE LITHONIA LIGHTING - TWR2400MYBLPIDGN   | 9     |
| K    | DUAL-LITE LZ-2 DGN HEAD EMERGENCY LIGHT LITHONIA LIGHTING - ELM2DGN   | 8     |
| N    | EMERGENCY LIGHT/EXIT SIGN COMBO UNIT - HUBBELL LTURWDGN LITHONIA LIGHTING LHQMSW3R120277DGN   | 3     |
| М    | FLOOD LIGHTS - HUBBELL (2) MHSK400H468DGN/THB21 LITHONIA LIGHTING (2)TFR400MTATBISLPIDGN/BS28DDBU   | 2     |

HOOKER HANGER TO BE USED TO MOUNT LIGHT FIXTURES TO CEILING GRID. HUBBELL - CSZT LITHONIA LIGHTING - HRC1J48

NOTE 1: IN LIEU OF TYPE "N" EMERGENCY/EXIT COMBINATION LIGHT A STANDARD EXIT LIGHT MAY BE SUBSTITUTED. USE DUAL LITE LTURNW DGN, LESS HEADS, EXIT LIGHT - LITHONIA LIGHTING - LHOMSW3R120/277DGN.

LIGHTING PLAN OPTION "E"




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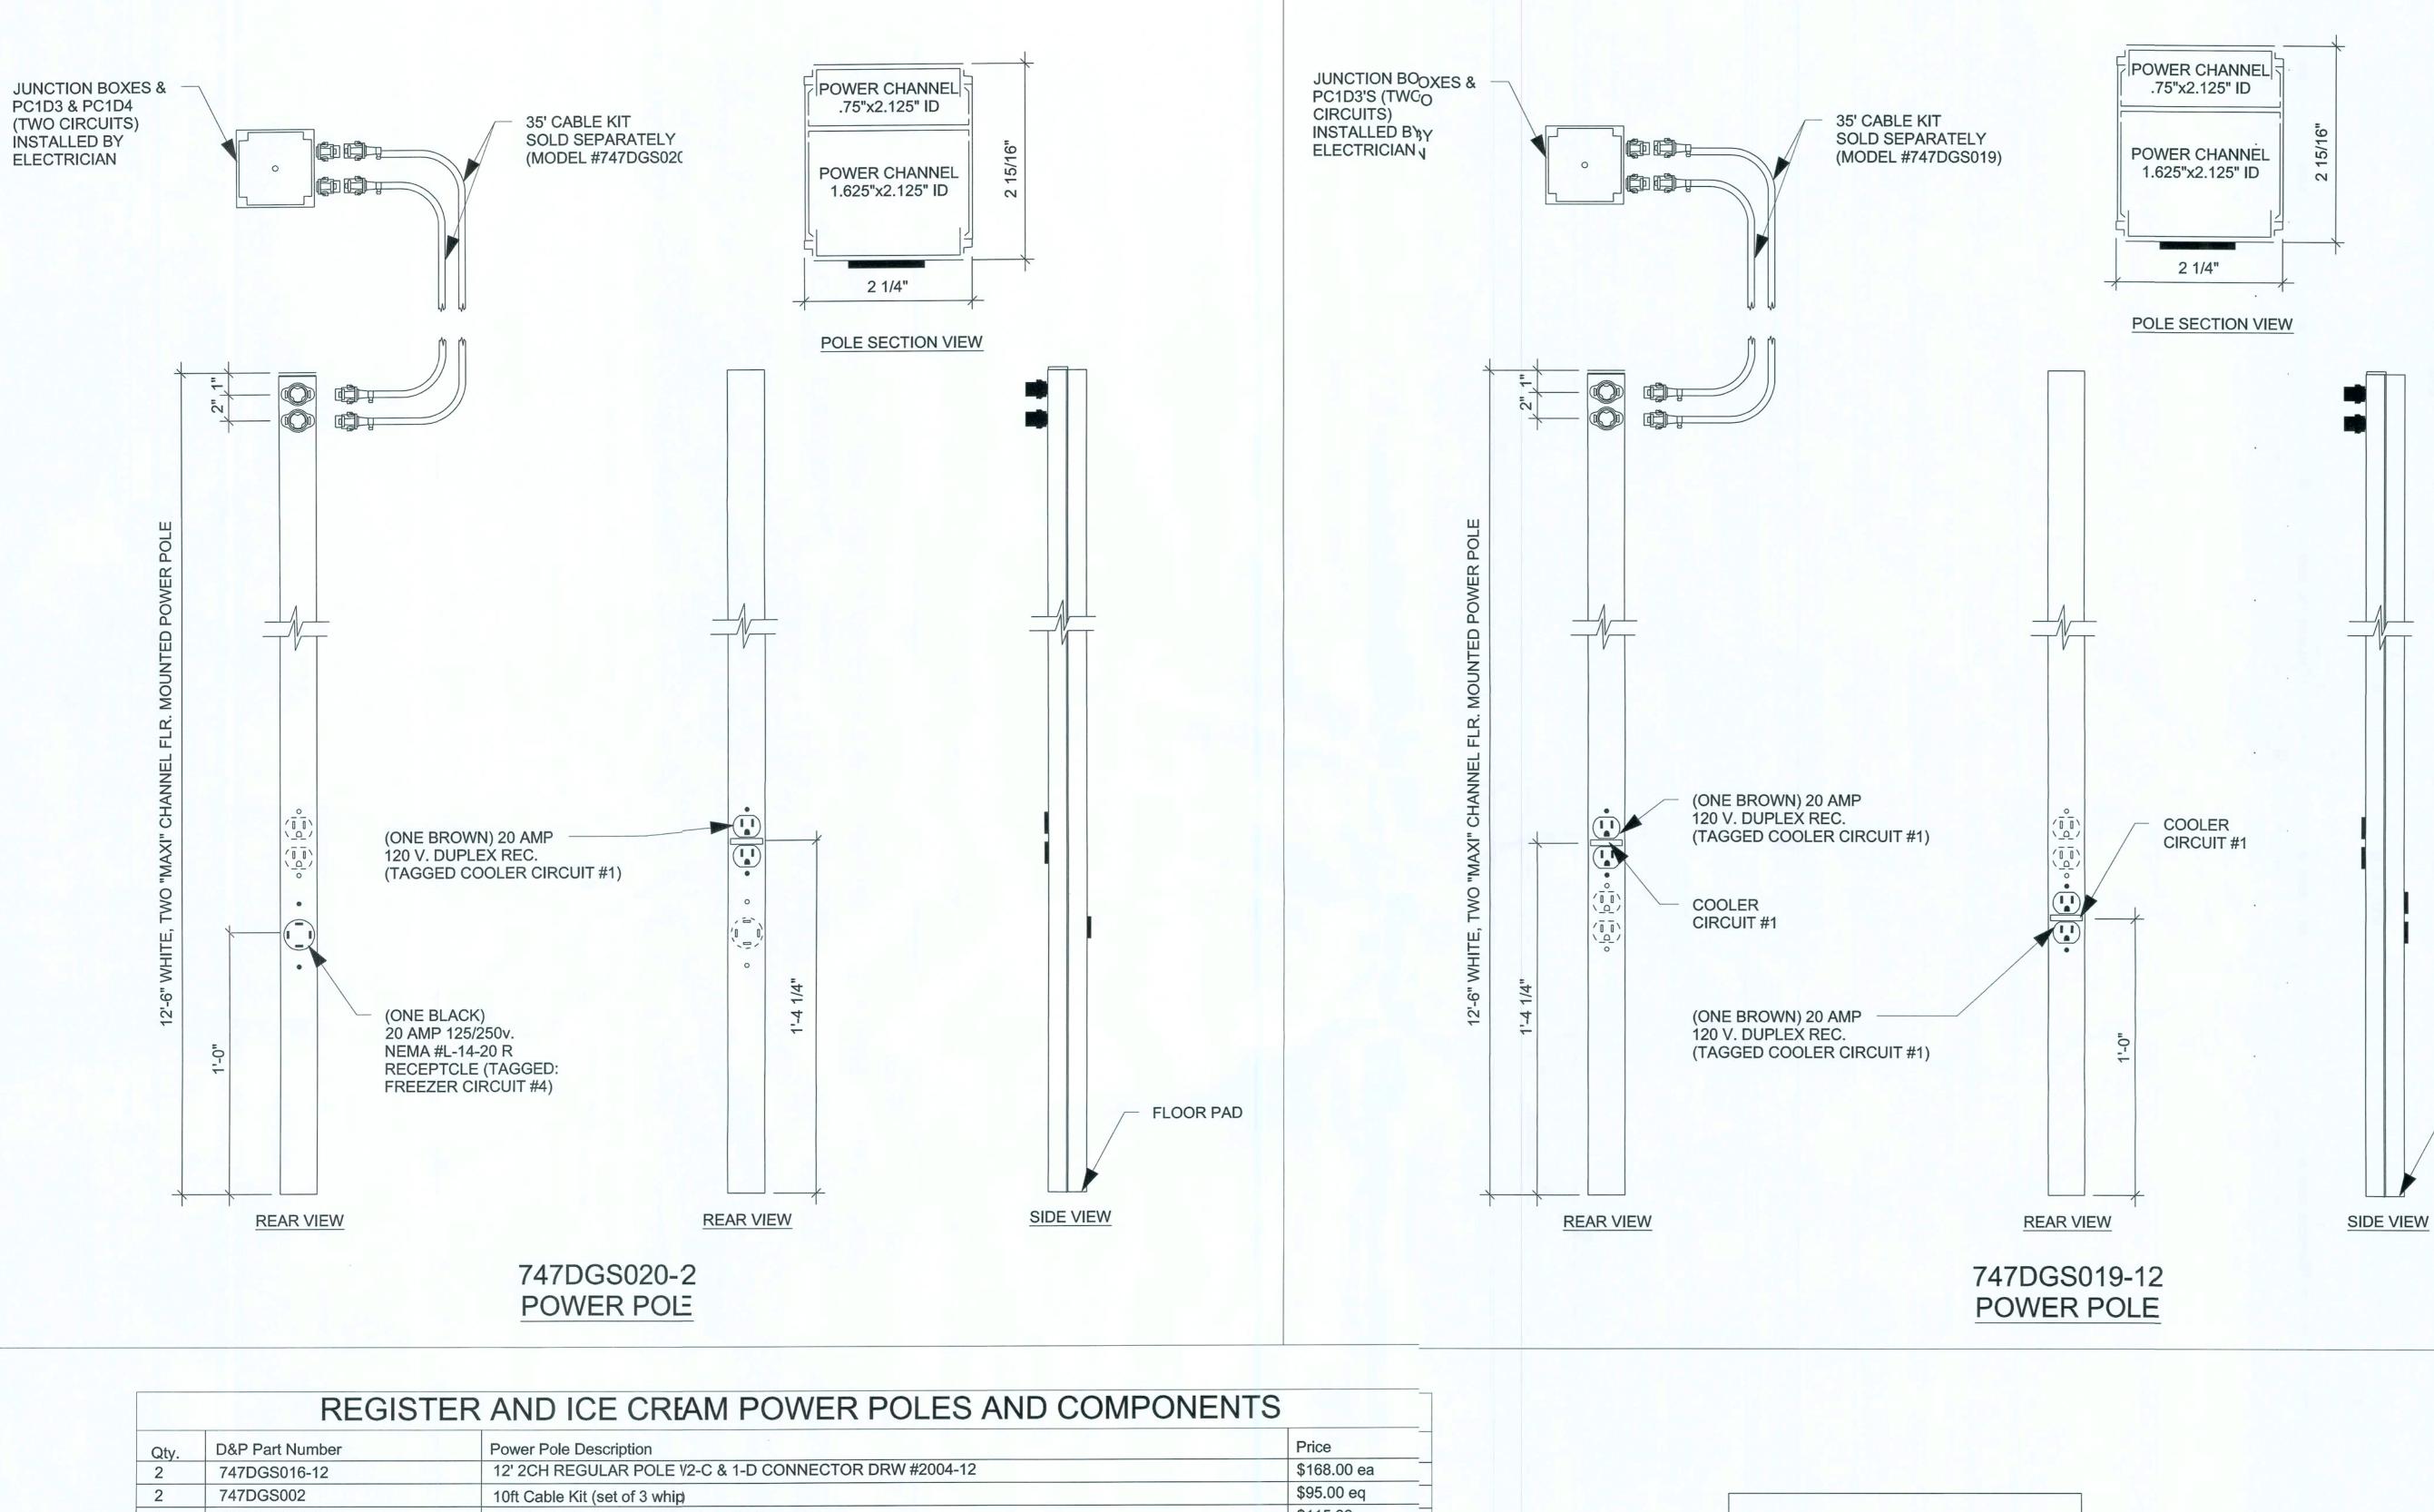
18 JAN 2010

2010

SHEET NUMBER

E2.E



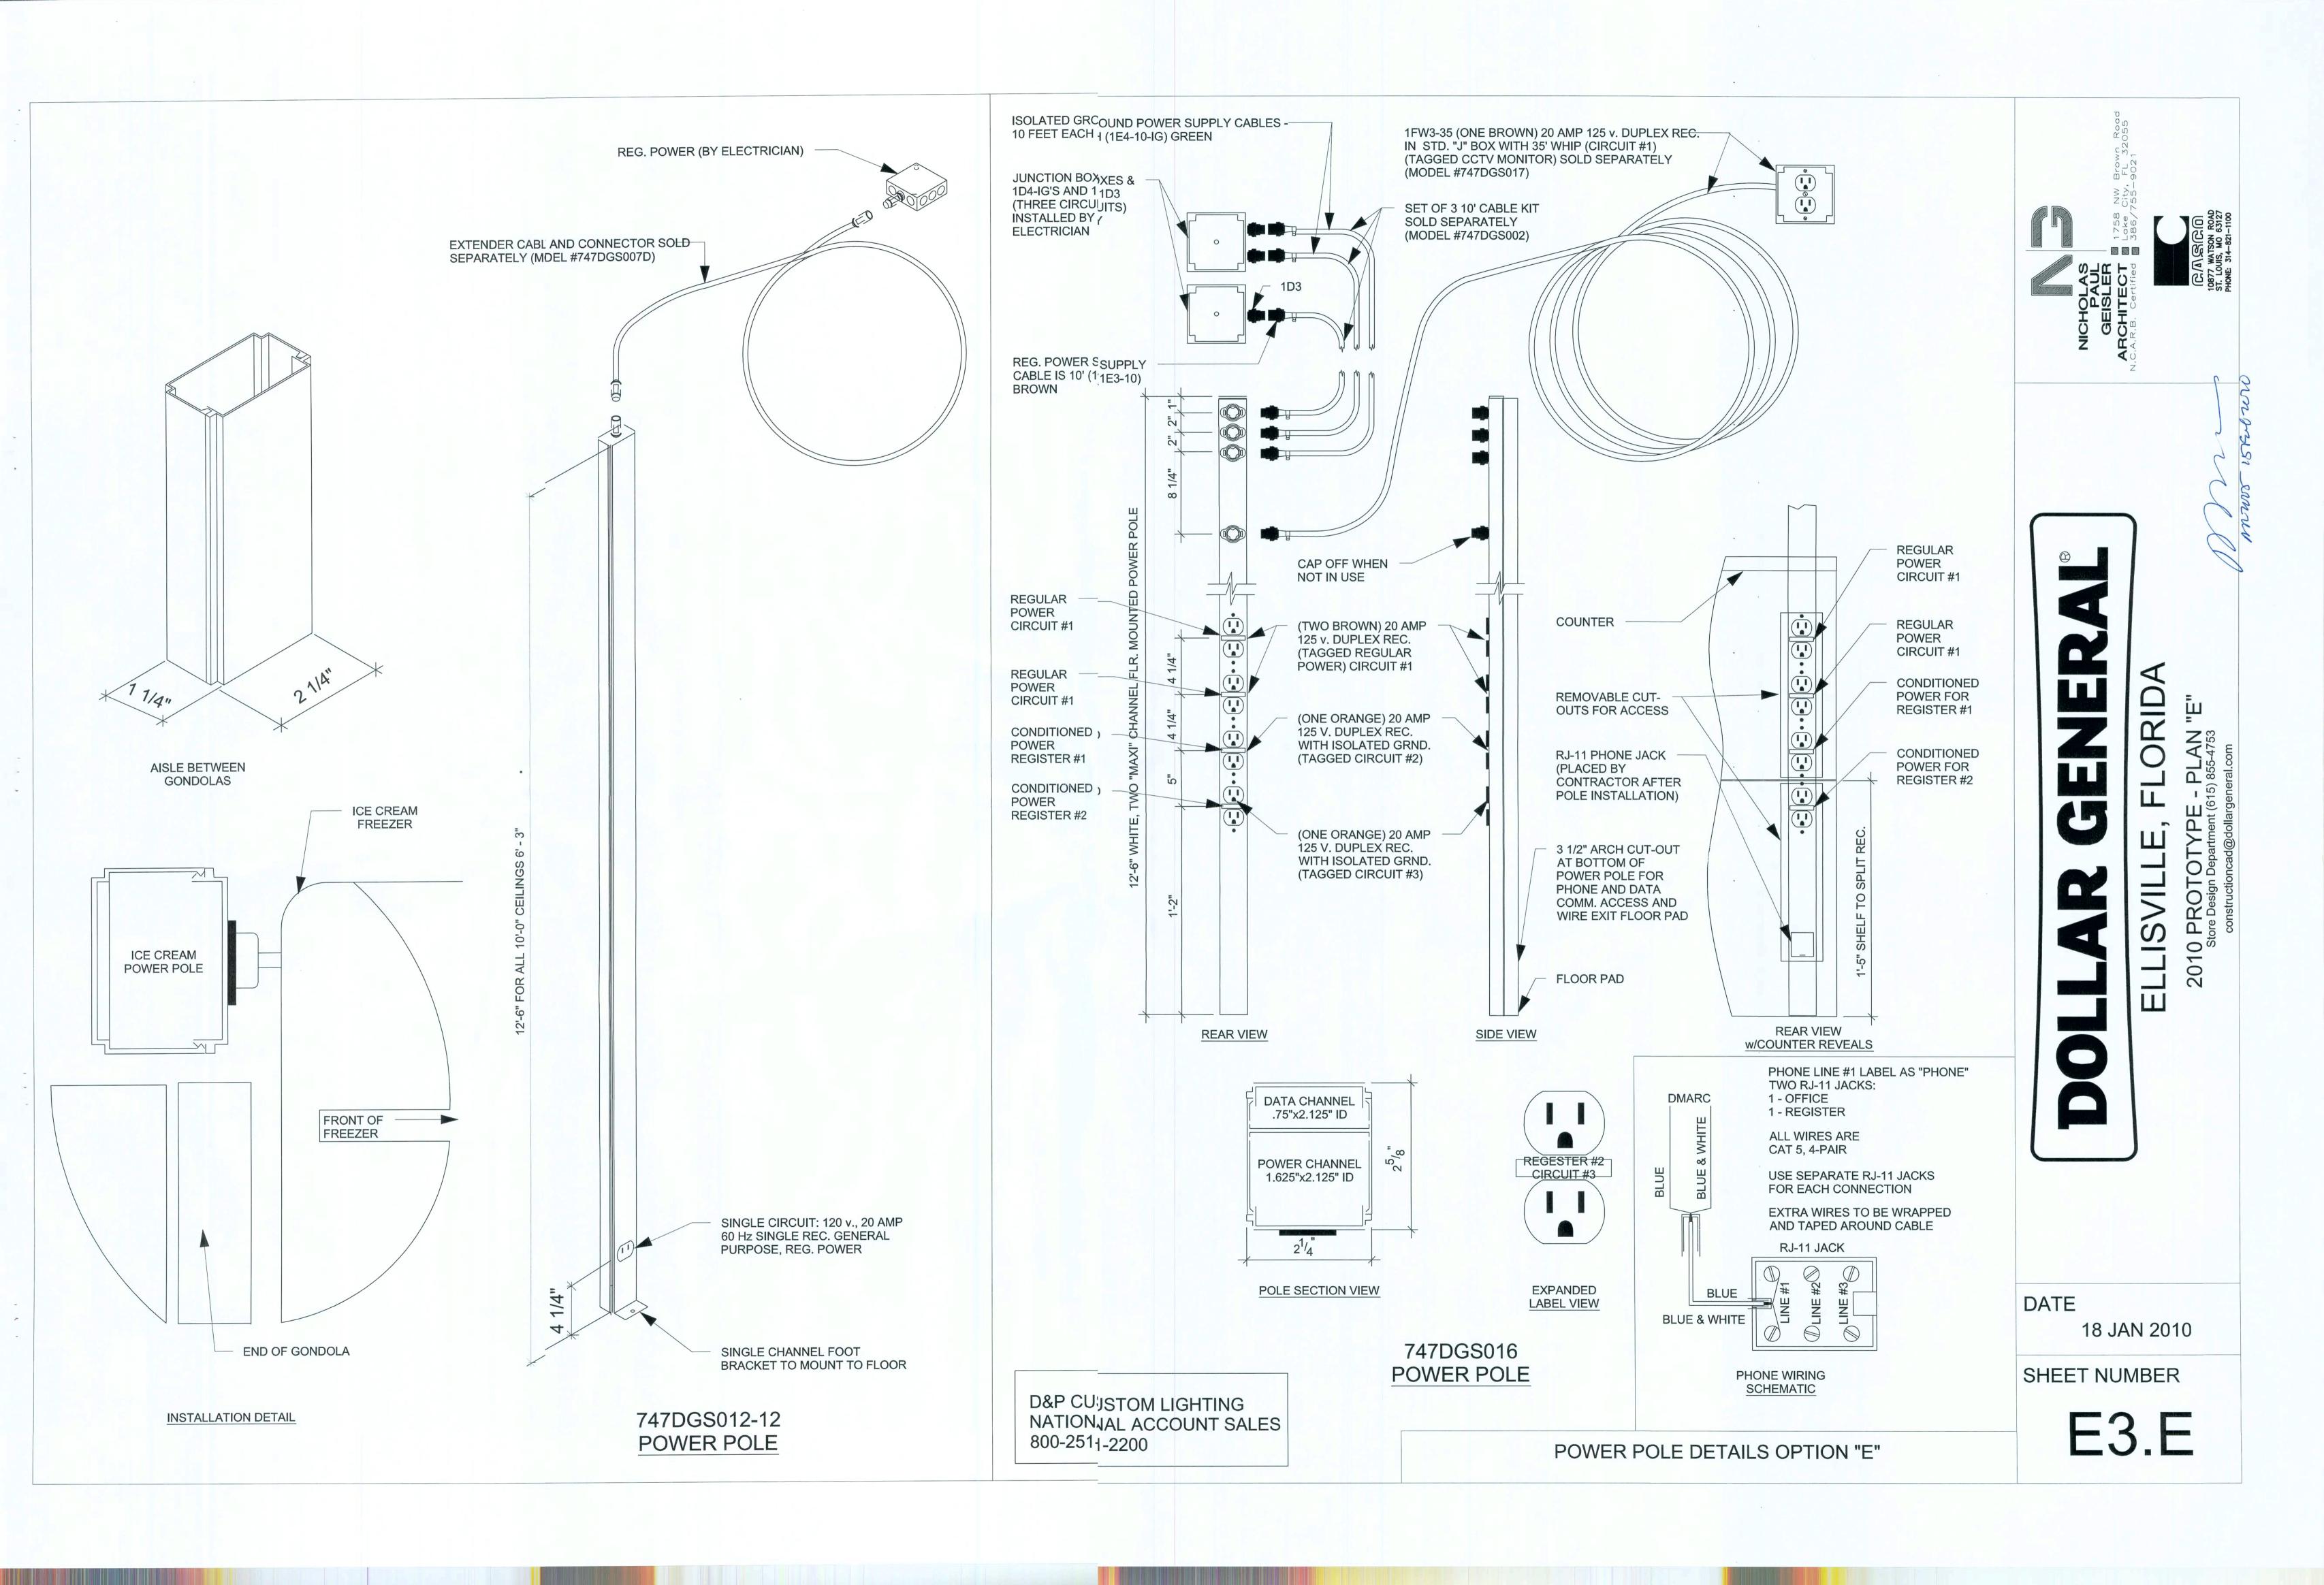

\$202.00

\$68.00

12' Single Channel Ice Crea Pole DRW #854-12 \$115.00 747DGS012-12 747DGS014C \$31.00 1E3-10 Extender Cable & Cnnector for Ice Cream Pole COOLER/FRIEZER POWER POLES Power Pole Description Price D&P Part Number \$184.00 747DGS019 Cable kit for 120 volt cooler \$178.00 747DGS019-12 120 Volt 2 CIR. Cooler pole \$165.00 747DGS020 120/250 Cable kit for cooler

120/250 volt 2 circuit Coole vole with NEMA L1420 connection

35' Whip Assembly w/J-Box

747DGS020-12

747DGS017

**D&P CUSTOM LIGHTING** NATIONAL ACCOUNT SALES 800-251-2200

POWER POLE DETAILS OPTION "E"

2010 PROTOTYPE

DATE

FLOOR PAD

18 JAN 2010

SHEET NUMBER

E4.E

| FLUS |                          |            | LOAD         | SKW          |            |  | СКТ |
|------|--------------------------|------------|--------------|--------------|------------|--|-----|
| CKT  | DESCRIPTION              |            | AØ           | BØ           |            | DESCRIPON  | #   |
| 1    | 10/40/4                  | 80         | 180<br>5040  |              | $\bigcirc$ | SPAR   | 2   |
| 3    | HVAC-1                   | $\bigcirc$ |              | 900          | $\cap$     | BUILDINGIGN  | 4   |
| 5    | 10/400                   | 80         | 900          |              | $\cap$     | PYLON SN TO THE PARTY OF THE PA | 6   |
| 7    | HVAC-2                   | $\bigcirc$ |              | 860<br>5040  | $\cap$     | Z. Z. Z. Z. SKTE LICHT OF Z.   | 8   |
| 9    | 10/400                   | 80         | 860<br>5040  |              | $\cap$     | SITELIGIT  | 10  |
| 11   | HVAC-3                   | $\cap$     |              | 1720<br>5040 | $\cap$     | RIGHT EXTWALLIGHTS   | 12  |
| 13   | 10/4004                  | 80         | 1720<br>5040 |              | $\cap$     | LEFT EXT WALLIGHTS   | 14  |
| 15   | HVAC-4                   | $\bigcirc$ |              | 293<br>5040  | $\cap$     | FRONT EXT WALCANOPY LIGHTS.  | 16  |
| 17   | SPARE                    | $\cap$     | 860          |              | $\cap$     | SPAR-ANTINATION  | 18  |
| 19   | SPARE                    | $\cap$     |              | 860<br>540   | $\cap$     | - SPAR   | 20  |
| 21   | AUTOMATIC DOOR           | $\cap$     | 1290         |              | $\cap$     | EXTERIOR DUX / DAWN  | 22  |
| 23   | POWER POLE SHARED        |            |              | 1220<br>1000 | $\cap$     | COOLE#1  | 24  |
| 25   | POWER POLE 1 CKT. 1      | $\cap$     | 1220<br>360  |              | $\cap$     | COOLE#2  | 26  |
| 27   | POWER POLE 1 CKT. 2      | $\bigcirc$ |              | 1620<br>180  | $\cap$     | FREEZR   | 28  |
| 29   | POWER POLE 2 CKT. 3      | $\cap$     | 1620<br>360  |              |            |  | 30  |
| 31   | POWER POLE 2 CKT, 4      | $\cap$     |              | 1220         | $\cap$     | FUTURE COLER   | 32  |
| 33   | ICE CREAM POWER POLE     | $\cap$     | 900          |              | $\cap$     | BUILDINGIGN  | 34  |
| 35   | DRINKING FOUNTAIN        | $\cap$     |              | 540          | $\cap$     | SPAR   | 36  |
| 37   | OUTDOOR ICE MERCHANDISER | ? _        | 800          |              | $\cap$     | SPAR   | 38  |
| 39   | OUTDOOR DRINK VENDING    | $\cap$     |              | 9140<br>1200 | 100        | PANEB  | 40  |
| 41   | OUTDOOR HVAC REC.        | $\bigcirc$ | 9990         | )            | $\cap$     | FAINED   | 42  |

# PANEL A NOTES:

1) ALL BREAKERS 20/1 UNO

2) PANEL A TO BE SERVICE ENTRANCE RATED WITH AIC RATING OF 22K MINIMU.


3) BREAKERS FOR HVAC UNITS SHALL BE SIZED PER MANUFACTURER REQUIRMENTS.

5) BREAKERS SERVICING LIGHTS TO BE SWITCHING DUTY AND HID RATED.

6) MAIN CIRCUIT BREAKER SHALL BE RATED FOR 100 % CONTINUOUS LOAD.

7) CIRCLED CIRCUIT DENOTES BREAKER LOCKS

8) SHADED CIRCUIT DENOTES ROUTING TO EMS SYSTEM

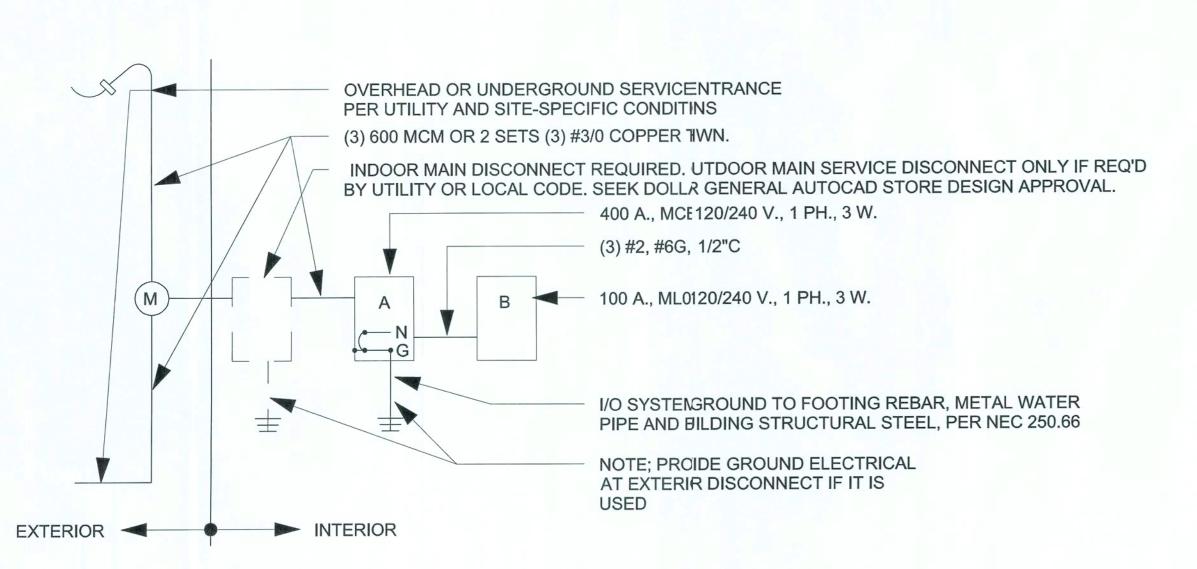

ELECTRICAL PANEL SCHEMATIC E5.E N.T.S.

| SUR<br>FLU | FACE PANEL<br>SH              | В      | 120/2             | 40 V, 1∅,    | 3W, 1  | MLO MCB                            |    |
|------------|-------------------------------|--------|-------------------|--------------|--------|------------------------------------|----|
| CKT        | DESCRIPTION                   |        |                   | S KW         |        | DESCRIPTION                        | CK |
| 1          | EMERGENCY/EXIT LIGHTS         | $\cap$ | AØ<br>180<br>3350 | BØ           | $\cap$ | TELEPHONE BOARD                    | 2  |
| 3          | RESTROOM LIGHTS               | $\cap$ |                   | 180          | $\cap$ | ENERGY MANAGEMENT                  | 4  |
| 5          | SALES LIGHTS ROW 14 & ENTRY   | $\cap$ | 1(1080            |              | $\cap$ | SECURITY OUTLETS                   | 6  |
| 7          | SALES LIGHTS ROW 10 & 12      | $\cap$ |                   | 540<br>780   |        | OFFICE OUTLETS                     | 8  |
| 9          | SALES LIGHTS ROW 8 & 11       | $\cap$ | 540<br>16680      |              |        | BREAK ROOM OUTLETS                 | 10 |
| 11         | SALES LIGHTS ROW 7.8 9        | $\cap$ |                   | 720<br>840   |        | LEFT SIDE SALES & RECEVING OUTLETS | 12 |
| 13         | SÁLES LIGHTS ROW 4 & 6        | $\cap$ | 7780 360          |              |        | RIGHT SIDE SALES OUTLETS           | 14 |
| 15         | SALES LIGHTS ROW 2.8.5        | $\cap$ |                   | 1250<br>1680 | 20     | WATER HEATER AT RESTROOMS          | 16 |
| 17         | SALES LIGHTS ROW 1-8-3        |        | 7 <sub>780</sub>  |              |        | WATER HEATER AT RESTROOMS          | 18 |
| 19         | SALES LIGHTS BACK ROW         | $\cap$ |                   | 1250<br>720  | 20     | MATER HEATER AT RECIEVING          | 20 |
| 21         | SALES RIGHT PERIMETER LIGHTS. |        | 1250<br>14200     |              |        | WATER HEATER AT RECIEVING          | 22 |
| 23         | RECEIVING LIGHTS/NIGHT LIGHTS | $\cap$ |                   | 260          |        | SPARE                              | 24 |
| 25         | SPARE                         | $\cap$ | -                 |              |        | SPARE                              | 26 |
| 27         | SPARE                         | $\cap$ |                   |              | $\cap$ | SPARE                              | 28 |
| 29         | SPARE                         |        |                   |              |        | SPARE                              | 30 |

PANEL B NOTES:

2) ALL BREAKERS 20/1 UNO

3) ALL BREAKERS SWD, HID RATED

1)CIRCLED CIRCUIT DENOTES BREAKER ? LOCKS

5) SHADED CIRCUIT DENOTES ROUTING TO EMS SYSTEM

4) PANEL B SERIES RATED WITH PANEL / A

CONNECTIVE LOAD SUMMATION

INTERIOR LIGHTING = SITE AND SIGN LIGHTING =

10263 VA 3960 VA RECEPTACLE LOAD = HVAC LOAD =

EQUIPMENT LOAD = 17953 VA

11737 VA

TOTAL LOAD =

DATE

18 JAN 2010


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SHEET NUMBER

E5.E

PANEL SCHEDULES OPTION "E"



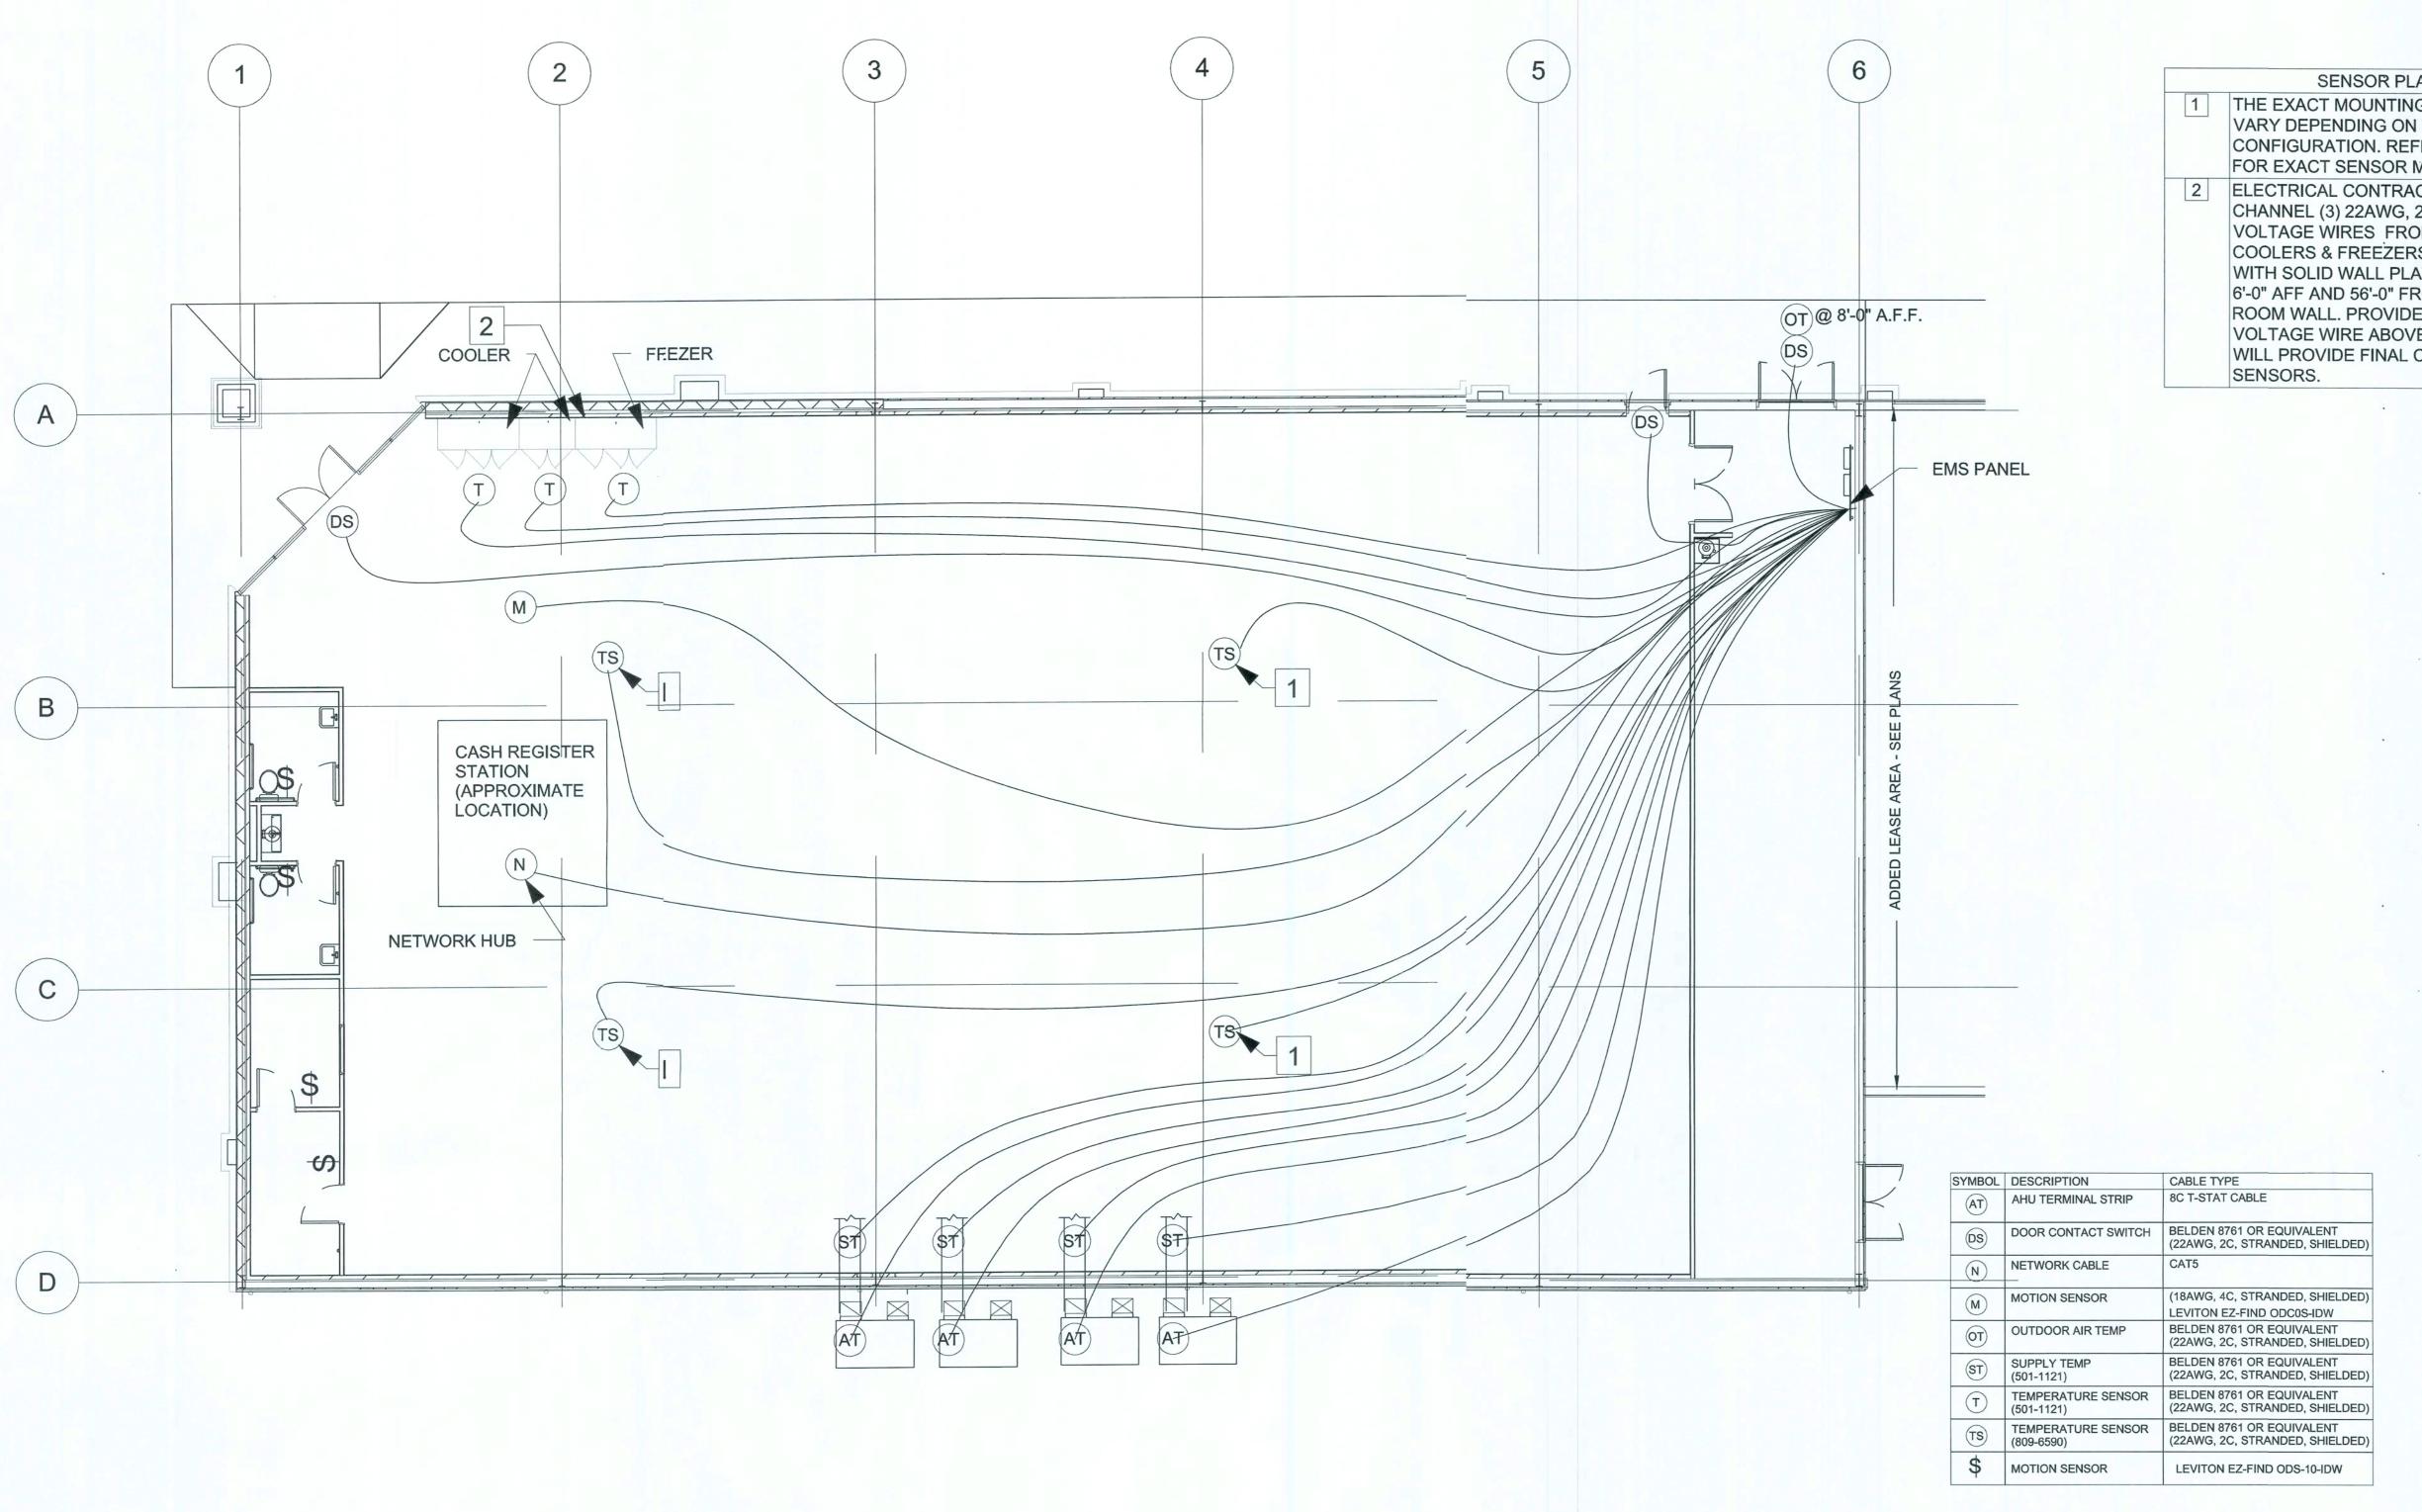

SENSOR PLAN KEYED NOTES

1 THE EXACT MOUNTING LOCATION OF THE SENSOR WILL VARY DEPENDING ON THE STORE LAYOUT AND DUCT CONFIGURATION. REFER TO SITE SPECIFIC DRAWINGS FOR EXACT SENSOR MOUNTING LOCATIONS

ELECTRICAL CONTRACTOR TO INSTALL (1) CONDUIT TO CHANNEL (3) 22AWG, 2C, STRANDED & SHIELDED LOW VOLTAGE WIRES FROM CEILING TO WALL BEHIND COOLERS & FREEZERS AND COVER JUNCTION BOX WITH SOLID WALL PLATE. WALL PENETRATION SHALL BE 6'-0" AFF AND 56'-0" FROM FRONT SALES FLOOR/BREAK ROOM WALL. PROVIDE 20' OF EXTRA COILED LOW VOLTAGE WIRE ABOVE THE CELING. DOLLAR GENERAL WILL PROVIDE FINAL CONNECTIONS TO TEMPEATURE SENSORS.

NICHOLAS
PAUL
GEISLER
ARCHITECT
Lake City, FL 3
N.C.A.R.B. Certified 386/755-9021

2010 PROT store Design L

DATE


18 JAN 2010


SHEET NUMBER

EMS1.E

NOTE: ALL QUESTIONS PERTAINING TO THE EMS PANEL, SYSTEM INSTALLATION & SETUP SHOULD BE DIRECTED TO PETE STEVENS @ EMERSON CLIMATE TECHNOLOGIES PHONE #770-425-2724.

SENSOR LOCATION PLAN OPTION "E"

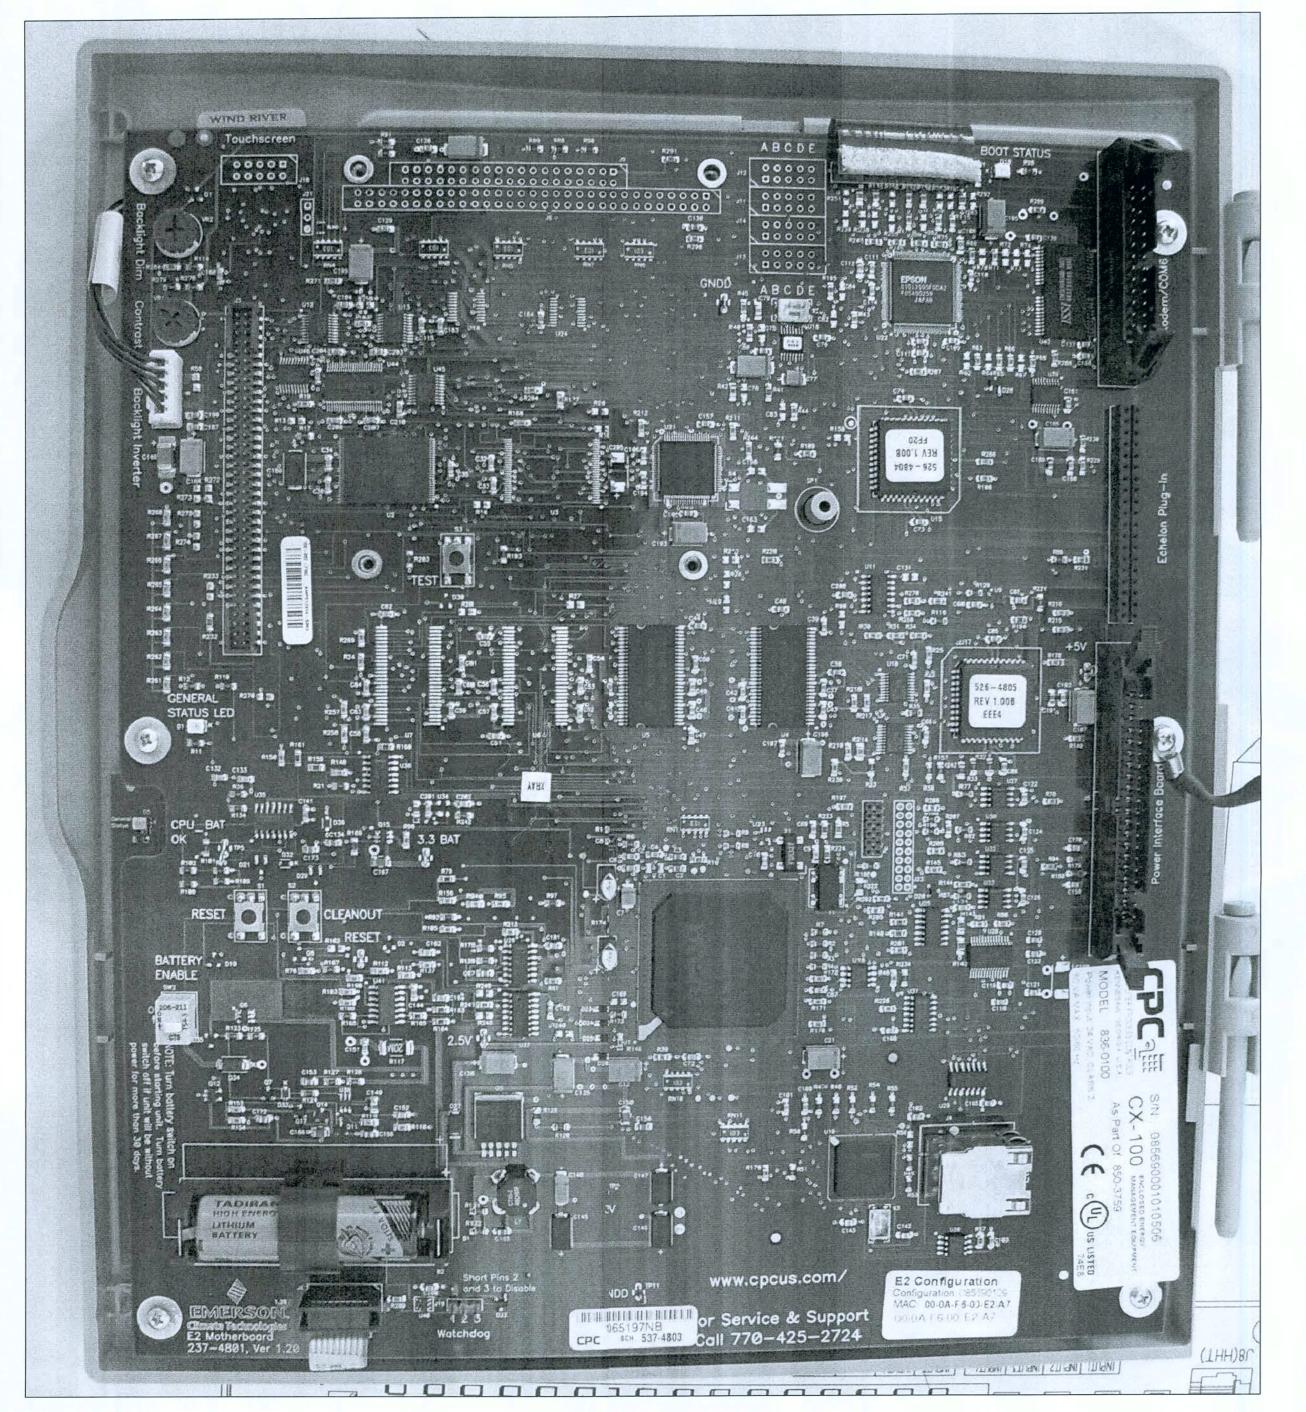

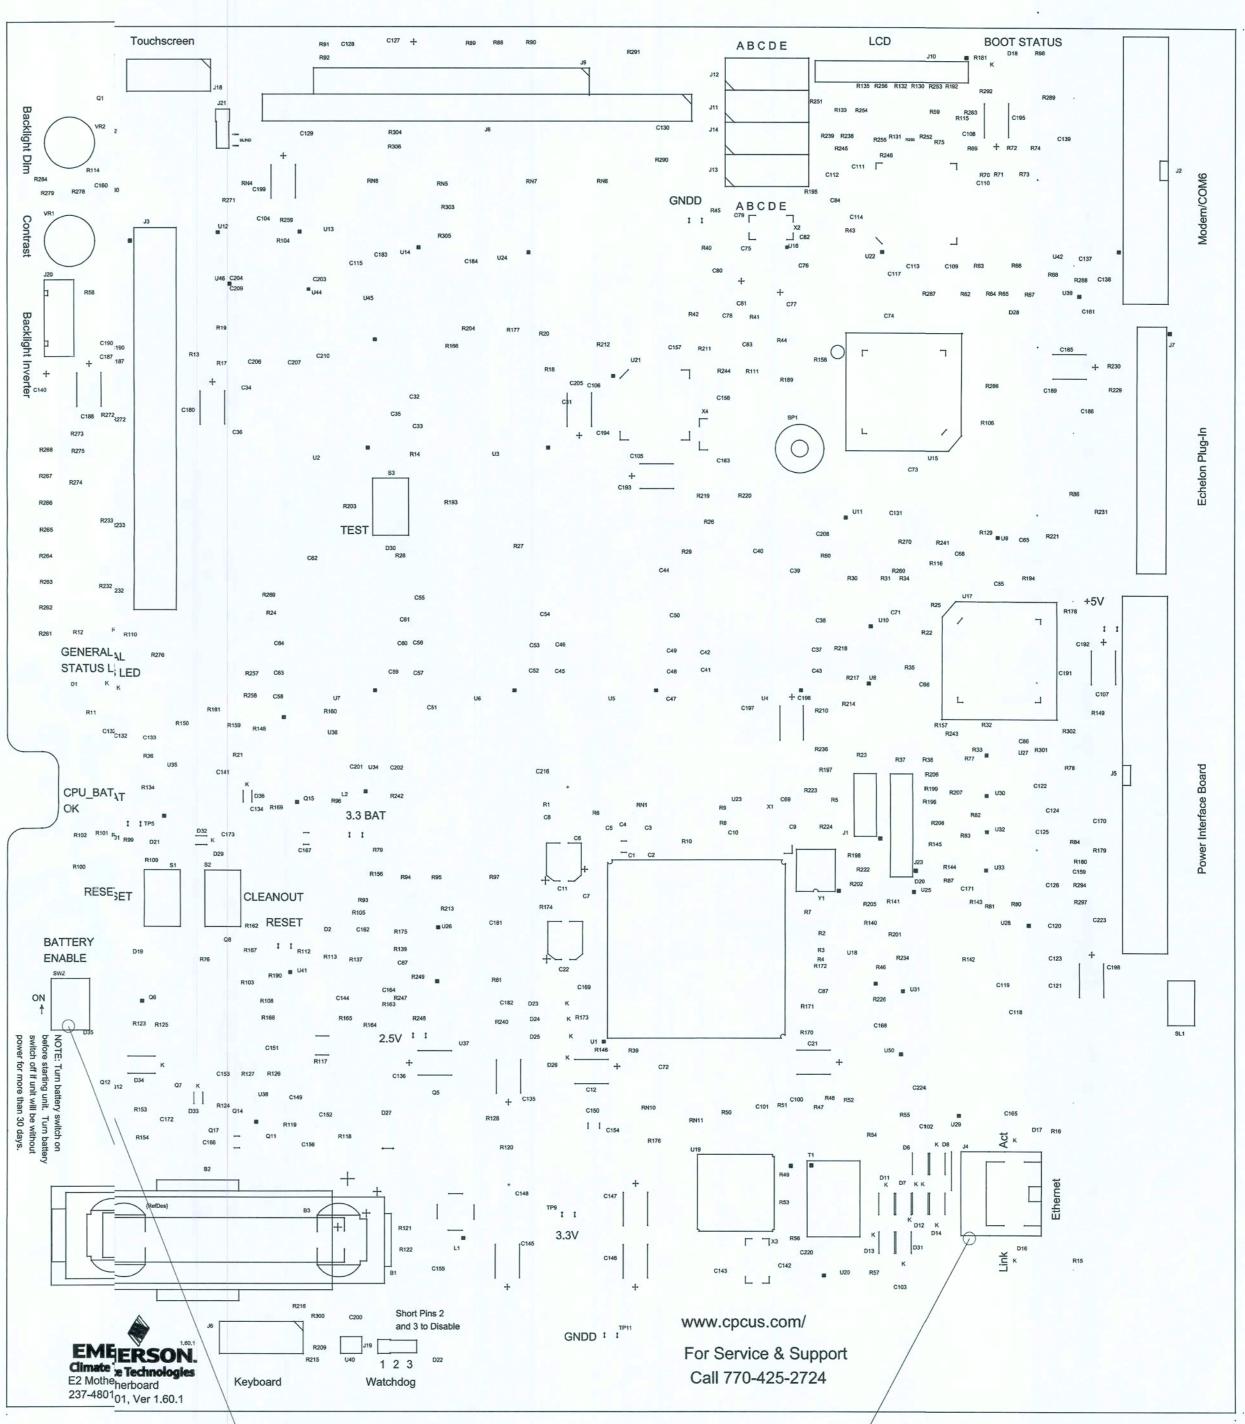

ENSURE THAT THE BATTERY ENABLE IS SWITCHED TO THE "ON" POSITION

VSAT INSTALLER TO CONNECT

CAT5 CABLE FROM SERVER


DATE

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SHEET NUMBER

EMS2.E

CPU TERMINAL DIAGRAM OPTION "E"



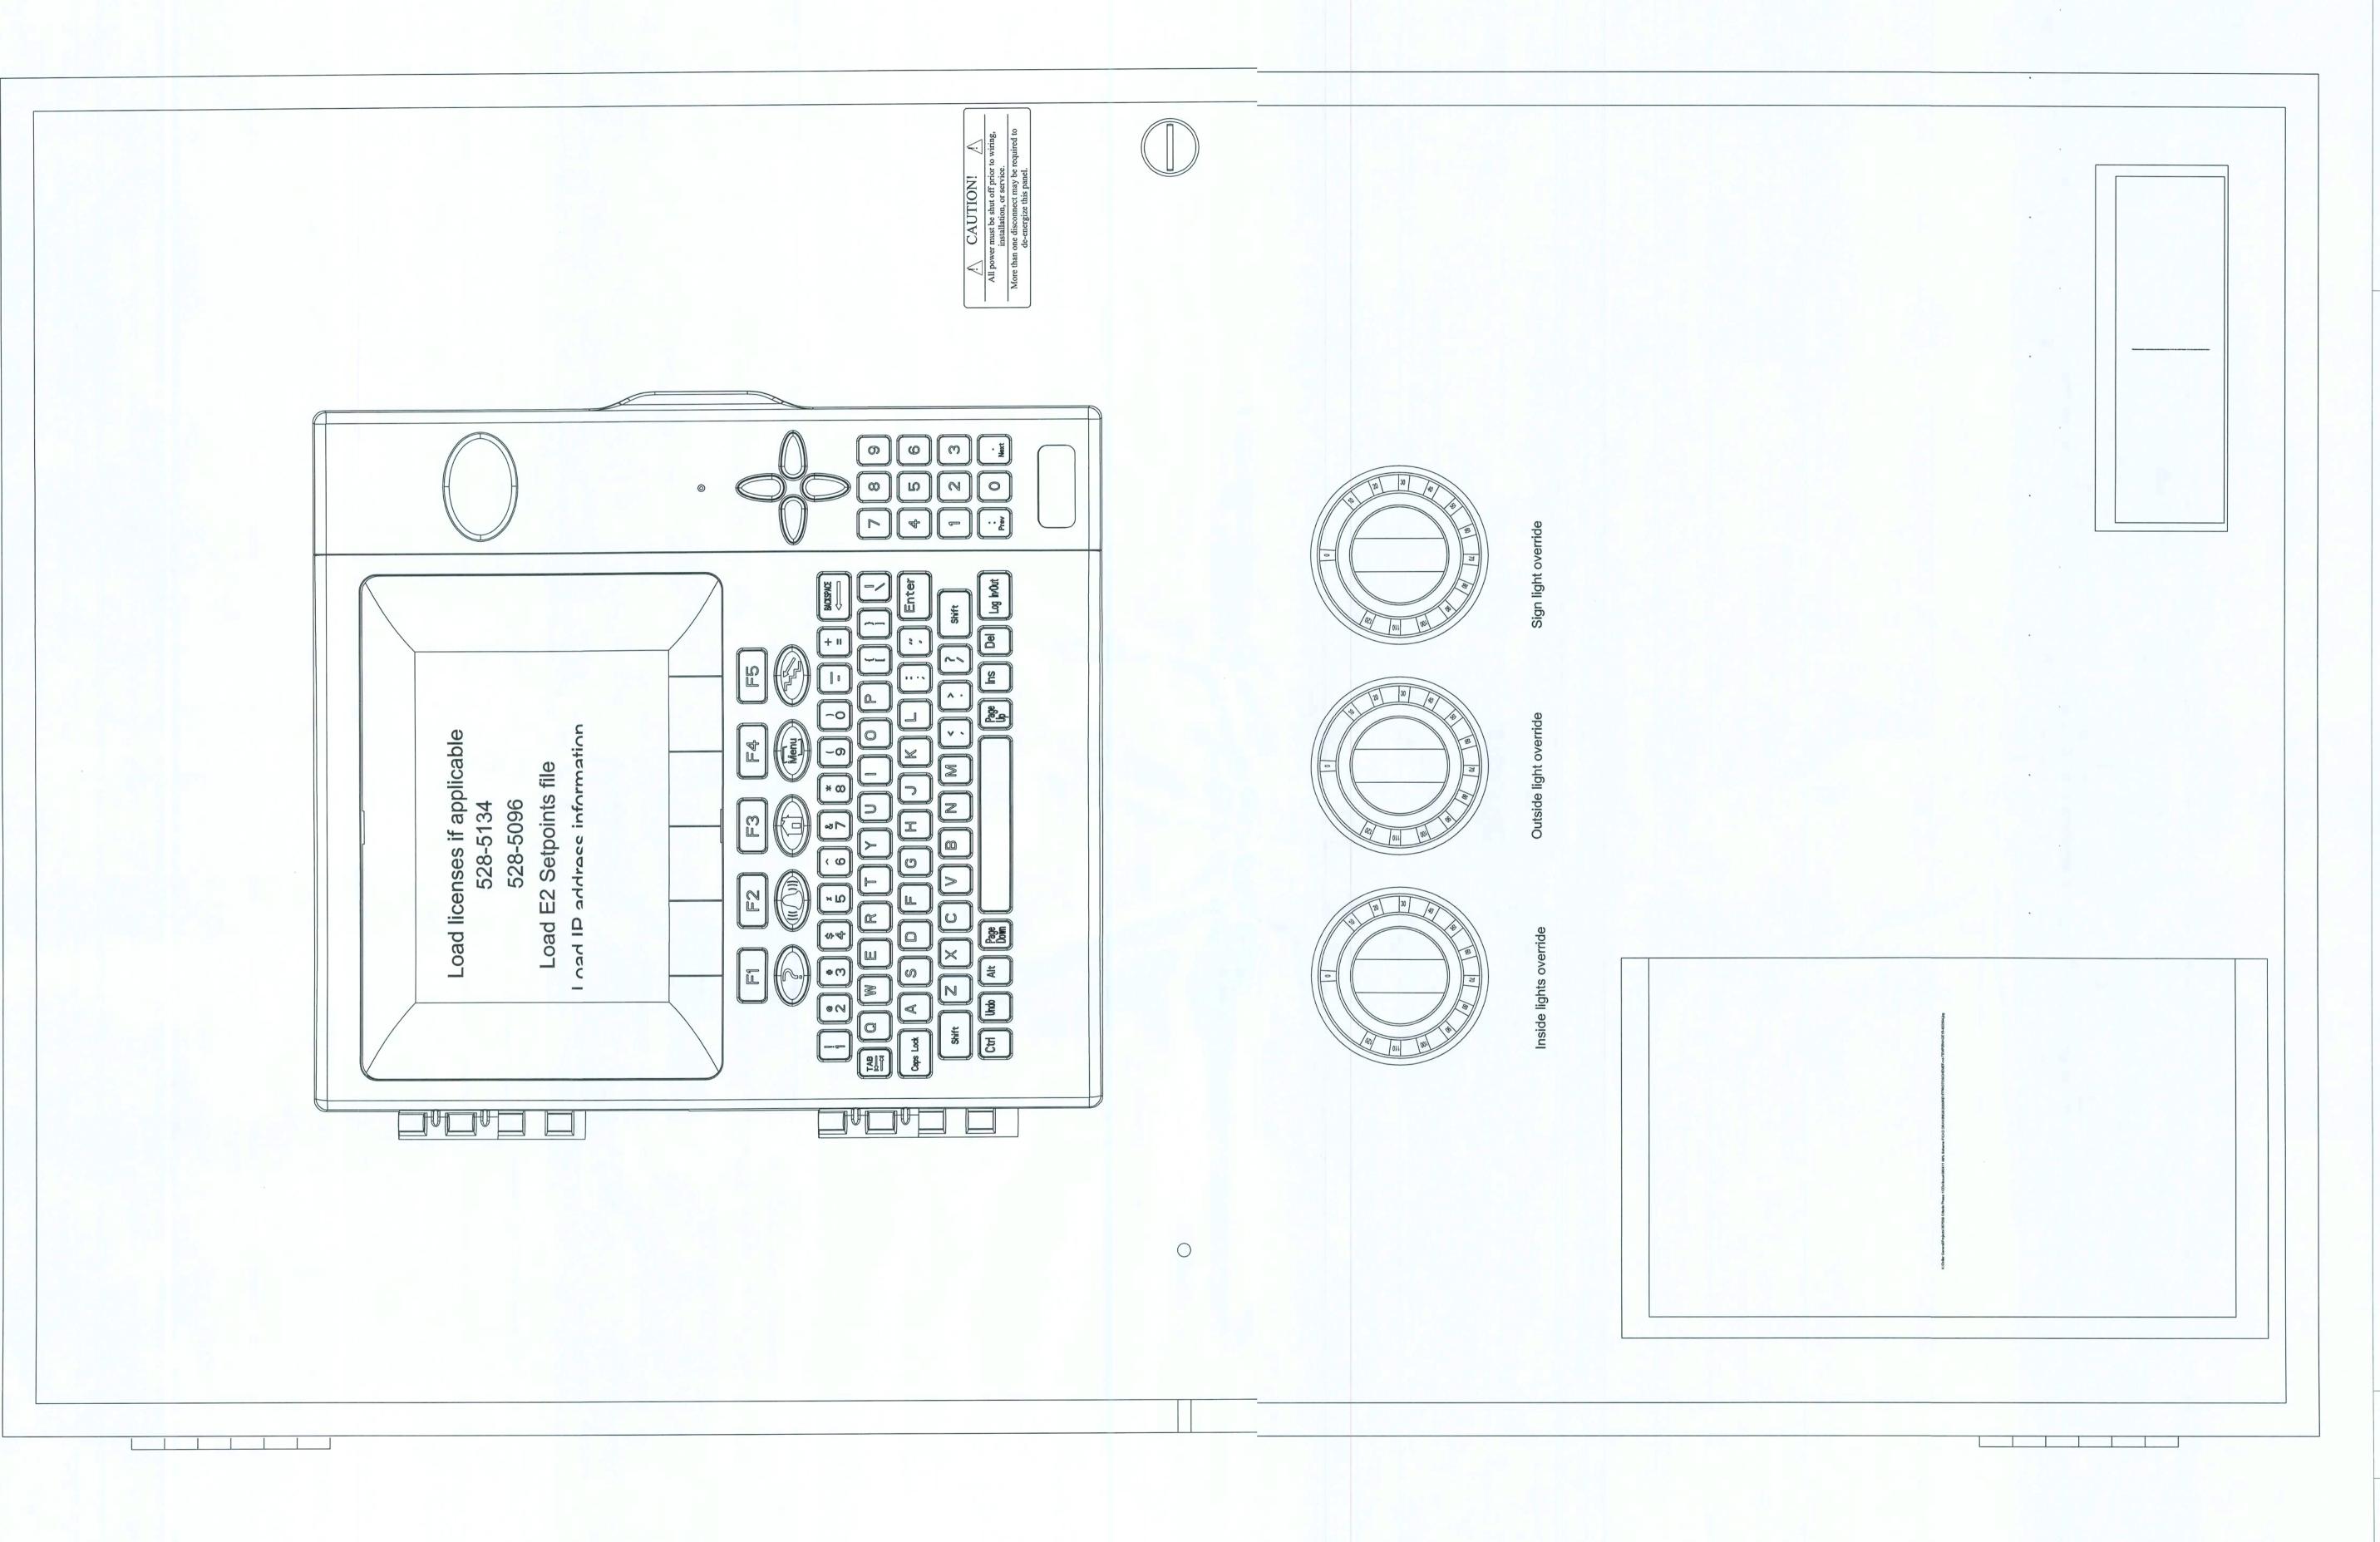


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SHEET NUMBER

EMS3.E

EMS PANEL AND CONTROLS OPTION "E"



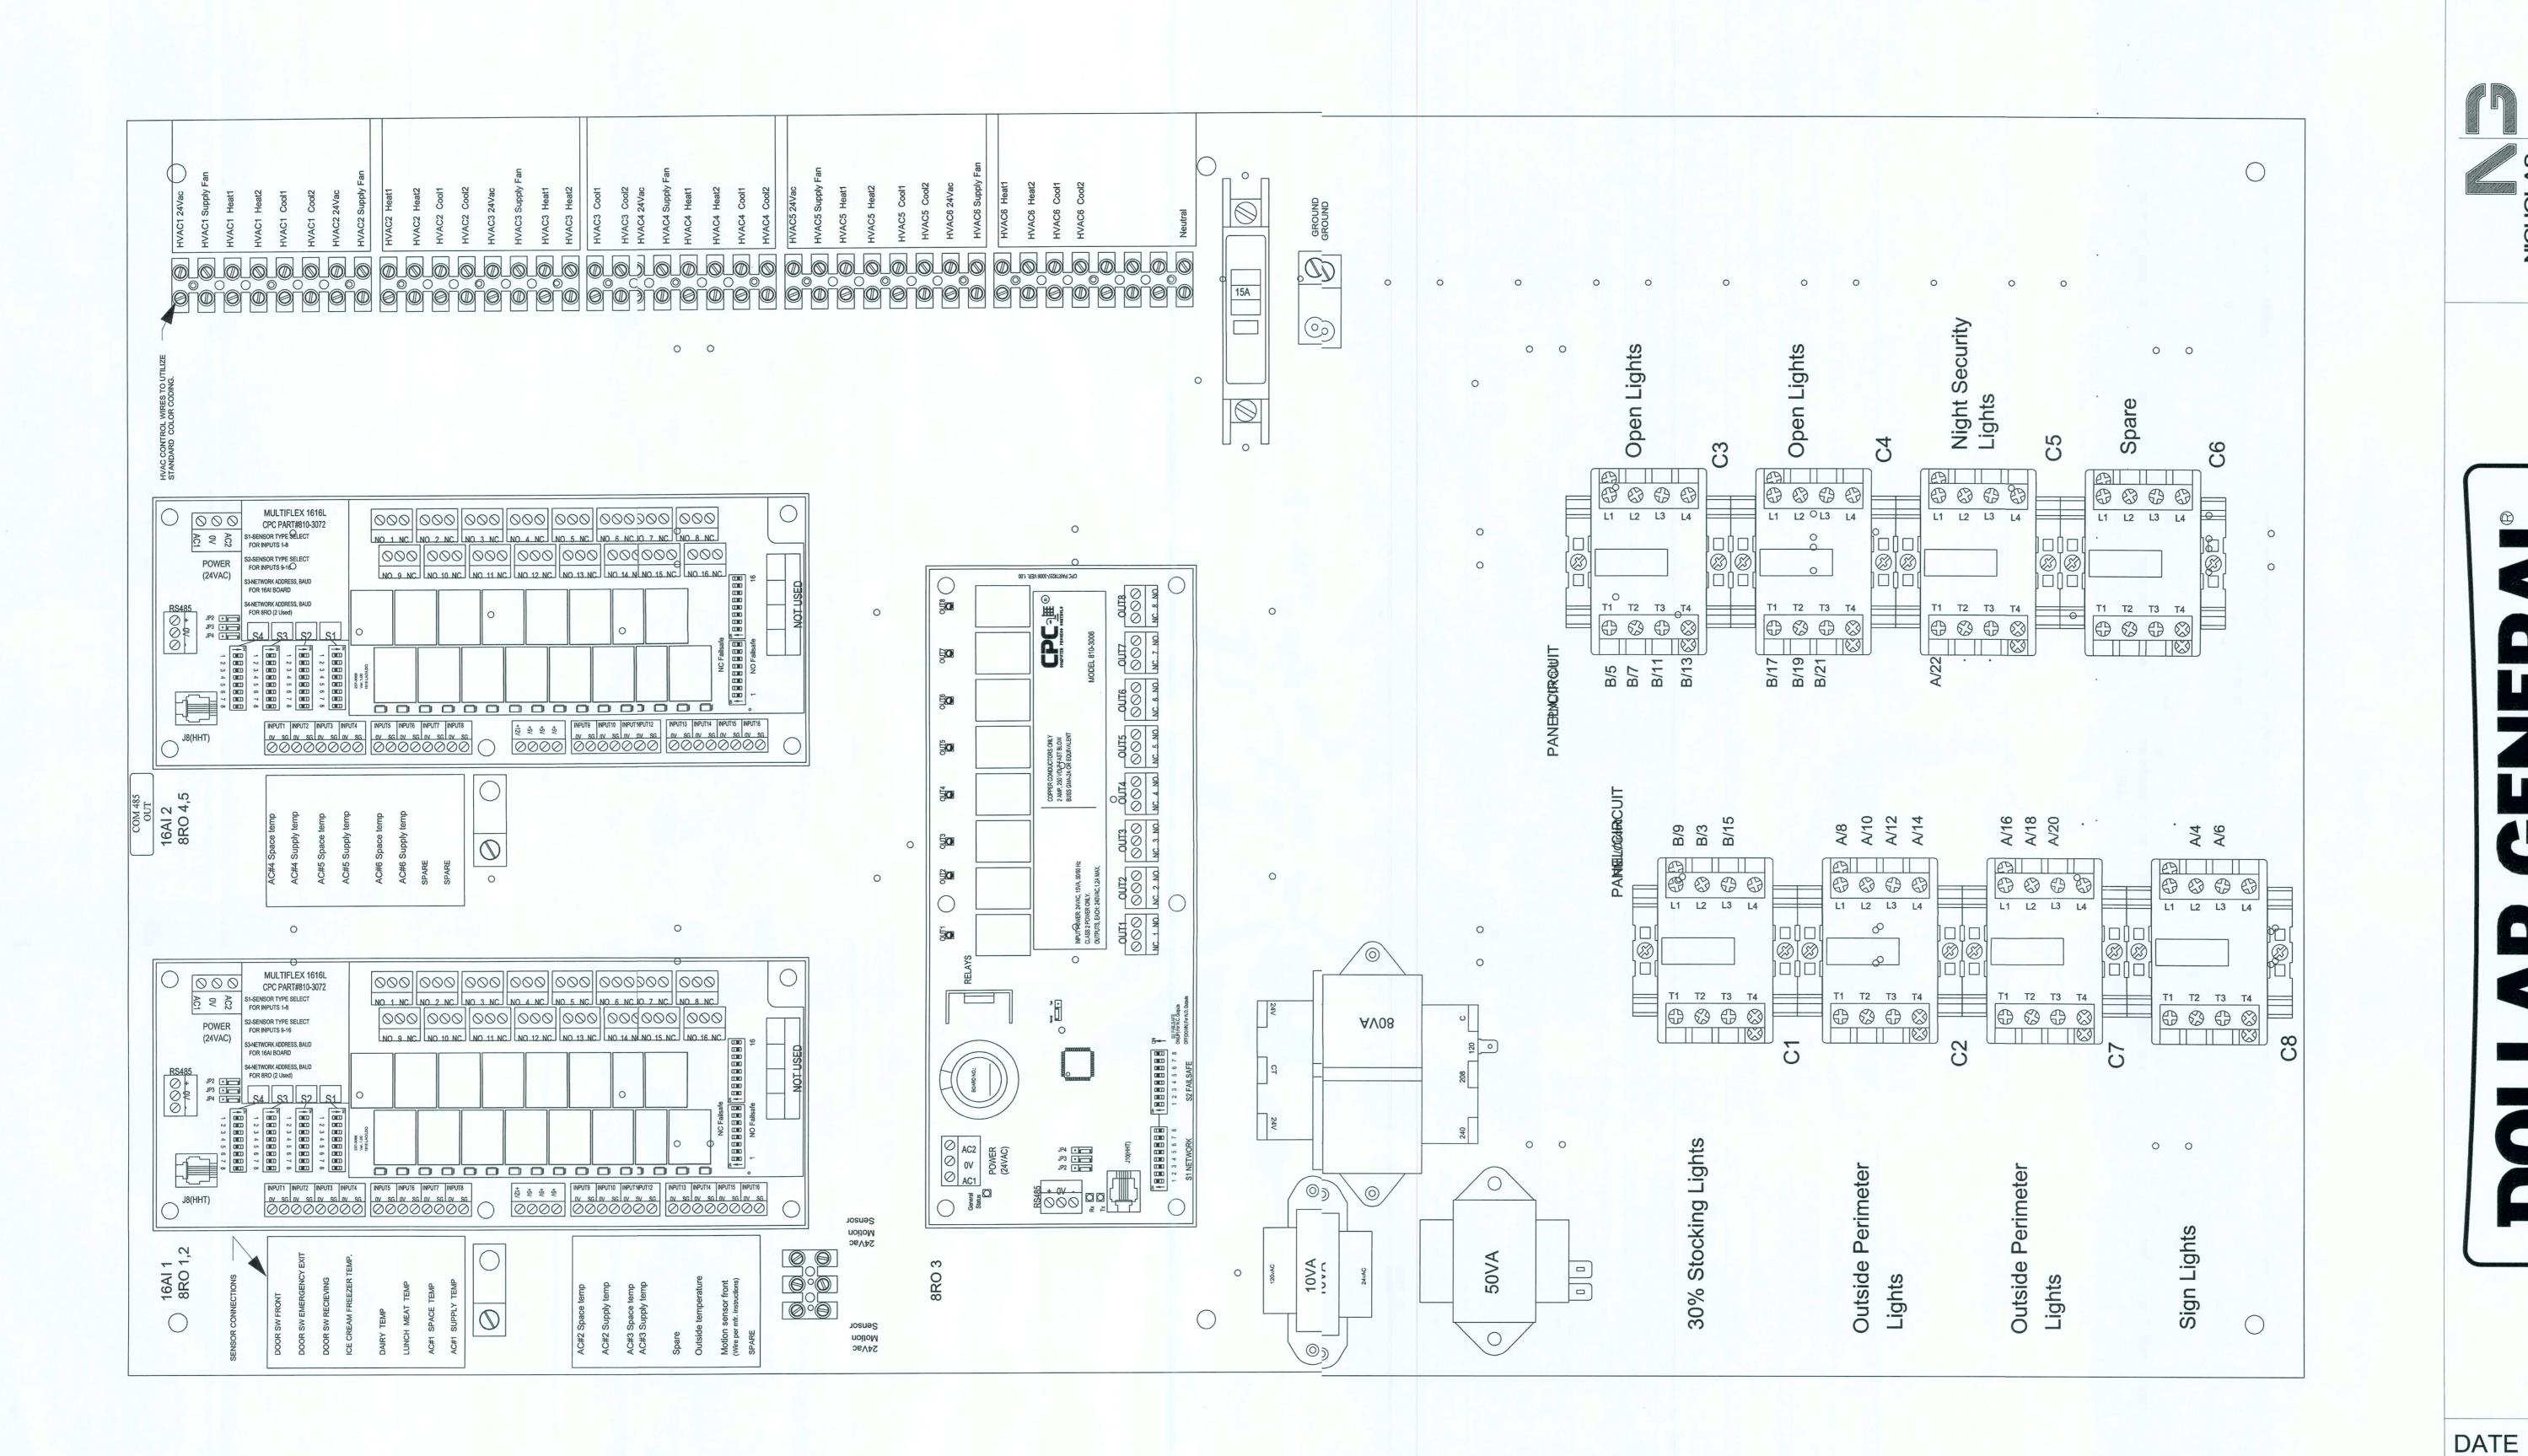

FLORID 2010 PROTOTYPE ELLISVILLE

EMS4.E

SHEET NUMBER

18 JAN 2010

# SITE LIGHTING

1. FINAL SIGN CONNECTION AND UNDERGROUND CONDUIT IS LANDLORD F.SPONSIBILITY. PROVIDE CONDUIT FROM THE ELECTRICAL PANEL TO LOCATION OF THE PYLON SIG BASE. BURY CONDUIT UNDER PARKING AREA. THE CONDUIT IS TO BE 1" AND HAVE ONE SET TO 1/2 WIRE WITH GROUND AND A 20-AMP TWO POLE BREAKER AT THE PANEL. A TEMPORARY 3' TALL STAK SHALL BE PROVIDED TO DESIGNATE THE PYLON SIGN LOCATION UNTIL THE SIGN IS PERMANENTLYNSTALLED. REMOVE POST AFTER SIGN IS INSTALLED.

2. SITE / PARKING LOT LIGHTING: PROVIDE ADEQUATE POLE AND/ OR WALLIGHTING FOR NIGHT VISION AROUND ENTRY, PARKING AND DUMPSTER PAD AREAS

3. MINIMUM OF TWO FOOT-CANDLES REQUIRED FOR ALL PAVED AREAS EXLUDING 15' PERIMETER FROM EDGE OF PAVEMENT.

4. REQUIRED LIGHTING: A COMBINATION OF POLE LIGHTS, BI-DIRECTIONASECURITY LIGHTS AND WALL PACKS WILL BE USED. REFER TO ELECTRICAL SITE PLAN AND SHEET E2.C FOR ADDITIOAL INFORMATION

5. PLEASE NOTE THAT LIGHTING DESIGN AND LAYOUT IS SITE SPECIFIC AN MAY REQUIRE ADDITIONAL LIGHTING TO COMPLY WITH SITE DESIGN CONDITIONS. THEREFORE, MAKIPROVISIONS FOR MORE POLE LIGHTING WHEN A SPECIFIC SITE REQUIRES IT.


6. UNDERGROUND ELECTRICAL SHALL BE PROVIDED TO THE SITE LIGHT DLES.

7. WHERE LOCAL JURISDICTIONS DO NOT ALLOW DOLLAR GENERAL'S REGIRED LIGHTING PLAN, AN ALTERNATE SITE LIGHTING PLAN & PHOTOMETRIC PLAN MUST BE SUBMITTED FOR APROVAL TO THE DOLLAR GENERAL AUTOCAD-STORE PLAN DEPARTMENT.

8. PHOTO METRIC SITE ANALYSIS AVAILABLE THROUGH DOLLAR GENERAL/ENDOR CONSOLIDATED ELECTRICAL DISTRIBUTORS CONTACT ROBERT DECKER AT (270) 781-2229.

9. DOLLAR GENERAL VENDOR PRICING FOR WALL PACKS OR POLE LIGHTIG AVAILABLE FROM CONSOLIDATED ELECTRICAL DISTRIBUTORS. CONTACT ROBERT DECKER T 270-781-2229.

10. SEE SHEET E2.C FOR MORE INFORMATION.

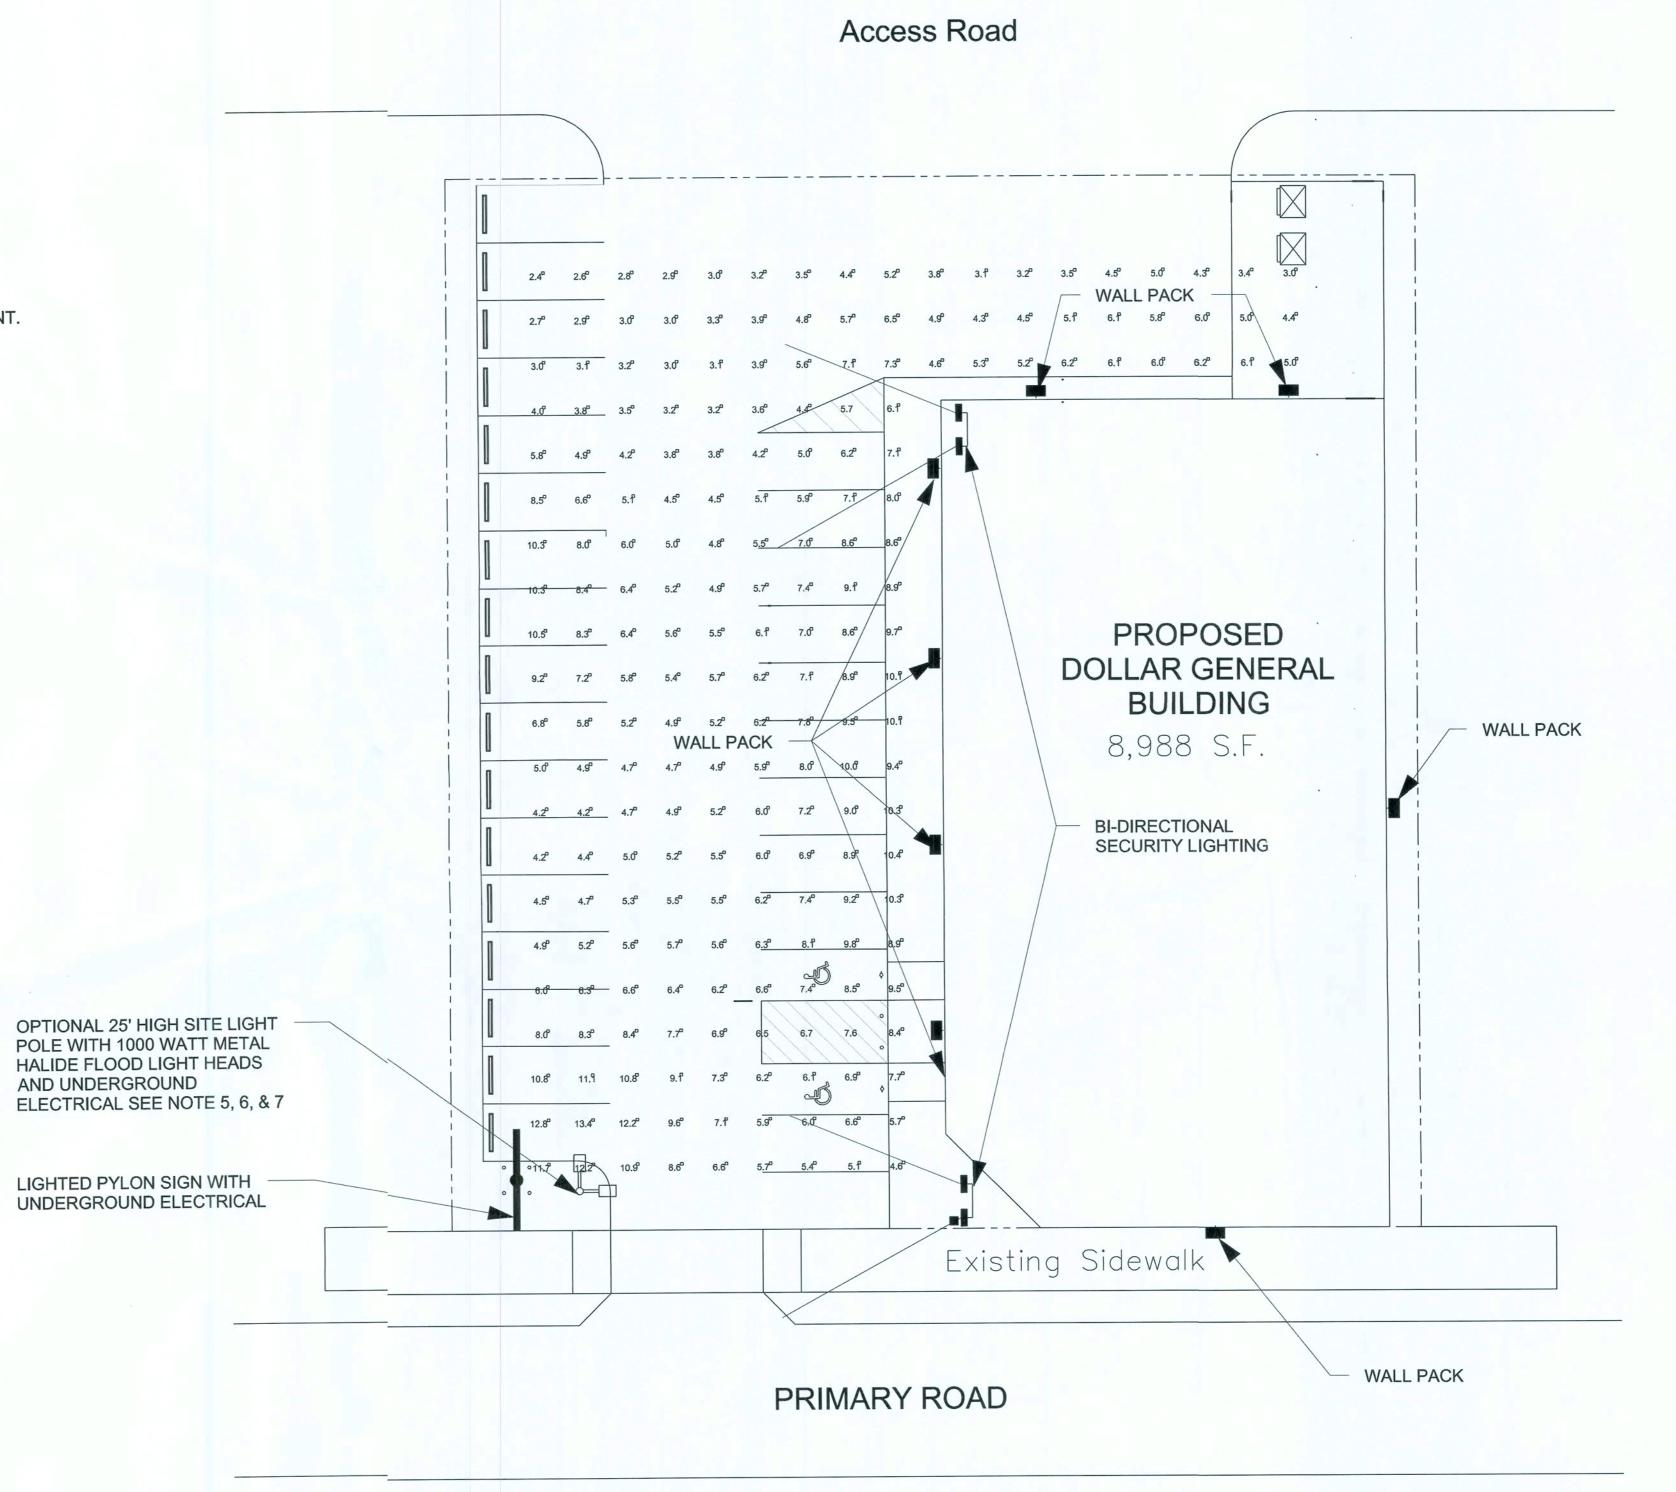

DOLLAR GENERAL®
FILSVILE FLORIDA

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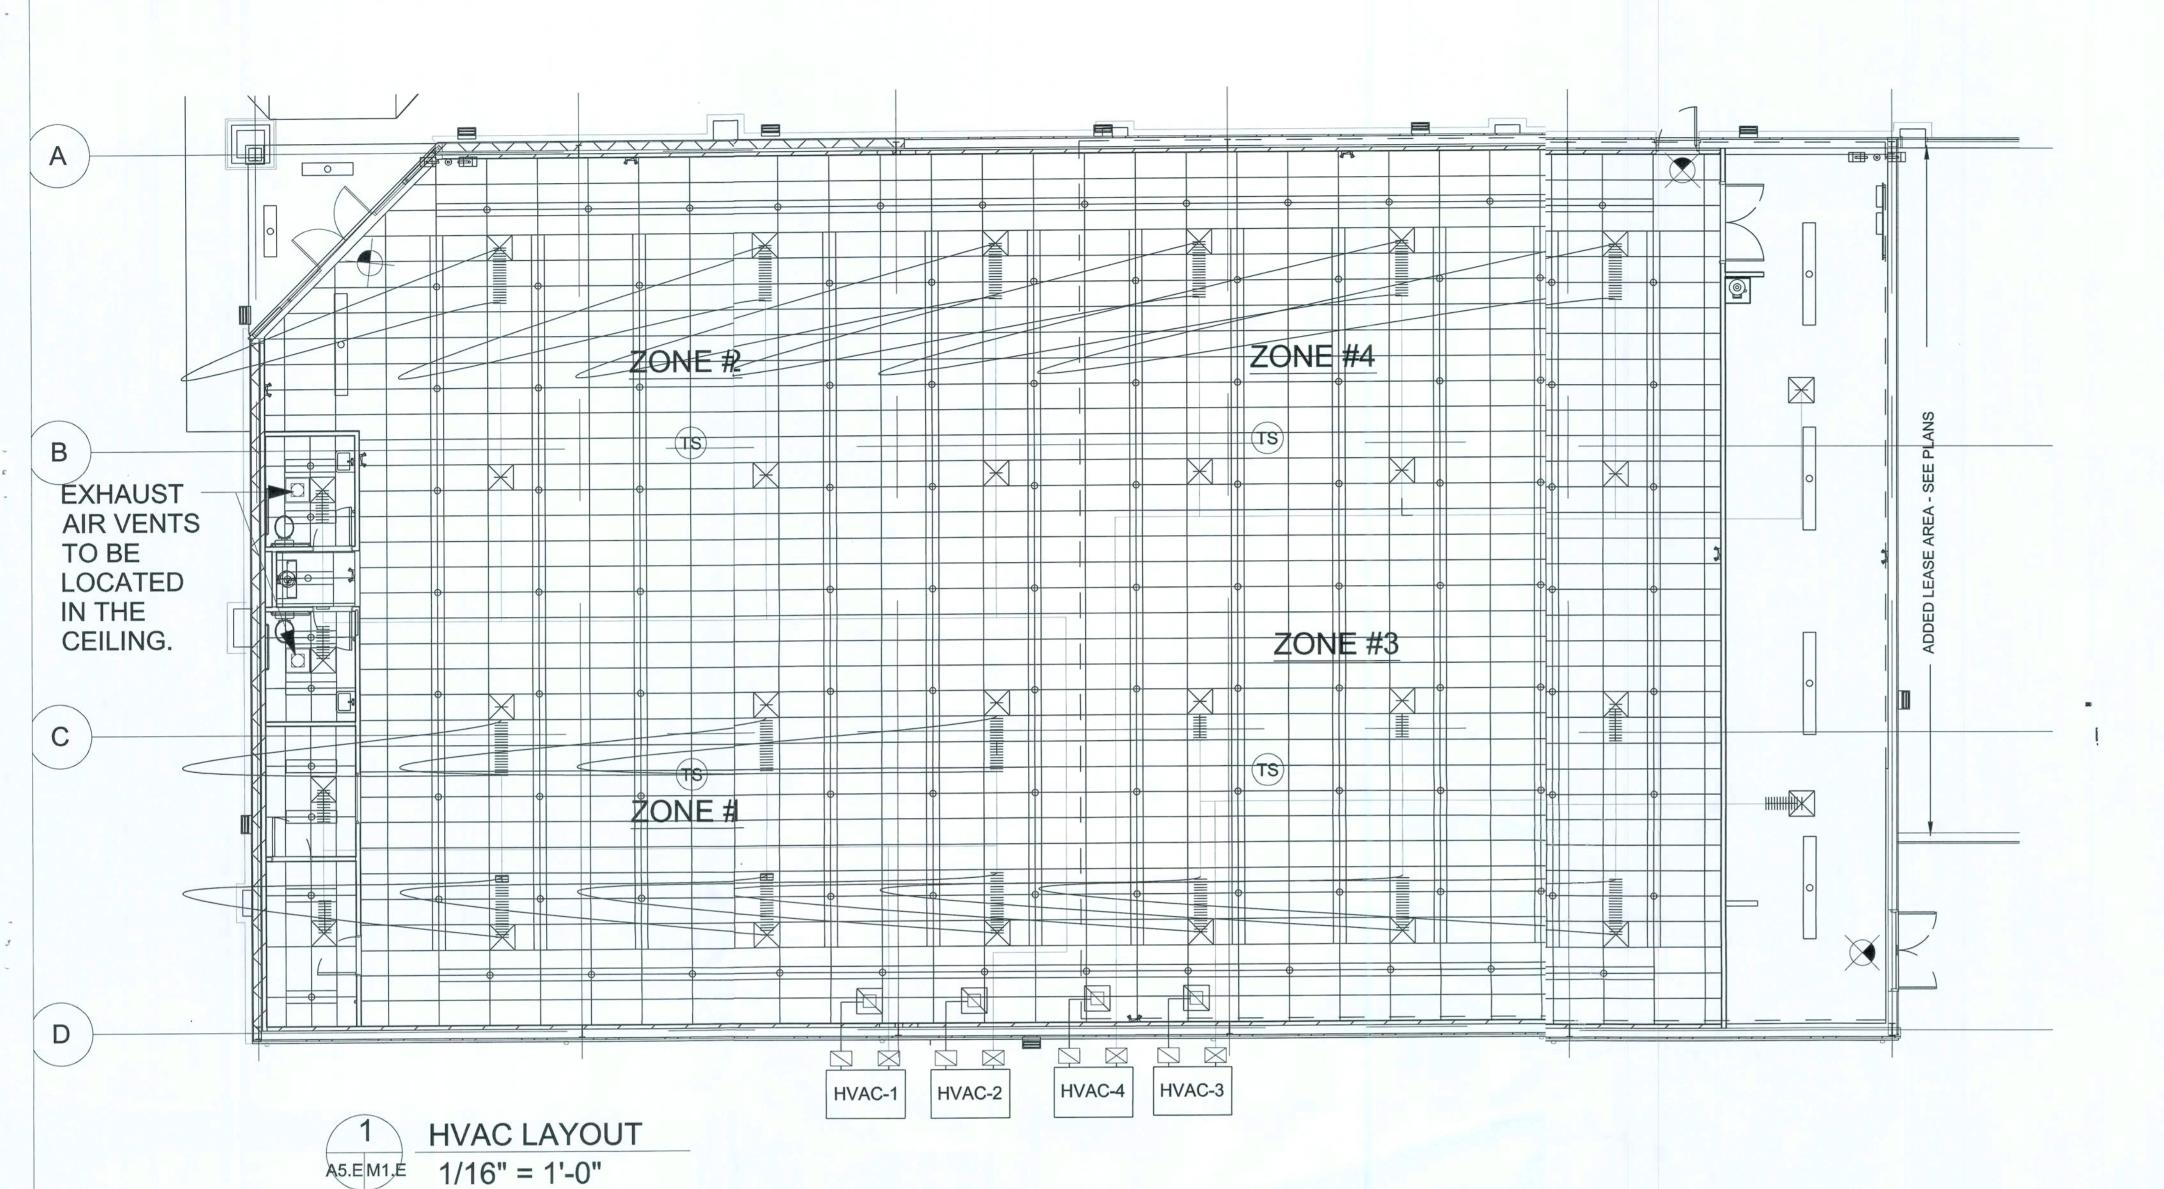
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ES1.E

SHEET NUMBER

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ELECTRICAL SITE LIGHTING PLAN OPTION "E"



NOR' CARR

LENN LOW GAS PR

ELECTRIC A

SOUTH LENNOX

(ELECTRIC PREFERREI LOW GAS ALLOWED)

OR

NOTE: IF PROPANE IS USED, TANKS ARE REQUIRED TO BE BURIED.

# **HVAC SPECIFICATIONS**

- 1. REAR, SIDE, OR ROOF MOUNTED SYSTEM, WITH COMPLETE RIGID SQUARE DUCTWORK, CONFORMING TO ASHRAE SPECIFICATIONS IN SALES FLOOR, OFFICES, REST ROOM, AND STOCKROOM AREAS.
- 2. ALL DUCTWORK MUST BE ABOVE 10'-6" A.F.F.
- 3. FOR HVAC SENSOR LOCATIONS SEE EMS1.D SHEET
- 4. CARRIER AND/OR LENNOX PACKAGED H.V.A.C. SYSTEMS ARE REQUIRED.
- 5. PROVIDE INLINE EXHAUST FAN FOR RESTROOM AREAS, INTERLOCK W/ RESTROOM LIGHTS.
- 6. UNITS SHALL BE PLACED UPON ADEQUATE SIZED, ELEVATED CONCRETE PADS. SEE SHEET S1.D FOR DETAILS.

## SYMBOL LEGEND:

- EXHAUST FAN
- SUPPLY AIR GRILL
  - RETURN AIR GRILL
- TEMPERATURE SENSOR

| TONAGE    | Gas Input              | MODEL NUMBER                         | Breaker                        |
|-----------|------------------------|--------------------------------------|--------------------------------|
|           |                        | WODEL HOWDER                         | Size                           |
| (3) 5 Ton | High Gas               | 48TCFA06A1A3A0A0A0A1-DG              | 60                             |
| (4) 5 Ton | Low Gas                | KGA060S4B-DG                         | 70                             |
| (4) 5 Ton | Electric               | KCA060S4B-DG                         | 80                             |
|           | (4) 5 Ton<br>(4) 5 Ton | (4) 5 Ton Low Gas (4) 5 Ton Electric | (4) 5 Ton Low Gas KGA060S4B-DG |

NOTE: ELEC. UNITS REQUIRE A SINGLE POINT KIT AND 10 KW HEAT STRIP.

ALL UNITS REQUIRE MANUAL OR ECONOMIZER DAMPERS.

E P

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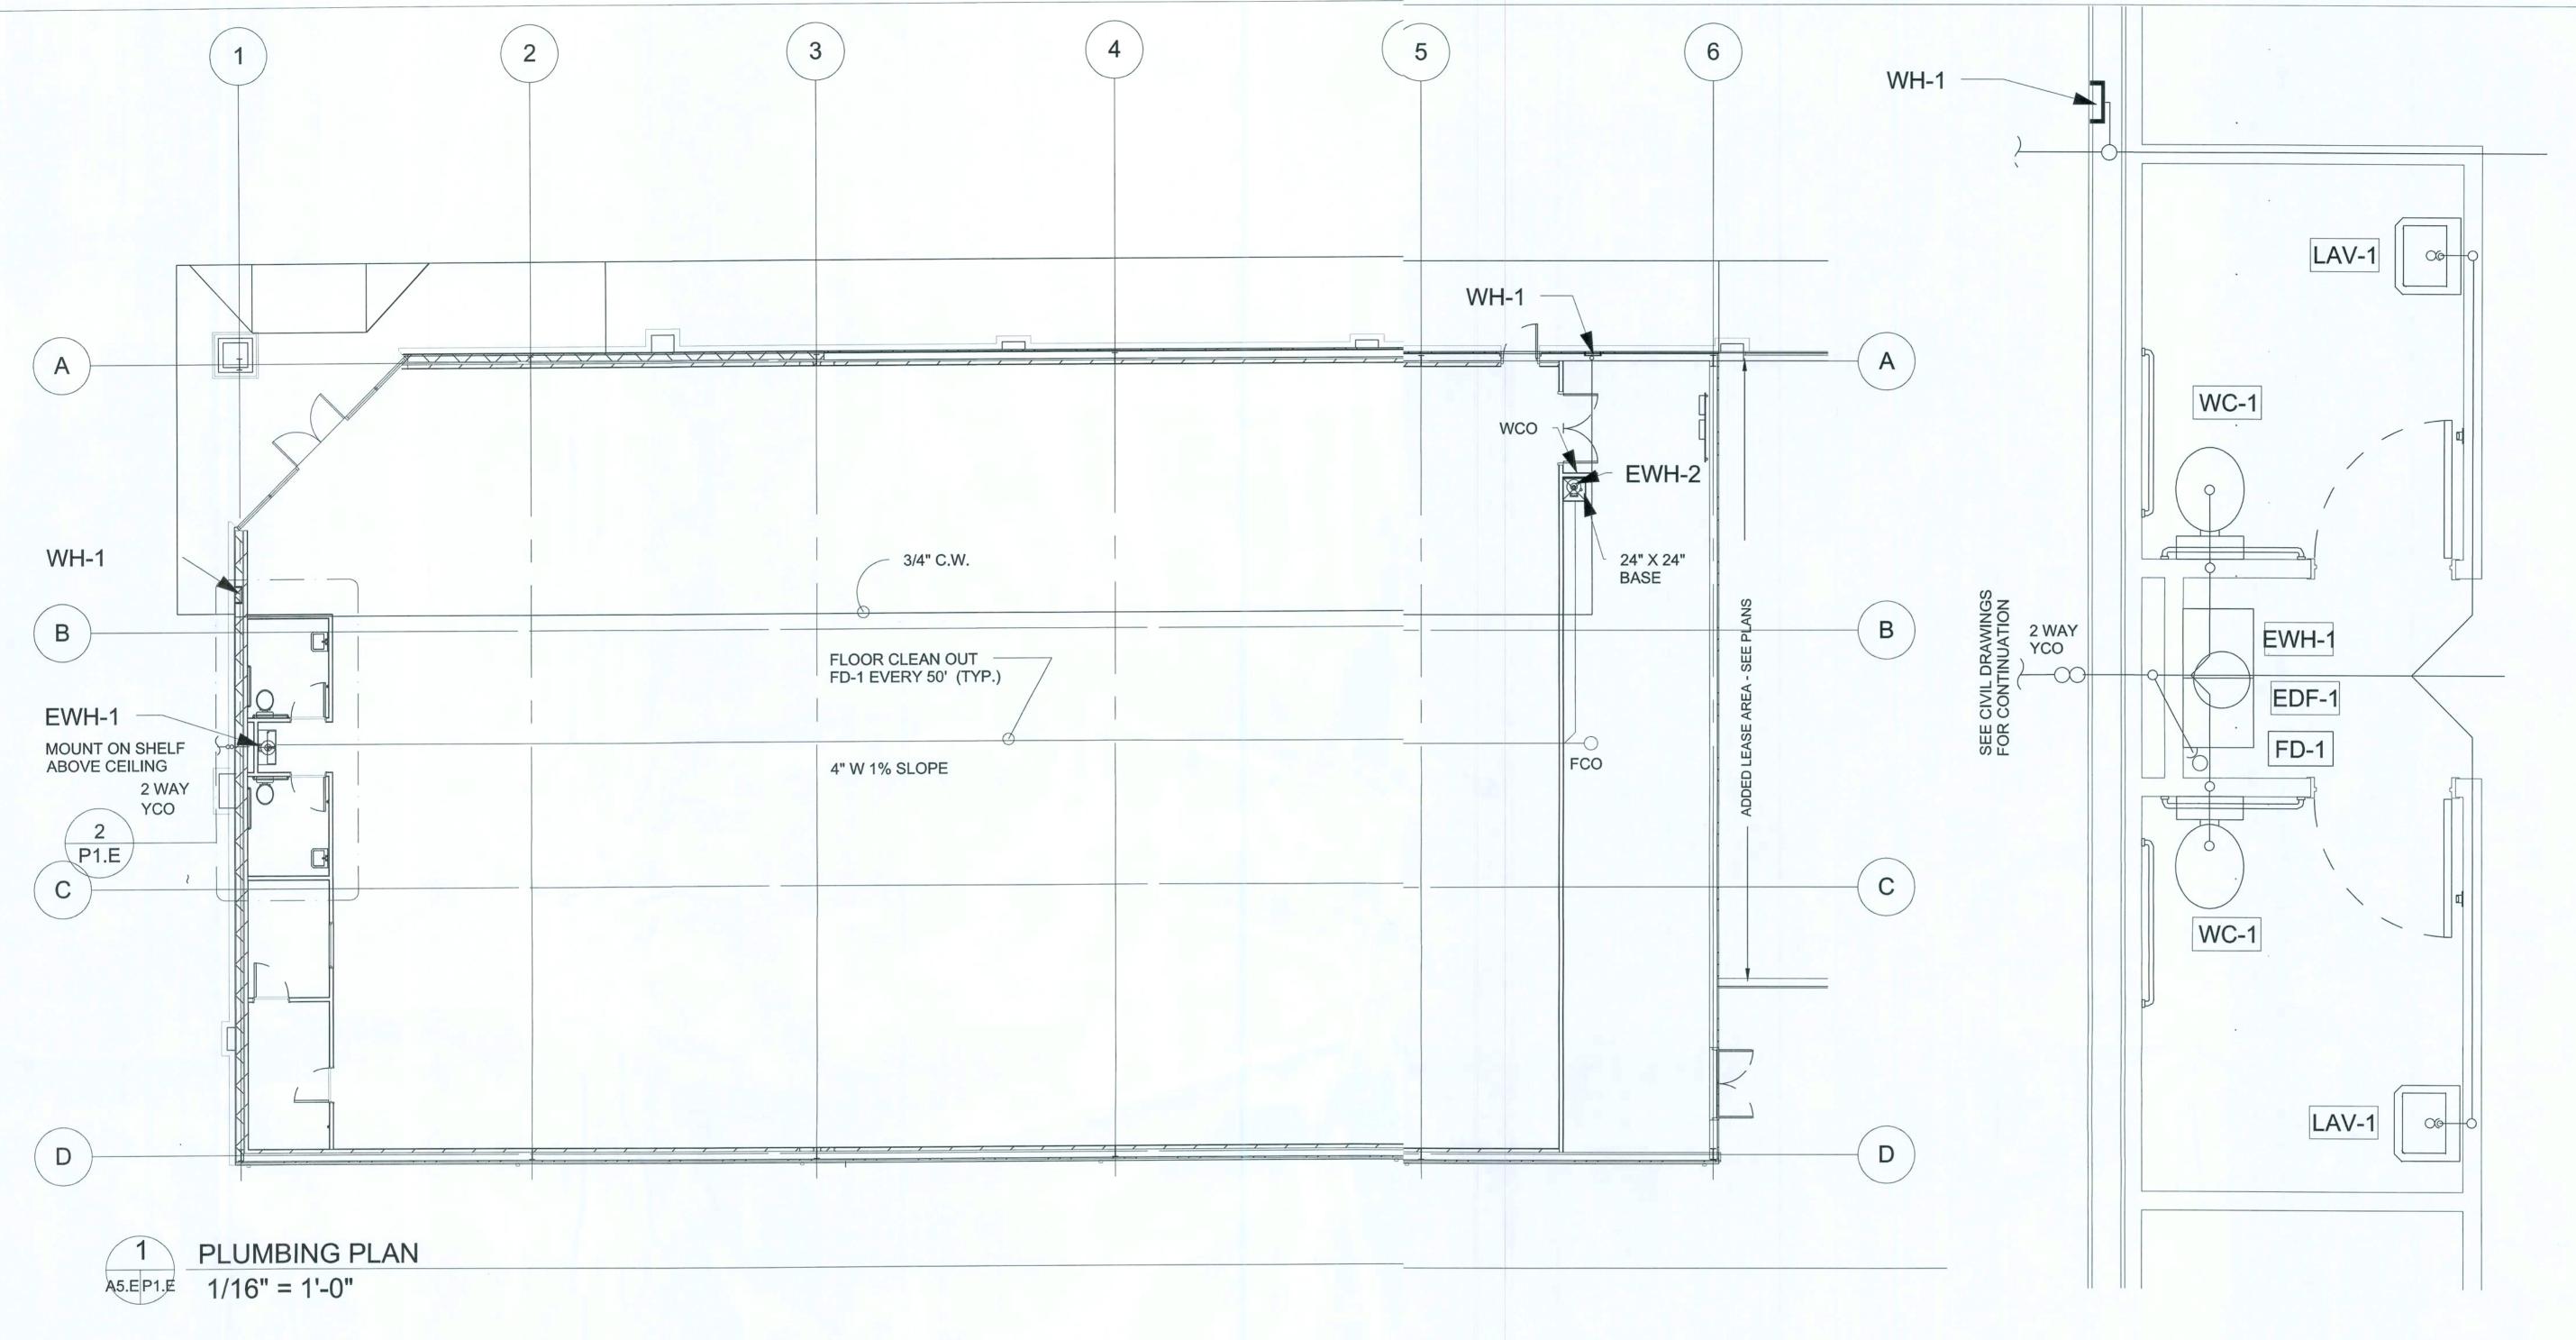
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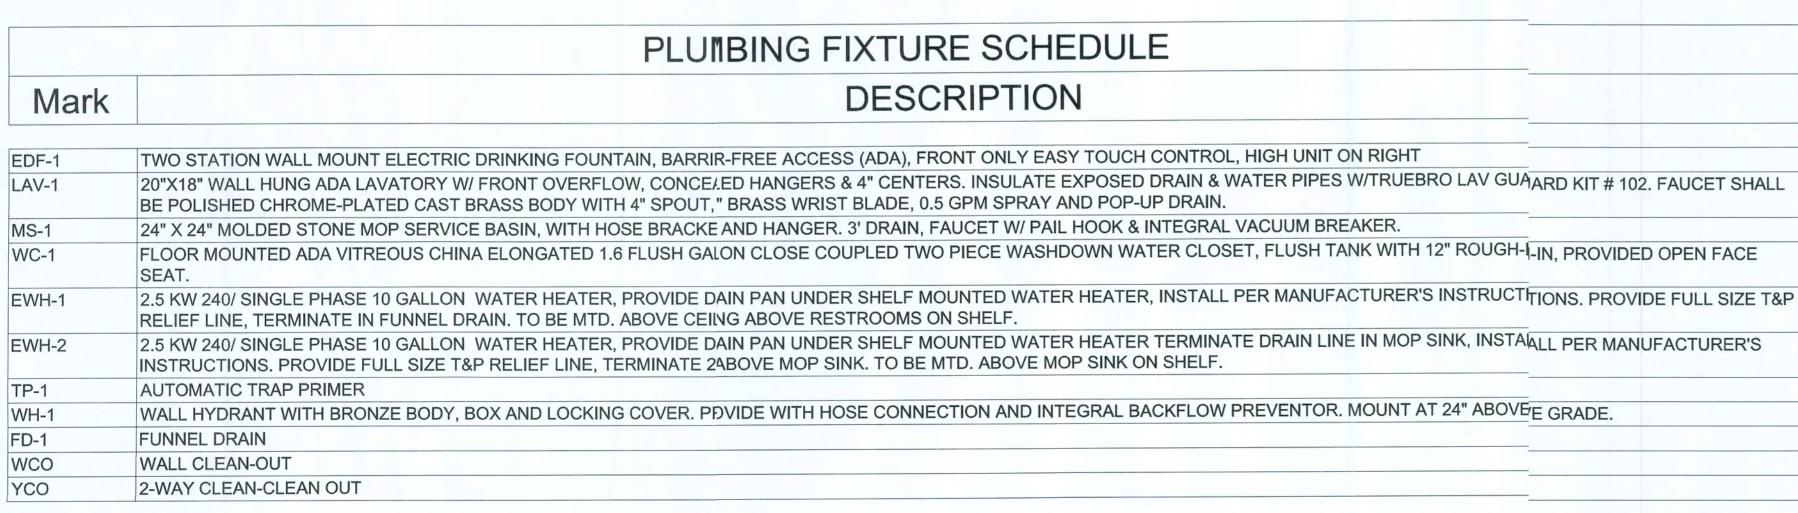
18 JAN 2010

SHEET NUMBER

M1.E

HVAC LAYOUT & SCHEDULE OPTION "E"





2 R1.E P1.E ENLARGED 1/4" = 1'-0"

ENLARGED TOILET PLAN

NOTES:

- PUBLIC SANITARY SEWER CONNCECTION REQUIRED.
   SEPTIC SYSTEM NOT ALLOWED UNLESS WRITTEN APPROVAL BY DOLLAR GENERAL STORE DESIGN.
- 3. HOLDING TANK SYSTEMS NOT ALLOWED.

PLUMBING PLANS OPTION "E"


ELLISVILI 2010 PROTO

DATE

18 JAN 2010

SHEET NUMBER


P1.E

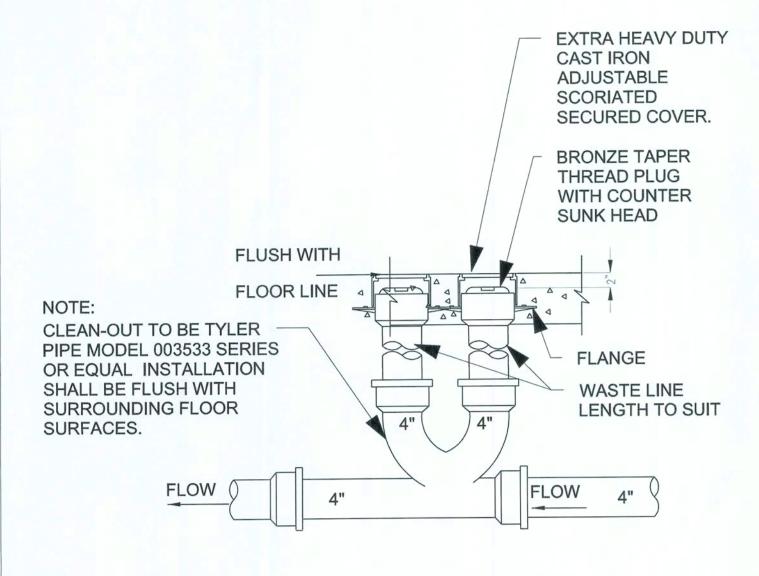

THIS DETAIL USED FOR 4"
SANITARY LINE RUN BELOW
FIXTURE RACKING. SEE PLANS.

1 P2.E

2-WAY YARD CLEAN-OUT DETAIL 1/4" = 1'-0"

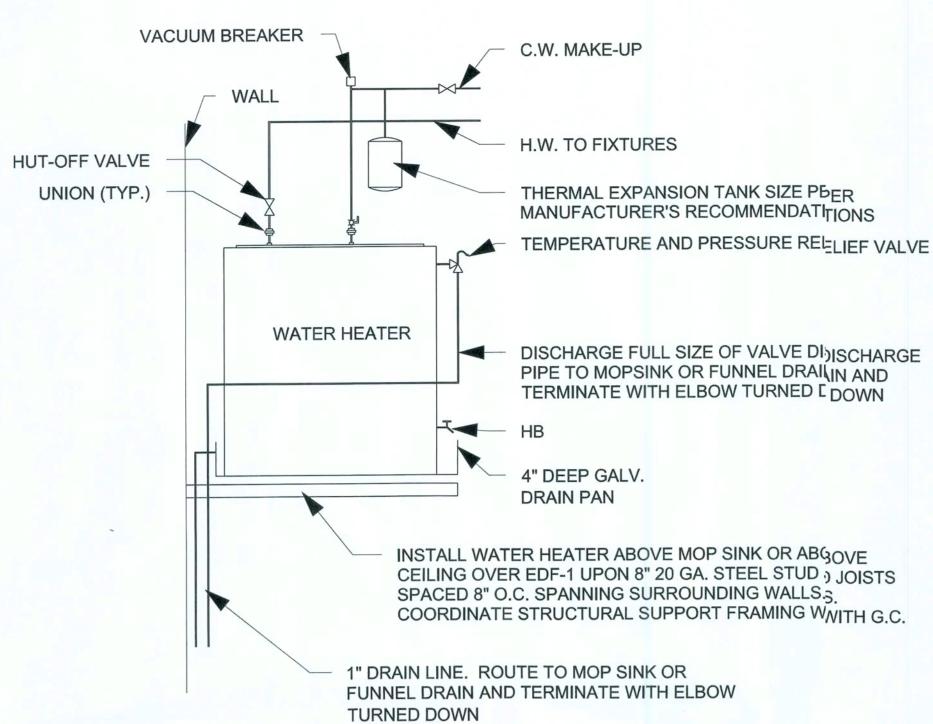


WATER HEATER "EWH-1" & "EWH-2" DETAIL

P2.E 1/2"

1/2" = 1'-0"

PROVIDE CLEANOUT WITH ADJUSTABLE CLEANOUT TOP WITH VARIATIONS SUITABLE FOR FLOOR COVERING (CARPET MARKER, RECESSED FOR TILE, SCORIATED FOR UNFINISHED FLOORS). CLEAN THE TOP OF EXPOSED FCO AFTER INSTALLATION.

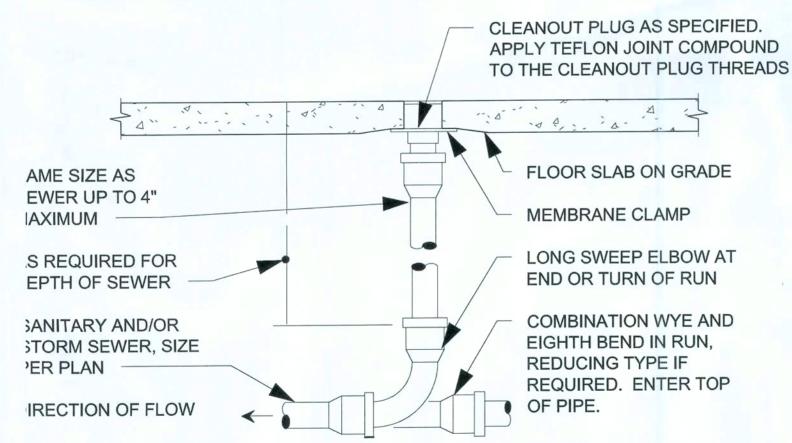


REFER TO SPECIFICATIONS AND SCHEDULE FOR MORE INFORMATION. LOCATE AT BUILDING EXIT, AT ENDS OF RUNS, AT TURNS OF PIPE GREATER THAN 45°, AT 50' INTERVALS ON STRAIGHT RUNS, AND/OR WHERE SHOWN ON PLANS AND RISERS. PROVIDE BACKFILL PER ARCHITECTURAL SPECIFICATIONS. LOCATE CLEANOUT WHERE THERE IS 18" CLEAR AROUND, FOR ACCESSIBILITY. CONSULT LOCAL CODES AND OFFICIALS FOR OTHER REQUIREMENTS.


3 FL P2.⊭ 1

FLOOR CLEAN OUT DETAIL

1 1/2" = 1'-0"

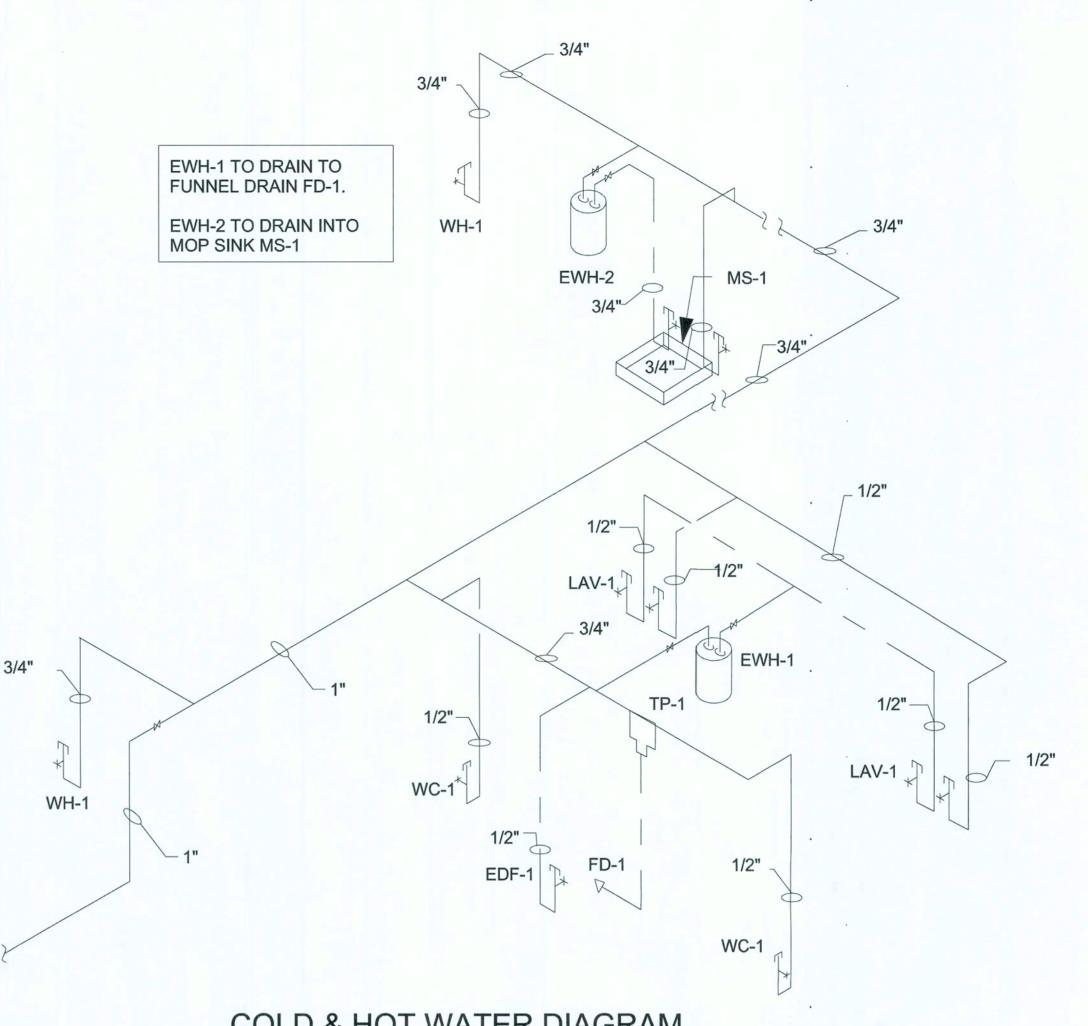

COLD & HOT WATER DIAGRAM
SEE SHEET P1.B FOR PLUMBING DEVICE CODES

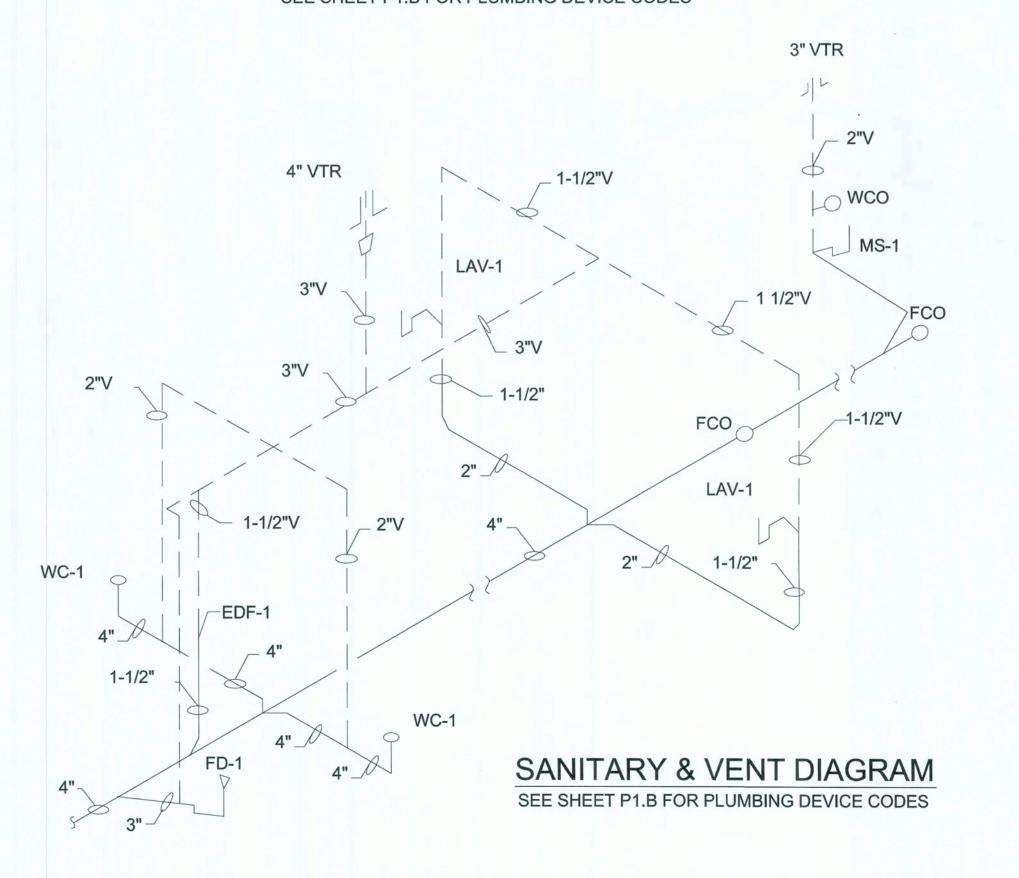

DOLLAR GENERAL

ELLISVILLE, FLORIDA 2010 PROTOTYPE - PLAN "E"

DATE

18 JAN 2010

SHEET NUMBER

P2.E

PLUMBING DETAILS & RISER DIAGRAMS OPTION "E"