

BETHLEHEM PARK COLUMBIA COUNTY, FLORIDA

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ATTACHMENTS

PLANS PREPARED FOR:

COLUMBIA COUNTY BOCC 135 NE HERNANDO AVENUE, SUITE 203 LAKE CITY, FL 32055 386-758-1005

Cou	ay Building
4	Plans Reviewed
5	for Code sompliance
Sia	e of Florida

REVISIONS

12/21/2023

PROJECT LOCATION

NORTH FLORIDA PROFESSIONAL SERVICES, INC.

P.O. BOX 3823 LAKE CITY, FL 32056 PH. 386-752-4675

2551 BLAIRSTONE PINES DR. TALLAHASSEE, FL 32301 WWW.NFPS.NET

JOB NUMBER: L220810CCB **GREGORY G. BAILEY** P.E. NO.: 43858

COVER SHEET BETHLEHEM PARK COLUMBIA COUNTY, FLORIDA SHEET C-1

SU-1

X:\2022\L220810CCB\H.CADD\Roadway\KEYSRD_Beth_Park_01.dwg

SURVEY



THIS ITEM HAS BEEN DIGITALLY SIGNED AND SEALED BY ROBERT PHILLIP BISHOP JR. ON THE DATE ADJACENT TO THE SEAL.

PRINTED COPIES OF THIS DOCUMENT ARE NOT CONSIDERED SIGNED AND SEALED AND THE SIGNATURE MUST BE VERIFIED ON ANY ELECTRONIC COPIES.

NORTH FLORIDA PROFESSIONAL SERVICES INC. P.O. BOX 3823 LAKE CITY, FL 32056 CERTIFICATE OF AUTHORIZATION: 29011 ROBERT PHILLIP BISHOP JR., P.E. NO. 38546

THE ABOVE NAMED PROFESSIONAL ENGINEER SHALL BE RESPONSIBLE FOR THE FOLLOWING SHEETS IN ACCORDANCE WITH RULE 61G15-23.004, F.A.C.

BUILDING PLANS

COVER SHEET	G1
ABBREVIATIONS & SYMBOLS	G2
FLOOR PLAN	B1
EXTERIOR ELEVATIONS	B2-B3
DOOR / WINDOW SCHEDULES	B4
FOUNDATION PLAN	S1
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ROOF FRAMING PLAN	S4
BUILDING SECTION	S5
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MECHANICAL PLAN	M1
MECHANICAL NOTES	M2
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POWER PLAN	E2
SANITARY PLUMBING PLANS	P1
WATER SUPPLY PLANS	P2
SANITARY RISER DIAGRAM	P3
PLUMBING NOTES	P4
LIFE SAFETY PLAN	LS1

	REVISIONS	
DATE	DESCRIPTION	
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NORTH FLORIDA PROFESSIONAL SERVICES, INC.

P.O. BOX 3823 LAKE CITY, FL 32056 PH. 386-752-4675 LIC NO. LB8356

2551 BLAIRSTONE PINES DR. TALLAHASSEE, FL 32301 WWW.NFPS.NET CA# 29011

JOB NUMBER: L220810CCB EOR: **GREGORY G. BAILEY** P.E. NO.:

43858

Gregory G Bailey

Digitally signed by Gregory G Bailey

DN; CN=Gregory G Bailey,

dnQualifier=A01410D0000018CFAA44B9F001D4DA4,

O=NORTH FLORIDA PROFESSIONAL SERVICES
INC., C=US

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No.43858

*

STATE OF

CORIDA GINTARIA

CIVIL PLANS

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SIGNATURE SHEET **BETHLEHEM PARK COLUMBIA COUNTY, FLORIDA** SHEET NO.

C-2

GENERAL NOTES

- 1. THE CONTRACTOR SHALL VERIFY ALL EXISTING CONDITIONS AND DIMENSIONS AT THE JOB SITE TO ENSURE THAT ALL NEW WORK WILL FIT IN THE MANNER INTENDED ON THE PLANS. SHOULD ANY CONDITIONS EXIST THAT ARE CONTRARY TO THOSE SHOWN ON THE PLANS, THE CONTRACTOR SHALL NOTIFY THE ENGINEER AND THE COLUMBIA COUNTY, FLORIDA (DEPARTMENT OF GROWTH MANAGEMENT) OF SUCH DIFFERENCES IMMEDIATELY AND PRIOR TO PROCEEDING WITH THE WORK.
- 2. THE CONTRACTOR SHALL MAINTAIN THE CONSTRUCTION SITE IN A SECURE MANNER. ALL OPEN TRENCHES AND EXCAVATED AREAS SHALL BE PROTECTED FROM ACCESS BY THE GENERAL PUBLIC.
- BOUNDARY INFORMATION SHOWN, WAS OBTAINED FROM A BOUNDARY SURVEY PREPARED BY NORTH FLORIDA PROFESSIONAL SERVICES, FLORIDA CERTIFICATE NO.
- 4. THE VERTICAL DATUM SHOWN HEREON IS REFERENCED TO THE NORTH AMERICA VERTICAL DATUM OF 1988 (NAVD88). THE ELEVATIONS SHOWN WERE DERIVED FROM FLORIDA DEPARTMENT OF TRANSPORTATION CONTROL MONUMENTS:
- 4.1. 2903006GPS6, WITH A PUBLISHED ELEVATION OF 80.08 FEET NAVD 88
- 4.2. 2903006GPS5, WITH A PUBLISHED ELEVATION OF 80.24 FEET NAVD 88
- 5. ANY PUBLIC LAND CORNER WITHIN THE LIMITS OF CONSTRUCTION SHALL BE PROTECTED. IF A CORNER MONUMENT IS IN DANGER OF BEING DESTROYED AND HAS NOT BEEN PROPERLY REFERENCED, THE CONTRACTOR SHOULD NOTIFY THE ENGINEER.
- 6. THE SITE IS LOCATED IN SECTION 5, TOWNSHIP 7 SOUTH, RANGE 17 EAST, COLUMBIA COUNTY, FLORIDA.
- 7. THE CONTRACTOR SHALL IMPLEMENT ALL COMPONENTS OF THE EROSION AND SEDIMENTATION CONTROL PLAN PRIOR TO ANY EARTH DISTURBING ACTIVITIES. ALL COMPONENTS SHALL BE MAINTAINED BY THE CONTRACTOR UNTIL ALL VEGETATION IS ESTABLISHED, THE ENTIRE PROJECT AREA IS STABILIZED AND THE OWNER HAS ACCEPTED OPERATION AND MAINTENANCE.
- 8. ALL DISTURBED AREAS NOT SODDED SHALL BE SEEDED WITH A MIXTURE OF LONG-TERM VEGETATION AND QUICK GROWING SHORT-TERM VEGETATION FOR THE FOLLOWING CONDITIONS. FOR THE MONTHS FROM SEPTEMBER THROUGH MARCH, THE MIX SHALL CONSIST OF 70 POUNDS PER ACRE OF LONG-TERM SEED AND 20 POUNDS PER ACRE OF WINTER RYE. FOR THE MONTHS OF APRIL THROUGH AUGUST, THE MIX SHALL CONSIST OF 70 PER ACRE OF LONG-TERM SEED AND 20 POUNDS PER ACRE OF
- 9. THE LOCATION OF THE UTILITIES SHOWN IN THE PLANS ARE APPROXIMATE ONLY. THE EXACT LOCATION SHALL BE DETERMINED BY THE CONTRACTOR DURING CONSTRUCTION. CONTRACTOR SHALL PROTECT ALL UTILITIES WITHIN THE PROJECT
- 10. ALL UTILITY CONSTRUCTION SHALL MEET THE COLUMBIA COUNTY WATER AND WASTEWATER UTILITY STANDARDS, AVAILABLE ONLINE OR THROUGH THE PUBLIC
- 11. THE CONTRACTOR SHALL STOCKPILE ALL EXCESS EARTH OFFSITE SITE AS DIRECTED BY THE ENGINEER.
- 12. ALL SITE CONSTRUCTION SHALL BE IN ACCORDANCE WITH COLUMBIA COUNTY LAND DEVELOPMENT REGULATIONS.
- 13. CONTRACTOR SHALL REVIEW AND BECOME FAMILIAR WITH ALL REQUIRED UTILITY CONNECTIONS PRIOR TO BIDDING. CONTRACTOR SHALL PROVIDE ALL WORK AND MATERIALS REQUIRED TO COMPLETE CONNECTION TO THE EXISTING UTILITIES. THIS INCLUDES BUT IS NOT LIMITED TO MANHOLE CORING, WET TAPS, PAVEMENT REPAIRS AND DIRECTIONAL BORING.
- 14. CONTRACTOR SHALL COORDINATE ALL WORK WITH OTHER CONTRACTORS WITHIN PROJECT AREA
- 15. CONTRACTOR SHALL PROVIDE ACTUAL INVERT ELEVATIONS ON ALL DRAINAGE STRUCTURES, INCLUDING CULVERTS, PRIOR TO PLACING ANY BASE MATERIAL. DEVIATIONS FROM THE PLANS SHALL BE APPROVED BY THE ENGINEER BEFORE CONTINUING WORK
- 16. THIS PROJECT IS TO BE CONSTRUCTED IN ACCORDANCE WITH THE AWWA

REVISIONS

SPECIFICATIONS, AND COLUMBIA COUNTY DEVELOPMENT STANDARDS UNLESS OTHERWISE NOTED.

- 17. IF UNSUITABLE MATERIAL IS ENCOUNTERED DURING GRADING, CONTRACTOR SHALL REMOVE UNSUITABLE MATERIAL TO A DEPTH OF 24" BELOW FINISHED GRADE WITHIN
- 18. THE CONTRACTOR SHALL NOTIFY THE COUNTY AT LEAST 48 HOURS PRIOR TO BEGINNING OF CONSTRUCTION.
- 19. NO WORK SHALL BE PERFORMED ON SATURDAY, SUNDAY, OR ANY DESIGNATED COUNTY HOLIDAY WITHOUT WRITTEN NOTIFICATION TO THE COUNTY AND COUNTY ENGINEER.
- 20. CONTRACTOR SHALL PROVIDE AN AS-BUILT SURVEY MEETING THE REQUIREMENTS OF CHAPTER 61G17 F.A.C. INCLUDE HORIZONTAL AND VERTICAL DIMENSIONAL DATA SO THAT IMPROVEMENTS ARE LOCATED AND DELINEATED RELATIVE TO THE BOUNDARY. PROVIDE SUFFICIENT DETAILED DATA TO DETERMINE WHETHER THE IMPROVEMENTS WERE CONSTRUCTED IN ACCORDANCE WITH THE PLANS. A COPY OF THE AS-BUILT SURVEY (IN PAPER AND DIGITAL AUTOCAD FORMAT) MUST BE SUBMITTED TO COLUMBIA COUNTY, FLORIDA (BUILDING AND ZONING) AND THE COUNTY
- 21. THE CONTRACTOR SHALL SUBMIT A NATIONAL POLLUTANT DISCHARGE ELIMINATION SYSTEM NOTICE OF INTENT ALONG WITH SUPPORTING DOCUMENTATION TO THE FLORIDA DEPARTMENT OF ENVIRONMENTAL PROTECTION AT LEAST 48 HOURS PRIOR TO BEGINNING OF CONSTRUCTION. THE CONTRACTOR SHALL BE RESPONSIBLE FOR ALL PERMIT FEES.
- 22. ALL CONCRETE SLABS ABUTTING EXTERIOR WALLS SHALL BE SOIL TREATED FOR

PH. 386-752-4675

LIC NO. LB8356

NORTH FLORIDA PROFESSIONAL SERVICES, INC. P.O. BOX 3823 2551 BLAIRSTONE PINES DR. LAKE CITY, FL 32056

TALLAHASSEE, FL 32301 WWW.NFPS.NET CA# 29011

JOB NUMBER: L220810CCB EOR: **GREGORY G. BAILEY** P.E. NO .:

43858

BETHLEHEM PARK COLUMBIA COUNTY, FLORIDA

C-3

GENERAL NOTES

DATE

DESCRIPTION

NORTH FLORIDA PROFESSIONAL SERVICES, INC.

P.O. BOX 3823 LAKE CITY, FL 32056 PH. 386-752-4675 LIC NO. LB8356

2551 BLAIRSTONE PINES DR. TALLAHASSEE, FL 32301 WWW.NFPS.NET CA# 29011

JOB NUMBER: L220810CCB EOR: **GREGORY G. BAILEY** P.E. NO.: 43858

SITE DATA TABLE **BETHLEHEM PARK COLUMBIA COUNTY, FLORIDA**

EROSION CONTROL NOTES

- THIS EROSION AND SEDIMENTATION CONTROL PLAN COMPLIES WITH THE REQUIREMENTS OF THE "FLORIDA DEVELOPMENT MANUAL" AND THE "FLORIDA EROSION AND SEDIMENT CONTROL INSPECTOR'S MANUAL".
- THE CONTRACTOR SHALL ADHERE TO COLUMBIA COUNTY AND OTHER GOVERNING AUTHORITIES FOR EROSION AND SEDIMENT CONTROL REGULATIONS. IF THE CONTRACTOR NEEDS TO CHANGE THIS PLAN TO MORE EFFECTIVELY CONTROL EROSION AND SEDIMENTATION, THE CONTRACTOR SHALL USE BMP'S FROM THE "FLORIDA EROSION AND SEDIMENT CONTROL INSPECTOR'S MANUAL".
- THE CONTRACTOR SHALL ADJUST AND REVISE THIS PLAN TO MEET ACTUAL FIELD CONDITIONS. ANY REVISIONS SHALL BE APPROVED BY THE REVIEWING AGENCIES.
- SEDIMENT AND EROSION CONTROL FACILITIES, STORM DRAINAGE FACILITIES AND DETENTION BASINS SHALL BE INSTALLED PRIOR TO ANY OTHER CONSTRUCTION.
- EROSION CONTROL MEASURES SHALL BE INSPECTED WEEKLY AND AFTER EACH RAINFALL OF 0.5 INCHES OR GREATER, AND REPAIRED OR REPLACED AS NECESSARY.
- SEDIMENT AND EROSION CONTROL MEASURES SHALL NOT BE REMOVED UNTIL ALL CONSTRUCTION IS COMPLETE AND UNTIL A PERMANENT GROUND COVER HAS BEEN
- ALL OPEN DRAINAGE SWALES SHALL BE GRASSED AND RIPRAP SHALL BE PLACED AS REQUIRED TO CONTROL EROSION.
- SILT FENCES SHALL BE LOCATED ON SITE TO PREVENT SEDIMENT AND EROSION FROM LEAVING PROJECT LIMITS.
- CONTRACTOR SHALL PLACE A DOUBLE ROW OF SILT FENCE IN AREAS WHERE RUNOFF FROM DISTURBED AREAS MAY ENTER WETLANDS.
- 10. DURING CONSTRUCTION AND AFTER CONSTRUCTION IS COMPLETE, ALL STRUCTURES SHALL BE CLEANED OF ALL DEBRIS AND EXCESS SEDIMENT.
- 11. ALL GRADED AREAS SHALL BE STABILIZED IMMEDIATELY WITH A TEMPORARY FAST-GROWING COVER AND/OR MULCH.
- 12. A PAD OF RUBBLE RIP RAP SHALL BE PLACED AT THE BOTTOM OF ALL COLLECTION FLUMES AND COLLECTION PIPE OUTLETS. GRANITE OR LIMESTONE RIPRAP IS REQUIRED, NO BROKEN CONCRETE WILL BE ACCEPTED.
- ALL SIDE SLOPES STEEPER THAN 3:1 SHALL BE ADEQUATELY PROTECTED FROM EROSION THROUGH THE USE OF SYNTHETIC BALES OR SODDING.
- 14. ALL STABILIZATION PRACTICES SHALL BE INITIATED AS SOON AS PRACTICABLE IN AREAS OF THE JOB WHERE CONSTRUCTION ACTIVITIES HAVE TEMPORARILY OR PERMANENTLY STOPPED, BUT IN NO CASE SHALL THE DISTURBED AREA BE LEFT UNPROTECTED FOR MORE THAN SEVEN DAYS.
- 15. ALL WASTE GENERATED ON THE PROJECT SHALL BE DISPOSED OF BY THE CONTRACTOR IN AREAS PROVIDED BY CONTRACTOR.
- LOADED HAUL TRUCKS SHALL BE COVERED WITH TARPS.

REVISIONS

DATE

- 17. EXCESS DIRT SHALL BE REMOVED DAILY.
- 18. THIS PROJECT SHALL COMPLY WITH ALL WATER QUALITY STANDARDS.
- QUALIFIED PERSONNEL SHALL INSPECT THE AREA USED FOR STORAGE OF STOCKPILES, THE SILT FENCE AND STRAW BALES, THE LOCATION WHERE VEHICLES ENTER OR EXIT THE SITE, AND THE DISTURBED AREAS THAT HAVE NOT BEEN FINALLY STABILIZED, AT LEAST ONCE EVERY SEVEN CALENDAR DAYS AND WITHIN 24 HOURS OF THE END OF A STORM OF 0.5 INCHES OR GREATER.
- 20. SITES THAT HAVE BEEN FINALLY STABILIZED WITH SOD OR GRASSING SHALL BE INSPECTED AT LEAST ONCE EVERY WEEK.

NORTH FLORIDA PROFESSIONAL SERVICES, INC.

TALLAHASSEE, FL 32301 LAKE CITY, FL 32056 PH. 386-752-4675 WWW.NFPS.NET LIC NO. LB8356 CA# 29011


JOB NUMBER: L220810CCB **GREGORY G. BAILEY** P.E. NO .:


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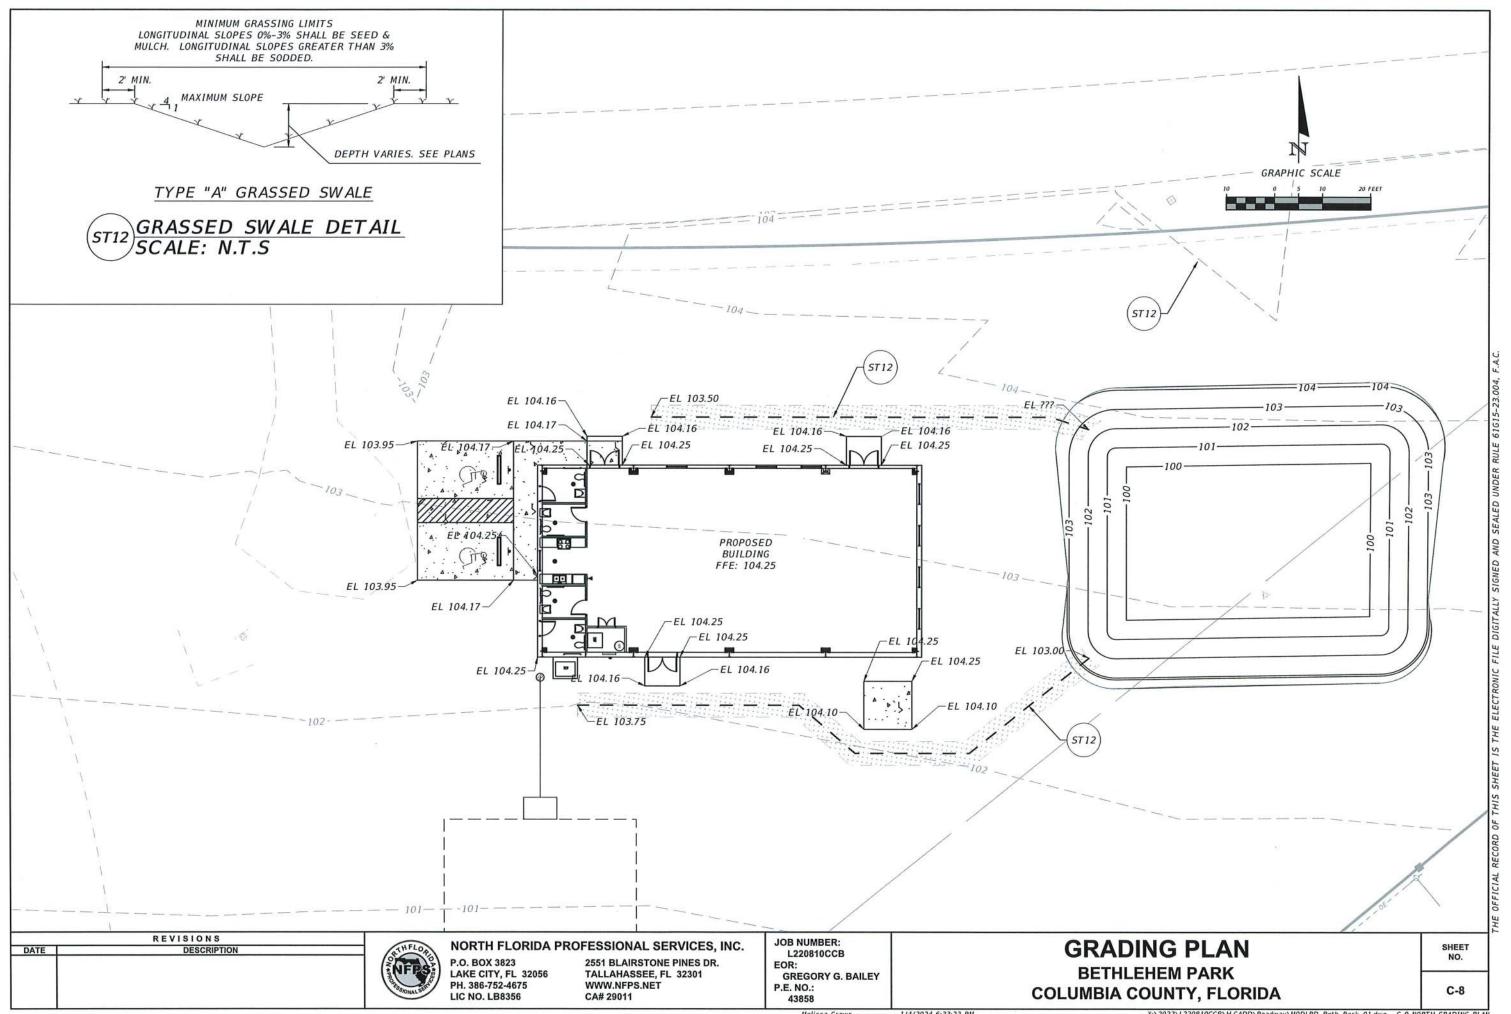
EROSION NOTES BETHLEHEM PARK


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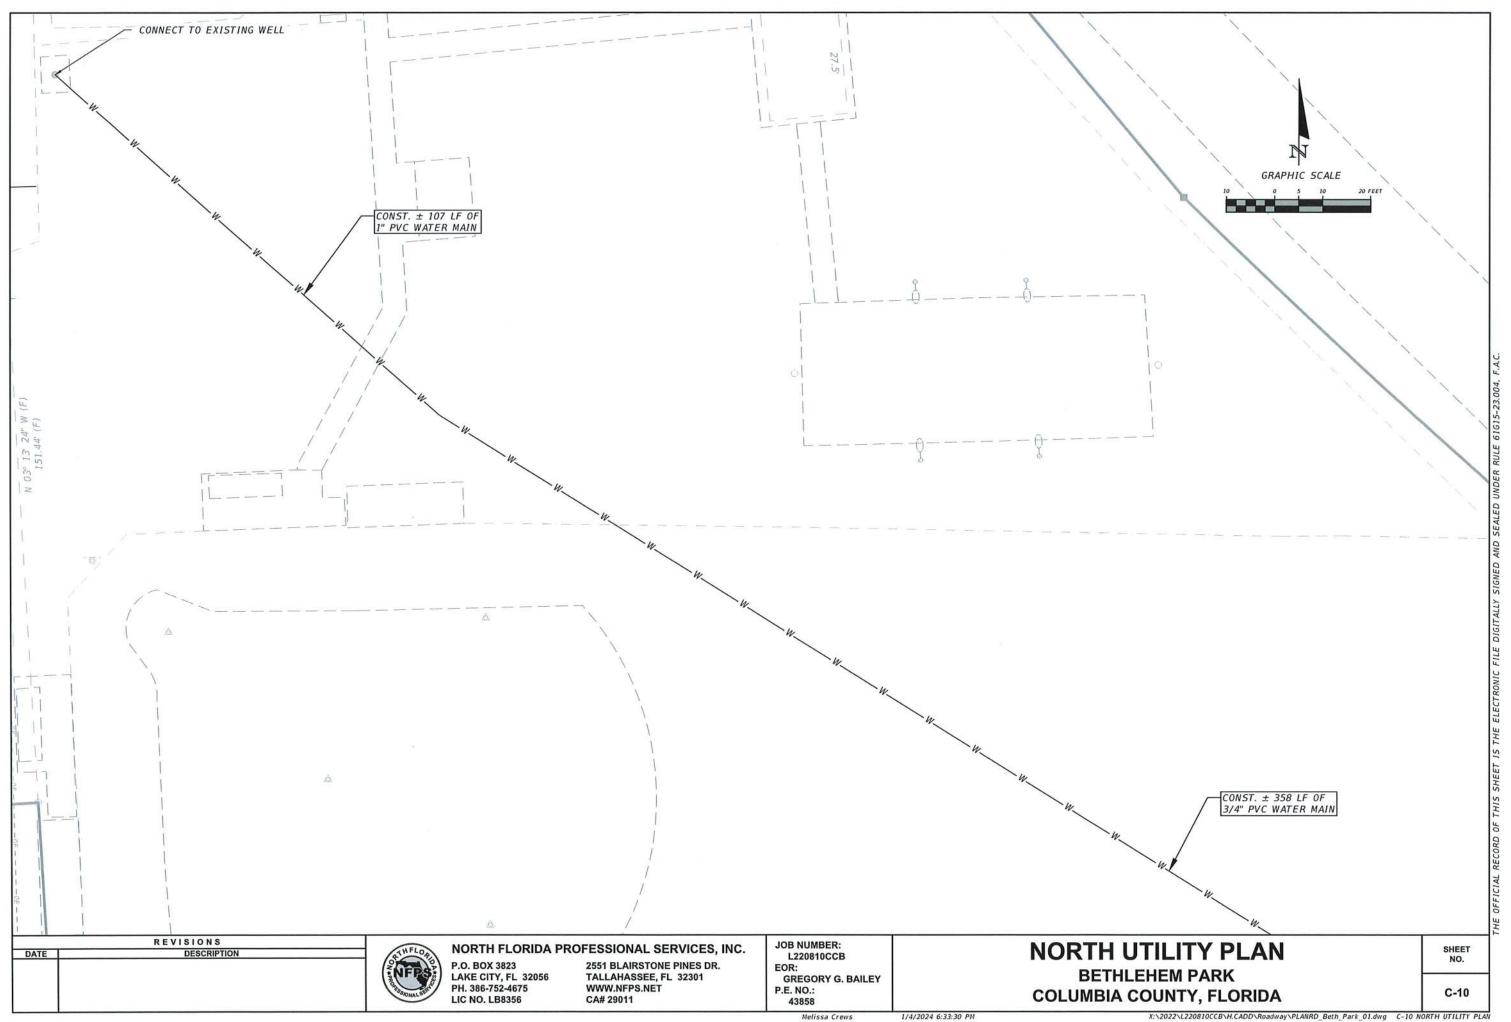
COLUMBIA COUNTY, FLORIDA C-5







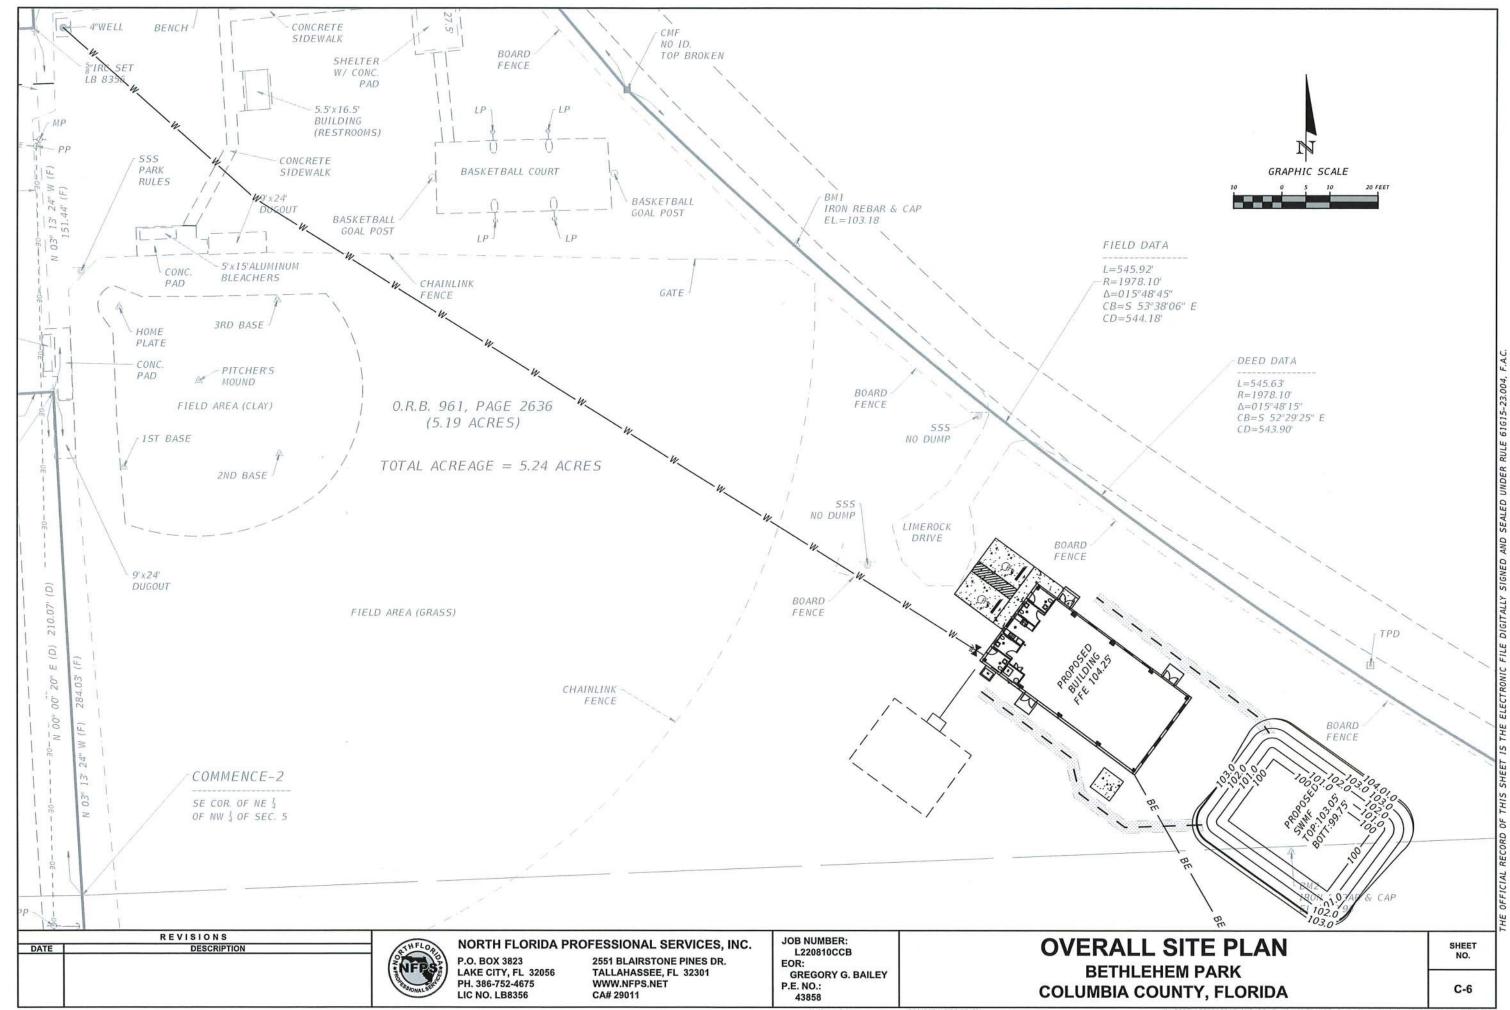

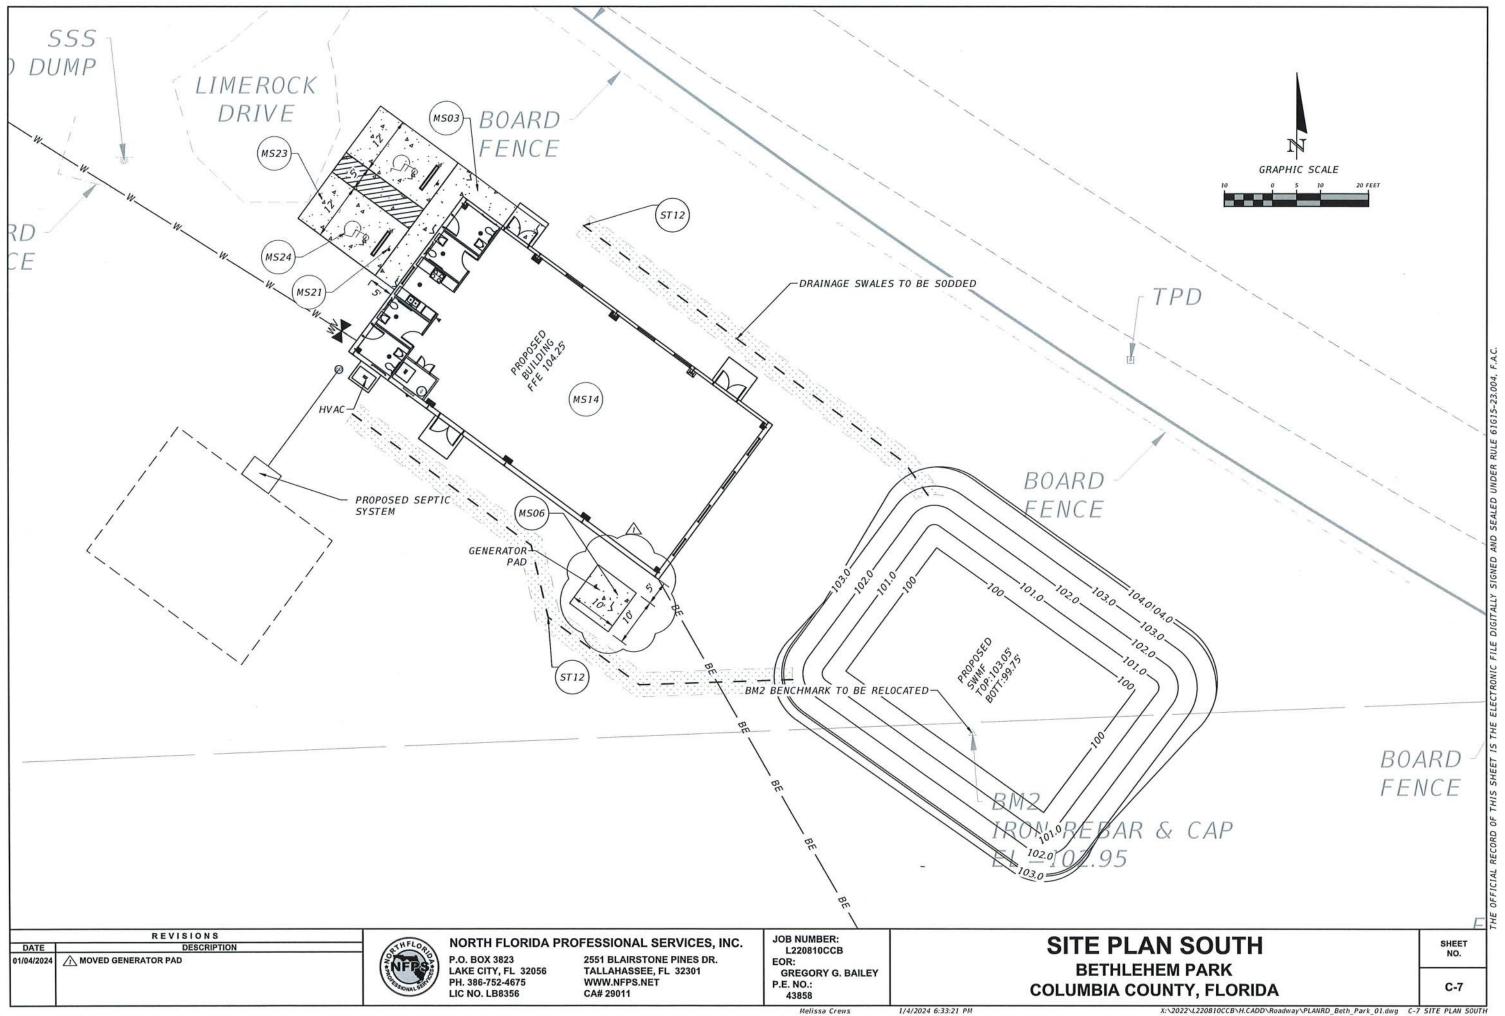

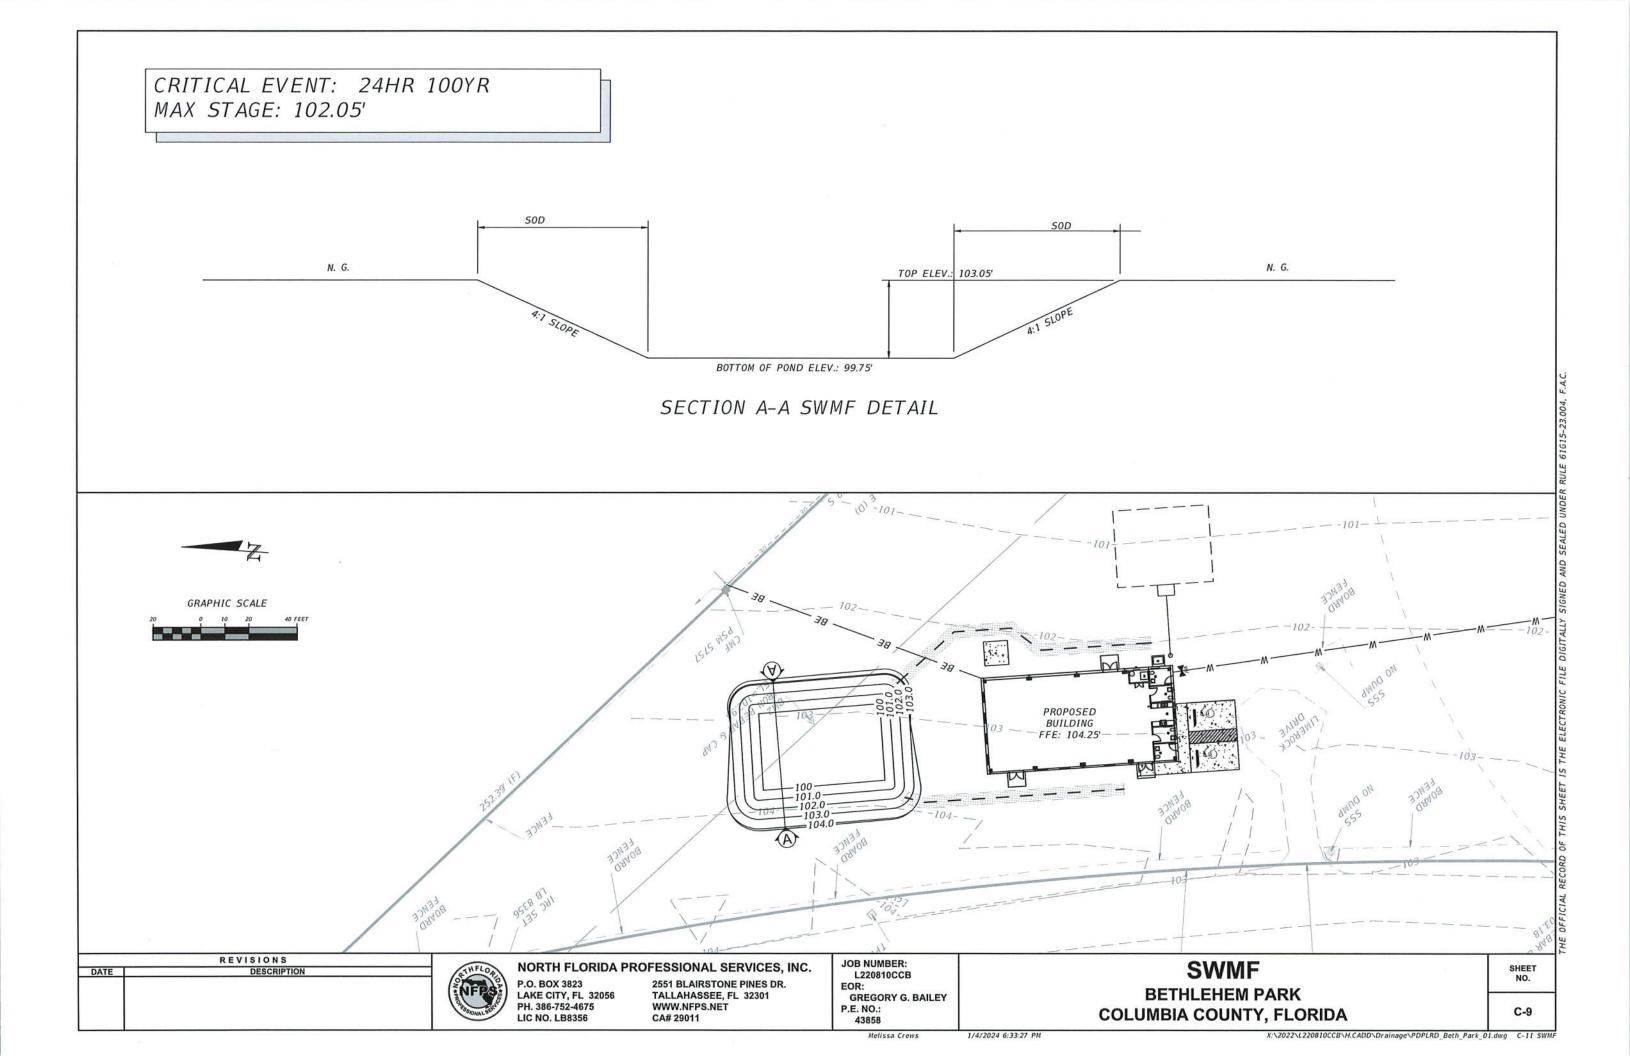

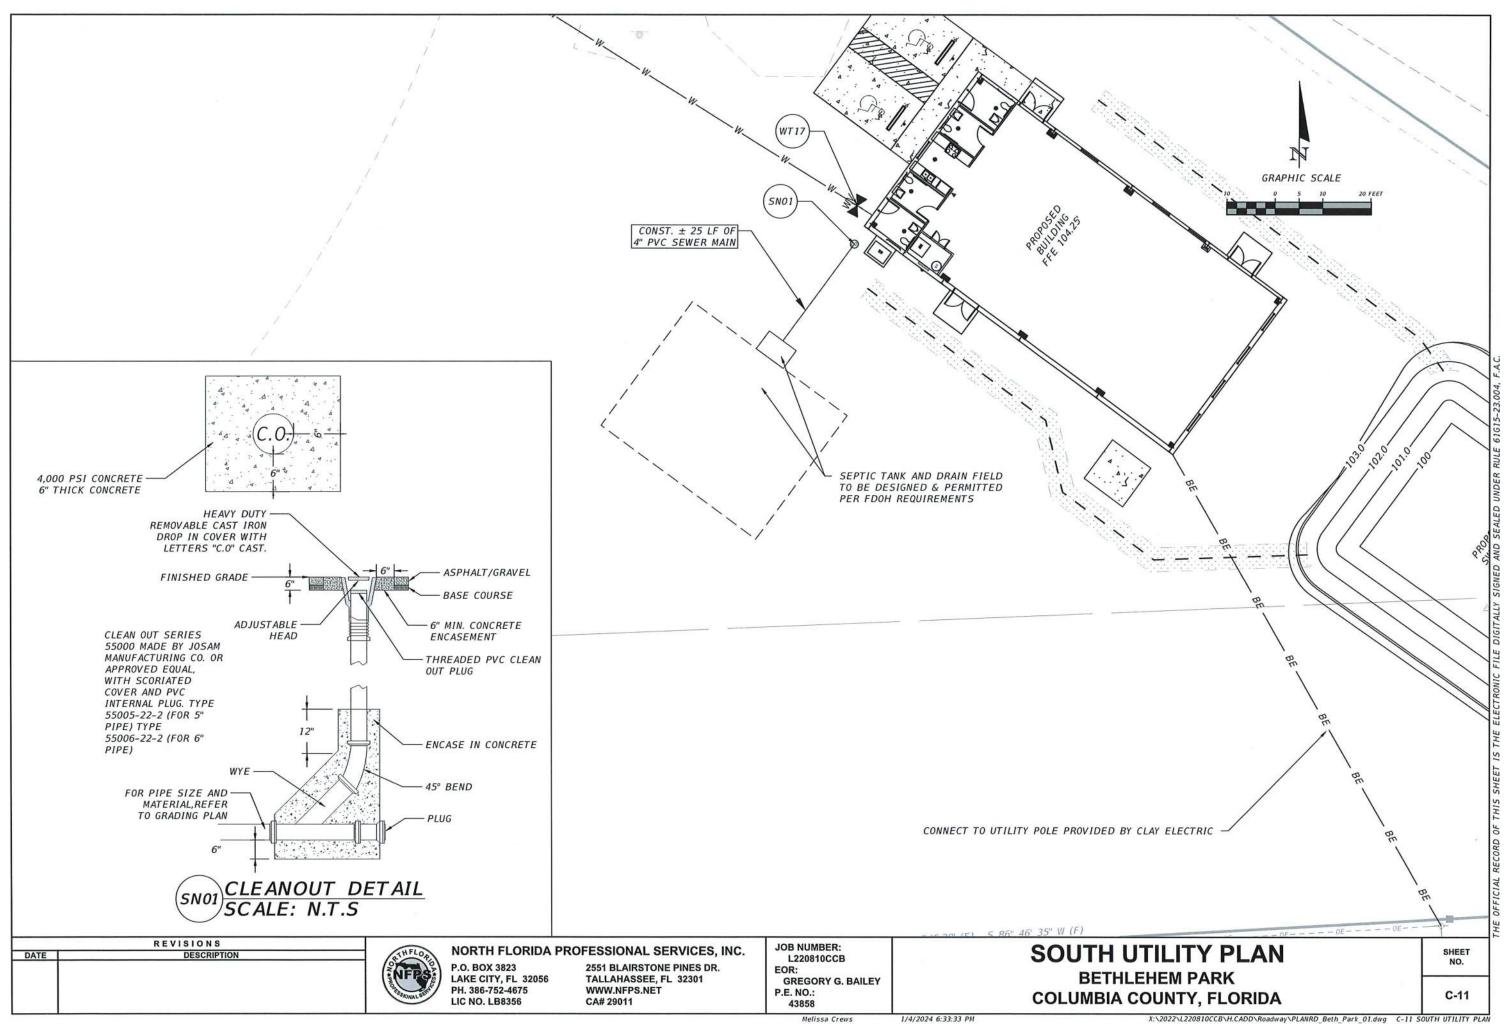

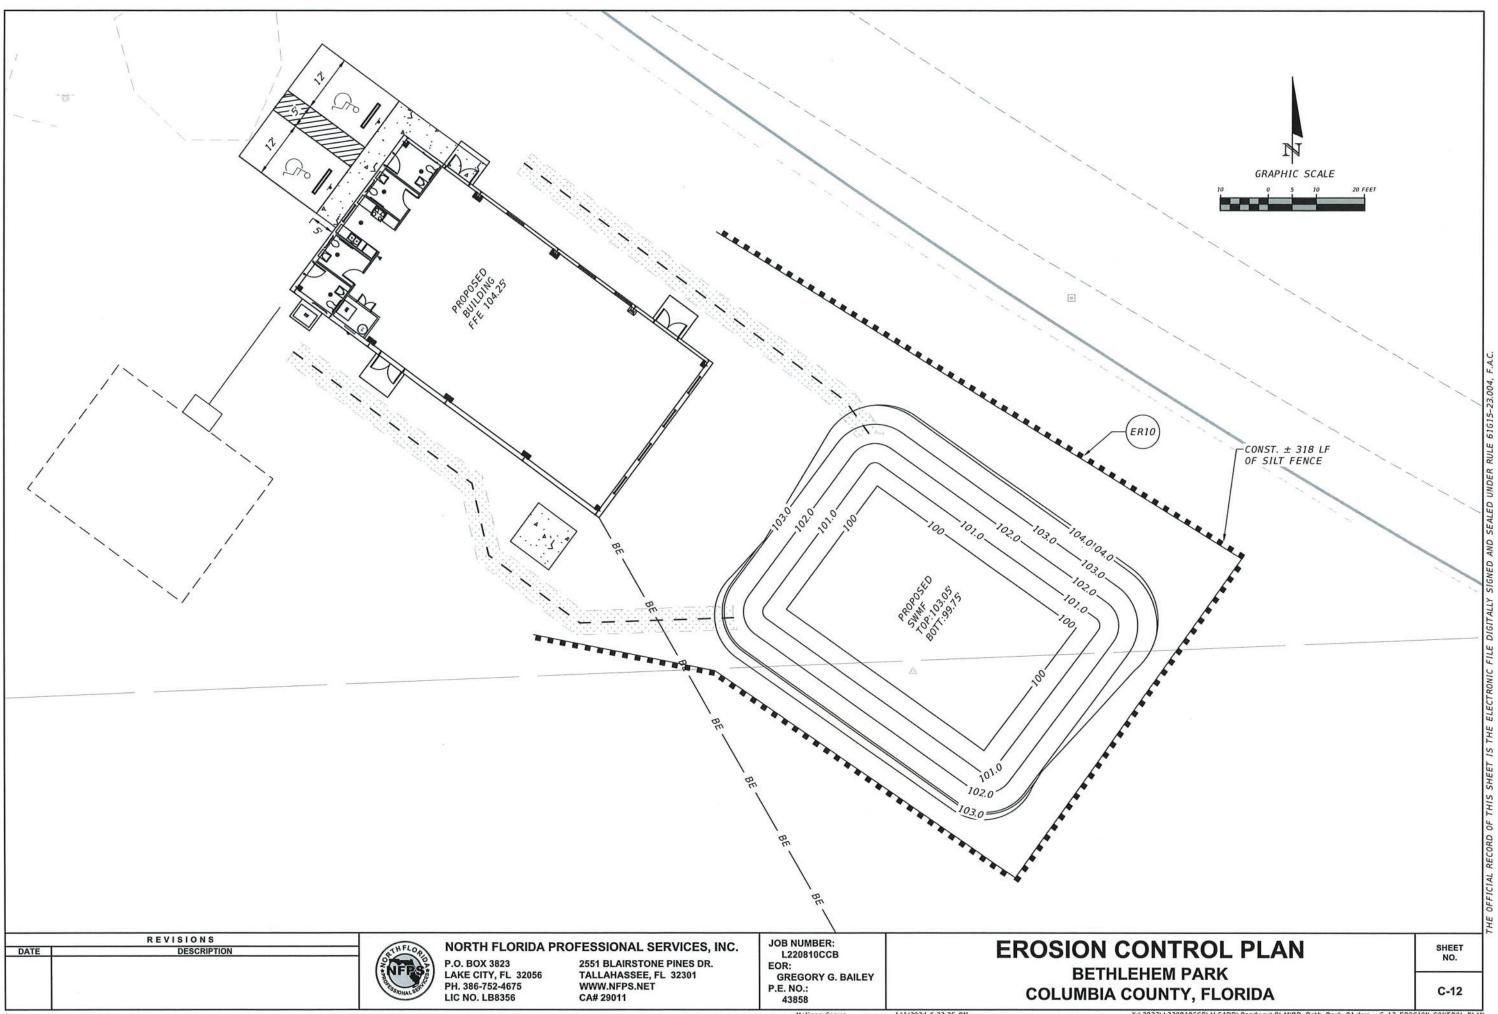

TYPE IV SILT FENCE SCALE: N.T.S.

SHALLOW DEEP

THE FOLLOWING SHALL BE PERFORMED IN THE EVENT ANY KARST FEATURES FORM DURING CONSTRUCTION - E.G. SOLUTION CAVITIES, CHIMNEYS,

- NOTIFY THE WATER MANAGEMENT DISTRICT AND THE APPLICABLE MUNICIPAL OR COUNTY PUBLIC WORKS IMMEDIATELY WHEN THE FEATURES ARE ENCOUNTERED. THE METHOD OF REPAIR SHALL BE SUBMITTED FOR REVIEW, COMMENT, AND APPROVAL PRIOR TO ATTEMPTING ANY REPAIR.
- SHALLOW KARST FEATURES ARE TYPICALLY LESS THAN 5' DEEP AND ONLY HAVE SMALL VOIDS IN THE LIMESTONE. THE FEATURE CAN BE REPAIRED BY BACKFILLING WITH A LOWER PERMEABILITY MATERIAL SUCH AS CLAYEY-SAND OR CLAY. COMPACT THE BACKFILL AND CREATE A SMALL MOUND SLIGHTLY ABOVE GRADE TO ACCOUNT FOR SETTLING.
- DEEP KARST FEATURES SHALL BE REPAIRED MORE PERMANENTLY. EXCAVATE THE FEATURE TO THE LIMESTONE BEDROCK. PLUG VOIDS IN THE BEDROCK WITH CLEAN GROUT. BACKFILL OVER THE PLUG WITH A LOWER-PERMEABILITY MATERIAL SUCH AS CLAYEY-SAND OR CLAY. COMPACT THE BACKFILL TO GRADE.

KARST FEATURE REPAIR DETAIL SCALE: N.T.S.

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2551 BLAIRSTONE PINES DR. TALLAHASSEE, FL 32301 WWW.NFPS.NET CA# 29011

JOB NUMBER: L220810CCB EOR: **GREGORY G. BAILEY** P.E. NO .:

43858

EROSION DETAILS BETHLEHEM PARK COLUMBIA COUNTY, FLORIDA

NO.


C-13

PROVIDE 1/8"-1/4"


CONTRACTION JOINTS AT 10'

CENTERS MAXIMUM.

MS03 SIDEWALK DETAIL "C" SCALE: N.T.S

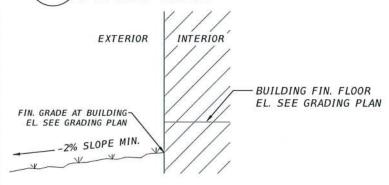


GRADE AT BUILDING DETAIL
SCALE: N.T.S

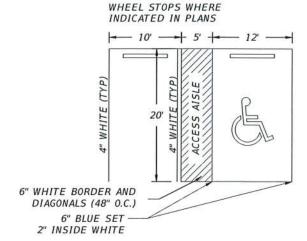


NOTES:

- 1. SIGN SHALL BE PLACED IN FRONT OF ALL DESIGNATED HANDICAPPED SPACES. SIGN HEIGHT SHALL BE 7' FROM PAVEMENT TO BOTTOM OF SIGN.
- 5' HANDICAPPED AISLE MAY BE PLACED ON THE RIGHT OR LEFT SIDE OF PARKING STALL.
- 3. HANDICAPPED PARKING SYMBOL SHALL BE 3 OR 5 FT. HIGH.
- 4. BLUE PAVEMENT MARKINGS SHALL BE TINTED TO MATCH SHADE 15180 OF FEDERAL STANDARDS 595A.

MS23 HANDICAP PARKING STALL DETAIL
SCALE: N.T.S

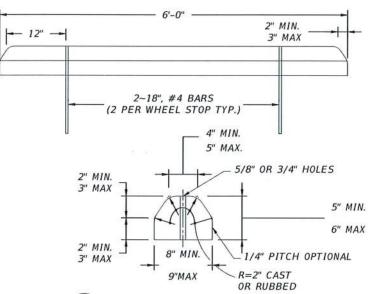

MS24 WHEEL STOP DETAIL
SCALE: N.T.S

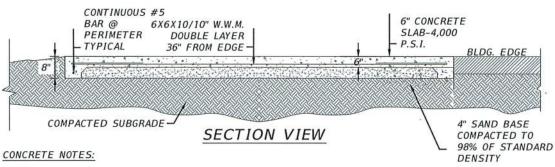

- THE DESIGN OF FOUNDATIONS AND SLAB-ON-GRADE IS BASED ON AN ASSUMED MINIMUM BEARING CAPACITY
 OF 2,000 PSF.
- 2. THE AREA UNDER FOOTINGS, FOUNDATIONS, AND CONCRETE SLABS-ON-GRADE SHALL HAVE ALL VEGETATION, STUMPS, ROOTS, AND FOREIGN MATERIALS REMOVED PRIOR TO THEIR CONSTRUCTION. FILL MATERIAL AND BACKFILL MATERIAL SHALL BE FREE OF ORGANIC MATERIAL, CONSTRUCTION DEBRIS, LARGE ROCKS, AND ANY OTHER FOREIGN MATERIAL.
- 3. THE CONTRACTOR SHALL INVESTIGATE ACTUAL LOCATIONS OF UNDERGROUND LINES AND UTILITIES BEFORE EXCAVATION. ALL EXCAVATIONS NEAR THESE LINES SHALL BE CARRIED OUT WITH EXTREME CAUTION.
- A MINIMUM CONCRETE COVER OF 3" SHALL BE PROVIDED FOR ALL REINFORCING STEEL.
 REINFORCING STEEL:REINFORCING STEEL BARS.....ASTM A-615 GRADE 40 WELDED WIRE FABRIC....

CONCRETE PAD DETAIL

SIGN FTP-20-06-REFLECTIVE BLUE REFLECTIVE WHITE REFLECTIVE WHITE REFLECTIVE WHITE-1.5" SERIES "C" LETTERS-ONLY REFLECTIVE 1.25"-BLACK BORDER WHITE LETTERS S250 FINE AND LETTERS REFLECTIVE BLUE-SIGN FTP 55 FINE =\$250.00 FINE AMOUNT VARIES FROM CITY/COUNTY. REFER TO LOCAL -POST JURISDICTION FOR AMOUNT. CONTRACTOR SHALL VERIFY FINISHED GRADE

SIGN NOTES:

. SIGN CONSTRUCTION, DESIGN AND PLACEMENT SHALL COMPLY WITH STATE AND LOCAL STATUES.

MS21 HANDICAP PARKING SIGN DETAIL SCALE: N.T.S

REVISIONS
DATE DESCRIPTION

SCALE: N.T.S

A-185



NORTH FLORIDA PROFESSIONAL SERVICES, INC.

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2551 BLAIRSTONE PINES DR. TALLAHASSEE, FL 32301 WWW.NFPS.NET CA# 29011 JOB NUMBER: L220810CCB EOR: GREGORY G. BAILEY P.E. NO.: 43858 MISC. DETAILS


BETHLEHEM PARK

COLUMBIA COUNTY, FLORIDA


SHEET NO.

C-14

SHEET IS THE ELECTRONIC FILE DIGITALLY SIGNED AI

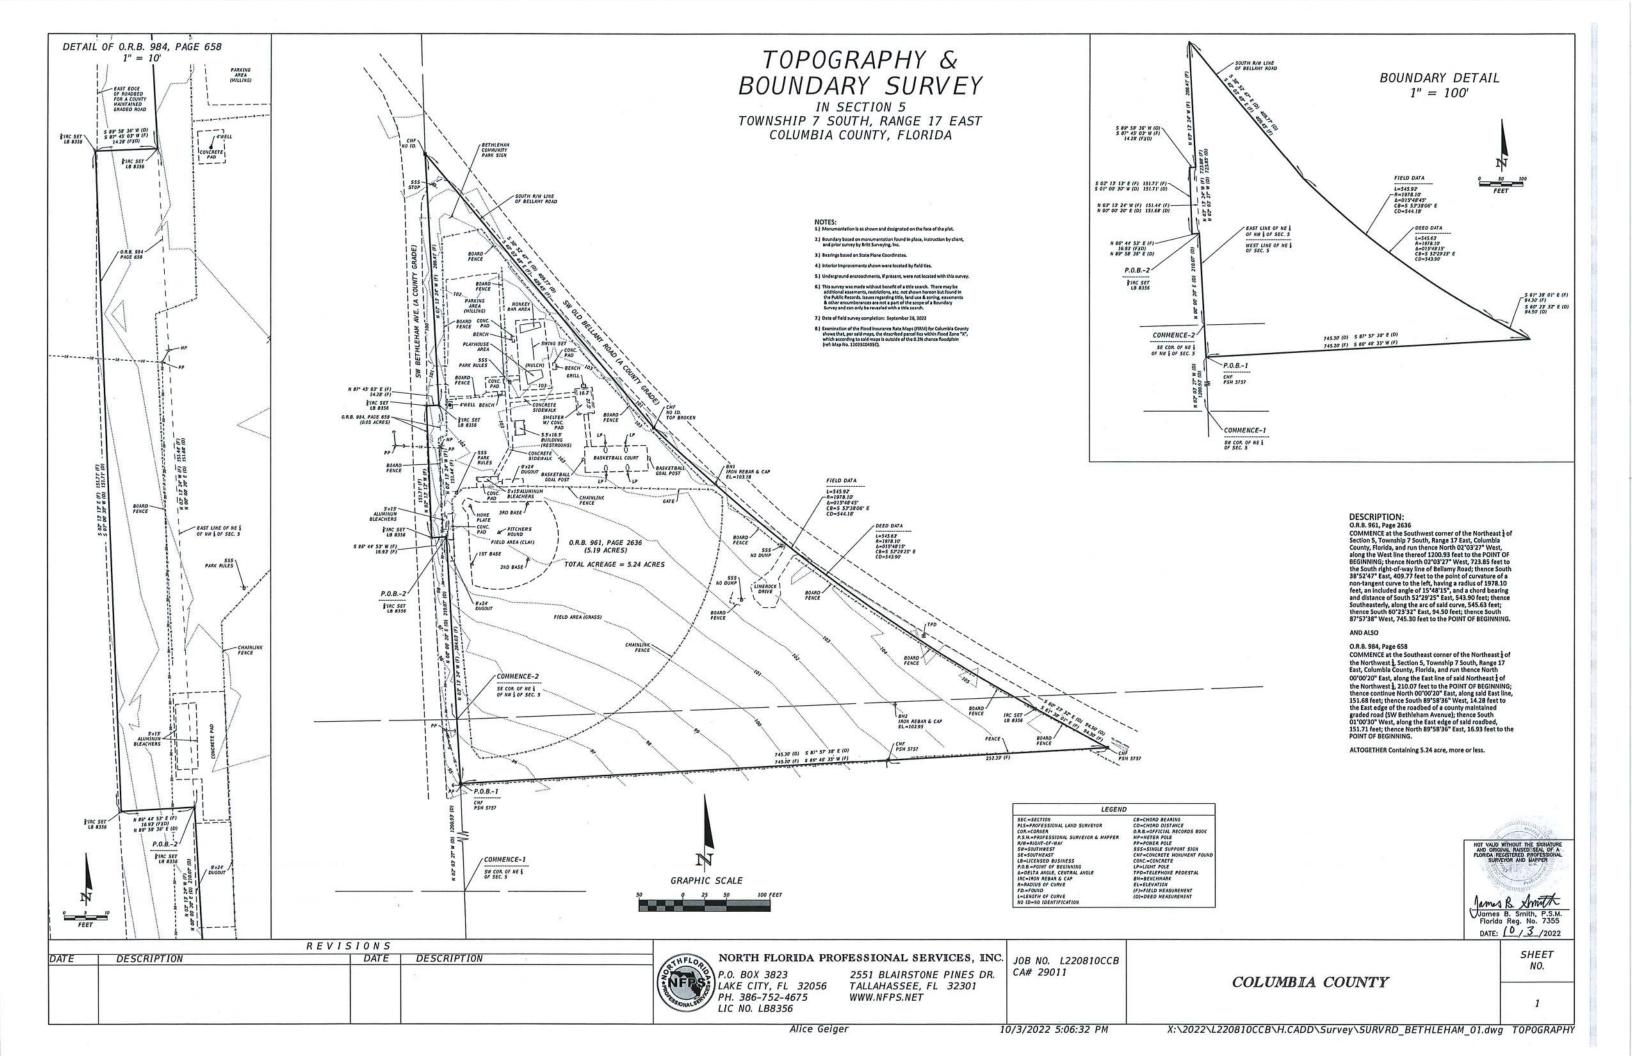

BUILDING CONSTRUCTION PLANS BETHLEHEM PARK ASSEMBLY BUILDING COLUMBIA COUNTY, FL.

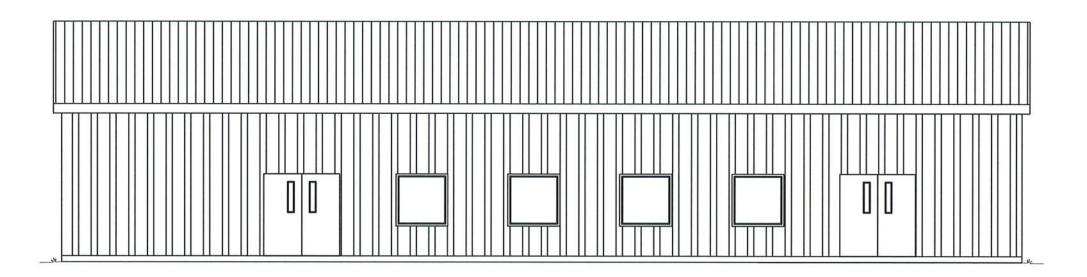



REVISIONS DATE

NORTH FLORIDA PROFESSIONAL SERVICES, INC. P.O. BOX 3823

LAKE CITY, FL 32056 PH. 386-752-4675 LIC NO. LB8356

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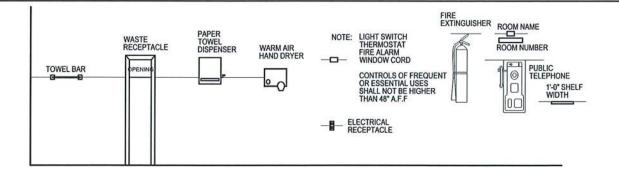
JOB NUMBER: L220810CCB ROBERT PHILLIP BISHOP JR. P.E. NO.:

COVER SHEET BETHLEHEM PARK ASSEMBLY BUILDING

COLUMBIA COUNTY, FLORIDA

SHEET NO.

G1



* BACK GRAB BAR SHALL BE MOUNTED 6" OFF SIDE WALL AND MIN. 36" LONG

ABBREVIATIONS LEGEND

GENERAL MOUNTING HEIGHTS

	7 (00)	<u>, </u>	WITHOUT LLOE	-1 10	OLIVLIVAL IVIC
A.B. ACOUS. ALT. ALUM. ANL. A.P. A.T.	ANCHOR BOLT ACOUSTICAL ALTERNATE ALUMINUM ANGLE ACCESS PANEL ACOUSTICAL TILE	DBL. DET. DIA. DIM. DISP. D.P.M. D.S. D.W.	DOUBLE DETAIL DIAMETER DIMENSION DISPENSER DAMPPROOFING MEMB. DOWNSPOUT DRYWALL	S.B.C. SCHED. S.D. S.F. SH. SHT. S.N.R. S.S.	SOUTHERN BUILDING CODE SCHEDULE SOAP DISPENSER SQUARE FEET SHELF SHEET SANITARY NAPKIN RECEPTACLE STAINLESS STEEL
BD. B.J. BLDG. BLK(G)	BOARD BAR JOIST BUILDING BLOCKING	EA. E.J. ELEC.	EACH EXPANSION JOINT ELECTRICAL	STD. STL. SUSP.	STANDARD STEEL SUSPENDED
BM. B.M. BOT. BRG. BRK. B.S.	BEAM BENCH MARK BOTTOM BEARING BRICK BOTH SIDES	ELEV. EQ. E.W.C. EXIST. EXT.	ELEVATION EQUAL ELECTRICAL WATER COOLER EXISTING EXTERIOR	TEMP. THK. T.P.D. T.S. TYP.	TEMPERED THICK TOILET PAPER DISPENSER TUBULAR STEEL TYPICAL
B.U.R.	BUILT-UP ROOFING BY (2X4)	F.D. F.E. F.E.C.	FLOOR DRAIN FIRE EXTINGUISHER FIRE EXT. CABINET	U.N.O. UR.	UNLESS NOTED OTHERWISE URINAL
CAB. C.I. C.J. CL. C.L.	CABINET CAST IRON CONSTRUCTION JOINT CENTERLINE CHAIN LINK CEILING	F.F. FIN. FIXT. FLR. FLSHG. FTG.	FINISH FLOOR FINISH FIXTURE FLOOR	V.C.T. VERT. V.P.B VTR. V.T.	VINYL COMPOSITE TILE VERTICAL VENEER PLASTER BASE VENT THROUGH ROOF VINYL TILE
CLG. CLR. C.M.U C.O COL. CONC. CONT. CONT. CPT. C.T.	CLEAR CONCRETE MASONRY UNIT CLEAN OUT COLUMN CONCRETE CONNECTION CONTINOUS CARPET CERAMIC TILE	FUR. F.V.	FURRING FIELD VERIFY SHEET INDEX	W. W/ W.C. WCO WD. W/O W.P. W.W.F. W.W.F.	WIDE WITH WATER CLOSET WALL CLEAN OUT WOOD WITHOUT WATERPROOFING WIDE WELDED FABRIC WELDED WIRE MESH
CTR. C.W.	COLD WATER	/ED 01/EE	Particle and the Date of the Control	0.1	481111111111

UNIT F.V. FIELD VERIFY	W/ WITH W.C. WATER CLOSET WCO WALL CLEAN OUT WD. WOOD W/O WITHOUT W.P. WATERPROOFING W.W.F. WIDE WELDED FABRIC W.W.M. WELDED WIRE MESH
SHEET INDEX	
COVER SHEET LEGENDS, SHEET INDEX & ABBREVIATIONS FLOOR PLAN EXTERIOR ELEVATIONS EXTERIOR ELEVATIONS SCHEDULES & NOTES FOUNDATION PLAN FOUNDATION DETAILS FOUNDATION DETAILS FOUNDATION NOTES ROOF PLAN WALL SECTION STRUCTURAL NOTES STRUCTURAL NOTES HVAC PLAN HVAC NOTES SANITARY PLUMBING PLAN WATER SUPPLY PLAN PLUMBING NOTES SANITARY RISER DIAGRAM ELECTRICAL LIGHTING PLAN LIFE SAFETY PLAN	G1 G2 B1 B2 B3 B4 S1 S2 No. 38546 S3 S4 STATE OF S6 S6 S7 S8 M1 M2 P1 P2 P3 P4 E1 E2 LS1

	SYMBOLS LEGEND
TYPE	DESCRIPTION
<u> </u>	SECTION
0	DETAIL MARK
•	REFERENCE (TO ANOTHER SECTION OR DETAIL)
000	ROOM NUMBER
(a)	DOOR (WITH MARK SYMBOL)
	WINDOW (WITH MARK SYMBOL)
\$ —	TARGET ELEVATION (EXISTING ELEVATION MARK NOT SHADED)

	MATERIALS LEGEND				
TYPE	DESCRIPTION				
	BATT INSULATION				
	BRICK VENEER				
	POURED IN PLACE CONCRETE SECTION				
	RIGID INSULATION				
	WOOD FRAMING (IN SECTION)				
	8" CONCRETE BLOCK				

REVISIONS DATE



NORTH FLORIDA PROFESSIONAL SERVICES, INC.

P.O. BOX 3823 LAKE CITY, FL 32056 PH. 386-752-4675 LIC NO. LB8356

2551 BLAIRSTONE PINES DR. TALLAHASSEE, FL 32301 WWW.NFPS.NET CA# 29011


JOB NUMBER: L220810CCB EOR: ROBERT PHILLIP BISHOP JR. P.E. NO.:


ABBREVIATIONS & SYMBOLS


BETHLEHEM PARK ASSEMBLY BUILDING COLUMBIA COUNTY, FLORIDA

SHEET

G2

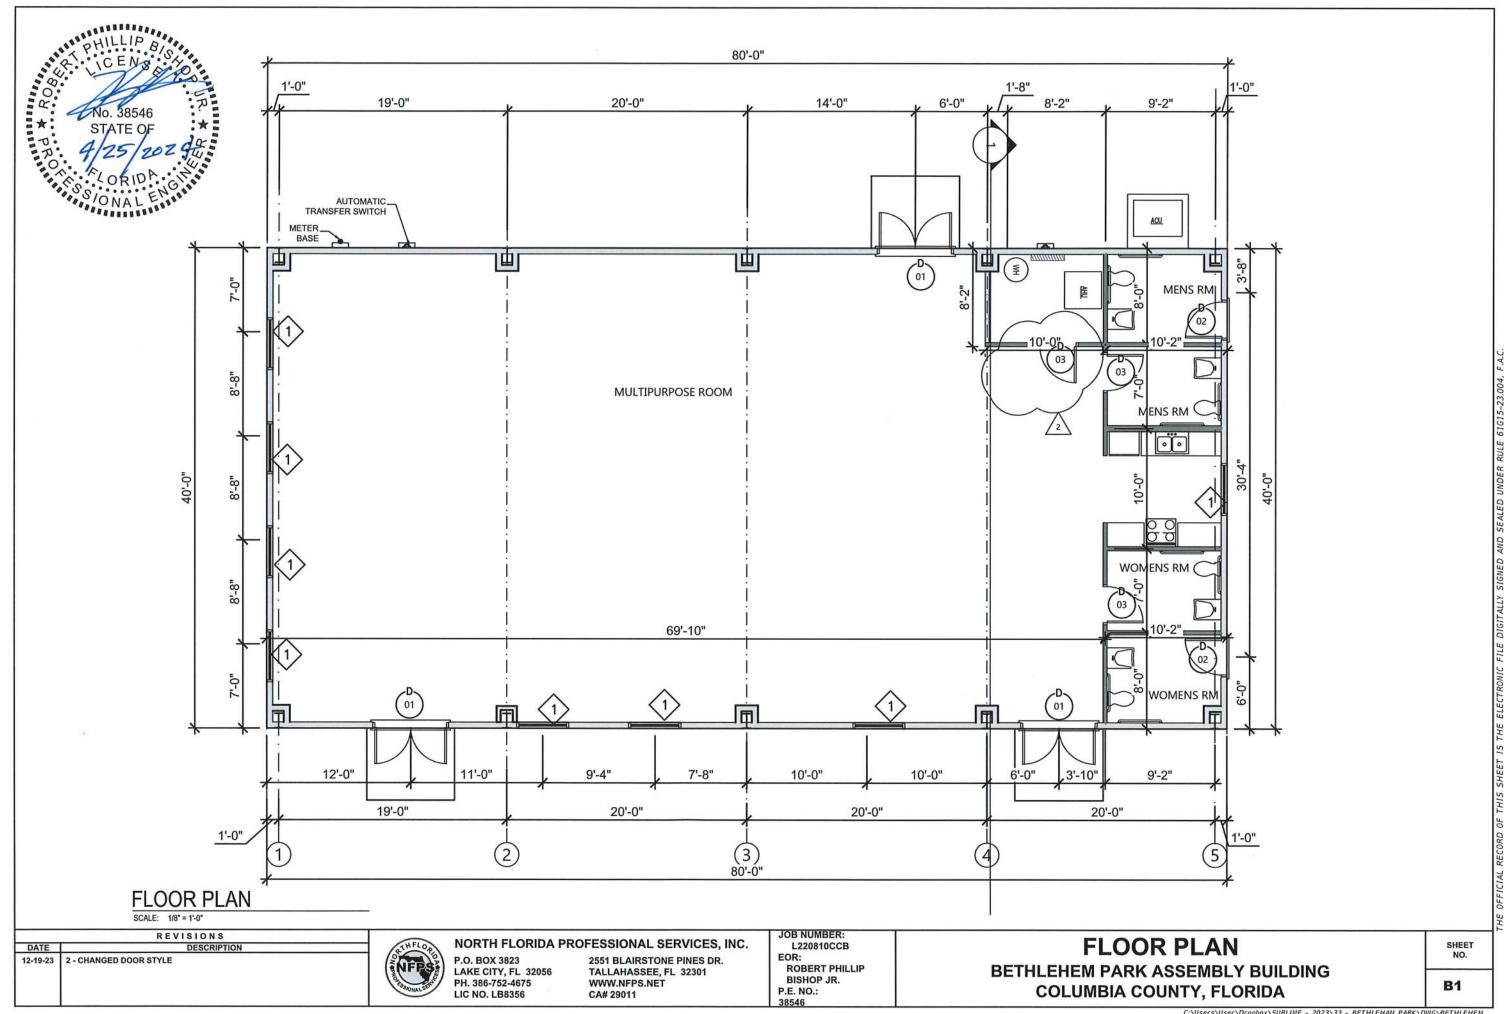

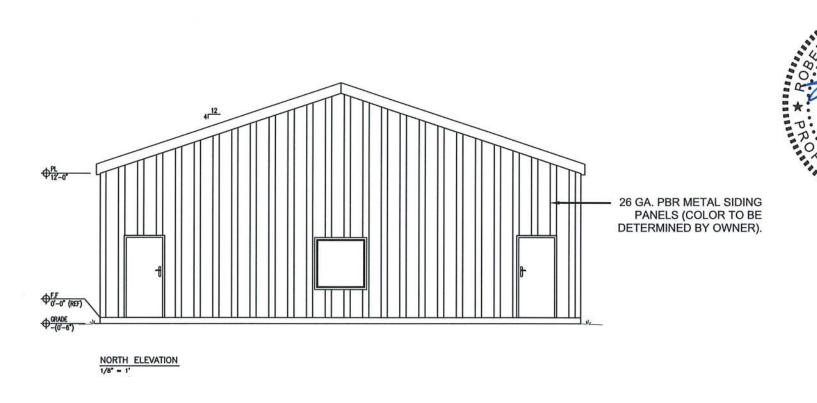

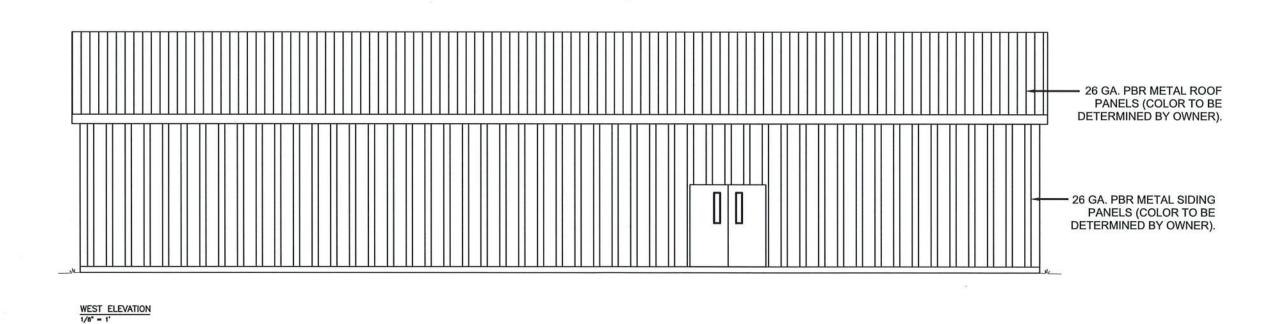

R E VISIONS
DATE DESCRIPTION



NORTH FLORIDA PROFESSIONAL SERVICES, INC.


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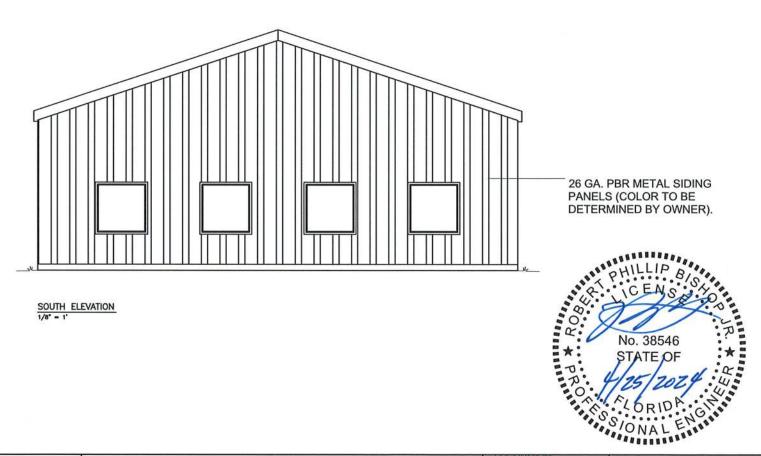
EXTERIOR ELEVATIONS

BETHLEHEM PARK ASSEMBLY BUILDING COLUMBIA COUNTY, FLORIDA

SHEET NO.

B2



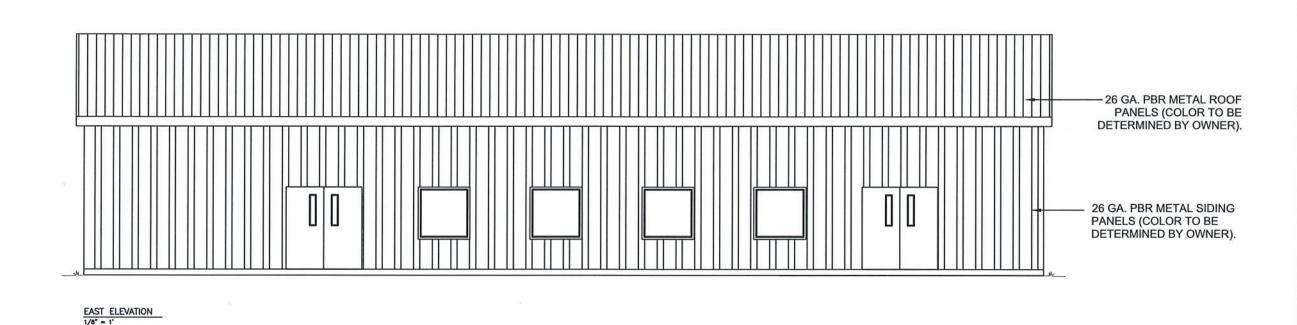

R E VISIONS

DATE DESCRIPTION

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NORTH FLORIDA PROFESSIONAL SERVICES, INC. P.O. BOX 3823 2551 BLAIRSTONE PINES DR.

P.O. BOX 3823 2551 BLAIRSTONE PINES D LAKE CITY, FL 32056 TALLAHASSEE, FL 32301 PH. 386-752-4675 WWW.NFPS.NET LIC NO. LB8356 CA# 29011 JOB NUMBER: L220810CCB EOR: ROBERT PHILLIP BISHOP JR. P.E. NO.:

38546

EXTERIOR ELEVATIONS

BETHLEHEM PARK ASSEMBLY BUILDING COLUMBIA COUNTY, FLORIDA

SHEET NO.

В3

MARK

TYPE I SOLID CORE, FLUSH TYPE II 18 GA. STEEL WITH WITH WOOD FRAME (STAIN GRADE) STEEL FRAME, (BRONZE FINISH) THRESHOLD, AND WEATHER STRIPPING

WIDTH HEIGHT

6'-0" 6'-8"

6'-8"

3'-0"

ALUM - ALUMINUM FRAME

STEEL FRAME, (BRONZE FINISH) THRESHOLD, AND WEATHER STRIPPING

PAINT

PAINT

FINISH HDW REMARKS

STEEL FRAME, (BRONZE FINISH) SIDE LITE, THRESHOLD, AND WEATHER STRIPPING

HARDWARE LIST

- A PRIVACY LOCK, CLOSER
- B PASSAGE SET, CLOSER
- C PASSAGE SET
- D KEYED LOCK
- E KEYED LOCK, PANIC DEVICE, CLOSER
- F KEYED LOCK, CLOSER

ALL DOOR HARDWARE SHALL BE COMMERCIAL GRADE 1 AND SHALL HAVE A BRUSHED NICKEL FINISH AND COMPLY WITH REQUIREMENTS OF FLORIDA ACCESSIBILITY CODE.

FIN	ISH	SCH	FDI	IIF
LIIA	O	SUL		JLE

ROOM NAME	FLOOR	BASE	WALLS		CEILING		
			MAT'L	FIN.	MAT'L	FIN.	HEIGHT
ASSEMBLY AREA	VCT	VB	GWB	HARD	SAT		9'-0"
KITCHEN AREA	VCT	VB	GWB	HARD	SAT		9'-0"
MECHANICAL ROOM	CONC	VB	GWB	HARD	GWB	KD/P	8'-0"
ADA RESTROOM #1	TILE	TILE	СВ	TILE	GWB	KD/P	8'-0"
ADA RESTROOM #1	TILE	TILE	СВ	TILE	GWB	KD/P	8'-0"
ADA RESTROOM #1	TILE	TILE	СВ	TILE	GWB	KD/P	8'-0"
ADA RESTROOM #1	TILE	TILE	СВ	TILE	GWB	KD/P	8'-0"

CONC -- SEALED WITH A NON-SKID CLEAR CONCRETE SEALER -- LUXURY VINYL PLANK COMMERIAL GRADE FLOORING

-- CERAMIC TILE, WALLS - 6"x6", FLOORS - 12"x12"

VB -- VINYL BASE, CONTINUOUS ROLL

-- GYPSUM WALLBOARD (BLUE BOARD IN WET AREAS)

-- CEMENT BOARD BEHIND WALL TILE -- HARD COATED PLASTER FINISH, LIGHT TEXTURE

-- SUSPENDED ACOUSTICAL TILE, 2'x2' GRID (WHITE), ARMSTRONG 589 TEGULAR

KD/P -- KNOCK DOWN TEXTURE, PAINTED
UNFIN -- EXTERIOR WALLS IN TRUCK BAYS AND 2nd FLOOR MEETING
AREA ARE UNFINISHED

MILL WORK & VINYL BASE
KITCHEN CABINETS AND VANITY CABINETS SHALL HAVE ½" PLYWOOD BOXES
WITH SOLID MAPLE HARDWOOD FACE FRAMES, DOORS SHALL HAVE RAISED
PANELS WITH FULLY CONCEALED SELF-CLOSING HINGES. DRAWERS SHALL
HAVE HARDWOOD FACES AND PLYWOOD BOXES AND FULL ACCESS, SELF-CLOSING DRAW GLIDES. ALL SHELVES SHALL BE 2" THICK ENGINEERED WOOD WITH PVC EDGE BANDING. ALL BASE CABINETS, INCLUDING VANITIES SHALL BE 24" DEEP X 36" HIGH (TO TOP OF COUNTERTOPS) AND WALL CABINETS SHALL BE 12" DEEP BY 42" HIGH. KITCHEN COUNTERTOPS SHALL HAVE A PLYWOOD

SHALL BE 12 DEEP BY 42 FIGH. NITCHEN COUNTERTORS SHALL HAVE A PLYWOOD SUBSTRATE WITH A LAMINATE SURFACE. VANITY TOPS SHALL BE CULTURED MARBLE WITH INTEGRAL SINK BASE.

THE VINYL BASE SHALL BE FLEXCO OR EQUAL AND SHALL BE A MINIMUM OF 1/8*

THICK BY 4" HIGH AND SHALL BE A CONTINUOUS ROLL. NO 4 FOOT LENGTHS

WILL BE ALLOWED. CONTRACTOR SHALL PROVIDE COLOR SAMPLES FOR SELECTION BY THE OWNER.

ALLOWANCES FOR BATHROOM FIXTURES, CERAMIC TILE & LVT

ALLOWANCES FOR BATHROOM FIXTURES, CERAMIC TILE & LVT
PROVIDE A \$1,200.00 ALLOWANCE FOR BATHROOM FIXTURES TO BE SELECTED BY OWNER
(I.E. TOWEL BARS, TOILET PAPER DISPENSERS, PAPER TOWEL DISPENSERS, ETC.) NOTE: SINKS,
TOILETS, AND PLUMBING FIXTURES NOT INCLUDED.
CONTRACTOR SHALL PROVIDE AN ALLOWANCE OF \$4.00 PER SQUARE FOOT FOR ALL 12X12 FLOOR
TILE AND WALL TILE. THE ALLOWANCE SHALL BE FOR TILE ONLY. ALL ADHESIVE, GROUT, METAL
TRIM AND INSTALLATION COSTS SHALL BE INCLUDED IN THE BASE BID. CONTRACTOR WILL PROVIDE
WITH OWNER SAMPLES TO SELECT FROM. NO SPECIAL TRANSITION TILES AT THE FLOORWALL
INTERFACE IS REQUIRED. WALL TILE SHALL BUTT TO FLOOR TILE. TRAVERTINE THRESHOLDS SHALL
BE PROVIDED AT ALL DOOR WAYS WITH DIFFERING FLOOR MATERIALS.
CONTRACTOR SHALL PROVIDE AN ALLOWANCE OF \$8.00 PER SQUARE FOOT FOR THE LUXURY VINYL
PLANK FLOORING. THE ALLOWANCE SHALL BE FOR FLOORING ONLY. ALL OTHER INSTALLATION COSTS
SHALL BE INCLUDED IN THE BASE BID.

- ALL MATERIALS USED UNDER THE PAINTING CONTRACT SHALL BE BY APPROVED
 MANUFACTURER AND DELIVERED TO THE JOB IN THE ORIGINAL SEALED CONTAINERS.
- 2. ALL PAINTED SURFACES SHALL RECEIVED ONE PRIMER COAT AND ONE FINISH COAT.
- 3. BEFORE ANY WORK IS DONE, THE CONTRACTOR SHALL PREPARE COLOR AND TEXTURE SAMPLES ON THE JOB FOR THE OWNER'S FINAL APPROVAL.
- 4. EXTERIOR SURFACE PREPARATION: REMOVE ALL DIRT, OIL, AND OTHER CONTAMINANTS.
- 5. INTERIOR SURFACE PREPARATION: WASH SURFACES FREE OF DIRT, WAX, SOAP, AND GREASE, REPAIR CRACKS AND SURFACE IMPERFECTIONS IN PLASTER WITH A WATER MIX OR LATEX PATCHING PLASTER, SAND SMOOTH AND SPOT PRIME.
- 6. COLORS AND FINISH TO BE CHOSEN BY OWNER.
- 7. APPROVED MANUFACTURERS: SHERWIN WILLIAMS BENJAMIN MOORE GLIDDEN



MARK TYPE MAT'L FINISH REMARKS WIDTH HEIGHT

WINDOW SCHEDULE

4'-0" 4'-0" FIXED ALUM BLACK CUSTOM BUILT WINDOW (SEE DETAIL) ALL WINDOWS SHALL HAVE LOW 'e', INSULATED GLASS WITH TINTING (BRONZE)

DOOR SCHEDULE

MAT'L

STEEL

TYPE

③ 3'-0" 6'-8" I SC WOOD STAIN F

SONAL ES

REVISIONS

12/05/2023 UPDATED SCHEDULES AND NOTES

DATE

P.O. BOX 3823 LAKE CITY, FL 32056 PH. 386-752-4675 **LIC NO. LB8356**


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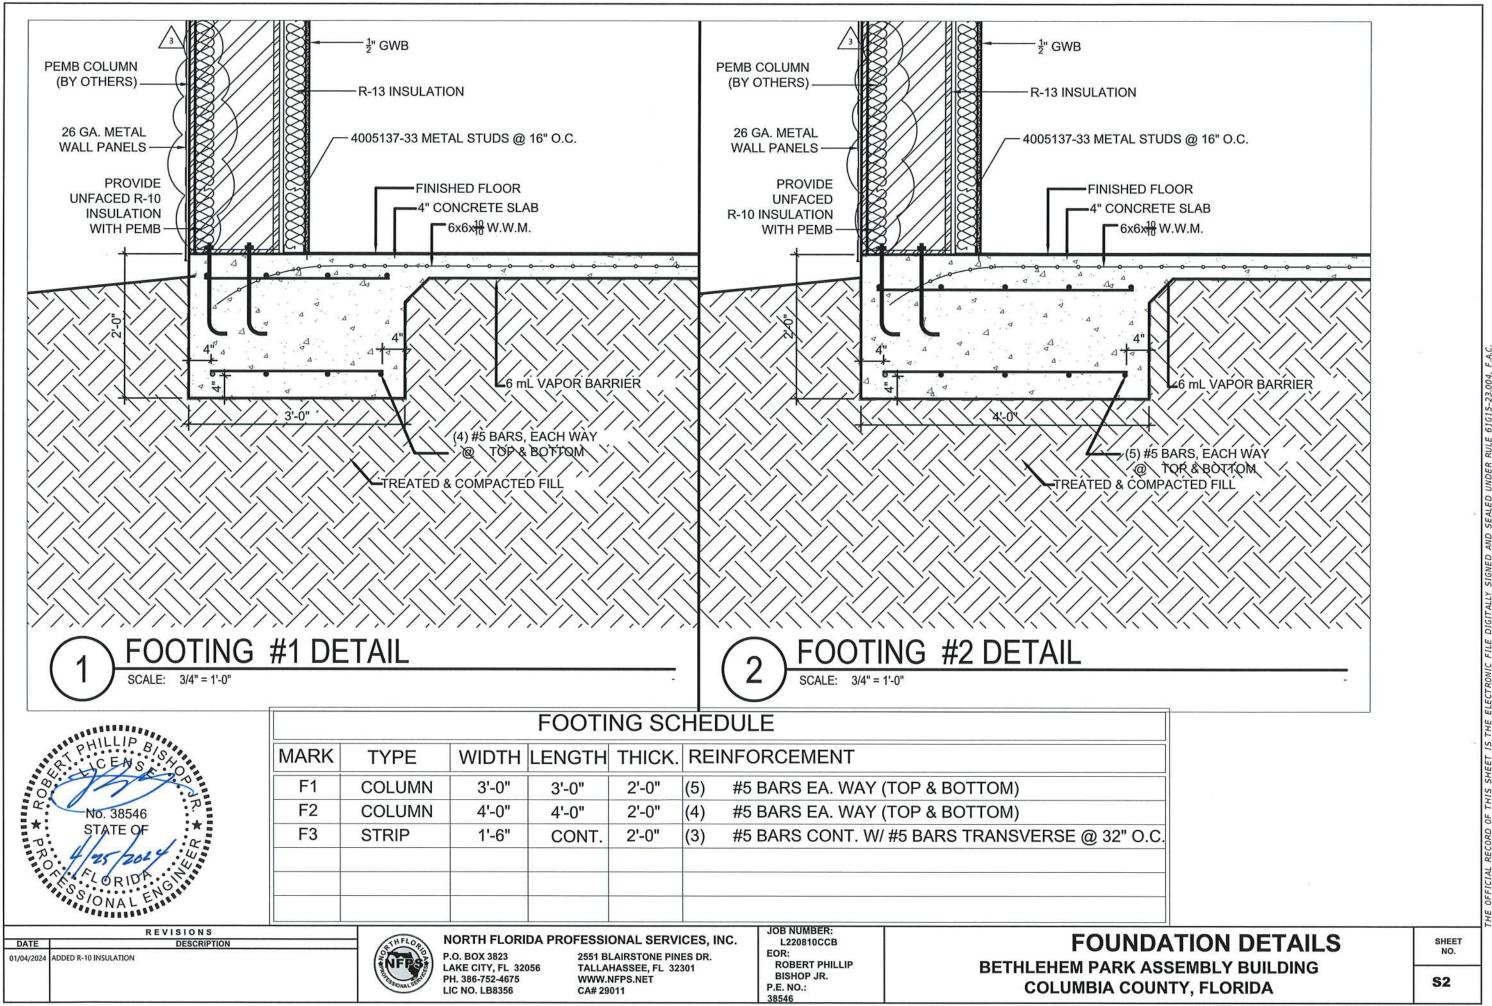
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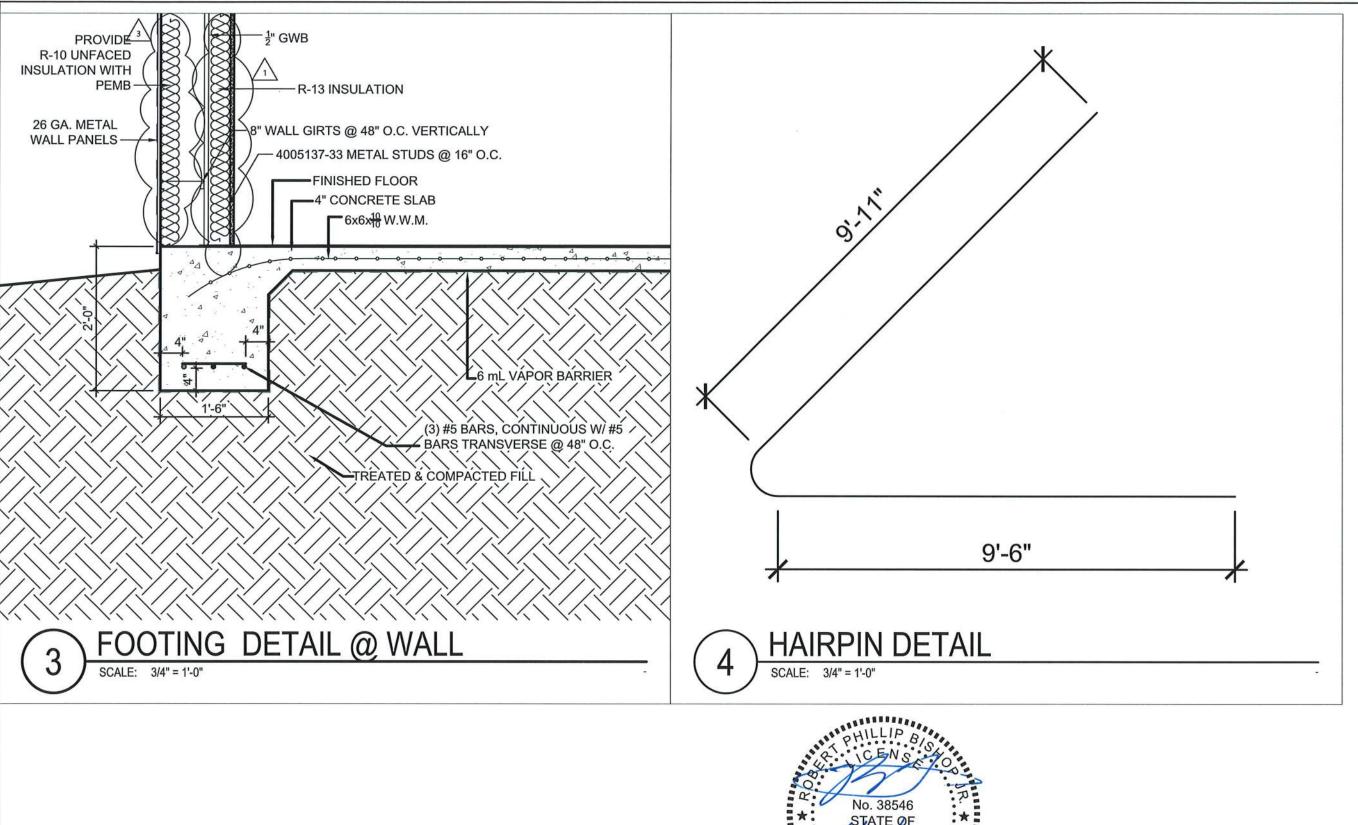
DOOR / WINDOW SCHEDULES BETHLEHEM PARK ASSEMBLY BUILDING **COLUMBIA COUNTY, FLORIDA**

SHEET NO.

B4





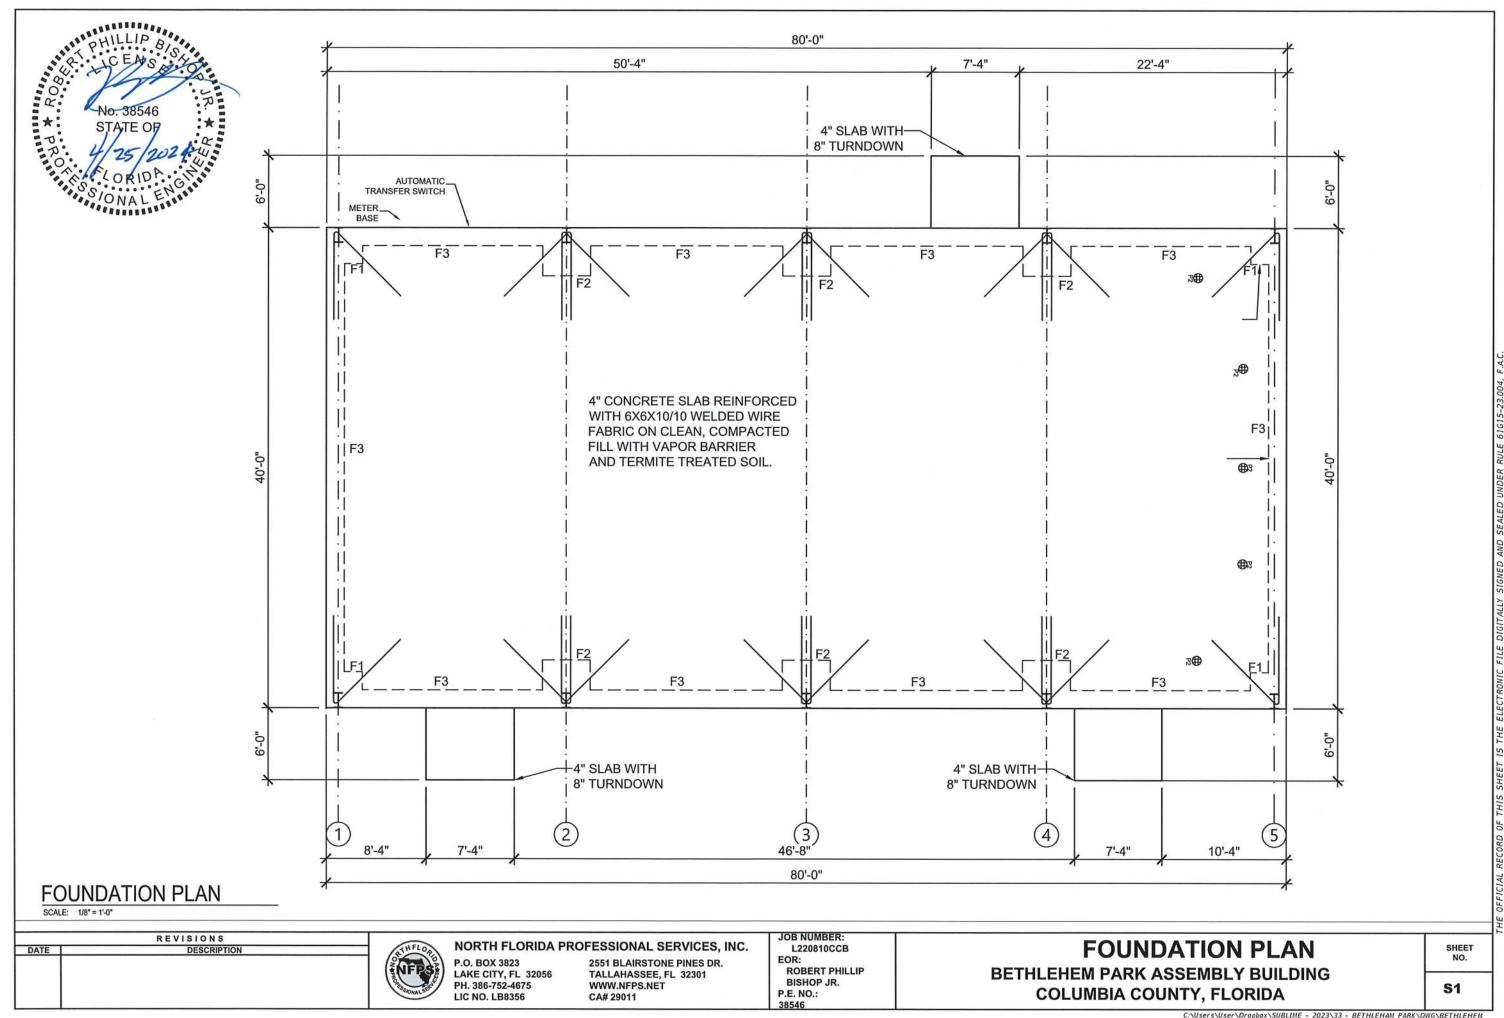

REVISIONS DESCRIPTION

REMOVED PLYWOOD ON WALL AND ADDED INTERIOR STUD WALL

DATE

LIC NO. LB8356

NORTH FLORIDA PROFESSIONAL SERVICES, INC. P.O. BOX 3823 2551 BLAIRSTONE PINES DR. LAKE CITY, FL 32056 PH. 386-752-4675

TALLAHASSEE, FL 32301 WWW.NFPS.NET CA# 29011

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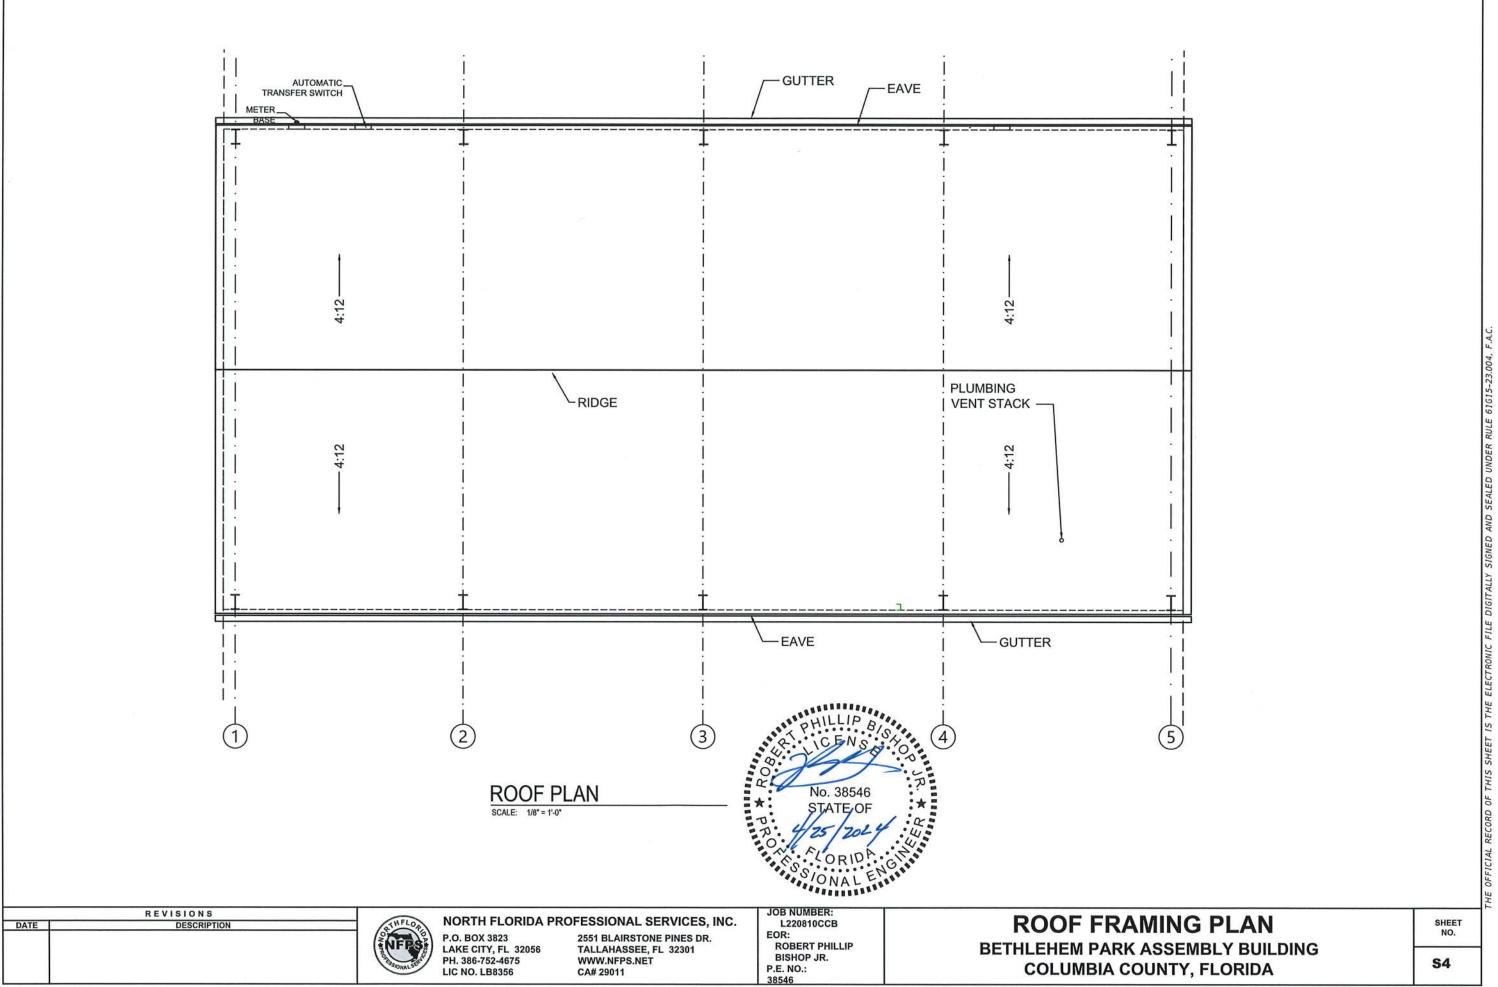
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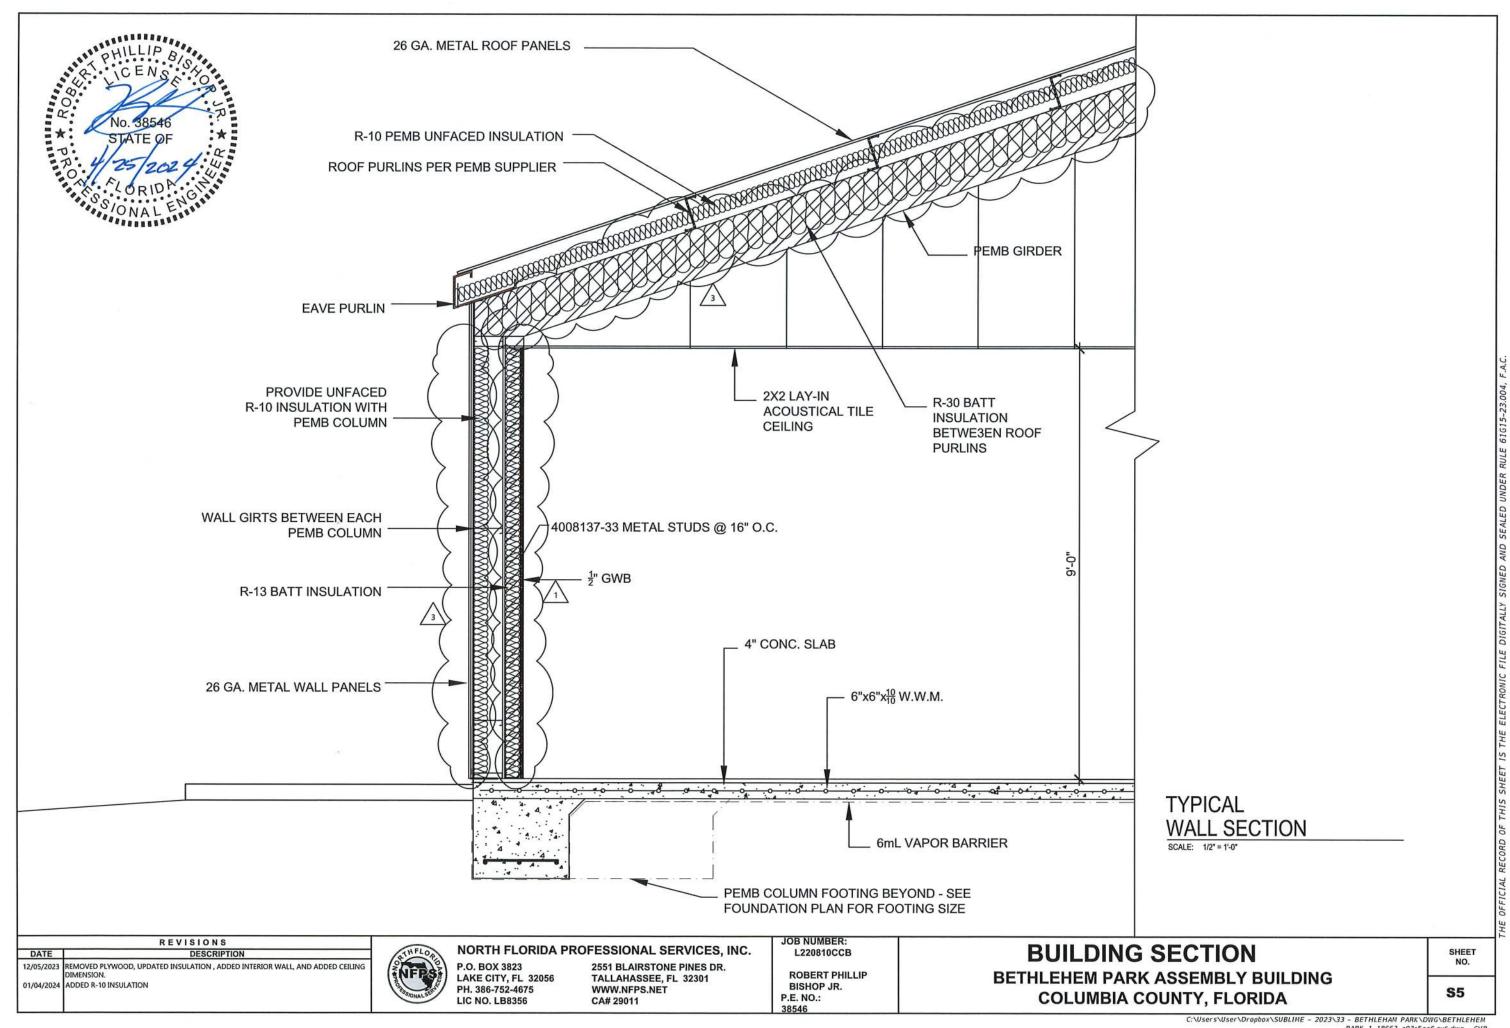
FOUNDATION NOTES BETHLEHEM PARK ASSEMBLY BUILDING

COLUMBIA COUNTY, FLORIDA

SHEET NO.

S3





GENERAL

- 1. THE CONTRACTOR SHALL COORDINATE BUILDING PLANS, MECHANICAL, ELECTRICAL, PLUMBING, AND CIVIL WORKS DOCUMENTS WITH THE STRUCTURAL CONTRACT DOCUMENTS. NOTIFICATION SHALL BE MADE TO THE ENGINEER AND OF ANY CONFLICT AND/OR OMISSIONS.
- THE DRAWINGS SHOWN ARE FOR TYPICAL AND CERTAIN SPECIFIC CONDITIONS ONLY. PROVIDE DETAILS SIMILAR TO THOSE SHOWN FOR DETAILS THAT ARE NOT SPECIFICALLY SHOWN.
- THE REVIEW OF SUBMITTALS AND/OR SHOP DRAWINGS BY THE ENGINEER DOES NOT RELIEVE THE CONTRACTOR OF THE SOLE RESPONSIBILITY TO REVIEW AND CHECK SHOP DRAWINGS PRIOR TO SUBMITTAL TO THE ENGINEER. THE CONTRACTOR REMAINS SOLELY RESPONSIBLE FOR ERRORS AND OMISSIONS ASSOCIATED WITH THE PREPARATION OF SHOP DRAWINGS AS THEY PERTAIN TO MEMBER SIZES, DETAILS, AND DIMENSIONS SPECIFIED IN THE CONTRACT DOCUMENTS. THE CONTRACTOR ALSO SHALL BE RESPONSIBLE FOR MEANS, METHOD, TECHNIQUES, SEQUENCES, AND PROCEDURES OF CONSTRUCTION.
- THE CONTRACTOR IS SOLELY RESPONSIBLE FOR THE DESIGN, CONSTRUCTION, AND ERECTION OF SAFE AND ADEQUATE BRACING, SHORING, TEMPORARY SUPPORTS, ETC. REQUIRED FOR STABILITY OF THE STRUCTURE DURING ALL INTERMEDIATE STAGES OF CONSTRUCTION
- IN NO CASE SHALL STRUCTURAL ALTERATIONS OR WORK AFFECTING A STRUCTURAL MEMBER BE MADE, UNLESS APPROVED BY THE ENGINEER OF RECORD IN WRITING.
- CONTRACTOR SHALL VERIFY ALL DIMENSIONS AND DETAILS SHOWN. NOTIFY THE ENGINEER OF ANY CHANGES OR MODIFICATIONS TO THE PLAN
- 7. ALL PRE-FABRICATED BUILDING ELEMENTS SHALL BE DESIGNED, FABRICATED AND ERECTED IN STRICT ACCORDANCE WITH ALL APPLICABLE CODES, SPECIFICATIONS AND REGULATIONS AND TO SUPPORT LOADS INDICATED IN THE STRUCTURAL DESIGN NOTES AND ANY CONCENTRATED LOADS. ALL REQUIRED BRACING (TEMPORARY AND PERMANENT) SHALL BE DESIGNED AND NOTED ON ERECTION DRAWINGS BY THE MANUFACTURER. CONTRACTOR SHALL PROVIDE SHOP DRAWINGS OF ALL PRE-FABRICATED ELEMENTS FOR REVIEW AND APPROVAL BY THE ENGINEER
- ALL FRAMING LUMBER SHALL BE SET AND SPACED AS INDICATED, SECURELY ATTACHED, NAILED, BRIDGED AND BLOCKED TO FORM A RIGID STRUCTURE. ALL WORK IS TO BE SECURELY SET, INCLUDING ANCHORING TO MASONRY AND CONCRETE.
- PROVIDE BLOCKING, NAILERS, PLATES AND OTHER MISCELLANEOUS WHERE SHOWN AND REQUIRED. SECURELY FASTEN BLOCKING IN PLACE. PLACE BOLTS IN CONCRETE, MASONRY AND STEEL FOR THE FASTENING OF BLOCKING AND PLATES WHERE SHOWN AND/OR REQUIRED.
- 10. ALL WOOD AND METAL STUDS SHALL BE SPACED AT 16"O.C, UNLESS OTHERWISE NOTED ON THE PLANS, WITH A SINGLE SOLE PLATE, DOUBLE TOP PLATE AND A CONTINUOUS ROW OF SOLID GIRTS AT THE CENTER OF HEIGHT. ALL OPENINGS SHALL HAVE WOOD NAILERS AT EACH JAMB AND HEADER.
- 11. ALL WALLS AND OTHER STRUCTURAL MEMBERS SHALL BE TEMPORARILY BRACED UNTIL PERMANENT BRACING IS IN PLACE.
- 12. ALL WINDOW AND DOOR HEADERS WITH A MAXIMUM SPAN OF 6'-0" IN A NONBEARING STUD WALL SHALL BE 2-6" METAL HEADERS FOR 4" WALLS.
- 13. ALL FLASHING AND WATERPROOFING BY CONTRACTOR.

THE STRUCTURAL ENGINEER SHALL NOT HAVE CONTROL OF BEINGER FOR CONSTRUCTION MEANS, METHODS, TECHNIQUES, PROCEDURES, OR SEQUENCES; FOR THE ACTS OF GMISSIONS OF THE CONTRACTOR OR ANY OTHER PERSONS PERFORMING THE WORK OR FOR THE FAILURE FOR ANY OF THEM TO CONSTRUCT THE WORK IN ACCORDANCE WITH THE CONTRACT DOCUMENTS.

25/2024 FOUNDATION PLAN ONLY CONVEYS STRUCTURAL INFORMATION. FOR GENERAL PLATURES, CONDUITS, ELECTRICAL EMBEDS, STEP HEIGHTS, ETC., SEE BUILDING PLANS. DO NOT SEALE FROTING DIMENSIONS AND LOCATION FROM THE FOUNDATION PLAN SHOWN. DO NOT DETERMINE FOOTING LOCATION BASED ON BATHER THE BUILDING PLAN OR FRAMING PLAN, BUT BY DIMENSIONS PROVIDED ON FOUNDATION PLAN. IF FOOTING SIZE OR LOCATION IS NOT DETERMINED ON PLAN THEN CONTACT THE ENGINEER OF RECORD (EOR).

No. 38546

STATE OF

UNLESS OTHERWISE NOTED ON DRAWINGS, MINIMUM CONCRETE COVER FOR REINFORCING SHALL BE 3" IN FOOTINGS AND WIRE MESH SHALL BE CENTERED IN SLAB ON GRADE. IN ALL CONTINUOUS FOOTINGS PROVIDE #3 BARS @ 48" O.C. OR ROD CHAIRS. PROVIDE CONTINUITY OF REINFORCING AT INTERSECTIONS OF PERPENDICULAR CONCRETE ELEMENTS BY INSTALLING CORNER BARS., MINIMUM OF 40 BAR DIAMETERS INTO EACH ELEMENT. SPLICES IN REINFORCING, WHERE PERMITTED SHALL BE 48 BAR DIAMETERS.

MASONRY STEMWALLS: ALL CONCRETE MASONRY UNITS SHALL BE COMPOSED OF ASTM C90E, GRADE N-1 HOLLOW CONCRETE MASONRY UNITS WITH TYPE 'S' MORTAR. WALL COURSING SHALL BE RUNNING BONDS, STACK BONDS SHALL NOT BE USED. GROUT ALL CELLS CONTAINING VERTICAL REINFORCEMENT WITH 3000psi PEA ROCK CONCRETE GROUT. SPLICES IN REINFORCING, WHERE PERMITTED, SHALL BE 48 BAR DIAMETERS. ALL CELLS BELOW FINISHED SHALL BE GROUTED SOOLID. ALL EXTERIOR WALLS SHALL BE REINFORCED FULL HEIGHT WITH #4 @ 4'-0" O.C. MAX. AND AT EACH CORNER, WALL END AND WALL INTERSECTIONS. PROVIDE CONTINUITY OF REINFORCING AT INTERSECTIONS OF PERPENDICULAR MASONRY ELEMENTS BY INSTALLING CORNER BARS, MINIMUM OF 40 BAR DIAMETERS INTO EACH ELEMENT. AT STEMWALL CONSTRUCTED OF 5 OR

> REVISIONS NORTH FLORIDA PROFESSIONAL SERVICES, INC. DESCRIPTION

RREVISED NOTES REVISED NOTES 12/19/2023



P.O. BOX 3823 LAKE CITY, FL 32056 PH. 386-752-4675

LIC NO. LB8356

2551 BLAIRSTONE PINES DR. TALLAHASSEE, FL 32301 WWW.NFPS.NET CA# 29011

JOB NUMBER:

BISHOP JR.

P.E. NO .:

L220810CCB

ROBERT PHILLIP

MORE COURSES, PROVIDE HORIZONTAL JOINT REINFORCEMENT AT 16" O.C. VERTICALLY (EVERY OTHER COURSE), AND VERTICAL REINFORCEMENT SHALL BE INCREASED AS NOTED UNLESS NOTED OTHERWISE.. LAP JOINT REINFORCING SHALL BE A MINIMUM OF 6".

CONCRETE SLABS ON GRADE:

SHALL BE INSTALLED OVER MIN. 6 MIL POLYETHYLENE VAPOR RETARDER WITH JOINTS LAPPED 6" AND SEALED OVER CLEAN, COMPACTED EARTH OR FILL WITH APPROVED CHEMICAL SOIL TREATMENT FOR PREVENTION OF SUBTERRANEAN

FOR CONTROLLED CRACKING, CUT A 1" SAWCUT INTO SLAB IN A 20'BY20' GRID WITHIN 12 HOURS OF CONCRETE PLACEMENT. PROVIDE SAWCUTS THROUGHOUT SLAB AND WHERE SHOWN ON FOUNDATION PLAN. CONTACT EOR FOR ALTERNATIVE METHODS.

CONCRETE NOTES

- 1.) FOUNDATION DESIGN IS BASED UPON AN ASSUMED SOIL BEARING CAPACITY OF 2,000 P.S.I. CONTRACTOR SHALL CONFIRM SOIL CAPACITY WITH A MINIMUM OF 3 SOIL COMPACTION TESTS INSIDE THE FOOTPRINT OF THE BUILDING. TEST BY A FLORIDA LICENSED SOIL ENGINEER = PROVIDE TEST RESULTS TO ENGINEER FOR REVIEW.
- 2.) REMOVE ALL DEBRIS, SHELL MARL, ORGANIC MATERIALS AND ANY OTHER DELETERIOUS MATERIALS PRIOR TO THE PLACEMENT OF SOIL FILL.. REMOVE TO A DISTANCE OF 5 FEET BEYOND THE FOUNDATION AND ANY HORIZONTAL SLAB WORK.
- ALL SOIL FILL MATERIAL SHALL BE PLACED AND COMPACTED IN 10" LIFTS MAXIMUM. AFTER FILL IS BROUGHT TÓ FINAL GRADE, PERFORM SOIL COMPACTION TESTS AT A RATE OF 2,000 SQ. FT. OF FOUNDATION AREA PER TEST. COMPACTION SHALL BE 98% MODIFIED PROCTOR. WATER CAN BE ADDED TO THE SOIL TO OBTAIN COMPACTION IF DEEMED ACCEPTABLE TO THE SOIL TESTING COMPANY. PERFORM SOIL COMPACTION TEST UNDER EVERY OTHER STRUCTURAL FOOTING. IF COMPACTION IS LESS THEN SPECIFIED, TEST THE NEXT ADJACENT FOOTING UNTIL COMPACTION IS AS SPECIFIED.
- 4.) CONCRETE SHALL BE 3,000 P.S.I. DESIGN MIX AS CERTIFIED FROM BATCH PLANT. SLUMP SHALL BE IN THE RÁNGE OF 4" TO 6" UNLESS BATCH PLANT ADDS PLASTICIZER AND CAN VERIFY THAT CONCRETE WILL TEST ABOVE 3,000 P.S.I. AT 28 DAYS. TAKE SLUMP TEST ON FIRST CONCRETE TRUCK AND EVERY 5 ADDITIONAL TRUCKS IE. TRUCK 1, TRUCK 6, TRUCK 11 ETC.. TAKE 4 CONCRETE TEST CYLINDERS FROM THE SAME TRUCKS AND PERFORM CONCRETE BREAKS AT 7 DAYS, 14 DAYS AND 28 DAYS TO VERIFY CONCRETE STRENGTH.
- 5.) CONCRETE SHALL BE PLACED PER A.C.I. STANDARDS AND AN ELECTRIC VIBRATOR SHALL BE UTILIZED TO CONSOLIDATE CONCRETE CONSISTENTLY AROUND FORMS AND REINFORCING MATERIALS. SURFACE FLATNESS SHALL BE 3/16" OR LESS MEASURED IN ANY 10 FOOT DIRECTION AND OVERALL SLAB SHALL BE WITHIN 1/8" OF LEVEL AT THE CORNERS OF THE BUILDING. CONCRETE SUB-CONTRACTOR SHALL BE RESPONSIBLE FOR ANY REPAIRS TO MAKE THE SLAB FLATNESS AND LEVELNESS MEET THESE REQUIREMENTS
- 6.) ALL REINFORCING STEEL WITH DEFORMATIONS SHALL BE GRADE 60 AND SHALL CONFORM TO ASTM A615. ALL CÓNTINUOUS STEEL SHALL BE LAPPED PER ACI 315 OR MINIMUM OF 12" WHICHEVER IS GREATER. ALL STEEL FABRICATION AND PLACEMENT SHALL MEET ACI 315 AND MINIMUM STEEL COVER SHALL COMPLY WITH ACI 318. WELDED WIRE MESH SHALL CONFORM TO ASTM A185 AND MESH SHALL LAP MINIMUM ONE FULL MESH WIDTH TYPICAL.
- 7.) ALL CONCRETE SHALL BE FINISHED AS FOLLOWS: FINISH FLOOR SLAB MACHINE TROWEL SMOOTH FINISH & SIDEWALKS - BROOM FINISH
- 8.) COORDINATE FLOOR FINISHES W/. CONTRACTOR & DEPRES SLABS TO ACCOMMODATE FLOOR FINISHES & EQUIPMENT
- 9.) FOR DIMENSIONS NOT SHOWN ON THE STRUCTURAL CONTRACT DOCUMENTS, SEE THE BUILDING PLANS.
- 10.) THE CONTRACTOR SHALL VERIFY EXISTING SITE CONDMA
 DIMENSIONS AND ELEVATIONS PRIOR TO STARTING WORK. THE ENGINEER SHALL BE NOTIFIED IN WRITING IF ANY DISCREPANCIES IN EXISTING SITE CONDITIONS, DIMENSIONS OR ELEVATIONSTO THOSE SHOWN IN THE STRUCTURAL DOCUMENTS CONTRACT.
- 11.) FOOTINGS AND FOUNDATIONS SHALL BE IN ACCORDANCE WITH LOCAL BUILDING CODES. FOOTINGS HAVE BEEN DESIGNED WITH A SOIL BEARING (DESIGN MAXIMUM) OF 2000psf. A SOIL INVESTIGATION REPORT IS RECOMMENDED TO VERIFY SUITABLE SUBSURFACE CONDITIONS. IF THE FOOTING ELEVATIONS SHOWN OCCUR IN A DISTURBED OR UNSTABLE SOIL, THE ENGINEER SHALL BE NOTIFIED. SOIL SHALL BE FREE OF ORGANIC MATERIAL AND COHESIVE (CLAY) SOILS. SOIL COMPACTION AND FILL SHALL BE COMPACTED TO A MIN. OF 95% MODIFIED PROCTOR IN ACCORDANCE WITH ASTM D 1557.

STRUCTURAL NOTES

BETHLEHEM PARK ASSEMBLY BUILDING COLUMBIA COUNTY, FLORIDA

SHEET

MATERIAL SPECIFICATIONS:

HARDWARE AND ANCHORS:

ANCHOR BOLTS & THREADED ROD: SHALL BE IN ACCORDANCE WITH ASTM A 307 OR ASTM F 1554 GRADE 36.

QT WIRE ROPE: **Ø & ***Ø, GALVANIZED "AIRCRAFT" DESIGNED 7X19 w/ A MIN., BREAKING STRENGTH OF 7,000lds. & 14,000lbs

WASHERS: SHALL BE IN ACCORDANCE WITH ASTM A 500 (GRADE B).

NUTS: SHALL BE IN ACCORDANCE WITH ASTM A 563 GRADE A HEX.

METAL CONNECTORS: ALL METAL CONNECTORS WHICH ARE EXPOSED TO EXTERIOR SHALL BE GALVANIZED.

RETROFIT REBAR/ROD INSTALLATION: EMBEDMENT OF RODS OR REBAR DOWELS SHALL BE 12 BAR DIAMETER MIN., HOLES SHALL BE 1/4" LARGER THAN REBAR AND 1/8" LARGER THAN THREADED ROD SIZE (U.O.N.)

ANCHORING ADHESIVE: SHALL BE ONE OF THE FOLLOWING PRODUCTS (DUAL CARTRIDGE INSTALLATION ONLY): EPOXY: SIMPSON SET OR EQUAL.

REINFORCING STEEL: SHALL BE ASTM A615, GRADE 60.

STRUCTURAL STEEY: SHALL BE ASTM A992, GRADE 50.

WELDED WIRE FABRIC (WWF): SHALL BE ASTM A185.

ROOF COVERING SPECIFICATIONS:

2 THE CONTRACTOR SHALL BE RESPONSIBLE FOR THE DESIGN AND INSTALLATION OF THE ROOF COVERING SYSTEM.
ASPHALT SHINGLES SHALL COMPLY WITH ASTM D3161 AND BE INSTALLED ACCORDING TO THE MANUFACTURER'S
REQUIREMENTS. CLAY AND TILE ROOFS SHALL BE INSTALLED PER THE "CONCRETE AND CLAY ROOF TILE INSTALLATION
MANUAL" AND THE MANUFACTURER'S REQUIREMENTS.

STANDING SEAM METAL ROOFS SHALL COMPLY WITH ASTM E1514 AND BE INSTALLED ACCORDING TO THE MANUFACTURER'S REQUIREMENTS. THE CONTRACTOR SHALL BE RESPONSIBLE FOR THE DESIGN AND INSTALLATION OF ALL METAL FLASHING AND VALLEY MATERIALS.

CERTIFICATION:

THE STRUCTURE SHOWN ON THESE PLANS IS DESIGNED TO WITHSTAND WINDS OF 120 MPH, 3 SECOND GUSTS & 120 MPH SUSTAINED WINDS: IN ACCORDANCE WITH CH. 16, FBC, EXPOSURE CATEGORY "C"



JOB NUMBER: L220810CCB

ROBERT PHILLIP BISHOP JR. P.E. NO.: STRUCTURAL NOTES
BETHLEHEM PARK ASSEMBLY BUILDING
COLUMBIA COUNTY, FLORIDA

SHEET NO.

S7

REVISIONS

12/05/2023 REVISED NOTES 12/19/2023 REMOVED NOTES OFF SONAL SEL


P.O. BOX 3823 LAKE CITY, FL 32056 PH. 386-752-4675 LIC NO. LB8356 2551 BLAIRSTONE PINES DR. TALLAHASSEE, FL 32301 WWW.NFPS.NET CA# 29011

NORTH FLORIDA PROFESSIONAL SERVICES, INC.

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SHEET IS THE ELECTRONIC FILE DIGITALLY SIGN

HVAC EQUIPMENT LIST

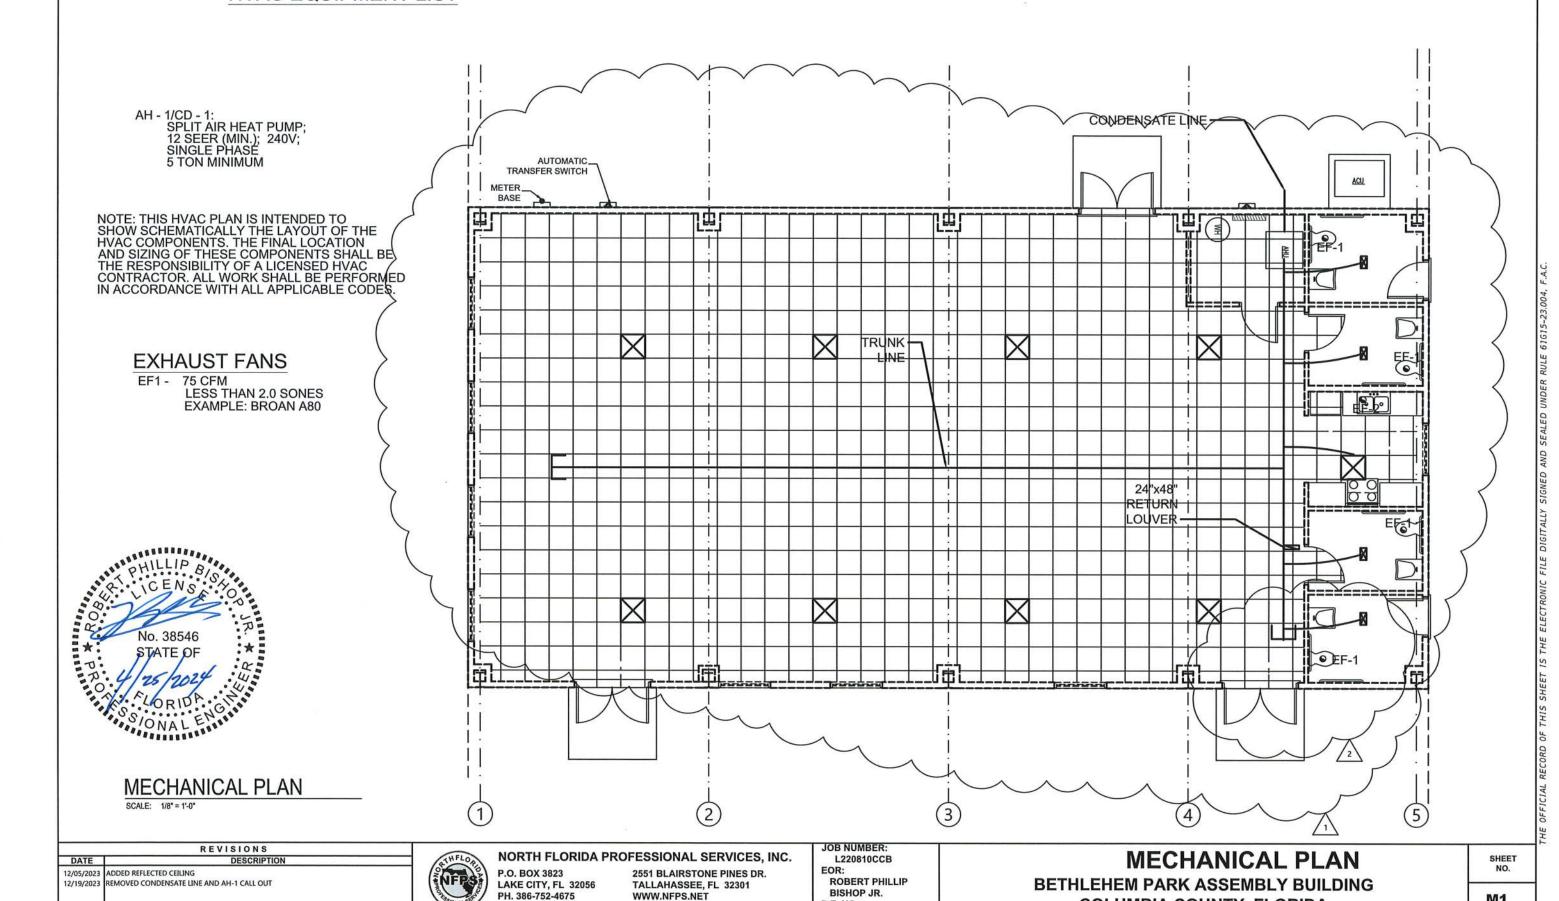

P.E. NO.:

LIC NO. LB8356

CA# 29011

COLUMBIA COUNTY, FLORIDA

M1

HVAC NOTES:

- 1. THIS TRADE SHALL COORDINATE FULLY WITH ALL OTHER TRADES ASSOCIATED WITH THIS PROJECT TO VERIFY THE LOCATION AND ELEVATION OF ALL EQUIPMENT PIPES, CONDUITS, AND DUCTS TO PREVENT CONFLICTS DURING CONSTRUCTION. ANY RELOCATION OR REPOUTING OF EQUIPMENT, PIPES, CONDUITS, OR DUCT RESULTED FROM A LACK OF COORDINATION BETWEEN TRADES SHALL BE AT THE CONTRACTORS
- 2. EQUIPMENT ROUGH-INS ARE ACCURATE TO THE BEST OF THE DESIGNERS KNOWLEDGE, HOWEVER IN SOME INSTANCES THE OWNER OR SUPPLIER MAY SUBSTITUTE OR THE EQUIPMENT ITEM MAY VARY FROM WHAT IS SHOWN ON THE PLANS. THE CONTRACTOR OR HIS TRADESMAN SHALL VERIFY ALL CRITICAL DIMENSIONS WITH THE OWNER OR SUPPLIER PRIOR TO BEGINNING CONSTRUCTION. FAILURE OF THE CONTRACTOR TO VERIFY THESE DIMENSIONS SHALL PLACE THE RESPONSIBILITY FOR ANY SUBSEQUENT RELOCATION DIRECTLY ON THE CONTRACTOR.
- 3. THE SUBMISSION OF A PROPOSAL BY THE CONTRACTOR OR A TRADESMAN SHALL BE CONSTRUED AS EVIDENCE THAT THE CONTRACTOR OR TRADESMAN HAS FAMILIARIZED HIMSELF WITH THE PLANS AND EXISTING SITE CONDITIONS. ANY SUDSEQUENT CLAIMS FOR AN INCREASE IN THE COST OF MATERIALS AND/OR LABOR RESULTING FROM DIFFICULTIES THAT COULD HAVE BEEN REASONABLE FORSEEN HAD A PROPER EXAMINATION BEEN MADE
- 4. THE CONTRACTOR AND HIS TRADES SHALL VISIT THE SITE AND THOROUGHLY INSPECT ALL EXISTING CONDITIONS TO ASSURE THAT THE WORK REPRESENTED IN THE PLANS AND SPECIFICATIONS AND EQUIPMENT PURCHASED WILL FIT INTO THE SPACE ALLOCATED AND
- 5. THE CONTRACTOR SHALL OBTAIN AN PAY FOR ALL PERMITS, LICENSES, DOCUMENTS AND SERVICES RELATED TO THE INSTALLATION OF THE WORK.
- 6. ALL WORK SHALL BE COMPLETED IN ACCORDANCE WITH ALL FEDERAL, STATE AND LOCAL CODES HAVING JURISDICTION.
- 7. THE CONTRACTOR SHALL PROVIDE A COMPLETE HVAC SYSTEM TO INCLUDE LABOR, MATERIALS, EQUIPMENT AND TOOLS NECESSARY FOR A COMPLETELY OPERATIONAL SYSTEM, INCLUDING ANY APPURTENANCES CUSTOMARILY INCLUDED IF NOT SPECIFICALLY CALLED OUT. AT THE COMPLETION OF THE INSTALLATION, THE MECHANICAL CONTRACTOR SHALL THOROUGHLY TEST THE SYSTEM TO ENSURE IT IS OPERATIONING PROPERLY.
- 8. THE COMPLETED INSTALLATION SHALL BE IN ACCORDANCE WITH MANUFACTURERS RECOMMENDATIONS AND ALL APPLICABLE INDUSTRY STANDARDS.
- 9. ALL MECHANICAL WORK SHALL BE LOCATED SO AS TO AVOID CONFLICT WITH OTHER TRADES AND PROVIDE ADEQUATE CLEARANCES FOR THE ARCHITECTURAL DESIGN ELEMENTS AND PROPER OPERATION AND MAINTENANCE OF ALL EQUIPMENT.

- 10. THE MECHANICAL CONTRACTOR SHALL PROVIDE A STATUTORY AFFIDAVIT AS PROVIDED BY THE OWNER. HE SHALL WARRANT AND GUARANTEE ALL HIS MATERIALS AND WORKMANSHIP FOR A PERIOD OF ONE (1) YEAR FROM THE DATE OF ACCEPTANCE.
- 11. DO NOT SCALE DIMENSIONS FROM THIS DRAWING. REFER TO FLOOR PLAN FOR BUILDING
- 12. ALL DUCTWORK SHALL BE FABRICATED AND INSTALLED IN ACCORDANCE WITH THE MOST RECENTLY PUBLISHED ASHRAE AND SMACNA STANDARDS.
- 13. ALL SUPPLY TRUNK DUCT SHALL BE CONSTRUCTED OF METAL DUCT MATERIAL (R-6 MIN. INSULATION).
- 14. ALL FLEXIBLE ROUND DUCT SHALL HAVE AN R-6 FIBERGLASS INSULATION ENCASED IN A VAPOR BARRIER OF SEAMLESS, NON-COMBUSTIBLE, CO-POLYMER PLASTIC. INSTALL METAFLEX CLASS I, TYPE 500 AIR DUCT OR UL LISTED EQUAL
- 15. ALL FLEXIBLE DUCT SHALL BE CONNECTED TO TRUNK WITH A COMPATABLE DUCT BOOT AND SHALL BE TAPED TO PROVIDE AN AIRTIGHT SEAL.
- 16. THE MANUFACTURER'S MINIMUM CLEARANCE RECOMMENDATIONS SHALL BE MAINTAINED ON ALL EQUIPMENT AND DUCT WORK.
- 17. THE MECHANICAL CONTRACTOR SHALL CAREFULLY COORDINATE THE LOCATION OF ALL DUCTS, GRILLES, DIFFUSERS, ETC. WITH THE CEILING GRID, PLUMBING, LIGHTING, AND WALL FRAMING.
- 18. THE SYSTEM SHALL BE BALANCED TO PROVIDED THE REQUIRED CFM'S FOR EACH AREA.
- 19. ALL FLEX DUCT HANGERS SHALL BE A MINIMUM OF 1" WIDE.
- 20. EXHAUST FANS SHALL BE FURNISHED WITH BIRDSCREENS, BACKDRAFT DAMPERS, AND DISCONNECTS WERE APPLICABLE AND IN ACCORDANCE WITH THE PLANS.
- 21. THE CONTRACTOR MUST VERIFY THE LOCATION OF THERMOSTATS WITH OWNER AND CAREFULLY COORDINATE WITH THE INTERIOR FINISHES.
- 22. THERMOSTATS SHALL INSTALLED 5'-0" A.F.F. WITH A LOCK BOX.
- 23. ALL CONTROL WIRING DIAGRAMS SHALL BE FURNISHED BY THE MECHANICAL CONTRACTOR TO THE ELECTRICAL CONTRACTOR.
- 24. PROVIDED FILTERED OUTSIDE FRESH AIR INTO THE RETURN OF EACH UNIT WITH A DAMPER.
- 25. ALL CONDENSATE DRAIN LINES SHALL BE SCHEDULE 40 PVC SLOPED AT 1/2" PER FOOT OF RUN WITH RETENTION.
- 26. ALL RETURN DUCTS SHALL BE FABRICATED FROM FIBERGLASS DUCT BOARD.



REVISIONS

DATE

NORTH FLORIDA PROFESSIONAL SERVICES, INC. P.O. BOX 3823

LAKE CITY, FL 32056 PH. 386-752-4675 LIC NO. LB8356

2551 BLAIRSTONE PINES DR. TALLAHASSEE, FL 32301 WWW.NFPS.NET CA# 29011

JOB NUMBER: L220810CCB ROBERT PHILLIP BISHOP JR.

P.E. NO .:


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MECHANICAL NOTES

SHEET

BETHLEHEM PARK ASSEMBLY BUILDING COLUMBIA COUNTY, FLORIDA

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REVISIONS DESCRIPTION

12/05/2023 ADDED REFLECTED CEILINGAND CHANGED AMPS ON METER BASE 12/19/2023 CHANGED LIGHT FIXTURE IN MECHANICAL ROOM, MOVED GFIC OUTLET IN KITCHENETTE AWAY FROM THE SINK, CONNECTED EXTERIOR LIGHTS TO SWITCHES 01/04/2024 ADDED AUTOMATIC TRANSFER SWITCH
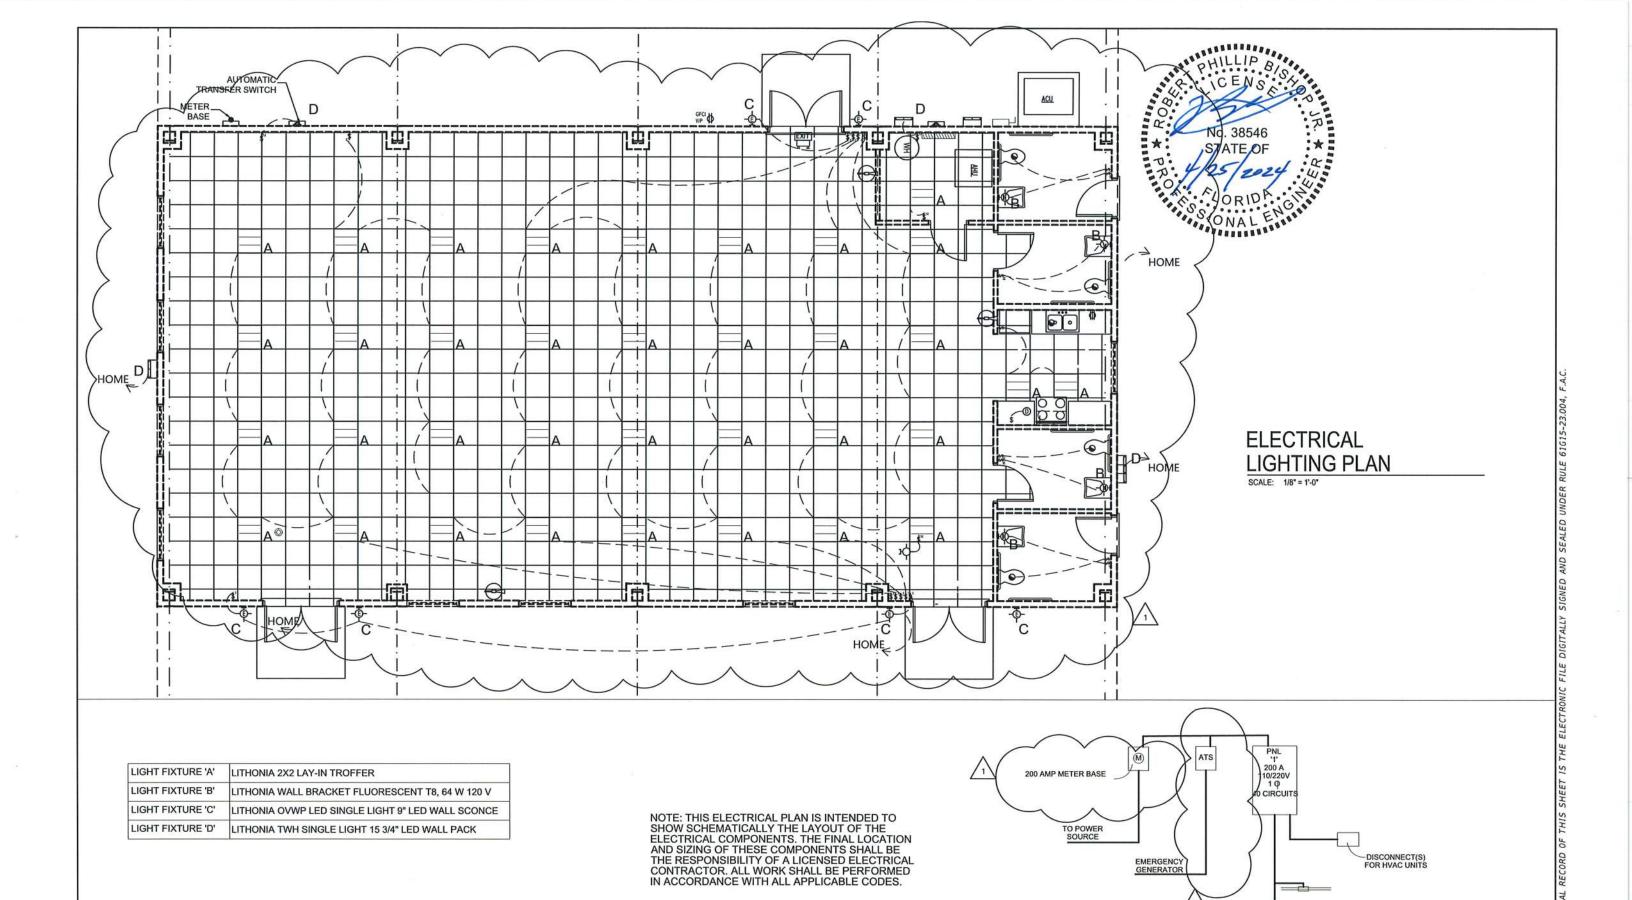
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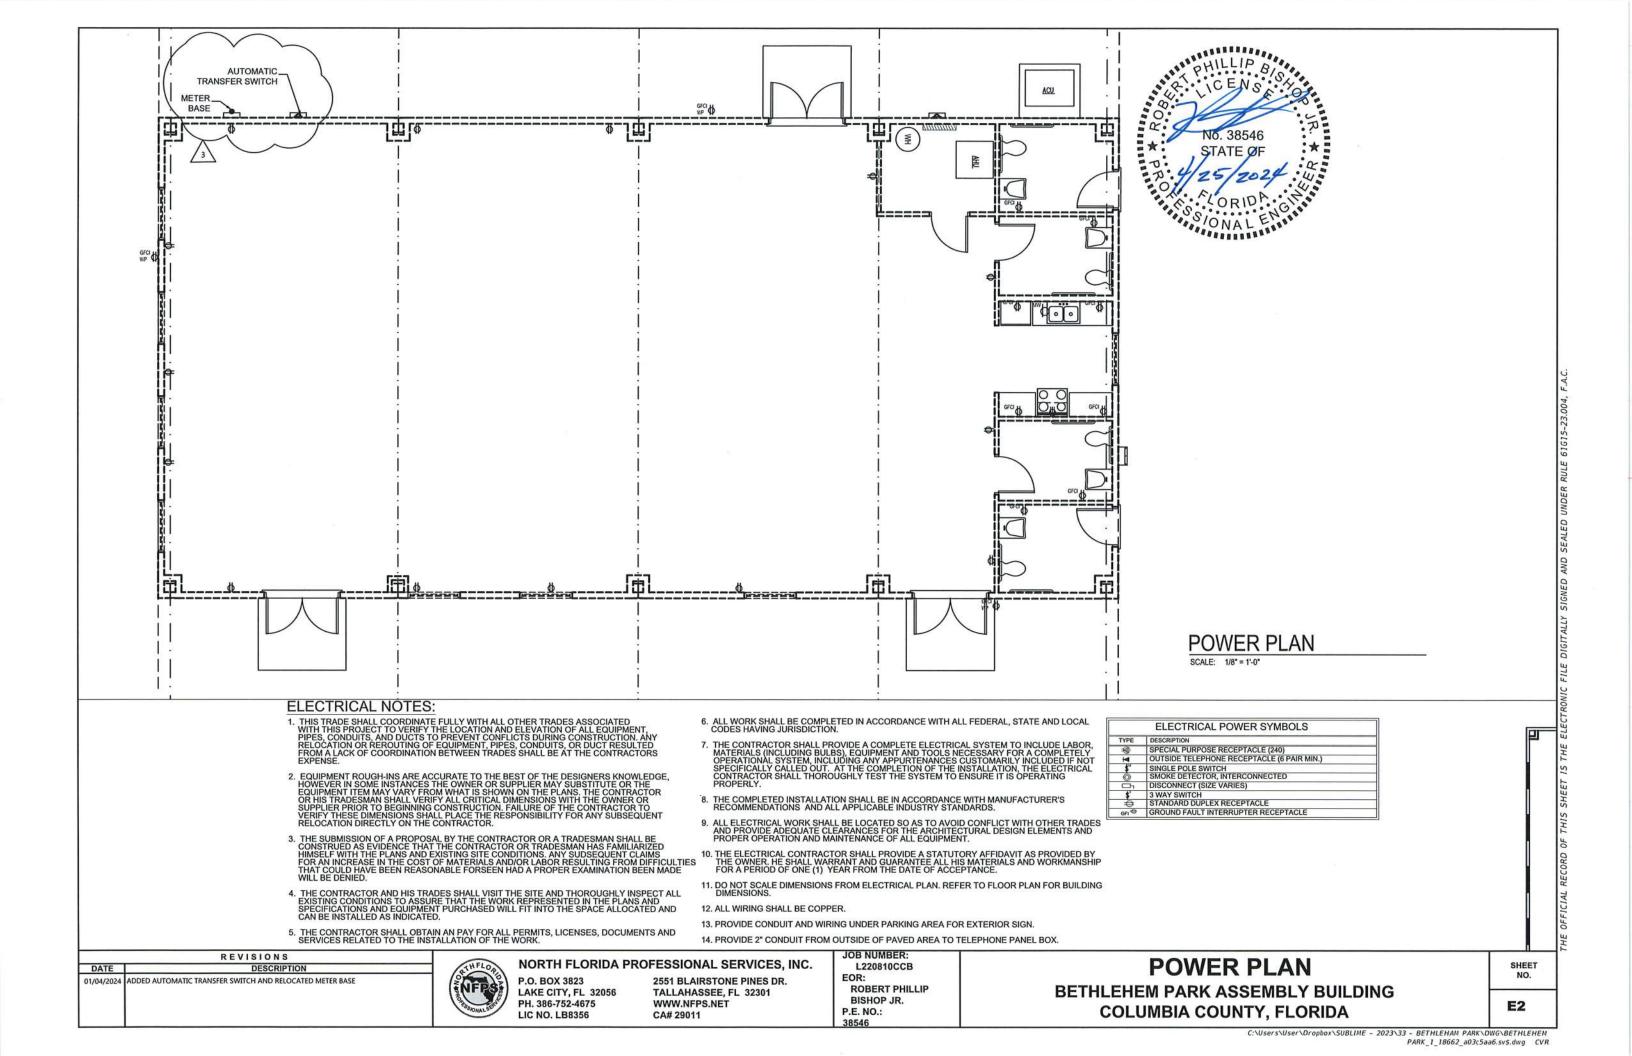
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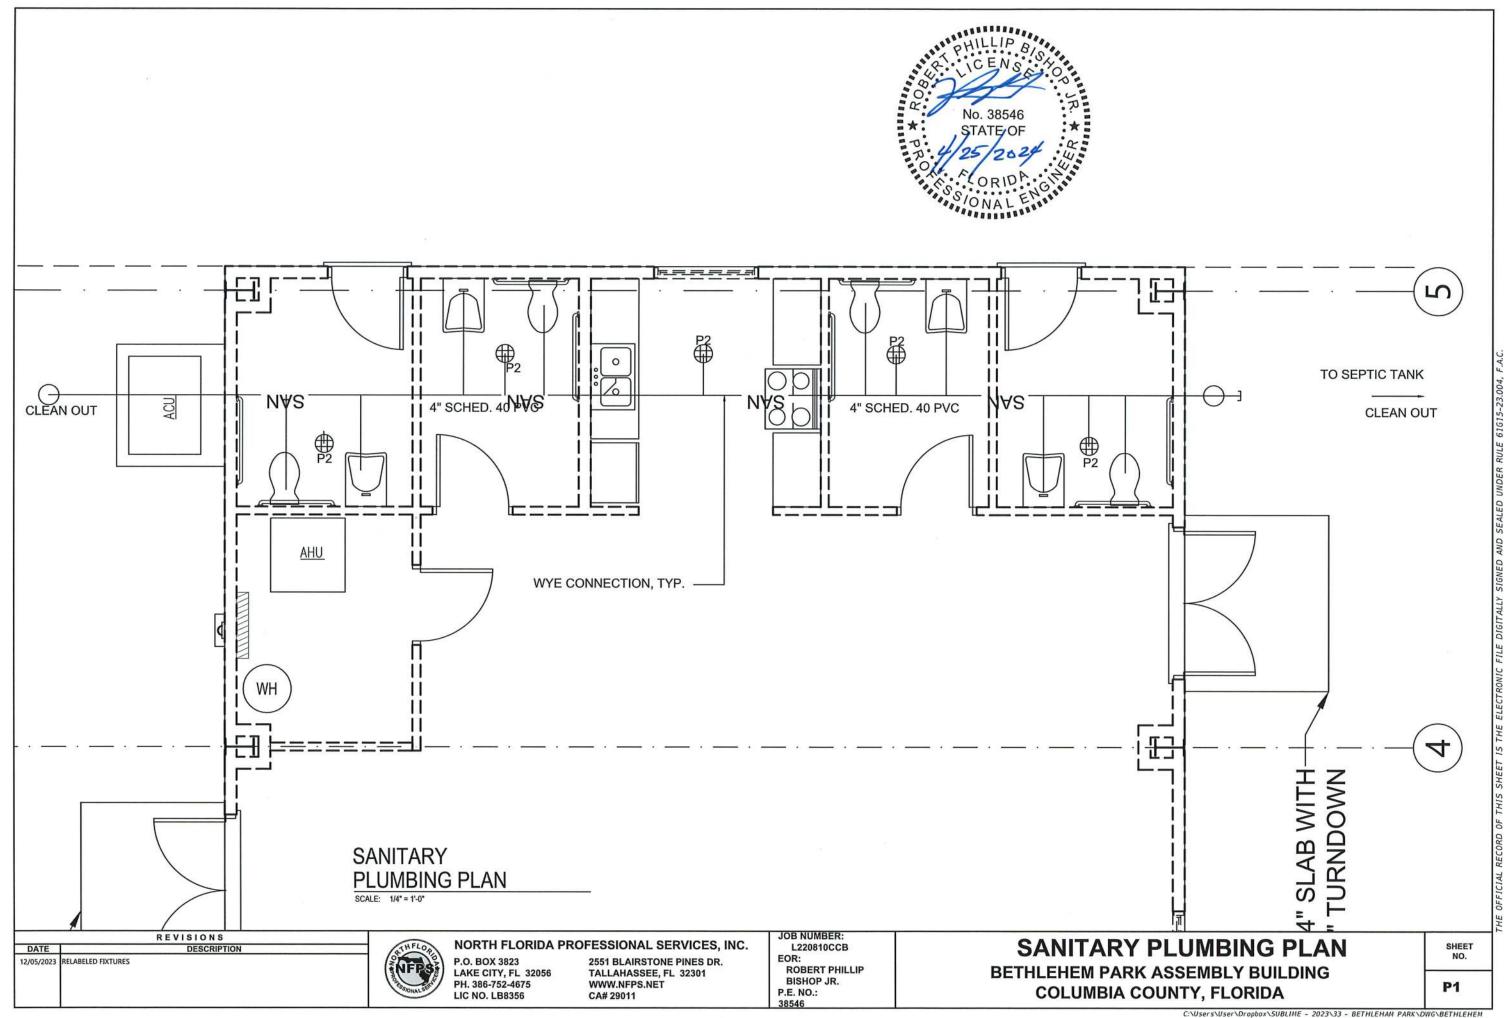
LIGHTING PLAN


ELECTRICAL RISER DIAGRAM


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BETHLEHEM PARK ASSEMBLY BUILDING **COLUMBIA COUNTY, FLORIDA**







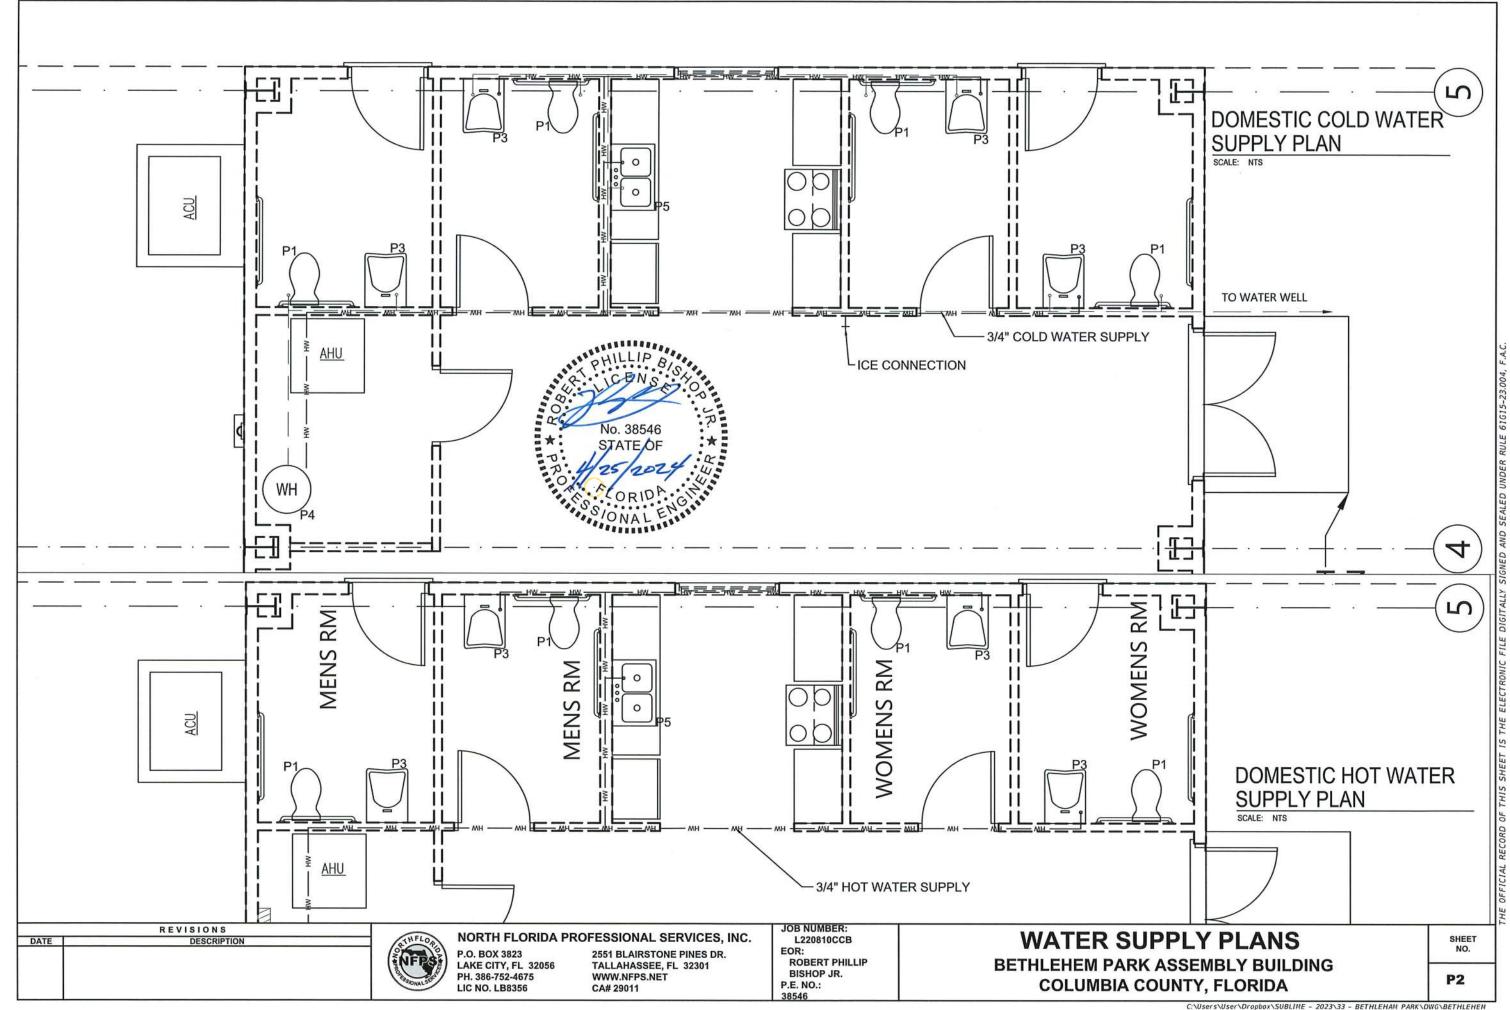

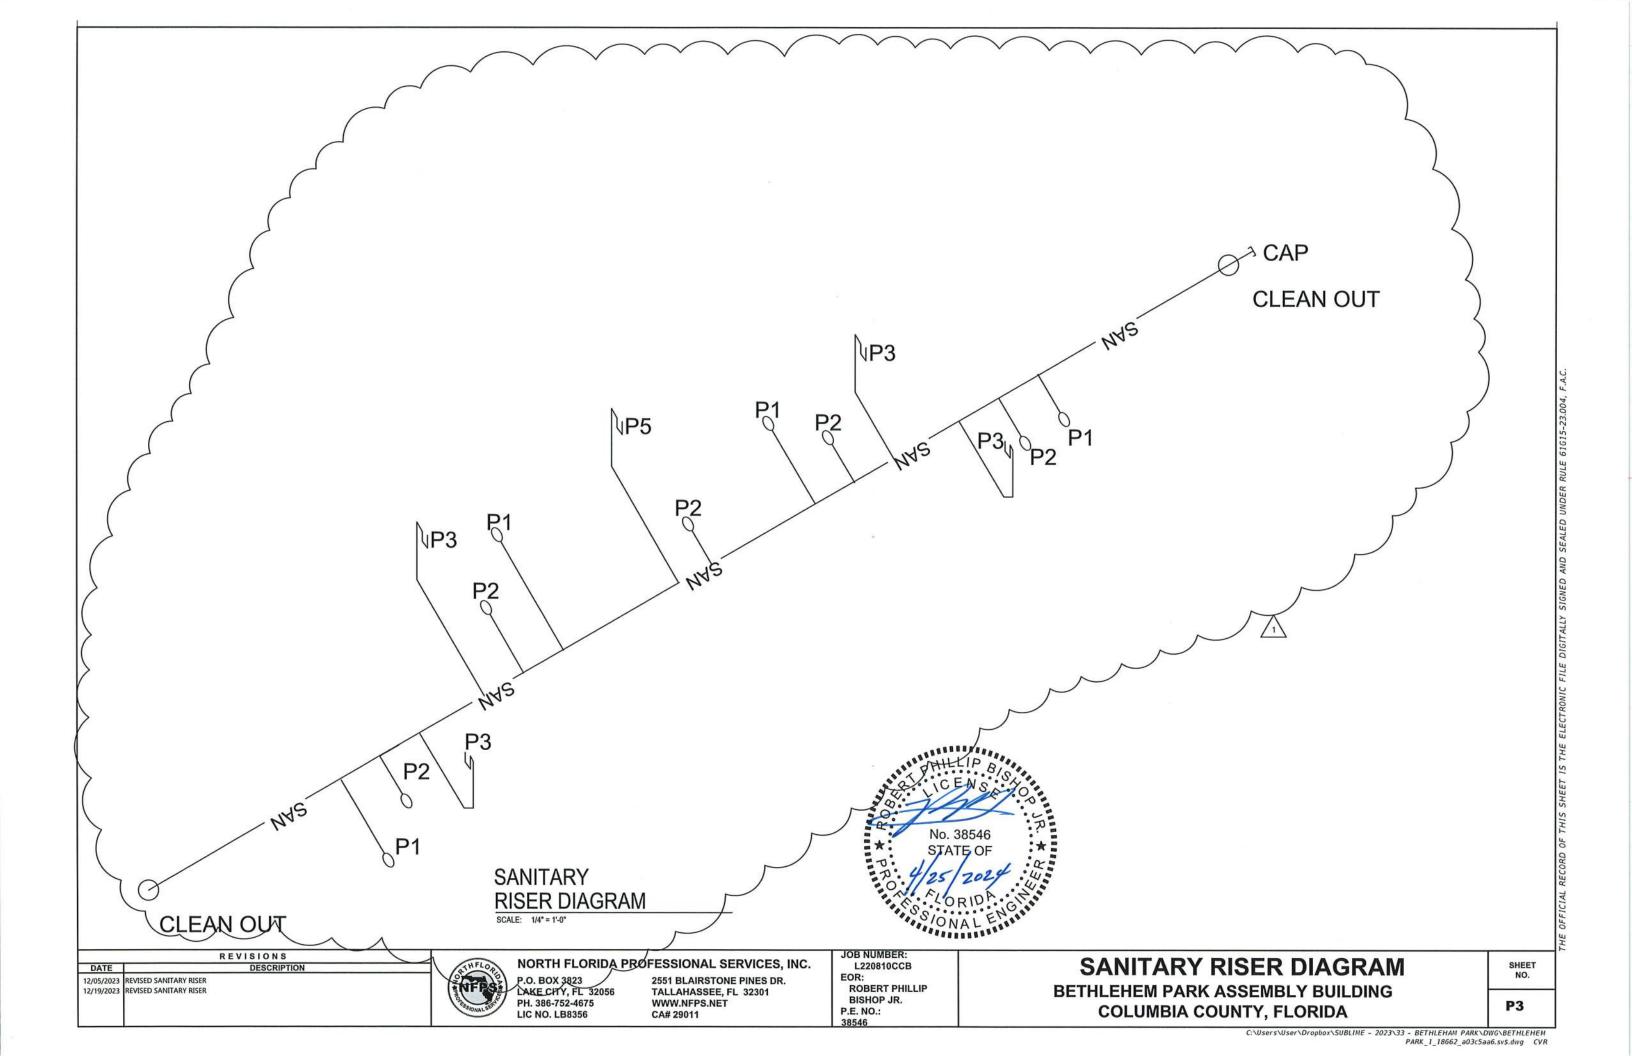PLUMBING NOTES

- 1. THIS TRADE SHALL COORDINATE FULLY WITH ALL OTHER TRADES ASSOCIATED WITH THIS PROJECT TO VERIFY THE LOCATION AND ELEVATION OF ALL EQUIPMENT, PIPES, CONDUITS, AND DUCTS TO PREVENT CONFLICTS DURING CONSTRUCTION. ANY RELOCATION OR REROUTING OF EQUIPMENT, PIPES, CONDUITS, OR DUCT RESULTED FROM A LACK OF COORDINATION BETWEEN TRADES SHALL BE AT THE CONTRACTORS EXPENSE.
- EQUIPMENT ROUGH-INS ARE ACCURATE TO THE BEST OF THE DESIGNERS KNOWLEDGE, HOWEVER IN SOME INSTANCES THE OWNER OR SUPPLIER MAY SUBSTITUTE OR THE EQUIPMENT ITEM MAY VARY FROM WHAT IS SHOWN ON THE PLANS. THE CONTRACTOR OR HIS TRADESMAN SHALL VERIFY ALL CRITICAL DIMENSIONS WITH THE OWNER OR SUPPLIER PRIOR TO BEGINNING CONSTRUCTION. FAILURE OF THE CONTRACTOR TO VERIFY THESE DIMENSIONS SHALL PLACE THE RESPONSIBILITY FOR ANY SUBSEQUENT RELOCATION DIRECTLY ON THE CONTRACTOR.
- ALL WORK SHALL BE COMPLETED IN ACCORDANCE WITH ALL FEDERAL, STATE AND LOCAL CODES HAVING JURISDICTION.
- 4. THE COMPLETED INSTALLATION SHALL BE IN ACCORDANCE WITH ALL REQUIREMENTS AND APPLICABLE INDUSTRY STANDARDS.
- THE CONTRACTOR SHALL OBTAIN AND PAY FOR ALL PERMITS, LICENSES, DOCUMENTS AND SERVICES RELATED TO THE INSTALLATION OF THE WORK.
- PRIOR TO SUBMITTING A PROPOSAL, THE CONTRACTOR AND HIS TRADES SHALL VISIT
 THE SITE AND THOROUGHLY INSPECT ALL EXISTING CONDITIONS TO INSURE THAT THE
 WORK REPRESENTED IN THE PLANS AND SPECIFICATIONS CAN BE INSTALLED AS NDICATED.
- 7. THE SUBMISSION OF A PROPOSAL BY THE CONTRACTOR OR A TRADESMAN SHALL BE CONSTRUED AS EVIDENCE THAT THE CONTRACTOR OR TRADESMAN HAS FAMILIARIZED HIMSELF WITH THE PLANS AND EXISTING SITE CONDITIONS. ANY SUDSEQUENT CLAIMS FOR AN INCREASE IN THE COST OF MATERIALS AND/OR LABOR RESULTING FROM DIFFICULTIES THAT COULD HAVE BEEN REASONABLE FORSEEN HAD A PROPER EXAMINATION BEEN MADE WILL BE DENIED.
- 8. DO NOT SCALE DIMENSIONS FROM THIS DRAWING. REFER TO FLOOR PLAN FOR BUILDING DIMENSIONS.
- ALL WORK SHALL BE LOCATED SO AS TO AVOID CONFLICT WITH OTHER TRADES AND PROVIDE ADEQUATE CLEARANCES FOR THE ARCHITECTURAL DESIGN ELEMENTS AND PROPER OPERATION AND MAINTENANCE OF ALL EQUIPMENT.

- 10. THE CONTRACTOR OR HIS TRADESMAN SHALL PROVIDED THE ENGINEER WITH TWO (2) COPIES OF SHOP DRAWINGS FOR REVIEW AND APPROVAL SO THAT THE QUALITY OF INTENDED MATERIALS OR EQUIPMENT CAN BE REVIEWED PRIOR TO INSTALLATION.
- 11. WASTE AND VENT PIPING SHALL BE SCHEDULE 40 PR SC TYPE 1, GRADE 1. POLYVINYL CHLORIDE COMPOUNDS AS DEFINED AND DISCRIBED IN TENTATIVE SPECIFICATIONS FOR RIGID PVC (ASTM DESIGNATION).
- 12. SLOPE ALL SEWER LINES AT 1/8" PER FOOT, UNLESS OTHERWISE NOTED.
- 13. ALL WATER SUPPLY LINES BELOW SLAB SHALL 1" CPVC (MINIMUM).
- 14. ALL WATER SUPPLY LINES ABOVE SLAB SHALL 1" CPVC (MINIMUM).
- 15. THE PLUMBING CONTRACTOR SHALL PROVIDE STOP VALVES AHEAD OF ALL OPERATING HANDLES AND FAUCETS.
- 16. THE CONTRACTOR OR HIS TRADES SHALL VERIFY ALL SERVICE POINTS AND METERING LOCATIONS (DOMESTIC WATER, SEWER, GAS, ELECTRIC, ETC.) FOR THE PROJECT WITH LOCAL AUTHORITIES PRIOR TO BEGINNING CONSTRUCTION.
- 17. THE PLUMBING CONTRACTOR SHALL VERIFY WITH THE LOCAL AUTHORITY THE LOCATION, SIZE AND ARRANGEMENT OF THE METER AND VALVING ENTERING THE BUILDING. IF A BACKFLOW PREVENTION DEVICE IS REQUIRED, THE CONTRACTOR SHALL FURNISH AND INSTALL SAME PER LOCAL AND STATE REQUIREMENTS.
- 18. THE SUBCONTRACTOR SHALL PROVIDE A STATUTORY AFFIDAVIT AS PROVIDED BY THE OWNER. HE SHALL WARRANT AND GUARANTEE ALL HIS MATERIALS AND WORKMANSHIP FOR A PERIOD OF ONE (1) YEAR FROM THE DATE OF ACCEPTANCE.

PLUMBING FIXTURE SCHEDULE

MARK	FIXTURE	ABBREV			S-INCHE WASTE	
P-1	WATER CLOSET	WC	3/4	3/4	4	FLOOR MOUNTED ELONGATED BOWL
P-2	FLOOR DRAIN	FD	-		2	
P-3	LAVATORY	LAV	3/4	3/4	1 1/4	WALL MOUNTED, 4" CENTERS, 1 1/2" P-TRAP (INSULATED), ADA COMPLIANT
P-4	WATER HEATER	WH	3/4	3/4	4	80 GALLON
P-5	KITCHEN SINK	KIT	3/4	3/4	1 1/4	DOUBLE BOWL, STAINLESS STEEL, 1 1/2" P-TRAP



REVISIONS

12/05/2023 1 - UPDATED SCHEDULE 12/19/2023 REMOVED UNUSED PLUMBING FIXTURES



NORTH FLORIDA PROFESSIONAL SERVICES, INC.

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EOR:
ROBERT PHILLIP
BISHOP JR.
P.E. NO.:

PLUMBING NOTES

BETHLEHEM PARK ASSEMBLY BUILDING

COLUMBIA COUNTY, FLORIDA

SHEET NO.

P4

