


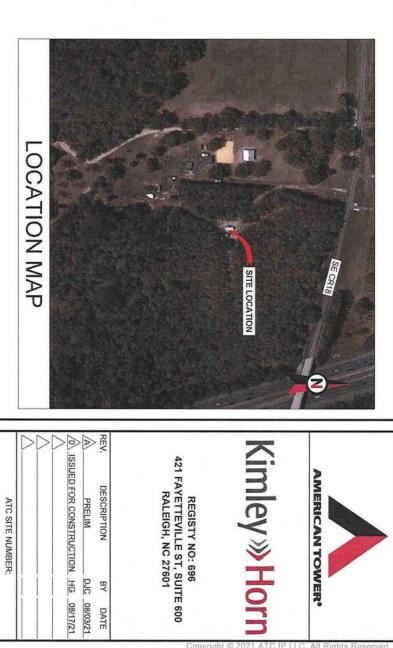

# MERICAN TOWERS

VERIZON SITE NUMBER: 131311 SITE ADDRESS: 2156 SE CR18 VERIZON SITE NAME: ATC LACROSSE ATC SITE NUMBER: 303048 ATC SITE NAME: LACROSSE FL 6 LAKE CITY, FL 32024



REGISTY NO: 696 421 FAYETTEVILLE ST, SUITE 600 RALEIGH, NC 27601

## ANTENNA AMENDMENT DRAWINGS VERIZON


LACROSSE FL 6

ATC SITE NAME: 303048 ATC SITE NUMBER:

VERIZON SITE NAME:

ATC LACROSSE

Sunshine	}		PHONE: (800) 247-2020	TELEPHONE COMPANY: RELL SOUTH	POWER COMPANY: CLAY ELECTRIC	UTILITY COMPANIES						12	-			ANSI/TIA-222-H     TH EDITION FLORIDA FIRE PREVENTION CODE (NFPA 70)		TO BE CONSTRUED TO PERMIT WORK NOT CONFORMING TO THESE CODES.	FOLLOWING CODES AS ADOPTED BY THE LOCAL GOVERNMENT AUTHORITIES. NOTHING IN THESE PLANS IS	ALL WORK SHALL BE PERFORMED AND MATERIALS INSTALLED IN ACCORDANCE WITH THE CURRENT EDITIONS OF THE	COMPLIANCE CODE
LAKE CITY, FL 32024	ROBERTS LAND TIMBER INVESTME 2156 SE CR18	PROPERTY OWNER:	RALEIGH, NC 2001	& ASSOCIATES, INC.	KIMLEY-HORN	<	WOBURN, MA 01801 JOHN. SCANDURA, JOHN	_	TOWER OWNER: APPLICANT:	PROJECT TEAM				GROUND ELEVATION: 153' AMSL	LONGITUDE: -82.57070891	LATITUDE: 29.95153502	GEOGRAPHIC COORDINATES:	COUNTY: COLUMBIA	2156 SE CR18	SITE ADDRESS:	PROJECT SUMMARY
FROM HIGH SPRINGS, FL:  PROCEED FROM HIGH SPRINGS HEAD EAST ON GEORGE DUBOSE RD TOWARD US-441 S / US-41 S / FL-25 / S US HIGHWAY 441 0.2 MI TURN LEFT ONTO US-441 N / US-41 N / FL-25 / S US HIGHWAY 441 5.0 MI TURN RIGHT TO STAY ON SE COUNTY ROAD 18 / COUNTY HWY-18 2.0 MI ARRIVE AT SE COUNTY ROAD 18 / COUNTY HWY-18	PROJECT LOCATION DIRECTIONS	INVOLVES THE COLLOCATION REMOVAL AND/OR REPLACEMENT OF TRANSMISSION EQUIPMENT THAT IS NOT A SUBSTANTIAL CHANGE UNDER CFR § 1.61000 (B)(7).	EXPEDITED REVIEW UNDER 47 U.S.C. § 1455(A) AS A MODIFICATION OF AN EXISTING WIRELESS TOWER THAT	6. THE PROJECT DEPICTED IN THESE PLANS QUALIFIES AS AN ELIGIBLE FACILITIES REQUEST ENTITLED TO	5. HANDICAP ACCESS IS NOT REQUIRED.	4. NO SANITARY SEWER, POTABLE WATER OR TRASH	A MONTH FOR ROUTINE INSPECTION AND MAINTENANCE.     THE PROJECT WILL NOT RESULT IN ANY SIGNIFICANT LAND	THE FACILITY IS UNMANNED.     A TECHNICIAN WILL VISIT THE SITE APPROXIMATELY ONCE	PROJECT NOTES		SORKY GENERALOR	INSTALL (1) CONSOLIDATED EQUIPMENT CABINET, (1) ILC, AND (1)	30kW GENERATOR		(SPARE) TO REMAIN	(b) KKO(5); (2) OVF(5); MND (2) 12A24 (1-3/6) H15KID CABLE(5)  EXISTING (6) 1 5/8" COAX CABLE(5) (4) 1 5/8" COAX CABLE(5)	INSTALL MOUNT MODIFICATIONS, (9) ANTENNA(S), (3) COMBINER(s),	1-5/8" COAX CABLE(S)	TOWER WORK:	THE PROPOSED PROJECT INCLUDES MODIFYING GROUND BASED AND TOWER MOUNTED EQUIPMENT AS INDICATED PER BELOW:	PROJECT DESCRIPTION
					R-604	R-603	R-602	R-601	E-503	E-502	E-501	E-100	C-501	C-401	C-201	C-102	C-101	G-002	G-001	SHEET NO:	
					SUPPLEMENTAL	SUPPLEMENTAL	SUPPLEMENTAL	SUPPLEMENTAL	GROUNDING DETAILS	PANEL SCHEDULE & ONE LINE DIAGRAM	ELECTRICAL ROUTING AND GROUNDING	ELECTRONIC NOTES	CONSTRUCTION DETAILS	ANTENNA INFORMATION & SCHEDULE	TOWER ELEVATION	DETAILED GROUND PLAN	DETAILED SITE PLAN	GENERAL NOES	TITLE SHEET	DESCRIPTION:	SHEET INDEX
									0	0	0	0	0	0	0	0	0	0	0	REV:	
									08/17/21	08/17/21	08/17/21	08/17/21	08/17/21	08/17/21	08/17/21	08/17/21	08/17/21	08/17/21	08/17/21	DATE:	
									HG	HG	HG	HG	НС	HG	HG	HG	НС	НС	НС	BY:	

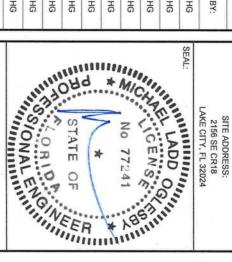

## 

DATE DRAWN:	08/17/21
ATC JOB NO:	13677441
CUSTOMER ID:	ATC LACROSSE
CHISTOMED #	121211

G-001 SHEET NUMBER:

TITLE SHEET

REVISION: 0

Kimley » Horn

**AMERICAN TOWER®** 

# GENERAL CONSTRUCTION NOTES:

- OWNER FURNISHED MATERIALS, VERIZON "THE COMPANY" WILL PROVIDE AND THE CONTRACTOR WILL INSTALL BTS EQUIPMENT FRAME (PLATFORM) AND ICEBRIDGE SHELTER (GROUND BUILD/CO-LOCATE ONLY)
- C m
- AC/TELCO INTERFACE BOX (PPC)
  ICE BRIDGE (CABLE TRAY WITH COVER) (GROUND BUILD/CO-LOCATE ONLY, GC
  TO FURNISH AND INSTALL FOR ROOFTOP INSTALLATION)

TOWERS, MONOPOLES

- ONELY----
- 'n 2. THE CONTRACTOR IS RESPONSIBLE TO PROVIDE ALL OTHER MATERIALS FOR THE COMPLETE INSTALLATION OF THE SITE INCLUDING BUT NOT LIMITED TO SUCH MATERIALS AS FENCING, STRUCTURAL STEEL SUPPORTING SUB-FRAME FOR PLATFORM, ROOFING LABOR AND MATERIALS, GROUNDING SUNGS, GROUNDING WIRES, COPEDER-CLAD OR XIT CHEMICAL GROUND ROD(S), BUSS BARS, TRANSFORMERS AND DISCONNECT SWITCHES WHERE APPLICABLE, TEMPORARY ELECTRICAL POWER, CONDUIT, LANDSCAPING COMPOUND STONE, CRANES, CORE DRILLING, SLEEPERS AND RUBBER MATTING, REBAR, CONCRETE CAISSONS, PADS ANDIOR ALGER MOUNTS, MISCELLANGUUS FASTENERS CADE TRAYS, NON-STANDARD ANTENNA FRAMES AND ALL OTHER MATERIAL AND LABOR REQUIRED TO COMPLETE THE JOB ACCORDING TO THE DRAWINGS AND SPECIFICATIONS, IT IS THE POSITION OF VERIZON TO APPLY FOR PERMITTING AND CONTRACTOR RESPONSIBLE FOR PICKUP AND PAYMENT OF REQUIRED PERMITS. 29.
- ALL WORK SHALL CONFORM TO ALL CURRENT APPLICABLE FEDERAL, STATE, AND LOCAL CODES, INCLUDING ANSIEIA/TIA-222, AND COMPLY WITH ATC CONSTRUCTION SPECIFICATIONS.

CONTRACTOR SHALL CONTACT LOCAL 811 FOR IDENTIFICATION OF UNDERGROUND UTILITIES PRIOR TO START OF CONSTRUCTION.

- CONTRACTOR SHALL BE RESPONSIBLE FOR COORDINATING ALL REQUIRED INSPECTIONS.
- ALL DIMENSIONS TO, OF, AND ON EXISTING BUILDINGS, DRAINAGE STRUCTURES, AND SITE IMPROVEMENTS SHALL BE VERIFIED IN FIELD BY CONTRACTOR WITH ALL DISCREPANCIES REPORTED TO THE ENGINEER.
- DETAILS SHOWN ARE TYPICAL; SIMILAR DETAILS APPLY TO SIMILAR CONDITIONS UNLESS OTHERWISE NOTED.
- THESE DRAWINGS DO NOT INCLUDE NECESSARY COMPONENTS FOR CONSTRUCTION SAFETY WHICH SHALL BE THE SOLE RESPONSIBILITY OF THE CONTRACTOR.
- CONTRACTOR SHALL BRACE STRUCTURES UNTIL ALL STRUCTURAL ELEMENTS NEEDED FOR STABILITY ARE INSTALLED. THESE ELEMENTS ARE AS FOLLOWS: LATERAL BRACING, ANCHOR BOLTS, ETC.
- CONTRACTOR SHALL DETERMINE EXACT LOCATION OF EXISTING UTILITIES, GROUNDS DRAINS, DRAIN PIPES, VENTS, ETC. BEFORE COMMENCING WORK.
- 12. INCORRECTLY FABRICATED, DAMAGED, OR OTHERWISE MISFITTING OR NONCONFORMING MATERIALS OR CONDITIONS SHALL BE REPORTED TO THE VERIZON. REP PRIOR TO REMEDIAL ACTION SHALL REQUIRE WRITTEN APPROVAL BY THE VERIZON REP PRIOR TO PROCEEDING.
- 13. EACH CONTRACTOR SHALL COOPERATE WITH THE VERIZON REP, AND COORDINATE HIS WORK WITH THE WORK OF OTHERS.
- CONTRACTOR SHALL REPAIR ANY DAMAGE CAUSED BY CONSTRUCTION OF THIS PROJECT TO MATCH EXISTING PRE-CONSTRUCTION CONDITIONS TO THE SATISFACTION OF THE VERZION CONSTRUCTION MANAGER.
- ALL CABLE/CONDUIT ENTRY/EXIT PORTS SHALL BE WEATHERPROOFED DURING INSTALLATION USING A SILICONE SEALANT.
- 16. WHERE EXISTING CONDITIONS DO NOT MATCH THOSE SHOWN IN THIS PLAN SET, CONTRACTOR SHALL NOTIFY THE VERIZON REP AND ENGINEER OF RECORD IMMEDIATELY.
- CONTRACTOR SHALL ENSURE ALL SUBCONTRACTORS ARE PROVIDED WITH A COMPLETE AND CURRENT SET OF DRAWINGS AND SPECIFICATIONS FOR THIS PROJECT.
- 8 CONTRACTOR SHALL REMOVE ALL RUBBISH AND DEBRIS FROM THE SITE AT THE END OF EACH DAY.
- CONTRACTOR SHALL COORDINATE WORK SCHEDULE WITH AMERICAN TOWER CORPORATION (ATC) AND TAKE PRECAUTIONS TO MINIMIZE IMPACT AND DISRUPTION OF OTHER OCCUPANTS OF THE FACILITY.
- CONTRACTOR SHALL FURNISH VERIZON AND AMERICAN TOWER CORPORATION (ATC) WITH A PDF MARKED UP AS-BUILT SET OF DRAWINGS UPON COMPLETION OF WORK.
- 21. PRIOR TO SUBMISSION OF BID, CONTRACTOR SHALL COORDINATE WITH VERIZON REP TO DETERMINE WHAT, IF ANY, ITEMS WILL BE PROVIDED. ALL ITEMS NOT PROVIDED SHALL BE PROVIDED AND INSTALLED BY THE CONTRACTOR. CONTRACTOR WILL INSTALL ALL ITEMS PROVIDED.

- 22
- CONTRACTOR SHALL INSTALL ALL SITE SIGNAGE IN ACCORDANCE WITH VERIZON SPECIFICATIONS AND REQUIREMENTS.

23.

- 24.
- GENERATORS & LIQUID PROPANE TANK
  ANTENNA STANDARD BRACKETS, FRAMES AND PIPES FOR MOUNTING
  ANTENNAS (INSTALLED BY OTHERS)

- TRANSMISSION LINE
  TRANSMISSION LINE JUMPERS
  TRANSMISSION LINE CONNECTORS WITH WEATHERPROOFING KITS
  TRANSMISSION LINE GROUND KITS
- HANGERS
  HOISTING GRIPS
  BTS EQUIPMENT
- 27.
- 28.
- CONTRACTOR SHALL BE RESPONSIBLE FOR SITE SAFETY INCLUDING COMPLIANCE WITH ALL APPLICABLE OSHA STANDARDS AND RECOMMENDATIONS AND SHALL PROVIDE ALL NECESSARY SAFETY DEVICES INCLUDING PPE AND PPM AND CONSTRUCTION DEVICES SUCH AS WELDING AND FIRE PREVENTION, TEMPOPARY SHORING, SCAFFOLDING, TRENCH BOXES/SLOPING, BARRIERS, ETC.

- 31. IN ORDER TO ESTABLISH STANDARDS OF QUALITY AND PERFORMANCE, ALL TYPES OF MATERIAL ISTED HEREINAFTER BY MANUFACTURER'S NAMES ANDIOR MANUFACTURER'S CATALOG NUMBER SHALL BE PROVIDED BY THESE MANUFACTURERS AS SPECIFIED.
- 32. VERIZON FURNISHED EQUIPMENT SHALL BE PICKED-UP AT THE VERIZON WARREHOUSE. NO LATER THAW 48HR AFTER BEING NOTIFIED INSURED, STORED, UNCRATE, PROTECTED AND INSTALLED BY THE CONTRACTOR WITH ALL APPURTENANCES REQUIRED TO PLACE THE EQUIPMENT IN OPERATION, READY FOR USE. THE CONTRACTOR SHALL BE RESPONSIBLE FOR THE EQUIPMENT AFTER PICKING IT UP.
- 33. VERIZON OR HIS ARCHITECT/ENGINEER RESERVES THE RIGHT TO REJECT ANY EQUIPMENT OR MATERIALS WHICH, IN HIS OWN OPINION ARE NOT IN COMPLIANCE WITH THE CONTRACT DOCUMENTS, ETHER BEFORE OR AFTER INSTALLATION AND THE EQUIPMENT SHALL BE REPLACED WITH EQUIPMENT CONFORMING TO THE REQUIPMENT SOFT THE CONTRACT DOCUMENTS BY THE CONTRACTOR AT NO COST TO VERIZON OR THEIR ARCHITECT/ENGINEER.

## SPECIAL CONSTRUCTION

- ANTENNA AND COAXIAL CABLES ARE FURNISHED BY VERIZON UNDER A SEPARATIE CONTRACT. THE CONTRACTOR SHALL ASSIST ANTENNA INSTALLATION CONTRACTOR IN TERMS OF COORDINATION AND SITE ACCESS. ERECTION SUBCONTRACTOR SHALL BE RESPONSIBLE FOR THE PROTECTION OF PERSONNEL.
- INSTALL ANTENNA AS INDICATED ON DRAWINGS AND VERIZON SPECIFICATIONS
- ņ INSTALL GALVANIZED STEEL ANTENNA MOUNTS AS INDICATED ON DRAWINGS.
- Ö INSTALL FURNISHED GALVANIZED STEEL OR ALUMINUM WAVEGUIDE AND PROVIDE PRINTOUT OF THAT TEST.
- CONTRACTOR SHALL PROVIDE FOUR (4) SETS OF SWEEP TESTS USING ANRITZU-PACKARD 87138 RF SCALAR NETWORK ANALYZER, SUBMIT FREQUENCY DOMAIN REFLECTOMETRE/RPD) TESTS RESULTS TO THE PROLECT MANAGER. SWEEP TESTS SHALL BE AS PER ATTACHED RFS "MINIMUM FIELD TESTING RECOMMENDED FOR ANTENNA AND HELIAX COAXIAL CABLE SYSTEMS" DATE DOLED 105/593, TESTING SHALL BE REPECTORAGE DR YA IN INDEPENDENT TESTING SERVICE AND BE BOUND AND SUBMITTED WITHIN ONE WEEK OF WORK COMPLETION.
- Ţ INSTALL COAXIAL CABLES AND TERMINATING BETWEEN ANTENNAS AND EQUIPMENT PER MANUFACTURER'S RECOMMENDATIONS, WEATHERPROOF ALL CONNECTIONS BETWEEN THE ANTENNA AND EQUIPMENT PER MANUFACTURER'S REQUIREMENTS, TERMINATE ALL COAXIAL CABLE THREE (3) FEET IN EXCESS OF ENTRY PORT LOCATION UNLESS OTHERWISE STATED.
- 9 ANTENNA AND COAXIAL CABLE GROUNDING:
- ALL EXTERIOR #6 GREEN GROUND WIRE TOAKY CHAIN" CONNECTIONS ARE TO BE WEATHER SEALED WITH ARS CONNECTORS/SPLICE WEATHER SEALED WITH ARS CONVINCEORS/SPLICE WEATHER PROOFING KIT #22/213 OR EQUAL.

PRIOR TO SUBMISSION OF BID, CONTRACTOR SHALL COORDINATE WITH VERIZON REP TO DETERMINE IF ANY PERMITS WILL BE OBTAINED BY CONTRACTOR, ALL REQUIRED PERMITS NOT OBTAINED BY VERIZON MUST BE OBTAINED, AND PAID FOR, BY THE CONTRACTOR.

- CONTRACTOR SHALL SUBMIT ALL SHOP DRAWINGS TO VERIZON FOR REVIEW AND APPROVAL PRIOR TO FABRICATION.
- 25. ALL ECUPMENT SHALL BE INSTALLED ACCORDING TO MANUFACTURER'S SPECIFICATIONS AND LOCATED ACCORDING TO VERIZON SPECIFICATIONS, AND AS SHOWN IN THESE PLAYS.

ω

- 26 THE CONTRACTOR SHALL SUPERVISE AND DIRECT THE PROJECT DESCRIBED HEREIN. THE CONTRACTOR SHALL BE SOLLEY RESPONSIBLE FOR ALL THE CONSTRUCTION MEANS, METHODS, TECHNIQUES, SEQUENCES AND PROCEDURES AND FOR COORDINATING ALL PORTIONS OF THE WORK UNDER THE CONTRACT.
- CONTRACTOR SHALL NOTIFY VERIZON REP A MINIMUM OF 48 HOURS IN ADVANCE OF POURING CONCRETE OR BACKFILLING ANY UNDERGROUND UTLITIES. FOUNDATIONS OR SEALING ANY WALL, FLOOR OR ROOF PENETRATIONS FOR ENGINEERING REVIEW AND
- THE CONTRACTOR SHALL PROTECT AT HIS OWN EXPENSE, ALL EXISTING FACILITIES AND SUCH OF HIS NEW WORK LIABLE TO INJURY DURING THE CONSTRUCTION PERIOD. ANY DAMAGE CAUSES BY NEGLECT ON THE PART OF THIS CONTRACTOR OR HIS REPRESENTATIVES, OR BY THE ELEMENTS DUE TO NEGLECT ON THE PART OF THIS CONTRACTOR OR HIS REPRESENTATIVES, EITHER TO THE EXISTING WORK, OR TO HIS WORK OR THE WORK OF THE CONTRACTOR, SHALL BE REPAIRED AT HIS EXPENSE TO THE OWNER'S SATISFACTION.
- 30. ALL WORK SHALL BE INSTALLED IN A FIRST CLASS, NEAT AND WORKMANLIKE MANNER BY MECHANICS SKILLED IN THE TRADE INVOLVED. THE QUALITY OF WORKMANSHIP SHALL BE SUBLECT TO THE APPROVAL OF THE VERIZON REP. ANY WORK FOUND BY THE VERIZON REP. AND WORK FOUND BY THE VERIZON REP. AND WORK FOUND BY THE VERIZON REP. AND TO BE OF INFERIOR QUALITY AND/OR WORKMANSHIP SHALL BE REPLACED AND/OR REWORKED AT CONTRACTOR EXPENSE UNTIL APPROVAL IS OBTAINED.

# ANTENNA INSTALLATION NOTES:

### WORK INCLUDED:

- m

ALL COAXIAL CABLE GROUNDING KITS ARE TO BE INSTALLED ON STRAIGHT RUNS OF COAXIAL CABLE (NOT WITHIN BENDS).

## ECTRICAL NOTES

- ELECTRICAL DESIGN SHALL BE PERFORMED BY ELECTRICAL CONTRACTOR.
  STRUCTURAL DESIGN SHALL BE PERFORMED BY GENERAL CONTRACTOR, ELECTRICAL
  CONTRACTOR SHALL ENGURE THAT ALL WORK COMPLES WITH ALL APPLICABLE LOCAL
  AND STATE CODES AND NATIONAL ELECTRICAL CODE.
- ALL SUGGESTED ELECTRICAL ELEMENTS (SUCH AS BREAKER SIZES, WIRE SIZES, CONDUITS SIZES ARE FOR ZONING PURPOSES ONLY. IT IS THE RESPONSIBILITY TO OF THE ELECTRICAL CONTRACTOR TO CONFIRM COMPLANCE WITH LOCAL ELECTRICAL CODES AND PASS ALL APPLICABLE AND NECESSARY INSPECTIONS. IN SOME EVENTS, IT MAY BE NECESSARY TO PERFORM AN ELECTRICAL LOAD STUDY TO VERFY THE CAPACITY OF THE EXISTING SERVICE. THIS IS NOT THE RESPONSIBILITY OF CONCORDIA. IT IS THE RESPONSIBILITY OF THE ELECTRICAL CONTRACTOR.
- CONTRACTOR SHALL FIELD LOCATE ALL BELOW GRADE GROUND LINES AND UTILITY LINES PRIOR TO CONSTRUCTION, CONTRACTOR IS RESPONSIBLE FOR RELOCATION ALL UTILITIES AND GROUND LINES THAT MAY BECOME DISTURBED OR CONFLICTING THE COURSE OF CONSTRUCTION.



## Kimley»Horn

REGISTY NO: 696 421 FAYETTEVILLE ST, SUITE 600 RALEIGH, NC 27601

ATC SITE NUMBER:

LACROSSE FL 6 ATC SITE NAME: 303048

ATC LACROSSE VERIZON SITE NAME:

2156 SE CR18 LAKE CITY, FL 32024 SITE ADDRESS:

MICHAEL LADD OCHUMAN CENSSONAL CONTRACTOR OF LEGISLATION OF LEGISL

CUSTOMER #:

131311

CUSTOMER ID: ATC LACROSSE

ATC JOB NO: DATE DRAWN: 08/17/21

13677441

ALL DISCREPANCIES FROM WHAT IS SHOWN ON THESE CONSTRUCTION DRAWINGS SHALL BE COMMUNICATED TO ATC ENGINEERING IMMEDIATELY FOR CORRECTION OR RE-DESIGN. FAILURE TO COMMUNICATE DIRECTLY WITH ATC ENGINEERING OR ANY CHANGES FROM THE DESIGN CONDUCTED WITHOUT PRIOR APPROVAL FROM ATC ENGINEERING SHALL BE THE SOLE

RESPONSIBILITY OF THE GE


VERAL CONTRACTOR.

GENERAL NOTES

G-002

SHEET NUMBER:

### SITE PLAN NOTES:

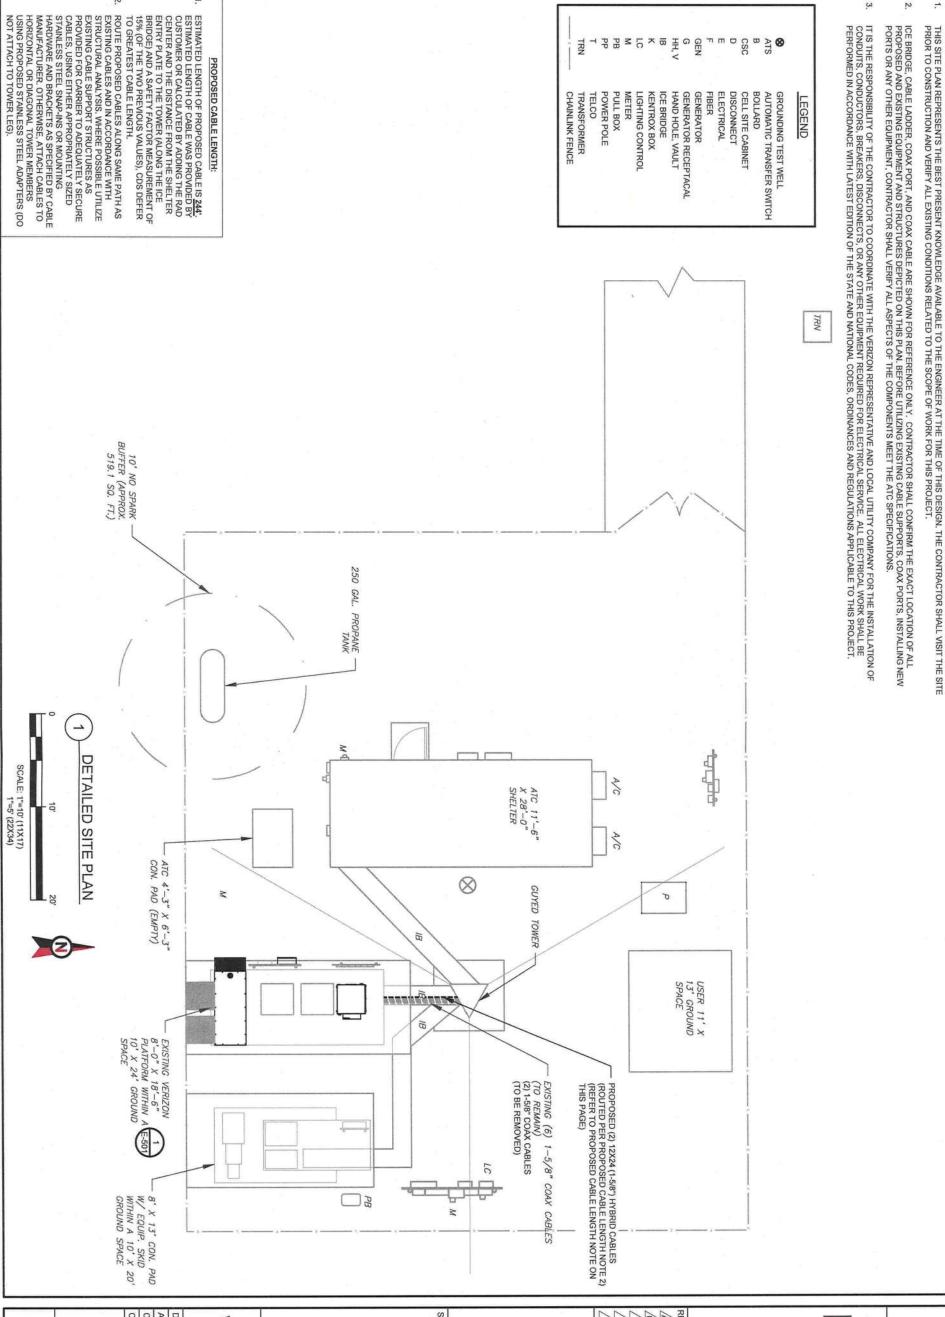



## **Kimley** » Horn AMERICAN TOWER

REGISTY NO: 696 421 FAYETTEVILLE ST, SUITE 600 RALEIGH, NC 27601

ISSUED FOR CONSTRUCTION HG 08/17/21	PRELIM DJC 08/03/21	REV. DESCRIPTION BY
8/17/21	8/03/21	DATE

T PB M C K B H, V

CSC D E

ATC SITE NUMBER: 303048

LACROSSE FL 6 ATC SITE NAME:

ATC LACROSSE VERIZON SITE NAME:


2156 SE CR18 LAKE CITY, FL 32024 SITE ADDRESS:


MC TATE OF HELD

131311	CUSTOMER #: 131311
ATC LACROSSE	CUSTOMER ID:
13677441	ATC JOB NO:
00/1//21	DATE DRAWN.

DETAILED SITE PLAN

SHEET NUMBER:

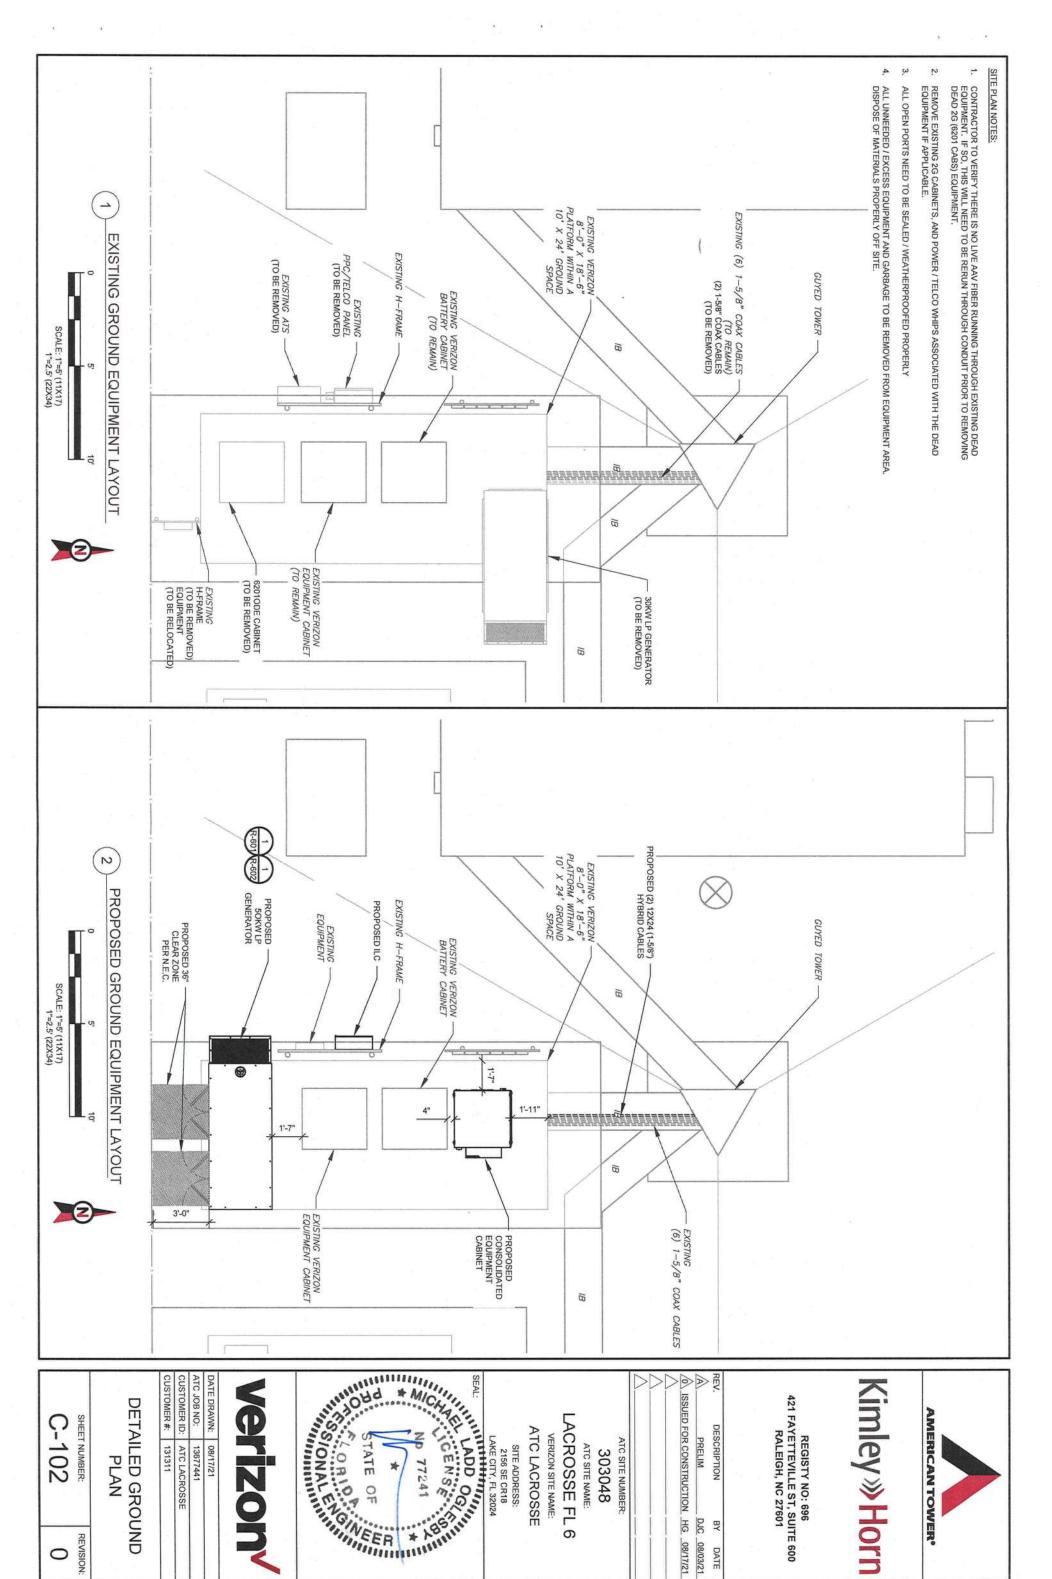

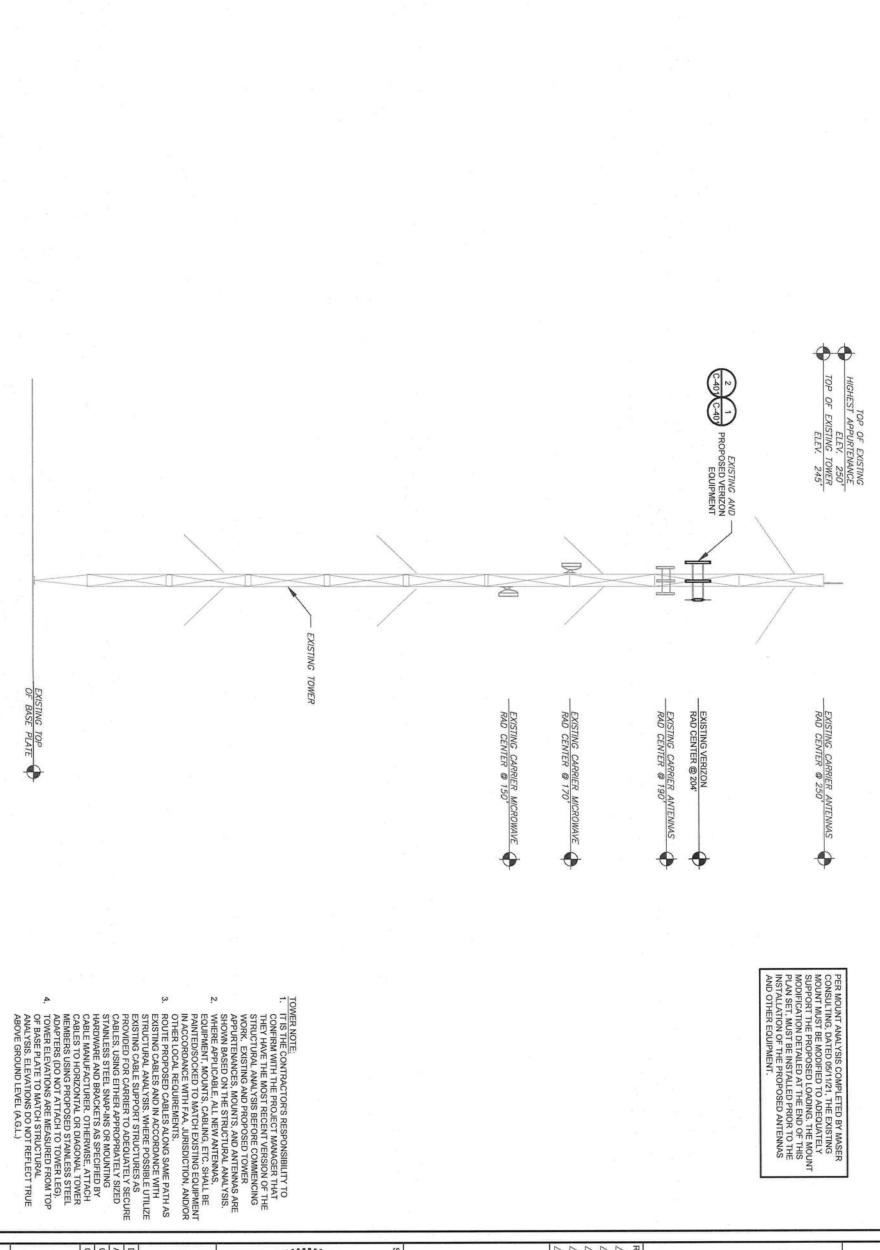

PER MOUNT ANALYSIS COMPLETED BY MASER CONSULTING, DATED 05/11/21, THE EXISTING MOUNT MUST BE MODIFIED TO ADEQUATELY SUPPORT THE PROPOSED LOADING. THE MOUNT MODIFICATION DETAILED AT THE END OF THIS PLAN SET, MUST BE INSTALLED PRIOR TO THE INSTALLATION OF THE PROPOSED ANTENNAS AND OTHER EQUIPMENT.

SEAL:

LADD OG

LADD OG

NO 77241

ACTOR OF THE OF

# DATE DRAWN: 08/17/21 ATC JOB NO: 13677441

2		
>		
U		
П		
ŋ		
=		
$\overline{\pm}$		
2		
_		

CUSTOMER #: CUSTOMER ID:

131311

ATC LACROSSE 13677441

TOWER ELEVATION

0

TOWER ELEVATION

REVISION:

SHEET NUMBER:

Kimley » Horn

AMERICAN TOWER'

A PRELIM DJC 08/03/21

O ISSUED FOR CONSTRUCTION HG 08/17/21

DESCRIPTION

BY

DATE

LACROSSE FL 6

ATC SITE NAME: 303048 ATC SITE NUMBER:

ATC LACROSSE


2156 SE CR18 LAKE CITY, FL 32024


SITE ADDRESS:


VERIZON SITE NAME:

REGISTY NO: 696 421 FAYETTEVILLE ST, SUITE 600

RALEIGH, NC 27601

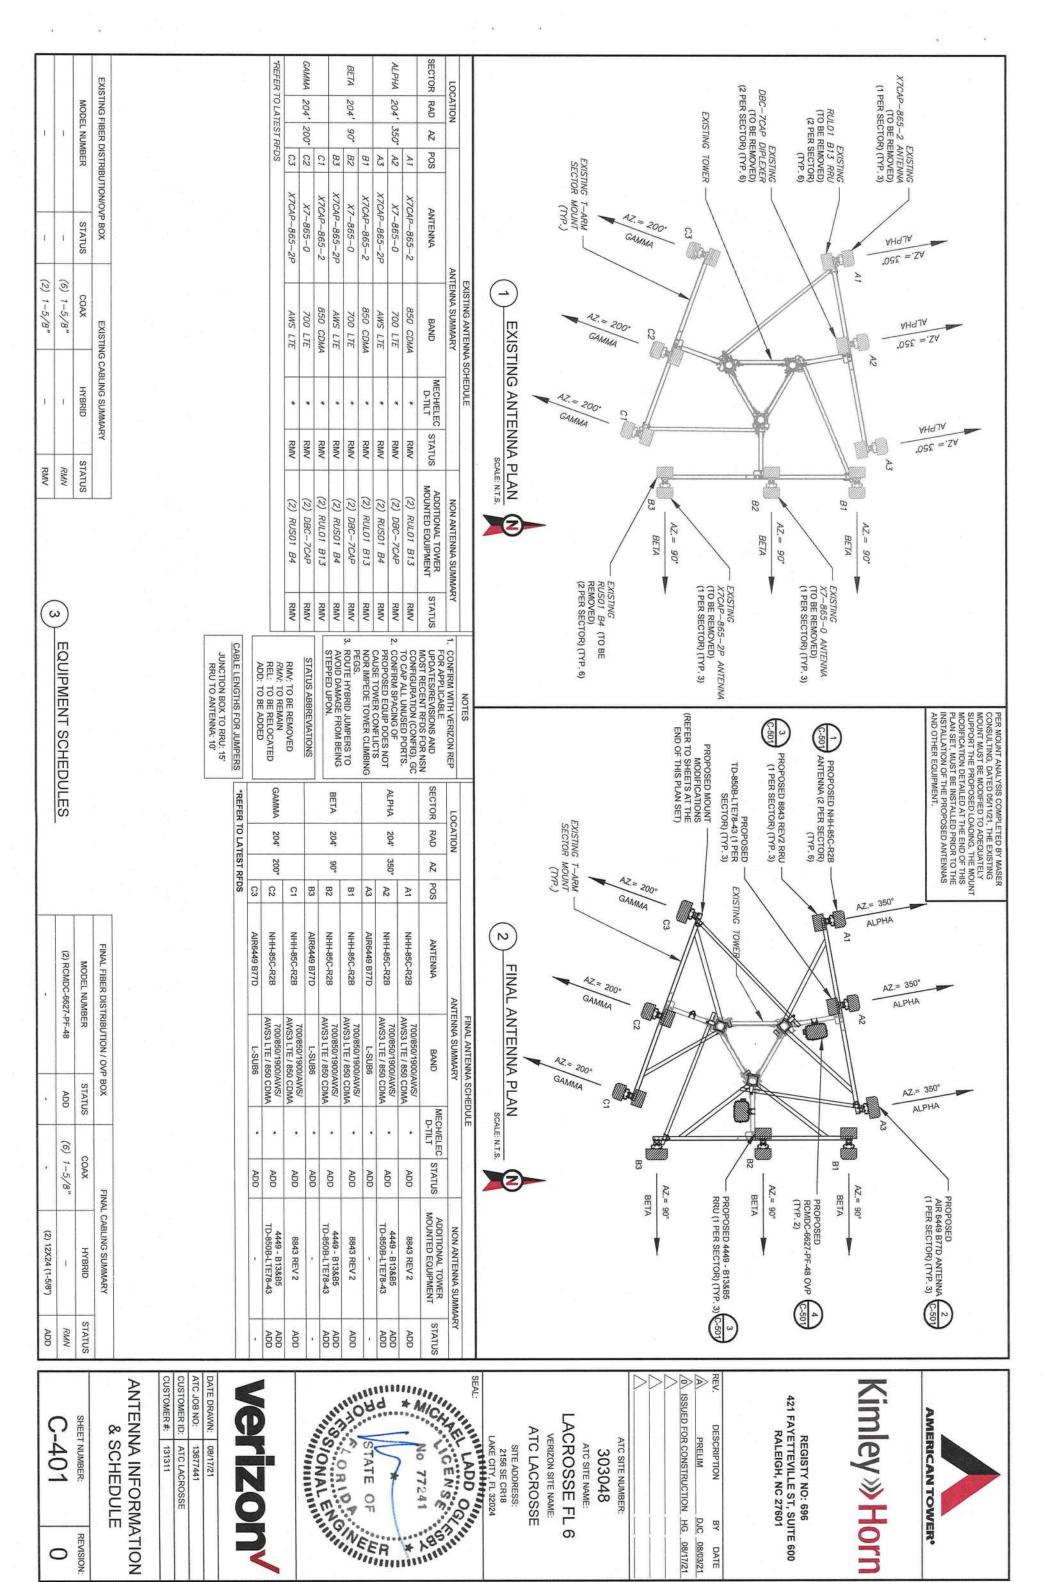

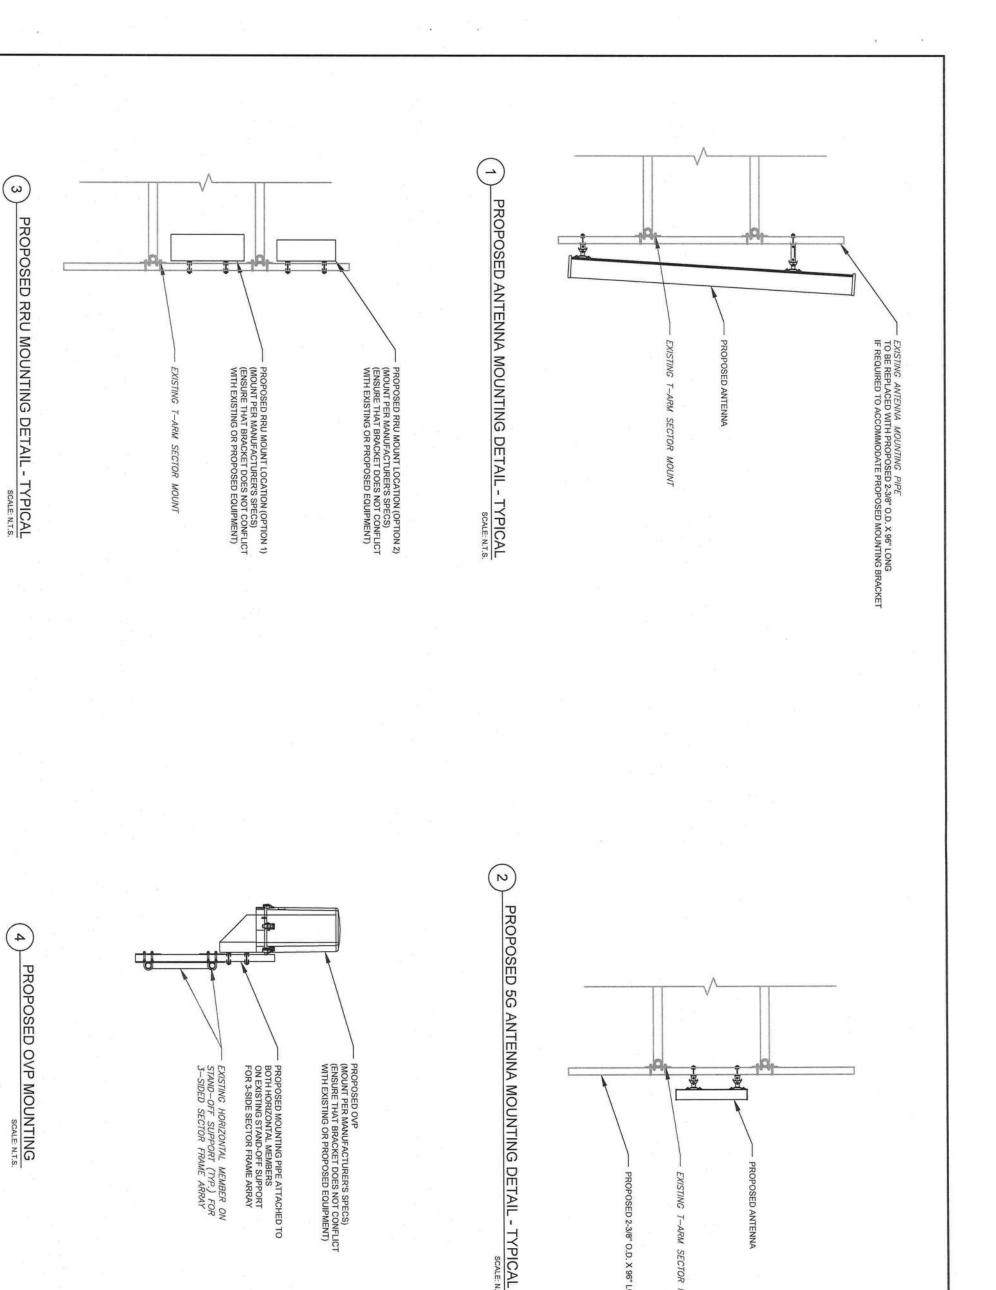

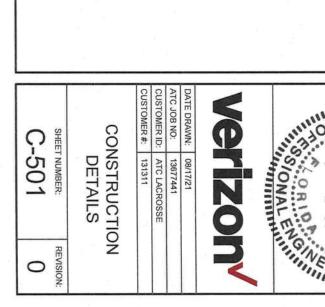

EXISTING T-ARM SECTOR MOUNT MCLARE LADD OGNILLING OF STATE LACROSSE FL 6 DESCRIPTION ATC LACROSSE VERIZON SITE NAME: 2156 SE CR18 LAKE CITY, FL 32024 ATC SITE NUMBER: SITE ADDRESS: ATC SITE NAME: 303048 DATE

SCALE: N.T.S.

PROPOSED 2-3/8" O.D. X 96" LONG



REGISTY NO: 696 421 FAYETTEVILLE ST, SUITE 600 RALEIGH, NC 27601

## ECTRICAL NOTES

## 1.00 CODES, STANDARDS, & SPECIFICATIONS STANDARDS AND PRACTICES AS REQUIRED BY NEC, NEMA, ANSI, NFPA, UBC, UL LOCAL UTILITY COMPANY. UL, IEEE, AND THE

- 1.04 ALL ELECTRICAL GROUNDING SHALL COMPLY WITH THE CURRENT EDITION OF THE NEC
- 1.05 CONTRACTOR SHALL MAINTAIN UL LISTED FIRE RATINGS AT ALL WALL PENETRATIONS.
- 1.06 CONTRACTOR SHALL MAINTAIN A MINIMUM CLEARANGE OF 39" IN FRONT OF ALL ELECTRICAL EQUIPMENT AS REQUIRED BY NEC. MINIMUM CLEARANCE SHALL BE OBSERVED FOR BOTH THE FRONT AND THE REAR OF THE METER H-FRAME RACK AND THE EQUIPMENT H-FRAME RACK.

### 2.00 GENERAL

- 2.01 CONTRACTOR SHALL BE RESPONSIBLE FOR ALL PERMITS AND ASSOCIATED FEES RELATED TO THE PROJECT AND SHALL DELIVER A COPY OF ALL PERMITS TO THE VERIZON REPRESENTATIVE
- 2.02 CONTRACTOR SHALL SCHEDULE AND SHOULD ATTEND ALL INSPECTIONS REQUIRED BY THE JURISDICTION HAVING AUTHORITY.
- 2.03 CONTRACTOR SHALL FURNISH ALL LABOR, MATERIALS, TOOLS, ACCESSORIES, ETC., FOR A COMPLETE WORKING ELECTRICAL INSTALLATION.
- 2.04 ALL WORK SHALL BE PERFORMED IN STRICT ACCORDANCE WITH APPLICABLE BUILDING CODES AND LOCAL ORDINANCES, INSTALLED IN A NEAT MANNER, AND SHALL BE SUBJECT TO APPROVAL BY THE ENGINEER.
- 2.05 CONTRACTOR SHALL PROTECT ADJACENT EQUIPMENT AND FINISHES FROM DAMAGE AND SHALL REPAIR TO ORIGINAL CONDITION ANY ITEMS DAMAGED AS A RESULT OF THE WORK
- 2.06 CONTRACTOR SHALL REPAIR ANY LANDSCAPING DISTURBED DURING CONSTRUCTION.
- 2.07 IF CONDUIT RUNS HAVE MORE THAN THREE (3) CONSECUTIVE 90 DEGREE TURNS, THE CONTRACTOR SHALL INSTALL PULL BOXES AS REQUIRED BY NEC.
- 2.08 CONTRACTOR SHALL INDICATE THE LOCATION OF ALL CAPPED UNDERGROUND SPARE CONDUIT ON THE RECORD DRAWINGS SUBMITTED TO THE OWNER.
- CONTRACTOR SHALL COORDINATE EXACT ROUTING OF CONDUIT WITH OWNER. ALL CONDUIT SHALL BE ROUTED WITHIN 3 FEET, EITHER SIDE, OF PERIMETER FENCING

### 3.00 MATERIALS

- 3.01 ALL EQUIPMENT AND MATERIALS SHOWN SHALL BE CONSIDERED NEW UNLESS SPECIFICALLY NOTED OTHERWISE ON THE DRAWINGS.
- 3.02 FINAL CONNECTIONS OF EQUIPMENT SHALL BE PER MANUFACTURER'S APPROVED WIRING DIAGRAMS, DETAILS, AND INSTRUCTIONS. THE ELECTRICAL CONTRACTOR SHALL PROVIDE MATERIALS AND EQUIPMENT COMPATIBLE WITH EQUIPMENT SUPPLIED BY VERIZON.
- 3.03 CONTRACTOR SHALL PROVIDE AN UPDATED PANELBOARD DIRECTORY FOR THE PANEL FROM WHICH THE NEW VERIZON EQUIPMENT CIRCUIT WILL BE CONNECTED, CONTRACTOR SHALL SUBMIT UPDATED DIRECTORY IN A PLASTIC COVER TO THE BUILDING OWNER FOR APPROVAL PRIOR TO INSTALLATION.
- 3.04 CONTRACTOR SHALL FIELD DETERMINE ACTUAL CONDUIT ROUTING AND SHALL OBTAIN APPROVAL FROM THE TOWER OWNER OF THE PROPOSED ROUTING PRIOR TO CONDUIT
- 3.05 ALL CONDUCTORS SHALL BE COPPER WITH THWN INSULATION AND ALL TERMINATIONS SHALL BE RATED FOR AT LEAST 75 DEGREES CELSIUS.
- 3.06 ALL NEUTRAL CONDUCTORS SHALL HAVE WHITE INSULATION. ALL GROUND CONDUCTORS IS SHALL HAVE GREEN INSULATION. COLOR TAPE IDENTIFICATION OF THESE CONDUCTORS IS
- 3.07 CONTRACTOR SHALL SEAL ALL CONDUITS ENTERING AN ENCLOSURE WITH CONDUIT SEALANT THAT IS COMPATIBLE WITH THE INSULATION OF THE CONDUCTORS IN THE
- 3.08 EQUIPMENT TO PREVENT WATER INFILTRATION. CONDUIT RUNS SHALL HAVE A CONTINUOUS DOWNWARD SLOPE AWAY FROM ALL
- 3.09 ALL CONDUIT SHALL BE SCHEDULE 40 PVC UNLESS NOTED OTHERWISE ON THE PLANS. WHEN CONDUIT IS ROUTED UNDER VEHICULAR TRAFFIC AREAS OR WHERE ABOVE GROUND AND SUBJECT TO DAMAGE, SCHEDULE 80 PVC CONDUIT SHALL BE UTILIZED. MANUFACTURED BEND RADII SHALL BE PER NEC.
- CONTRACTOR SHALL PROVIDE TWO (2) 200 POUND TEST POLYETHYLENE PULL CORDS IN ALL CONDUITS AND ALL INNERDUCTS. PULL CORDS SHALL BE SECURED AT EACH END OF CONDUIT RUNS. ALL SPARE CONDUIT ENDS SHALL BE CAPPED WITH MANUFACTURED PVC
- 3.11 CONTRACTOR SHALL BOND EACH METALLIC CONDUIT ENTERING A METALLIC ENCLOSURE WITH A #8 MIN AWG INSULATED COPPER BONDING JUMPER PER NEC. CONTRACTOR SHALL BOND ALL ELECTRICAL EQUIPMENT TO THE H-FRAME RACK ON WHICH EQUIPMENT IS MOUNTED WITH #8 MIN AWG INSULATED COPPER BONDING JUMPERS PER NEC.
- 3.12 CONTRACTOR SHALL IDENTIFY THE END OF ALL SPARE UNDERGROUND CONDUITS AND PROVIDE AND INSTALL 90 DEGREE ELBOWS WITH VERTICAL CONDUIT EXTENSIONS TO EXTEND 3" ABOVE FINISHED CRUISHED AGGREGATE GRADE. CONTRACTOR SHALL TERMINATE CONDUITS WITH MANUFACTURED CONDUIT CAPS THAT THE CONTRACTOR HAS

3.13 CONTRACTOR SHALL PROVIDE AND INSTALL AN ENGRAVED PHENOLIC PLATE ON THE FRONT OF THE INTEGRATED LOAD CENTER, THE WORDING ON THE PLATE SHALL READ AS FOLLOWS: "MAXIMUM DRAW OF ALL RECTIFIERS AND EQUIPMENT ON THE LOAD CENTER CANNOT EXCEED 50KW. IF ADDITIONAL POWER IS REQUIRED. THE EXISTING 50KW GENERATOR MUST BE REPLACED."

# PRE-CONSTRUCTION COORDINATION

4.01 CONTRACTOR SHALL VISIT THE SITE PRIOR TO BID AND NOTE EXISTING CONDITIONS THAT MIGHT AFFECT THEIR WORK, ALL SUCH CONDITIONS SHALL BE REPORTED TO THE ENGINEER PRIOR TO BID

6.02

- 4.02 THE CONTRACTOR SHALL PROVIDE A UTILITY LOCATOR AND SHALL VERIFY THE ACTUAL LOCATION OF ALL UTILITIES PRIOR TO CONSTRUCTION. THE CONTRACTOR SHALL BE RESPONSIBLE FOR PROTECTING ALL EXISTING UTILITIES, ANY DAMAGE TO EXISTING UTILITIES SHALL BE REPAIRED AT THE CONTRACTOR'S EXPENSE.
- 4.03 CONTRACTOR SHALL VERIFY, PRIOR TO ROUGH-IN, THAT SITE CONDITIONS ALLOW FOR THE PLACEMENT OF THE ELECTRICAL EQUIPMENT AS SHOWN ON THE PLANS.
- 4.04 CONTRACTOR SHALL COORDINATE WITH LOCAL ELECTRICAL UTILITY REGARDING THE EXACT LOCATION OF THE TRANSFORMER, ALL METERING REQUIREMENTS, AND THE EXACT LOCATION OF THE TRANSFORMER, ALL METER. CONDUIT ROUTING BETWEEN TRANSFORMER AND METER.
- 4.05 CONTRACTOR SHALL COORDINATE WITH LOCAL TELCO UTILITY REGARDING THE EXACT LOCATION OF THE TELCO SERVICE ENTRY POINT.

6.05

6.04

6,03

- 4.06 CONTRACTOR SHALL COORDINATE WITH AUTHORITY HAVING JURISDICTION REGARDING LOCAL FROST LINE REQUIREMENTS FOR RACEWAY MATERIAL SELECTION AND INSTALLATION.
- 4.07 CONTRACTOR SHALL PERFORM AN ARC FLASH ANALYSIS AT THE INTEGRATED LOAD CENTER AND PROVIDE ARC FLASH LABEL PER NEC.
- 4.08 ELECTRICAL SERVICE IS GREATER THAN 75 KVA, THE CONTRACTOR SHALL PERFORM A SHORT CIRCUIT ANALYSIS TO DETTERMINE THE REQUIRED AIC RATING PERFORM A SHORT CIRCUIT ANALYSIS TO DETTERMINE THE EXCUITE BEAKERS AND EQUIPMENT, FRIOR TO PURCHASING EQUIPMENT, THE CONTRACTOR SHALL CONTACT THE ELECTRIC UTILITY AND OBTAIN IN WRITING THE MAXIMUM AVAILABLE FAULT CURRENT (AFC) AT THE UTILITY SERVICE POINT. PROVIDE MAX. AFC SIGNAGE AS REQUIRED PER NEC 10.24. THE CONTRACTOR SHALL ENSURE ALL ELECTRICAL EQUIPMENT, CIRCUIT BREAKERS, DISCONNECTS, FUSES, AND PANELBOARDS HAVE A FAULT CURRENT INTERRUPTING RATING FUSES. ALL CIRCUIT BREAKERS AND EQUIPMENT SHALL HAVE A MINIMUM AIC RATING OF 10,000 AMPS. IF THE RATING OF THE UTILITY TRANSFORMER PROVIDING THE GREATER THAN THE AVAILABLE FAULT CURRENT

- O PANEL SCHEDULE LOADING NOTES
  PANEL SCHEDULE SHOWS FINAL CONDITIONS BASED UPON LOADING AND
  DIRECTION PROVIDED BY VERIZON WIRELESS AND AMERICAN TOWER
- 5.02 CONTRACTOR TO VERIFY ANY EXISTING LOADING NOT SHOWN IN THE FINAL PANEL CONFIGURATION OR EXPLICITLY CALLED OUT FOR REMOVAL WITH THE VERIZON CM PRIOR TO REMOVAL OF THE LOAD.
- 5.03 CONTRACTOR TO VERIFY ANY EXISTING LOAD DIRECTED TO REMAIN IN THE FINAL CONFIGURATION WITH THE PROPOSED LOADING SHOWN IN THE PANEL SCHEDULE WILL NOT EXCEED 80% OF THE PANELS MAXIMUM LOAD.

6.09

- 5.04 CONTRACTOR TO STOP WORK, AND NOTIFY THE EOR OF ANY DISCREPANCIES, FOR A REVISED AND APPROVED PANEL SCHEDULE.
- 5.05 PANEL SCHEDULE IS A TYPICAL REPRESENTATION OF WHAT IS EXPECTED ON VERIZON WIRELESS SITES IN THIS MARKET. ACTUAL LOADING MAY VARY BASED ON EXISTING CONDITIONS.

# 6.01

00 GROUNDING NOTES

- THE GROUND RING SHALL CONSIST OF #2 AWG BARE SOLID TINNED COPPER (STC) CONDUCTOR, UNLESS NOTED OTHERWISE, BURIED AT 30" BELOW FINISHED GRADE (OR BELOW FROST LINE). LOCATE 24" MINIMUM AND 36" MAXIMUM FROM EQUIPMENT PAD AND FROM TOWER FOUNDATION. ALL CONNECTIONS SHALL BE MADE USING A PARALLEL TYPE EXOTHERMIC WELD, UNLESS NOTED OTHERWISE, WHERE THE GROUND RING DISTURBS EXISTING SITE GROUNDING, CONNECT GROUND RING TO EXISTING SITE ON MAINTAIN THE CONTINUITY OF THE EXISTING SITE ON MAINTAIN THE CONTINUITY ON THE CONTINUITY OF THE EXISTING SITE ON MAINTAIN THE CONTINUITY OF THE CONTINUITY ON THE CONTINUITY O
- INSTALL GROUND RODS AS SHOWN AND AS REQUIRED, GROUND RODS TO BE COPPER CLAD STEEL, 58" DAMETER AND 10FT IN LENGTH, SPACING BETWEEN GROUND RODS SHALL BE 10FT MINIMUM AND 15FT MAXIMUM. TOP OF GROUND ROD TO BE 30" MINIMUM BELOW GRADE (OR BELOW FROST LINE). BOND TOP OF GROUND ROD TO GROUND WIRE WITH EXCTHERMIC WELD, DO NOT EXCTHERMICALLY WELD ANYTHING TO GROUND ROD EXCEPT GROUND WIRE WHICH PASSES OVER TOP OF GROUND ROD.
- GENERATOR GROUND RING SHALL HAVE A MINIMUM OF 4 GROUND RODS, INSTALLED AT THE CORNERS OF THE GROUND RING PLUS ADDITIONAL RODS AS REQUIRED TO COMPLY WITH THE SPACING REQUIREMENTS.
- MINIMUM BEND RADIUS FOR #2 AWG GROUND WIRE IS 12", EXCEPT USE 24" FOR EQUIPMENT PAD GROUND RINGS.
- GROUND ALL EXTERIOR EXPOSED METAL OBJECTS TO BURIED GROUND SYSTEM WITH #2 STC MECHANICALLY ATTACHED OR EXOTHERMICALLY WELDED TO OBJECTS AND EXOTHERMICALLY WELDED TO GROUND RING, USE TWO HOLE LUGS FOR CONNECTION TO FLAT METAL SURFACES, USE ONLY STAINLESS STEEL HARDWARE ON ALL MECHANICAL CONNECTIONS, CLEAN ALL SURFACES (AND STRIP PAINTED SURFACES) TO BARE BRIGHT METAL PRIOR TO MAKING GROUND CONNECTIONS, APPLY ANTI-OXIDE COMPOUND TO ALL MECHANICAL CONNECTIONS. APPLY ZINC RICH PAINT (OCLD GALV.) TO ALL EXOTHERMIC WELDS, AND TO ANY METAL EXPOSED BY CLEANING, STRIPPING, GRINDING, CUTTING OR DRILLING.
- ALL GROUNDING CONDUCTORS ABOVE GRADE SHALL BE RUN IN 3/4" FLEXIBLE PVC CONDUIT. CONDUIT SHALL BEGIN WITHIN 3/4" OF ABOVE GROUND CONNECTION POINT, SHALL EXTEND 2/4" BELOW GRADE MINIMUM, AND SHALL BE FILLED WITH SEALANT AT ABOVE GROUND CONNECTION POINT. SECURE CONDUIT EVERY 2/4" ON VERTICAL RUNS AND EVERY 3/6" ELSEWHERE WITH NON-METALLIC TIES.
- LEADS AT TWO DIAGONALLY OPPOSITE CORNERS OF GENERATOR BY DRILLING AND BOLTING TWO HOLE LUG TO FINS ON GENERATOR BASE STRUCTURE. GROUND LEADS SHOULD RUN ALONG BASE OF GENERATOR AND TAKE SHORTEST PATH ACROSS CONCRETE PAD TO GRAVEL AREA, AND THEN CONTINUE TO GROUND RING.
- 6.08 EXOTHERMICALLY WELDED TO THE POST AND EXOTHERMICALLY WELDED TO GROUND RING, ANY FENCE WITH METAL LINE POSTS WITHIN 6TT OF THE GROUND RING SHALL HAVE THE LINE POSTS BONDED TO THE GROUND RING WITH #2 STC WITH #2 STC CLAMPED OR EXOTHERMICALLY WELDED TO THE POST AND EXOTHERMICALLY WELDED TO THE POST AND EXOTHERMICALLY WELDED TO THE POST AND EXOTHERMICALLY WELDED TO GROUND RING AT 20FT MAXIMUM INTERVALS AS MEASURED ALONG THE LENGTH OF THE FENCE. ANY METAL FENCE POST WITHIN 6FT OF A GROUNDED METAL OBJECT SHALL BE BONDED TO THE EQUIPMENT GROUND RING WITH #2 STC CLAMPED OR
- NOTIFY CM TO INSPECT GROUND RING BEFORE BACKFILLING, CONTRACTOR SHALL HIRE A 3RD PARTY TO PERFORM AN IEEEB1 FALL OF POTENTIAL METHOD GROUND TEST, MAXIMUM ALLOWABLE RESISTANCE TO GROUND IS 5 OHMS, PROVIDE ADDITIONAL GROUND SYSTEM COMPONENTS AS REQUIRED TO ACHIEVE THIS VALUE.
- GROUNDING OF ALL ELECTRICAL EQUIPMENT SHALL BE AS PER NEC, MUNICIPAL AND

6.10

6.11 WHERE PROPANE TANK IS INSTALLED TO FUEL GENERATOR, BOND PROPANE TANK TO GROUND RING WITH A SINGLE #STC CLAMPED TO FILLER PIPE OF PROPANE TANK AND EXOTHERMICALLY WELDED TO GROUND RING, GROUND LEAD SHOULD RUN TO TANK SUPPORT AND TAKE SHORTEST PATH ACROSS CONCRETE PAD TO GRAVEL AREA, THEN CONTINUE TO GROUND RING, IF PROPANE TANK FUEL LINE IS METALLIC AND CROSSES EQUIPMENT GROUND RING, IF PROPANE TANK FUEL LINE TO GROUND RING WHERE THE TWO LINES CROSS WITH A SINGLE #2 STC CLAMPED TO FUEL LINE RING WHERE THE TWO LINES CROSS WITH A SINGLE #2 STC CLAMPED TO FUEL LINE AND EXOTHERMICALLY WELDED TO GROUND RING.

- BOND GENERATOR TO GROUND RING WITH #2 STC MECHANICALLY FASTENED TO GENERATOR AND EXOTHERMICALLY WELDED TO GROUND RING. LOCATE GROUND

6.07

6.06

- UTILITY COMPANY REQUIREMENTS.

## AMERICAN TOWER®

# Kimley»Horr

REGISTY NO: 696 421 FAYETTEVILLE ST, SUITE 600 RALEIGH, NC 27601

0 ISSUED FOR CONSTRUCTION HG 08/17/21 DESCRIPTION PRELIM ATC SITE NUMBER: DJC 08/03/21 DATE

303048

ATC SITE NAME:

LACROSSE FL 6 VERIZON SITE NAME:

ATC LACROSSE

SITE ADDRESS:

SEAL: ADD OCHUMAN STATE OF AND OCHUMAN STATE OCHUMA

131311	CUSTOMER #:
ATC LACROSSE	CUSTOMER ID:
13677441	ATC JOB NO:
08/17/21	DATE DRAWN: 08/17/21


## **ELECTRICAL NOTES**

E-100

SHEET NUMBER

REVISION

0

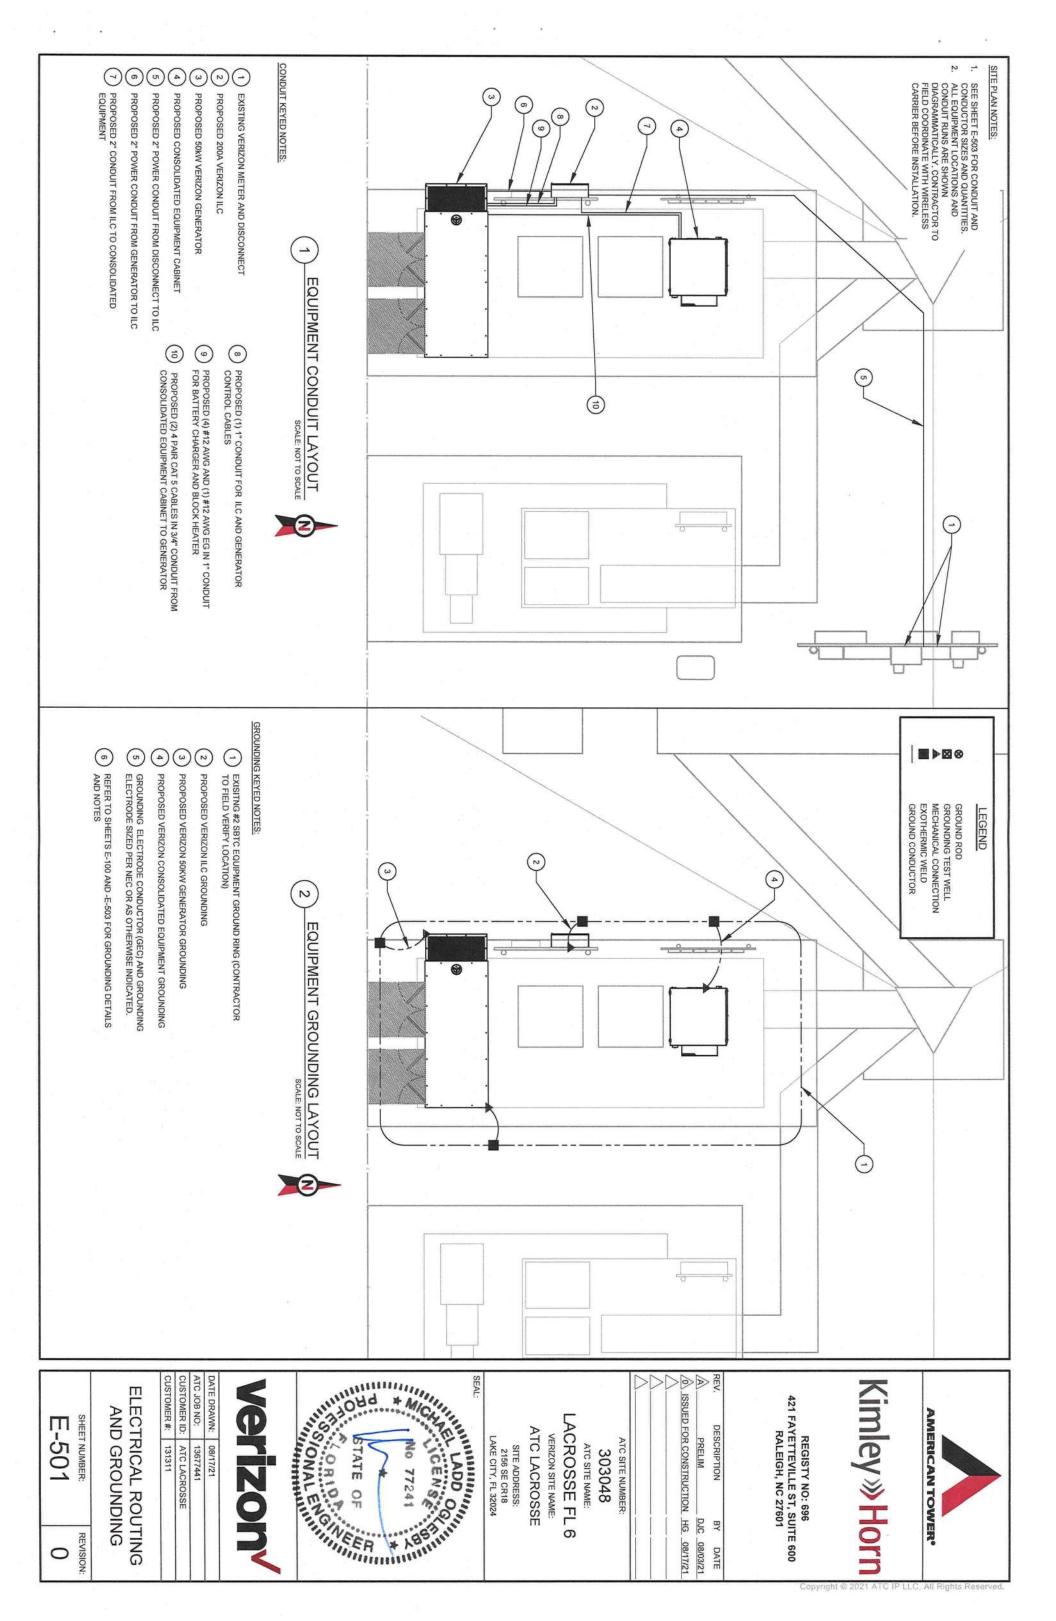

PANEL SCHEDULE NOTES:

1. PANEL SCHEDULE IS A TYPICAL
1. PANEL SCHEDULE IS A TYPICAL
VERIZON WIRELESS SITES IN THIS MARKET.
ACTUAL LOADING MAY VARY BASED ON EXISTING IF THE EXISTING AND PROPOSED LOAD IS FOUND TO EXCEED THE MAXIMUM LOADING OF THE PANEL, WORK IS TO CEASE IMMEDIATELY AND CONDITIONS.

THE EOR IS TO BE NOTIFIED.

**ENCLOSURE TYPE** PHASE, WIRES MOUNT MAIN BREAKER PANEL STATUS **VOLTAGE** CKT LOAD DESCRIPTION GFI **Block Heater Battery Charger** \*\*Lights \*RECTIFIER 1 Surge Supressor SURFACE SINGLE, 3 PROPOSED NEMA 3R 200 AMP 120/240V **AMPS** 30 60 30 20 20 20 20 60 POLES BREAKER STATUS 2 2 9 9 9 9 9 9 SERVICE USA LOAD VA FACTOR N TO GROUND BOND **GROUND BAR NEUTRAL BAR BUS RATING** AIC RATING 1136 1136 1500 180 540 300 0 0 1.00 1.25 1.25 1.25 1.25 1.25 1.25 1.25 1.25 1.25 1.25 1.25 1.25 1.25 1.25 PHASE A PHASE B 13265 1420 1600 1420 1420 1795 2095 2095 1420 × YES YES YES 200 AMPS 22,000 AMPS 13640 2840 1420 3295 1645 1420 1420 1600 S NOTES: Panel schedule shows final conditions based upon loading and FACTOR 1.25 1.00 1.25 1.25 1.25 1.25 1.25 1.25 1.25 1.25 1.25 1.25 1.25 1.25 1.25 LOAD VA SERVICE 1136 1136 1136 1136 1136 1136 1136 1136 1136 1136 1136 1136 1136 1136 180 STATUS 8 9 2 8 8 2 8 9 2 8 8 9 8 8 8 BREAKER POLES 2 2 2 2 BREAKER AMPS 30 30 20 30 30 30 30 30 30 30 30 30 30 8 30 PROPOSED GFI \*RECTIFIER 7 RECTIFIER 3 LOAD DESCRIPTION \*RECTIFIER8 \*RECTIFIER 4 RECTIFIER 2 RECTIFIER 6 RECTIFIER 5 유 22 20 14 12 30 28 26 24 18 16 10 00 σ

TOTAL SERVICE LOAD KVA OVERALL LOAD SUMMARY 112.10 26.91

23

21 19

27 25 17

15 13 11

- \* LOADING VALUES ARE BASED ON INFORMATION PROVIDED BY VERIZON WIRELESS
- \*\* LOADING VALUES ARE BASED ON INFORMATION PROVIDED BY ATC


direction provided by Verizon Wireless and American Tower Corporation.

configuration or explicitly called out for removal with the Verizon CM prior to removal of the load. Contractor to verify any existing loading not shown in the final panel

configuration with the proposed loading shown in the panel schedule will Contractor to verify any existing load directed to remain in the final

not exceed 80% of the panels maximum load.

for a revised and approved panel schedule. Contractor to stop work, and notify the EOR of any discrepancies,

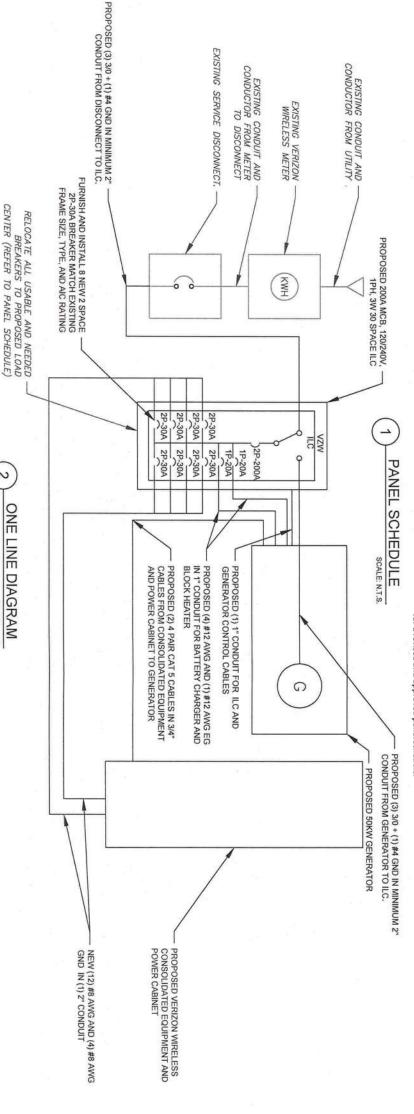



## Kimley»Hor

REGISTY NO: 696 421 FAYETTEVILLE ST, SUITE 600 RALEIGH, NC 27601


REV. DESCRIPTION	ВҮ	DATE
PRELIM	DJC	DJC 08/03/21
0 ISSUED FOR CONSTRUCTION HG 08/17/21	HG	08/17/2

ATC SITE NUMBER: 303048

LACROSSE FL 6 VERIZON SITE NAME: ATC SITE NAME:

ATC LACROSSE

2156 SE CR18 LAKE CITY, FL 32024 SITE ADDRESS:

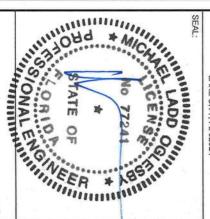

ATC JOB NO: DATE DRAWN: 08/17/21


13677441


E-502 SHEET NUMBER: REVISION ONE LINE DIAGRAM

0

N

ONE LINE DIAGRAM

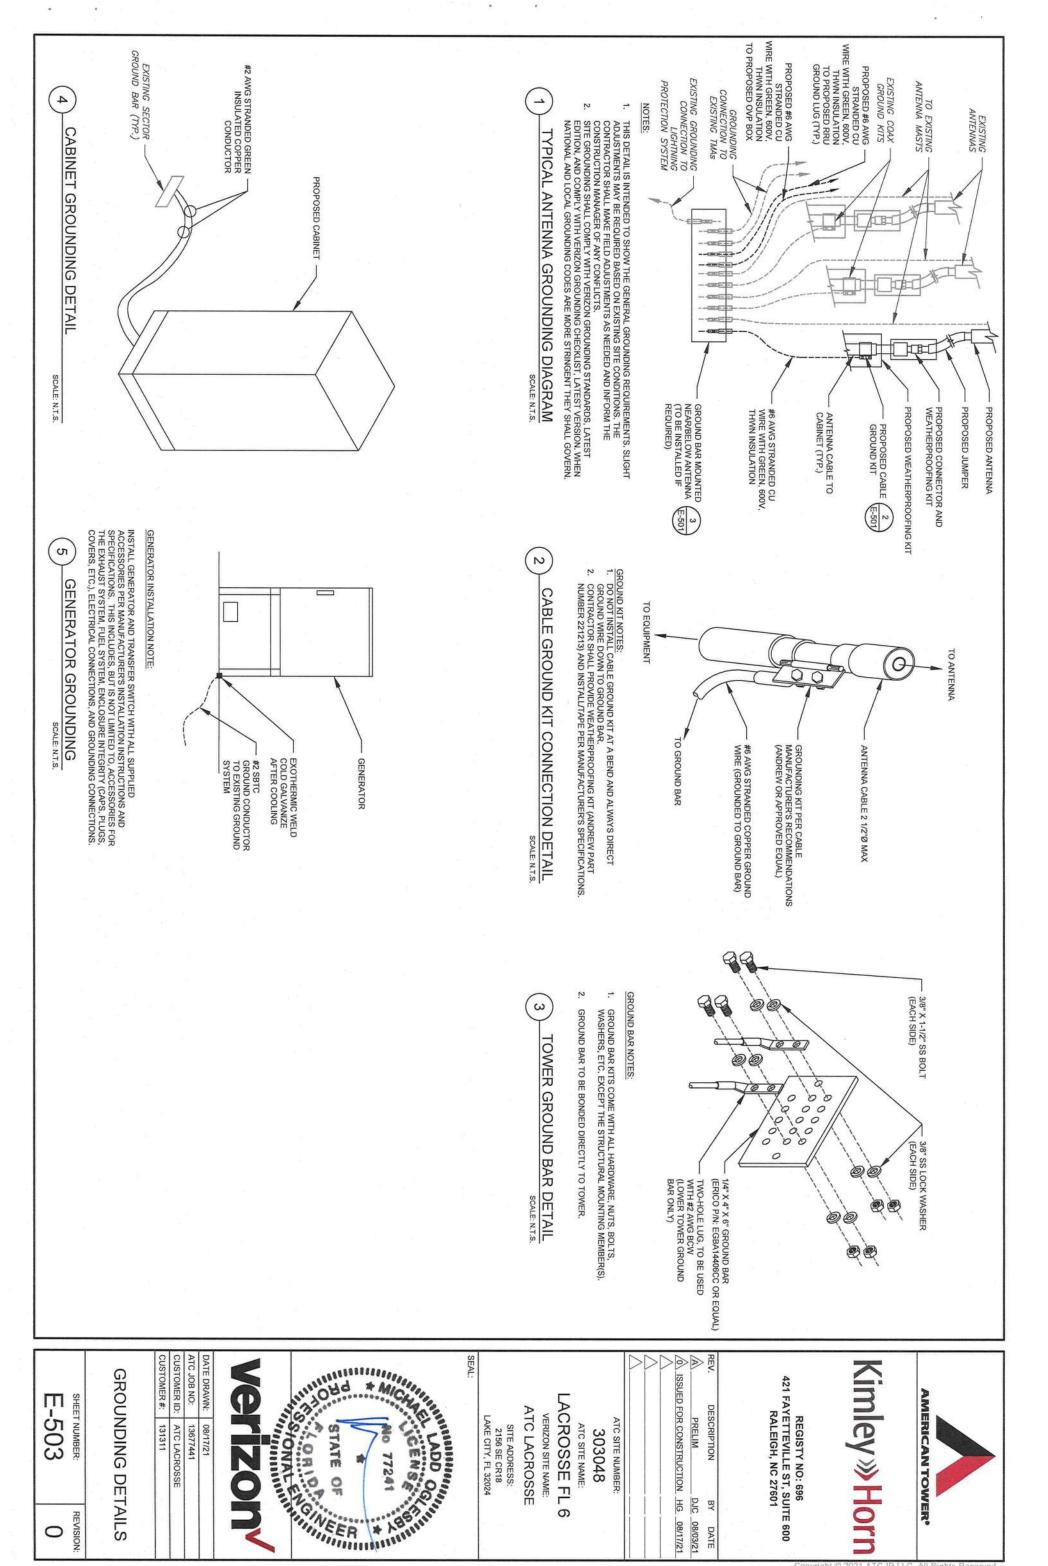

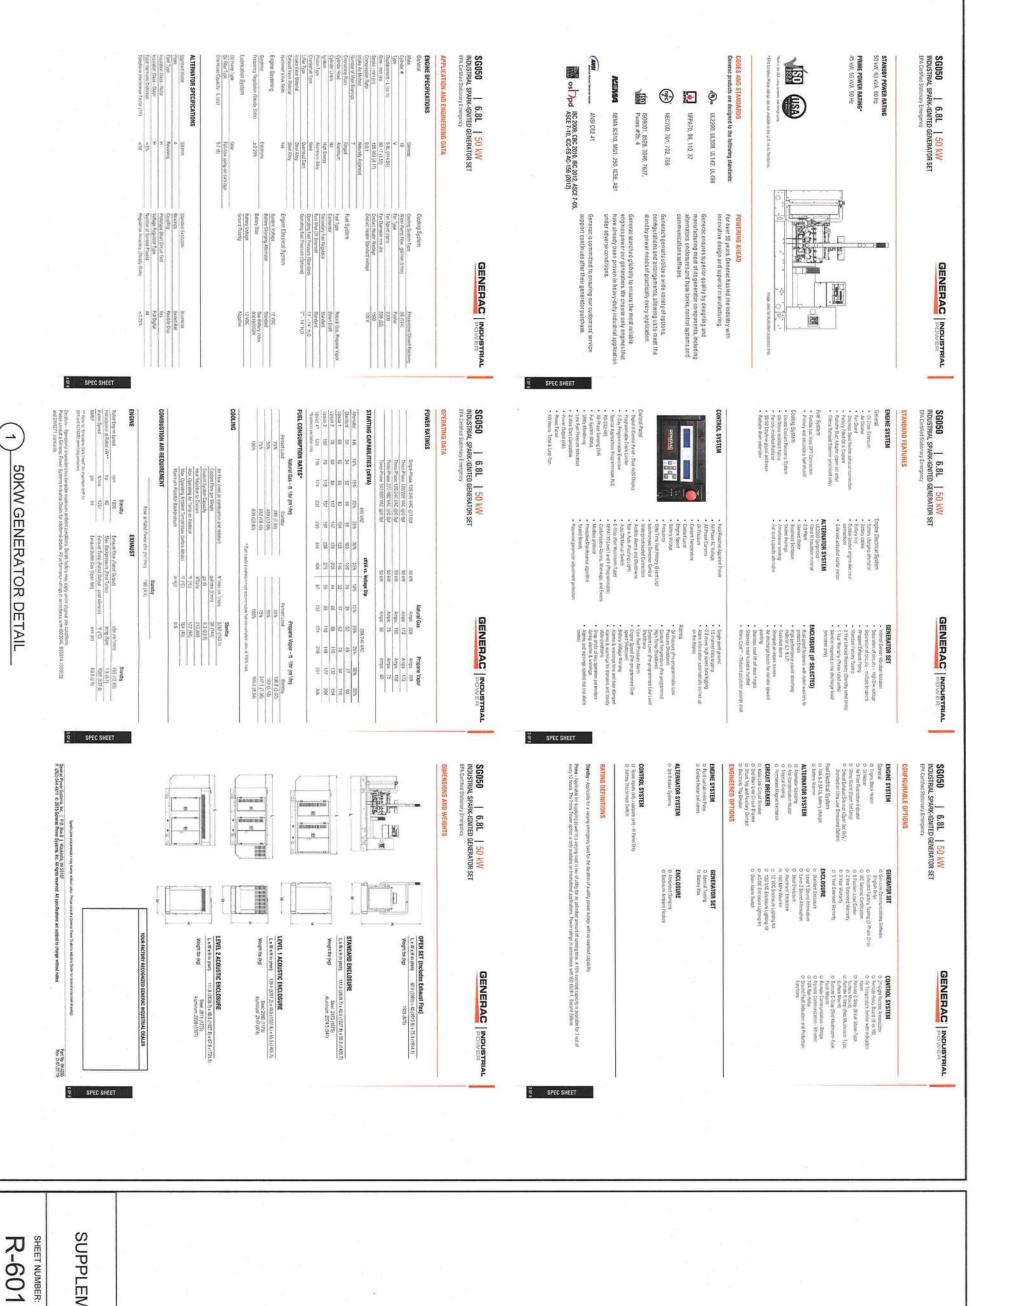


SUPPLEMENTAL

0

REVISION:

Copyright @ 2021 ATC IF LLC, All Rights Reserved

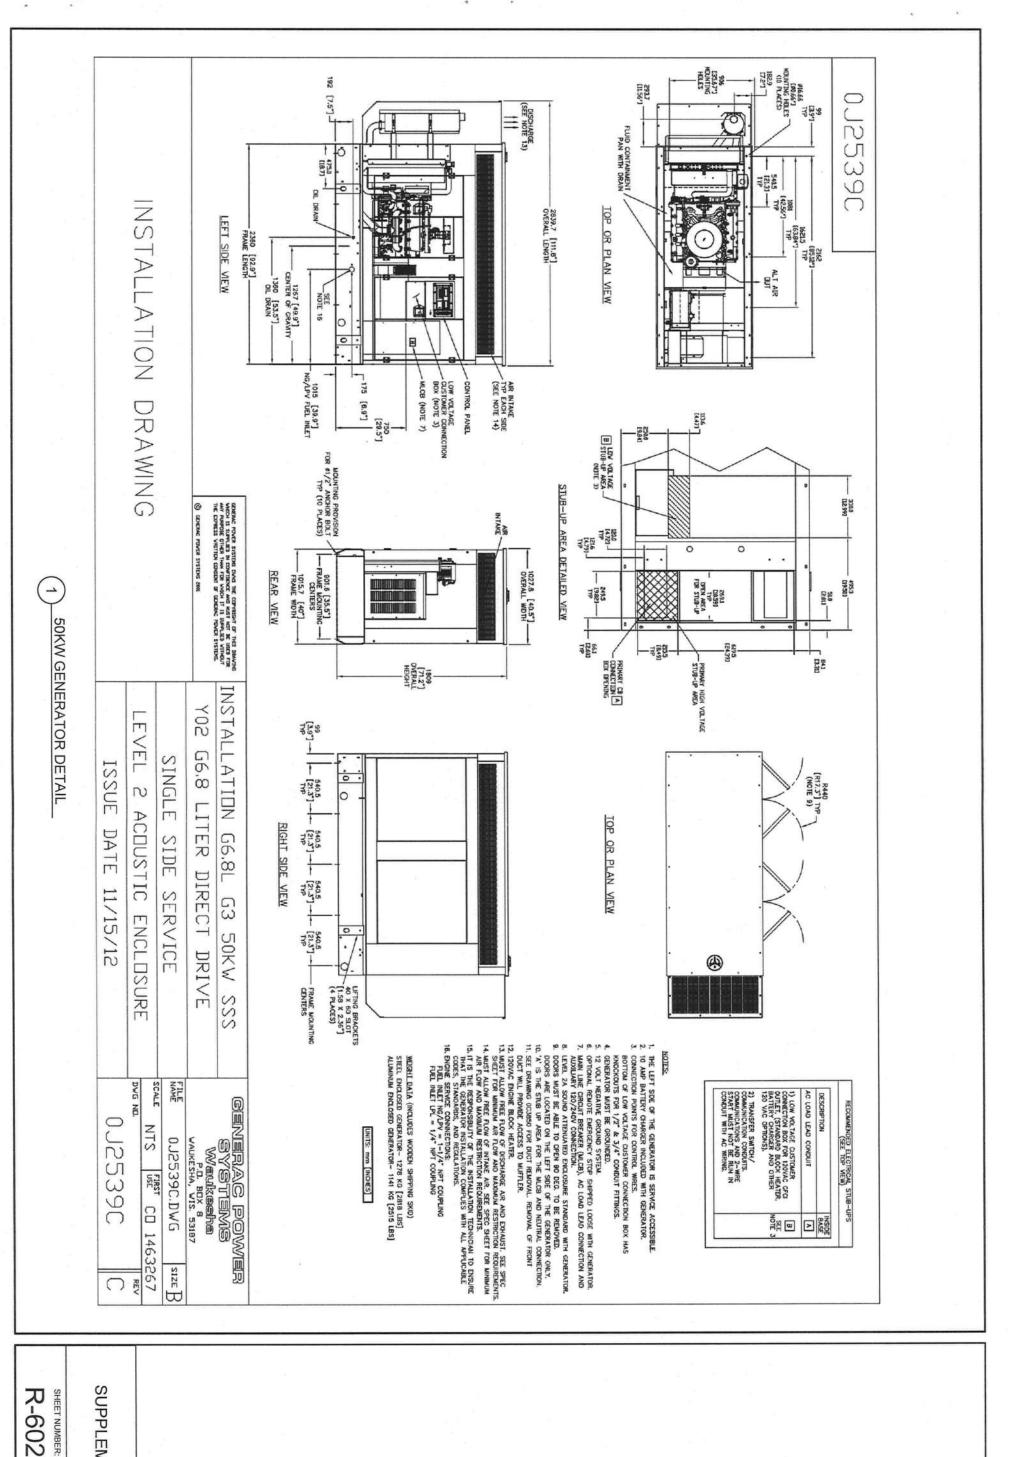

SUPPLEMENTAL

4720 Salisbury Road Jacksonville, FL 32256 877.627.3772 Maser Consulting



## shawn.sacks@colliersengineering.com

# Antenna Mount Analysis Report

Mount Analysis

Maser Consulting Project #: 21944603A SMART Tool Project #: 10057764

May 11, 2021

Site Information

Site ID:

Site Name:

Address: Carrier Name:

Verizon Wireless 2156 SE CR18 131311-VZW I ATC LACROSSE ATC LACROSSE

29.951500° Lake City, Florida 32024 Columbia County 82.570722°

Longitude:

Latitude:

250-Ft Guyed 13.00-Ft Combined T-Frame

Structure Information

FUZE ID # 16276457

Mount Type: Tower Type:

Analysis Results

Combined T-Frame: >200.0% Fail

Report Prepared By: Garrett Smith



MOUNT ANALYSIS

Mount Structural Analysis Report (1) 13.00-Ft Combined T-Frame

May 11, 2021 Site ID: 131311-VZW / ATC LACROSSE Page | 3

Copyright @ 2021 ATC IP LLC, All Rights Rese

## Final Loading Configuration:

The following equipment has been considered for the analysis of the mount:

Equipment (ft)         Quantity         Manufacturer         Model           (ft)         6         Commscope         NHH-85C-R2B           3         Ericsson         AIR 6449           204.00         3         Ericsson         4449           3         Ericsson         8843           3         Commscope         TD-850B-LTE78-43           2         Raycap         RHSDC-6627-PF-48
Model  NHH-85C-R2B  AIR 6449  4449  8843  TD-850B-LTE78-43  RHSDC-6627-PF-48

## Standard Conditions:

- All engineering services are performed on the basis that the information provided to Maser Consulting and
  used in this analysis is current and correct. The existing equipment loading has been applied at locations
  determined from the supplied documentation. Any deviation from the loading locations specified in this report shall be communicated to Maser Consulting to verify deviation will not adversely impact the analysis.
- Mounts are assumed to have been properly fabricated, installed and maintained in good free and plumb in accordance with its original design and manufacturer's specifications. condition, twist

Obvious safety and structural issues/deficiencies noticed at the time of the mount mapping and reported in the Mount Mapping Report are assumed to be corrected and documented as part of the PMI process and are not considered in the mount analysis.

The mount analysis and the mount mapping are not a condition assessment of the maintenance and condition assessments are still required post analysis. mount. Proper

- ω For mount analyses completed from other data sources (including new replacement mounts) and not specifically mapped by Maser Consulting, the mounts are assumed to have been properly fabricated, installed and maintained in good condition, twist free and plumb in accordance with its original design and manufacturer's specifications.
- All member connections are assumed to have been designed to meet or exceed the load carrying capacity of the connected member unless otherwise specified in this report.

4.

- 5 The mount was checked up to, and including, the bolts that fasten it to the mount collar/attachment and threaded rod connections in collar members if applicable. Local deformation and interaction between the mount collar/attachment and the supporting tower structure are outside the scope of this analysis.
- All services are performed, results obtained, and recommendations made in accordance accepted engineering principles and practices. Maser Consulting is not responsible for topinions, and recommendations made by others based on the information supplied. the conclusion, with generally

6


SUPPLEMENTAL

R-603

SHEET NUMBER:

NOTE: THIS SHEET WAS CREATED BY OTHERS AND PROVIDED AT THE REQUEST OF THE CUSTOMER WITHOUT EDIT. PLEASE REFERENCE THE MOUNT ANALYSIS REPORT FOR COMPLETE MOUNT ANALYSIS REPORT FOR COMPLETE MOUNT ANALYSIS CALCULATIONS AND DETAILS. SUPPLEMENTAL PAGES INCLUDED IN THE CONSTRUCTION DRAWINGS ARE FOR REFERENCE ONLY. GENERAL CONTRACTOR IS TO VERIFY THEY HAVE THE MOST RECENT MOUNT ANALYSIS PRIOR TO CONSTRUCTION.

0

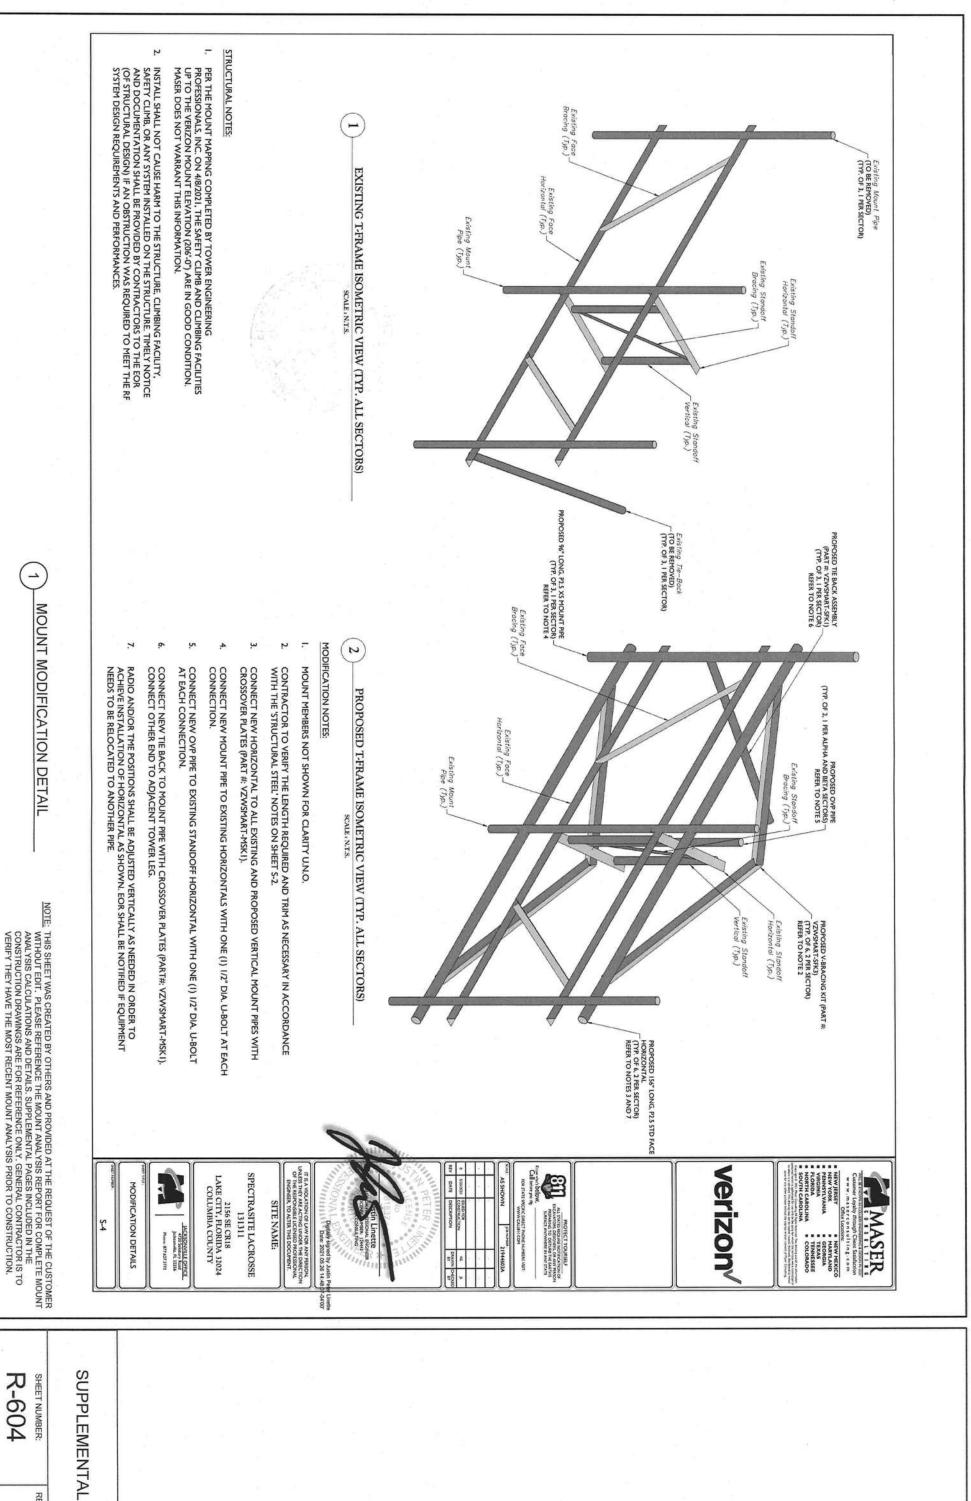

R-604 SHEET NUMBER:

REVISION: 0

Copyright © 2021 ATC IP LLC, All Rights Ress