

RETROFIT: EXISTING PYLON

045 - TAKE 5

CAR WASH

345 W Duval St

Loke City, FL 32055

UL Underwriters Laboratories Inc.
UL File #E229670



INITIAL LAYOUT:

April 15, 2022

REVISIONS:

I
II
III
IV
V

Sq. Ft. Signage:

41.66

Signage Allowance:

N/A Replacing Existing



60.00' EST

100.00' EST
41.66 Sq. Ft.
GTY: 2

Color Key:

PMS 2191 C

PMS 7691 C

PMS 107 C

Black

White

72.00'

PROOF
PHASE 1

REMOVE AND DISPOSE OF EXISTING SIGNAGE
AND BAC, AS WELL AS PAINTING
BY CLIENT/POC PRIOR TO INSTALLATION



EXISTING CONDITIONS

IMPOSED IMAGERY



SPECIFICATIONS

CABINET REPLACEMENT

PANELS

Quantity:

See above

Size:

As in drawing

Face Color:

As in drawing

Vinyl Colors:

As in drawing

Face:

Flat (Retrofit As needed)

Mounting:

Into existing cabinet

SPECIFICATIONS

LED RETROFIT

TOP CABINET

Quantity:

ESTIMATED 10

Material:

36" LED Retrofits

Mounting:

Into existing sockets & rewired

NOTES:

- EXISTING CONDITIONS VARY & MAY AFFECT COST DUE TO SIZE, MATERIAL, QUANTITY, INSTALLATION, SCOPE, ETC.
- REPLACE CABINET PANELS (RETROFIT AS NEEDED)
- RETROFIT TO LED BULBS (RETROFIT AS NEEDED)
- PAINT EXISTING POLES AND CABINETS BLACK

Owner/Landlord Approval _____

6801 Mount Hermon Church Rd, Ste C, Durham, NC 27705 • (P) 919-552-8689 • (F) 919-557-1322

SIGNS: UNLIMITED

(communicate your identity)

RETROFIT: EXISTING PYLON

045 - TAKE 5

CAR WASH

345 W Duval St

Lake City, FL 32055

UL Underment Laboratories Inc.
UL File #E225670



INITIAL LAYOUT:

April 15, 2022

REVISIONS:

I
II
III
IV
V

Sq. Ft. Signage:

41.66

Signage Allowance:

N/A Replacing Existing

REMOVE AND DISPOSE OF EXISTING SIGNAGE
AND BLC, AS WELL AS PAINTING
BY CABINET PRIOR TO INSTALLATION



EXISTING CONDITIONS

IMPOSED IMAGERY



240.00' EST

96.00' EST



Color Key:

PMS 2191 C
PMS 7691 C
PMS 107 C
Black
White

SPECIFICATIONS

CABINET REPLACEMENT

PANELS

Quantity:

See above

Size:

As in drawing

Face Color:

As in drawing

Vinyl Colors:

As in drawing

Face:

Flat (retrofit as needed)

Mounting:

Into existing cabinet

SPECIFICATIONS

LED RETROFIT

TOP CABINET

Quantity:

ESTIMATED 10

Material:

36" LED Retrofits

Mounting:

Into existing sockets & rewired

NOTES:

- EXISTING CONDITIONS VARY & MAY AFFECT COST DUE TO SIZE, MATERIAL, QUANTITY, INSTALLATION, SCOPE, ETC.
- REPLACE CABINET PANELS (RETROFIT AS NEEDED)
- RETROFIT TO LED BULBS (RETROFIT AS NEEDED)
- PAINT EXISTING POLES AND CABINETS BLACK

Owner/Landlord Approval _____

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SIGNS UNLIMITED

Communicate your identity

PROOF
PHASE 1

DIRECTIONAL/WAYFINDING SIGN

045 - TAKE 5

CAR WASH

345 W Duval St

Lake City, FL 32055



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UL File #E225670

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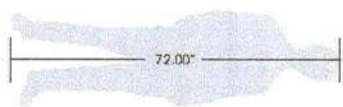
May 09, 2022

REVISIONS:



I
II
III
IV
V



Color Key:
PMS 2191 C
PMS 7691 C
PMS 107 C
PMS 7625 C
Black
White



DETAIL

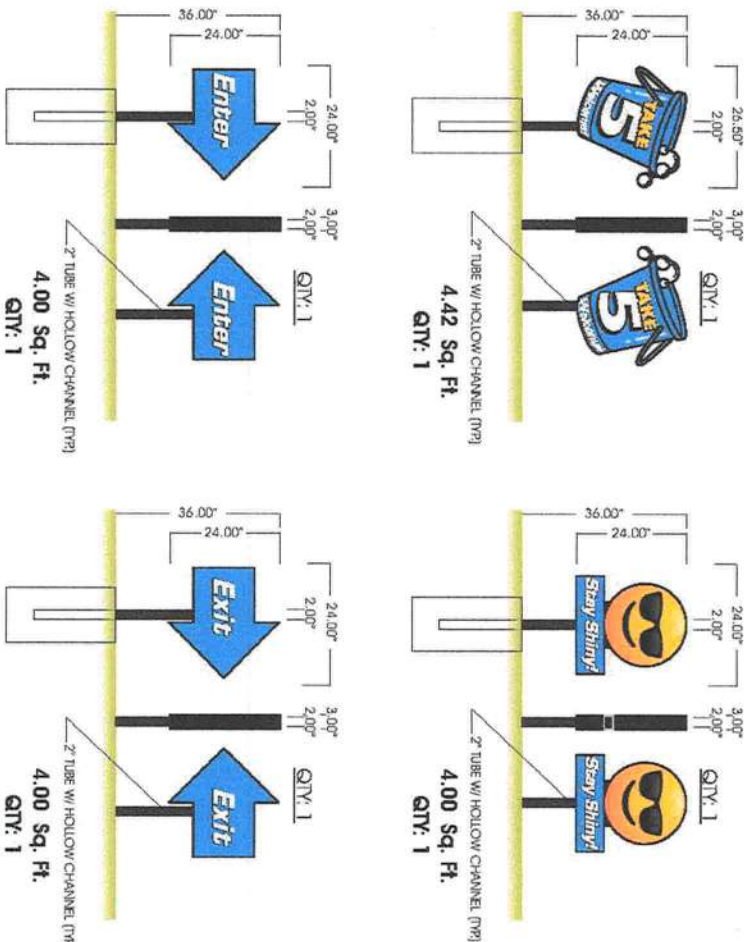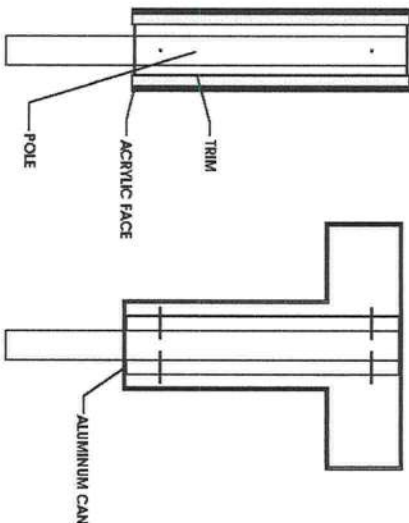

- NOTES:**
- HOLES TO BE DUG BY HAND TO AVOID DAMAGING UNMARKED UNDERGROUND LINES
 - ALL WAYFINDING SIGNS MUST BE REINFORCED WITH CONCRETE

SPECIFICATIONS

NON ILLUMINATED
DOUBLE-SIDED
POST & CHANNEL

Size: As in drawing
Material: Aluminum square tubing
Face Color: As in drawing
Trim: 1"
Trim Color: Black
Return Color: Black
Return Depth: 3"
Face: 1/8" Acrylic
Leg Color: Black
Mounting: Into Earth

Owner/Landlord Approval

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UL File #E225670

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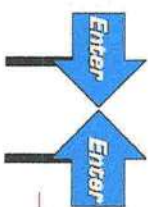
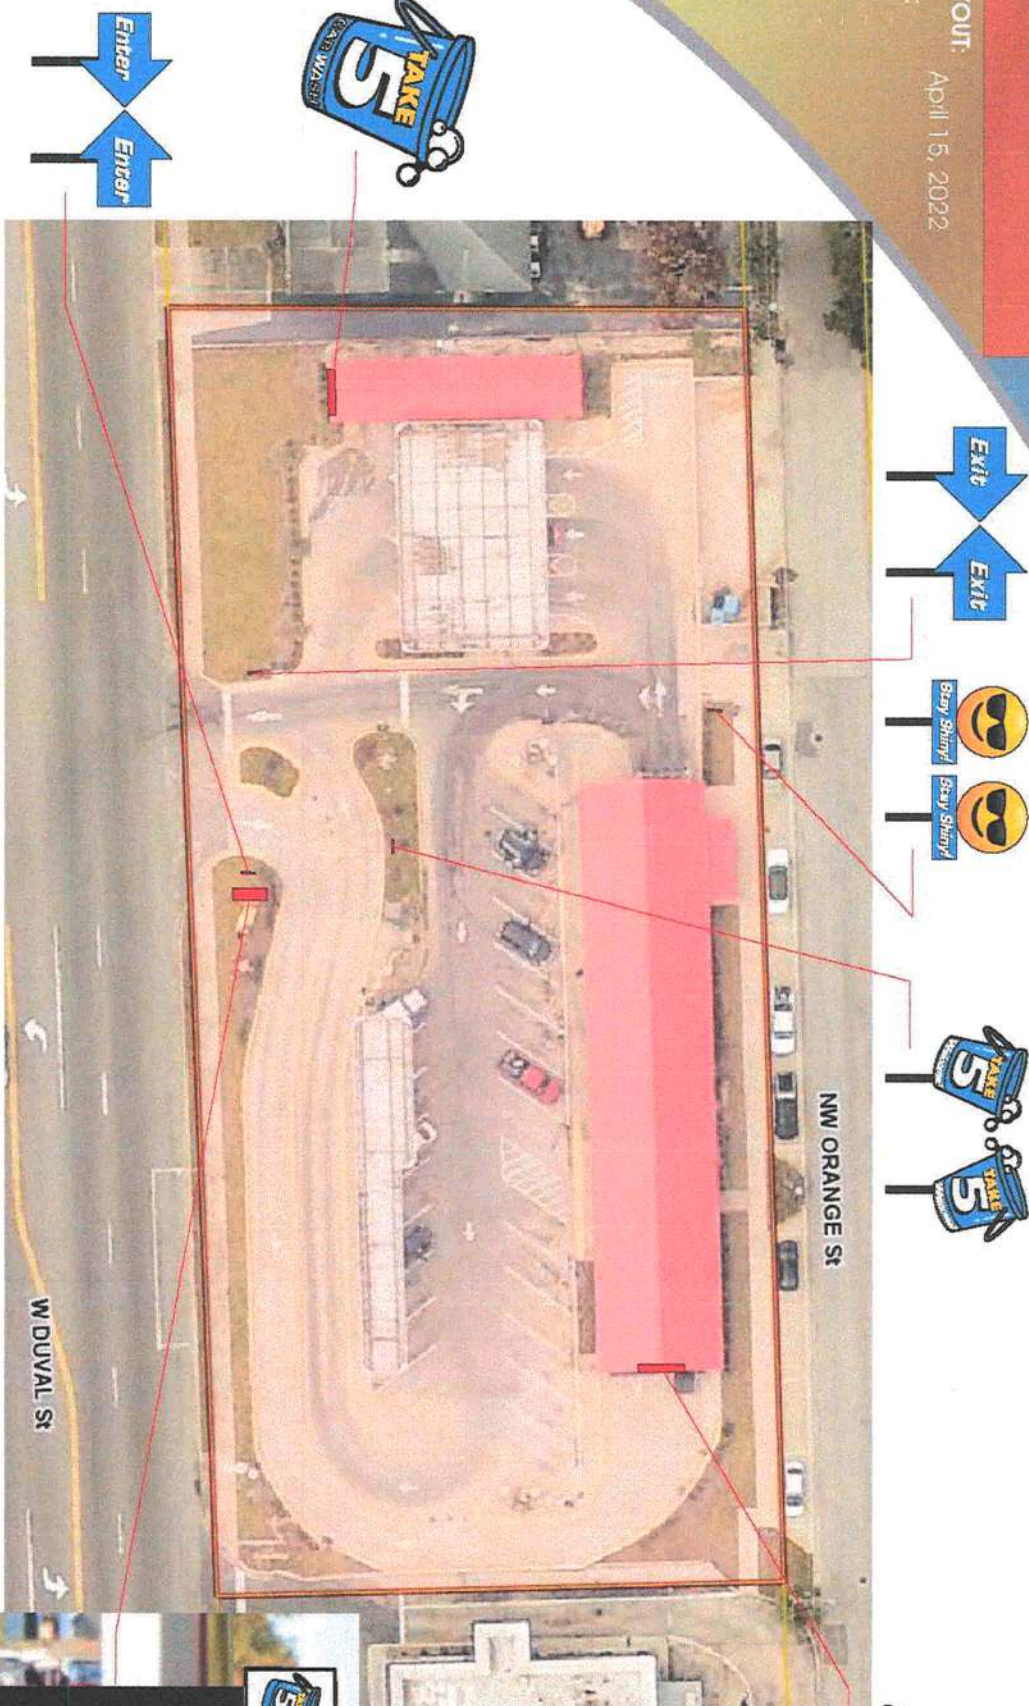
INITIAL LAYOUT:

April 15, 2022

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SITE PLAN PHASE 1



Owner/Landlord Approval _____

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Underwriters Laboratories
Inc.

INITIAL LAYOUT

April 15, 2022

REVISIONS:

I
II
III
IV

Sq. Ft. Signage:

58.47

Signage Allowance:

Zoned CG

1.5 Sq. Ft. Per 1 Ft. Linear Lot

Frontage Aggregate

Maximum Sq. Ft.: 525 Sq. Ft. Aggregate

(350 Ft. Lot Frontage)

Minimum Clearance: 9 Ft. from Grade

PAINTING
BY CLIENT/GC PRIOR TO INSTALLATION


Color Key:

- PMS 2191 C
- PMS 7691 C
- PMS 107 C
- PMS 7625 C
- PMS 7625 C
- Black
- White



EXISTING CONDITIONS

DETAIL

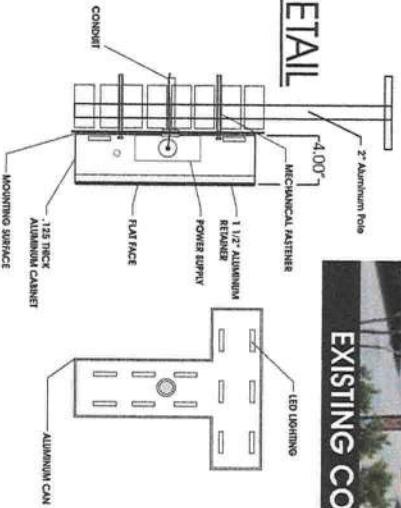

NOTES:

- IF ELECTRICAL LINE/J-BOX IS WITHIN 6' OF ELECTRICAL, CONNECTION TO BE HANDLED BY INSTALLER.
- IF NOT ELECTRICAL HANDLED BY OWNER/GC
- IF ROOF PENETRATIONS ARE NECESSARY, THEY ARE TO BE SEALED BY A ROOFER. THIS IS HANDLED BY THE GC/OWNER
- REMOVAL AND DISPOSAL OF EXISTING WALL SIGNS HANDLED BY GC/OWNER



IMPOSED IMAGERY



200.00" ESTIMATED RACEWAY LENGTH
310.00" ESTIMATED RACEWAY LENGTH



SPECIFICATIONS

ILLUMINATED CHANNEL
LETTERS ON RACEWAYS

- Quantity:** See above
- Size:** As in drawing
- Trim:** 1"
- Trim Color:** Black
- Return Color:** Black
- Face Color:** White
- Face:** 1/8" Acrylic
- Letter Interior:** Gloss White
- Illumination:** LED
- Raceway Size:** 4" x 7" 0.125 Extruded Aluminum
- Raceway Color:** To Match Facade
- Mounting:** Hanging Brackets Flush to Facade

SIGNS UNLIMITED

communicate your identity

Owner/Landlord Approval

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FRONT ELEVATION

045 - TAKE 5

CAR WASH

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Lake City, FL 32055



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INITIAL LAYOUT:

April 15, 2022

REVISIONS:

- I
- II
- III
- IV
- V

Sq. Ft. Signage:

58.47

Signage Allowance:

Zoned CG

1.5 Sq. Ft. Per 1 Ft. Linear Lot

Frontage Aggregate

Maximum Sq. Ft.: 525 Sq. Ft. Aggregate

(350 Ft. Lot Frontage)

Minimum Clearance: 9 Ft. from Grade


Color Key:

- PMS 2191 C
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- PMS 107 C
- PMS 7625 C
- Black
- White



PAINTING
BY CLIENT/GC PRIOR TO INSTALLATION

DETAIL

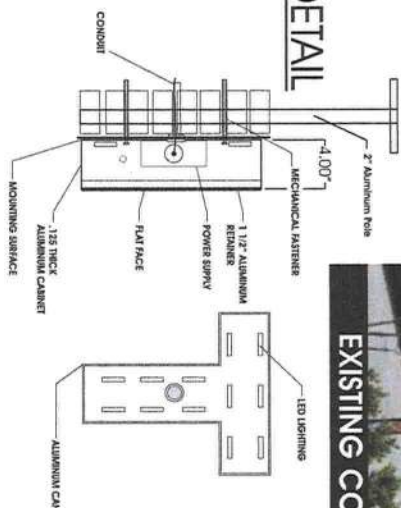

EXISTING CONDITIONS

210.00" Clearance



420.00" EST

336.00" EST

IMPOSED IMAGERY



58.47 Sq. Ft.
QTY: 1

200.00" ESTIMATED RACEWAY LENGTH
310.00" ESTIMATED RACEWAY LENGTH

PROOF

SPECIFICATIONS

ILLUMINATED CHANNEL
LETTERS ON RACEWAYS



Quantity: See above
Size: 1"
As In drawing
Trim: 1"
Trim Color: Black
Return Color: Black
Face Color: Black
White
Face: 1/8" Acrylic
Letter Interior: Gloss White
Illumination: LED

Raceway Size: 4" x 7" 0.125 Extruded Aluminum
Raceway Color: To Match Facade
Mounting: Hanging Bars Flush to Facade

NOTES:
• IF ELECTRICAL LINE/J-BOX IS WITHIN 6' OF ELECTRICAL, CONNECTION TO BE HANDLED BY INSTALLER.
• IF NOT ELECTRICAL HANDLED BY OWNER/GC
• IF ROOF PENETRATIONS ARE NECESSARY, THEY ARE TO BE SEALED BY A ROOFER. THIS IS HANDLED BY THE GC/OWNER
• REMOVAL AND DISPOSAL OF EXISTING WALL SIGNS HANDLED BY GC/OWNER

SIGNS: UNLIMITED

communicate your identity


Owner/Landlord Approval

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CALCULATIONS INCLUDE THE FOLLOWING CONSIDERATIONS:
AS OUTLINED IN THE 2020 FLORIDA BUILDING CODE (7th ED.):
CHAPTER 16-LOADS AND FORCES
CHAPTER 17-SPECIAL INSPECTIONS
CHAPTER 18-SOILS AND FOUNDATIONS
CHAPTER 19-CONCRETE
CHAPTER 20-ALUMINUM
CHAPTER 21-MASONRY
CHAPTER 22-STEEL
CHAPTER 23-WOOD
ALL SIGNS SHALL BE COMPLIANT WITH CURRENT NEC CODES

- NOTES
- 1.) SEE MANUFACTURERS DRAWINGS FOR ADDITIONAL DETAILS AND DIMENSIONS.
 - 2.) SIGN CABINET AND CONNECTION BY SIGNS UNLIMITED.

- * CLIENT - SIGNS UNLIMITED
- * 2020 FLORIDA BUILDING CODE 7TH ED.
- * RISK CATEGORY II
- * 120 MPH WIND SPEED, EXP. C
- * (1) POLE, (1) FOOTING

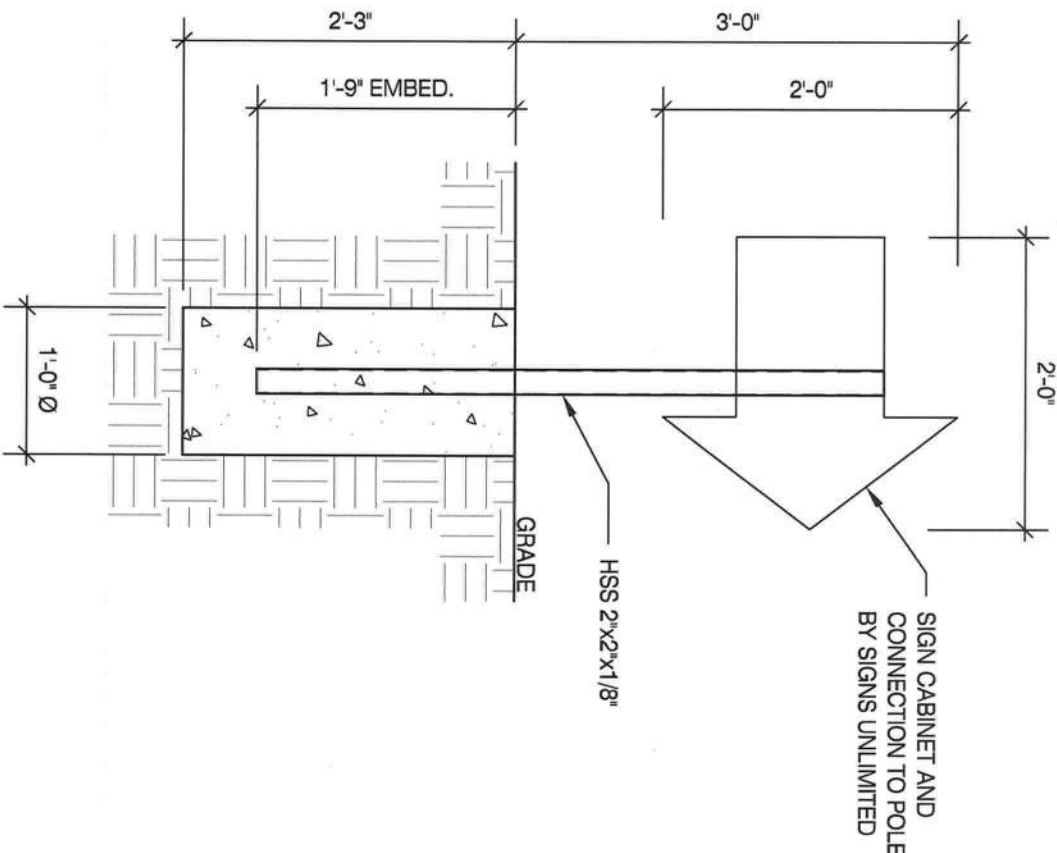

FRONT ELEVATION W/ CAISSON FOUNDATION

SCALE: N.T.S.

1

WIND DATA									
Building Code	2020 Florida Buildi	Importance Factor, I	1.0	Damping Ratio, B	0.005	H/60	0.04 in	H/873	
Wind Load Criteria	ASCE 7-16	Directionality Factor, K _d	0.85	Natural Frequency, n ₁	12.87 Hz				
Wind Speed, V	120 mph	Topography Factor, K _z	1.0	Gust Effect Factor, G	0.85				
Exposure Category	C	Base Pressure, Y ₁₀ /K _z	18.8 psf	ASD Wind Load Factor, γ _w	0.6				
Wind Pressure Override per	0 psf	Notes: (1) Loading values in chart below are based upon average K _z values for each segment. Actual values are calculated on hidden sheet using derived V-M equations. Chart is provided for information purposes only.							
Jurisdiction Requirement		(2) Wind directionality (K _z) factor is 0.95 for Single Pole (Round) segments, instead of 0.85. The C _f value from Fig. 6-21 has been increased by 0.95/0.85 to account for this variation.							

DEFLECTION ANALYSIS		
Deflection Limit	H/60	
Deflection at 0.7" W	0.04 in	
Deflection Ratio	H/873	

GEOMETRY INPUT ⁽¹⁾																		
No. of Poles		Monument:		No														
1		No. of Footings:		1														
Section	Location	Type	Height	Width	Horiz.	Area	Top	Centroid	K _i	C _i	Wind		Support Loads		Footing Loads			
			ft	ft	Offset						sq ft	Elev.	ft	Press.	Trib.	Shear	Moment	Trib.
1	Base	Single Pole (Not Round)	1.00	0.17		0.2	1.0	0.5	0.85	1.65	22.4	Factor	kips	k-ft	Factor	kips	k-ft	
2		Single Pole w/ Cabinet	2.00	2.21		4.4	3.0	2.0	0.85	1.65	22.4	1.0	0.1	0.2	1.0	0.1	0.2	
Overall Height:			3.00 ft															
Summation based upon averages above:																		
			0.1		0.2		0.1		0.2		0.1		0.2		0.1		0.2	
Actual base reactions based upon V-M equations:																		

SUPPORT POLE DESIGN SUMMARY																				
MATERIAL = STEEL																				
Base Elev ft	Section	Axis	Required Strength Values (ASD)						Allowable Strength Values (ASD)						Unity Ratios			Interaction Ratios		Status
			V _r kips	M _r kip-ft	T _r kip-ft	P _r kips	V _a kips	M _a kip-ft	T _a kip-ft	P _a kips	V _u /V _c	M _u /M _c	T _u /T _c	P _u /P _c	P-M	P-M-V-T				
0.00	HSS2X2X1/8	Strong	0.1	0.2	0.0	0.1	7.1	1.3	1.1	12.7	1.5%	14.9%	3.4%	0.4%	15.3%	0.0%	✓			
FOUNDATION DESIGN SUMMARY																				
Type	Diameter	Width	Thickness	Length	Depth	Volume	Reinforcing					Status	Allowable Soil Pressure							
	ft	ft	ft	ft	ft	cy														
✓ Caisson	1.00	--	--	--	2.25	0.07						OK	300 psi/ft							
Vertical Slab																				
Spread																				

MBI COMPANIES INC.
299 N. WEISGARBER RD.
KNOXVILLE, TN 37919

PHONE 865.584.0999
SIGN-ENGINEER.COM

PROJECT:
345 West Duval Street, Lake City, Florida, 32055

DRAWING TITLE:

TAKE 5

DRAWN BY: DEW
CHECKED BY: TSM
COMM. NO. 220149.164

DATE: 09/27/22


REV # DATE DRAWN BY

DRAWING NO. DWG. 5



GROUND SIGN DESIGN SPECIFICATIONS:

1. REFER TO SIGN COMPANY'S DRAWINGS FOR MORE DETAILS. ALL DESIGNS, DETAILING FABRICATION AND CONSTRUCTION SHALL CONFORM TO:
2020 FLORIDA BUILDING CODE 7TH ED.
- ACI
AISC
AMERICAN WELDING SOCIETY
LOCAL BUILDING CODES & ORDINANCES
2. CONCRETE: 2500 PSI @ 28 DAYS
3. STD. STEEL PIPE SECTION: ASTM A53 GRADE B (Fy=35 KSI), U.N.O.
4. STEEL PIPE SECTION (> 20" Ø): ASTM A252 GRADE 3 (Fy=42 KSI MIN), U.N.O.
5. HSS ROUND SECTION: ASTM A500 GRADE B (Fy=42 KSI) U.N.O.
6. HSS SQUARE/RECTANGULAR SECTION: ASTM A500 GRADE B (Fy=46 KSI)
7. W SHAPES: ASTM A992 (Fy = 50 KSI)
8. ANCHOR BOLTS: ASTM F1554 GRADE 36 U.N.O. (ALTERNATES GRADE 55 & 105)
9. CONNECTION BOLTS: ASTM A325
10. THREADED RODS: ASTM A193 GRADE B7
11. STEEL ANGLES, CHANNELS, STRUCTURAL SHAPES & PLATES ASTM A36
12. REINFORCING: GRADE 60 ASTM A615
13. PROVIDE A MINIMUM OF THREE INCHES OF CONCRETE COVER OVER EMBEDDED STEEL.
14. THE CONTRACTOR (INSTALLER) IS RESPONSIBLE FOR THE MEANS & METHODS OF CONSTRUCTION IN REGARDS TO JOBSITE SAFETY.
15. NO FIELD HEATING FOR BENDING OR CUTTING OF STEEL SHALL BE ALLOWED WITHOUT THE ENGINEERS APPROVAL.
16. WELDING ELECTRODES: E70XX
17. ALLOWABLE SOIL BEARING PRESSURE ASSUMED: 2000 PSF
18. ASSUMED HORIZONTAL (PASSIVE PRESSURE) ASSUMED AT 150 PSF/FT OF DEPTH. ISOLATED LATERAL BEARING FOUNDATIONS FOR SIGNS NOT ADVERSELY AFFECTED A 1/2" MOTION AT THE GROUND SURFACE DUE TO SHORT TERM LATERAL LOADS SHALL BE PERMITTED TO BE DESIGNED USING TWO TIMES THE TABULATED CODE VALUES.
19. ALL FOOTINGS SHALL BEAR ON FIRM UNDISTURBED RESIDUAL SOIL AND/OR ENGINEERED EARTH.
20. FILL COMPACTED TO 98% OF ITS MAXIMUM DRY DENSITY AS PER ASTM D 698-70 (STANDARD PROCTOR) UNLESS NOTED OTHERWISE. THE SOIL BEARING CAPACITY IS TO BE VERIFIED BY A GEOTECHNICAL ENGINEER PRIOR TO CONSTRUCTION. IF ALLOWABLE BEARING AND/OR LATERAL PRESSURE IS LESS THAN THE ABOVE ASSUMED AND/OR CALCULATED PRESSURES, THE ENGINEER SHOULD BE CONTACTED FOR RE-EVALUATION.
21. EXCAVATION SHALL BE FREE OF LOOSE SOIL BEFORE POURING CONCRETE.
22. WELDERS SHALL BE CERTIFIED FOR THE TYPE OF WELDING.
23. ADEQUATELY BRACE POLES) UNTIL CONCRETE HAS SET UP FOR 14 DAYS.
24. GROUT UNDER BASE PLATES WITH NON-SHRINK GROUT.
25. THIS ENGINEER DOES NOT WARRANT THE ACCURACY OF DIMENSIONS FURNISHED BY OTHERS.
26. ALL EXPOSED STEEL SHALL BE PAINTED WITH AN ENAMEL PAINT TO INHIBIT CORROSION.
27. THIS DESIGN IS FOR THE INDICATED ADDRESS ONLY, AND SHOULD NOT BE USED AT OTHER LOCATIONS WITHOUT WRITTEN PERMISSION OF THE ENGINEER.
28. DESIGN OF DETAILS AND STRUCTURAL MEMBERS NOT SHOWN, BY OTHERS.

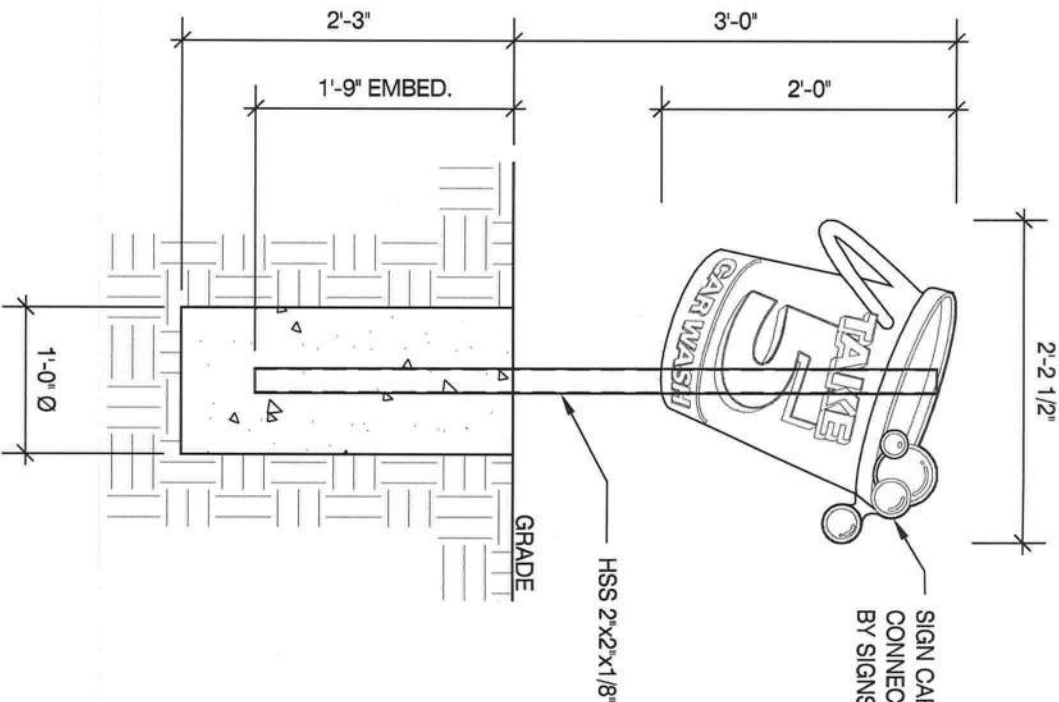

FRONT ELEVATION W/ CAISSON FOUNDATION
SCALE: N.T.S.

CALCULATIONS INCLUDE THE FOLLOWING CONSIDERATIONS:
AS OUTLINED IN THE 2020 FLORIDA BUILDING CODE (7th ED.):
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CHAPTER 21-MASONRY
CHAPTER 22-STEEL
CHAPTER 23-WOOD
ALL SIGNS SHALL BE COMPLIANT WITH CURRENT NEC CODES

- NOTES
- 1.) SEE MANUFACTURERS DRAWINGS FOR ADDITIONAL DETAILS AND DIMENSIONS.
- 2.) SIGN CABINET AND CONNECTION BY SIGNS UNLIMITED.

- * CLIENT - SIGNS UNLIMITED
* 2020 FLORIDA BUILDING CODE 7TH ED.
* RISK CATEGORY II
* 120 MPH WIND SPEED, EXP. C
* (1) POLE, (1) FOOTING

WIND DATA						DEFLECTION ANALYSIS	
Building Code	2020 Florida Build	Importance Factor, I	1.0	Damping Ratio, β	0.005	Deflection Limit	H/60
Wind Load Criteria	ASCE 7-16	Directionality Factor, K_d ⁽¹⁾	0.85	Natural Frequency, n	12.87 Hz	Deflection at 0.7" W	0.04 in
Wind Speed, V	120 mph	Topography Factor, K_z	1.0	Gust Effect Factor, G	0.85	Deflection Ratio	H/873
Exposure Category	C	Base Pressure, V_{10}/K_z	18.8 psf	ASD Wind Load Factor, V ⁽²⁾	0.6		
Wind Pressure Override per Jurisdiction Requirement	0 psf						

Notes: (1) Loading values in chart below are based upon average K_z values for each segment. Actual values are calculated on hidden sheet using derived V-M equations. Chart is provided for information purposes only.

GEOMETRY INPUT (1)									
No. of Poles	1	No. of Footings	1	Monument:	No				
Section	location	Type	Height	Width	Offset	Area	Elev.	Centroid	K_z
1	Base	Single Pole (Not Round)	1.00	0.17		0.2	1.0	0.5	0.85
2		Single Pole w/ Cabinet	2.00	2.21		4.4	3.0	2.0	0.85
			Overall Height:		3.00 ft	Summation based upon overages above:			
						0.1	0.2	0.1	0.2

SUPPORT POLE DESIGN SUMMARY																	
MATERIAL = STEEL																	
Base Elev <i>f</i>	Section	Axis	Required Strength Values (ASD)					Allowable Strength Values (ASD)					Unity Ratios		Interaction Ratios	Status	
			<i>V_r</i>	<i>M_r</i>	<i>T_r</i>	<i>P_r</i>	<i>V_a</i>	<i>M_a</i>	<i>T_a</i>	<i>P_a</i>	<i>V/V_r</i>	<i>M/M_r</i>	<i>T/T_r</i>	<i>P/P_r</i>			
0.00	HSS2X2X1/8	Strong	0.1	0.2	0.0	0.1	7.1	1.3	1.1	12.7	1.5%	14.9%	3.9%	0.4%	15.3%	0.0%	✓
FOUNDATION DESIGN SUMMARY																	
Type	Diameter	Width	Thickness	Length	Depth	Volume	Reinforcing					Status	Allowable Soil Pressure				
	<i>f</i>	<i>f</i>	<i>f</i>	<i>f</i>	<i>f</i>	<i>cy</i>											
✓ Caisson	1.00	--	--	--	2.25	0.07						OK	300 psi/ft				
Vertical Slab																	
Spread																	

MBI

MBI COMPANIES INC.
299 N. WEISGARBER RD.
KNOXVILLE, TN 37919
PHONE: 865.584.0999
SIGN-ENGINEER.COM

PROJECT:
345 West Duval Street, Lake City, Florida, 32055

DRAWN BY:
DEW

CHECKED BY:
TSM

COMM. NO.
2201 49.164

DATE:
09/27/22

DRAWING NO.
DWG.

CORP. LLC. # F02000002650
BUS. LLC. # AA26000828
ENG. C.O.A. # 29794

REV #
DATE

DRAWN BY


3

DARREN S. ANTLE
P.E. LIC # 76913
11/8/23

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AS OUTLINED IN THE 2020 FLORIDA BUILDING CODE (7TH ED.) :
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CHAPTER 23-WOOD
ALL SIGNS SHALL BE COMPLAINT WITH CURRENT NEC CODES

- NOTES
- 1.) SEE MANUFACTURERS DRAWINGS FOR
ADDITIONAL DETAILS AND DIMENSIONS.
- 2.) SIGN CABINET AND CONNECTION
BY SIGNS UNLIMITED.

- * CLIENT - SIGNS UNLIMITED
* 2020 FLORIDA BUILDING CODE 7TH ED.
* RISK CATEGORY II
* 120 MPH WIND SPEED, EXP. C
* (1) POLE, (1) FOOTING

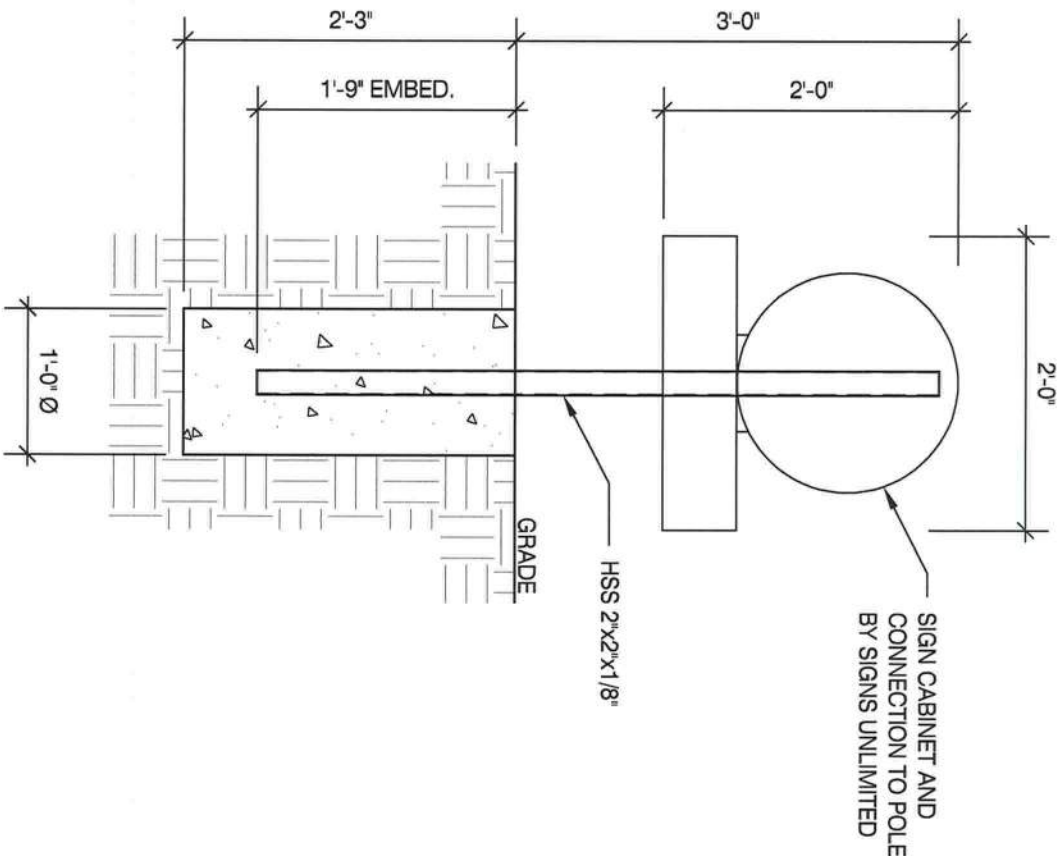

WIND DATA										DEFLECTION ANALYSIS		
Building Code	2020 Florida Building	Importance Factor, I	1.0	Damping Ratio, β	0.005	H/60	Deflection Limit Deflection at 0.7" W Deflection Ratio H/873					
Wind Load Criteria	ASCE 7-16	Directionality Factor, K_d ⁽¹⁾	0.85	Natural Frequency, f_n	12.87 Hz	0.04						
Wind Speed, V	120 mph	Topography Factor, K_z	1.0	Gust Effect Factor, G	0.85							
Exposure Category	C	Base Pressure, V_{10}/f_n	18.8 psf	ASD Wind Load Factor, γ ⁽³⁾	0.6							
Wind Pressure Override per	0 psf											
Linsdetection Requirement												
Notes: (1) Loading values in chart below are based upon average k_z values for each segment. Actual values are calculated on hidden sheet using derived V-M equations. Chart is provided for information purposes only.												

GEOMETRY INPUT ⁽¹⁾												
No. of Poles		1		No. of Footings		1		Monument:		No		
Section	Location	Type	Height	Width	Horiz. Offset	Area	Top Elev.	Centroid	K _z	C _g		
			ft	ft	ft	sq ft	ft	ft				
1	Base	Single Pole (Not Round)	1.00	0.17		0.2	1.0	0.5	0.85	1.65	22.4	psf
2		Single Pole w/ cabinet	2.00	2.21		4.4	3.0	2.0	0.85	1.65	22.4	psf
Overall Height:			3.00 ft									
Summation based upon averages above:												
0.1 0.1 0.2 0.1 0.2 0.2												
Actual base reactions based upon V-M equations:												

from fig. 6-21 has been increased by 0.5/0.25 to account for this variation.

(3) Wind pressures listed below have already been multiplied by the ASD Wind Load Factor, V.

SUPPORT POLE DESIGN SUMMARY									
		MATERIAL =		STEEL					
Base Elev	Section	Axis	Required Strength Values (ASD)			Allowable Strength Values (ASD)			Unity Ratios
f_t		V_r	M_r	T_r	P_r	V_r	M_r	T_r	P_r
0.00	HSS2X2X1/8	Kips	Kip-ft	Kip-ft	Kips	Kips	Kip-ft	Kip-ft	Kips
		Strong	0.1	0.2	0.0	0.1	7.1	1.3	1.1
FOUNDATION DESIGN SUMMARY									
Type	Diameter	Width	Thickness	Length	Depth	Volume	Reinforcing		
f_t	f_t	f_t	f_t	f_t	f_t	cy			
✓ Caisson	1.00	--	--	2.25	0.07				
Vertical Slab									
Spread									

MBI

MBI COMPANIES, INC.
299 N. WEISGAUBER RD.
KNOXVILLE, TN 37919
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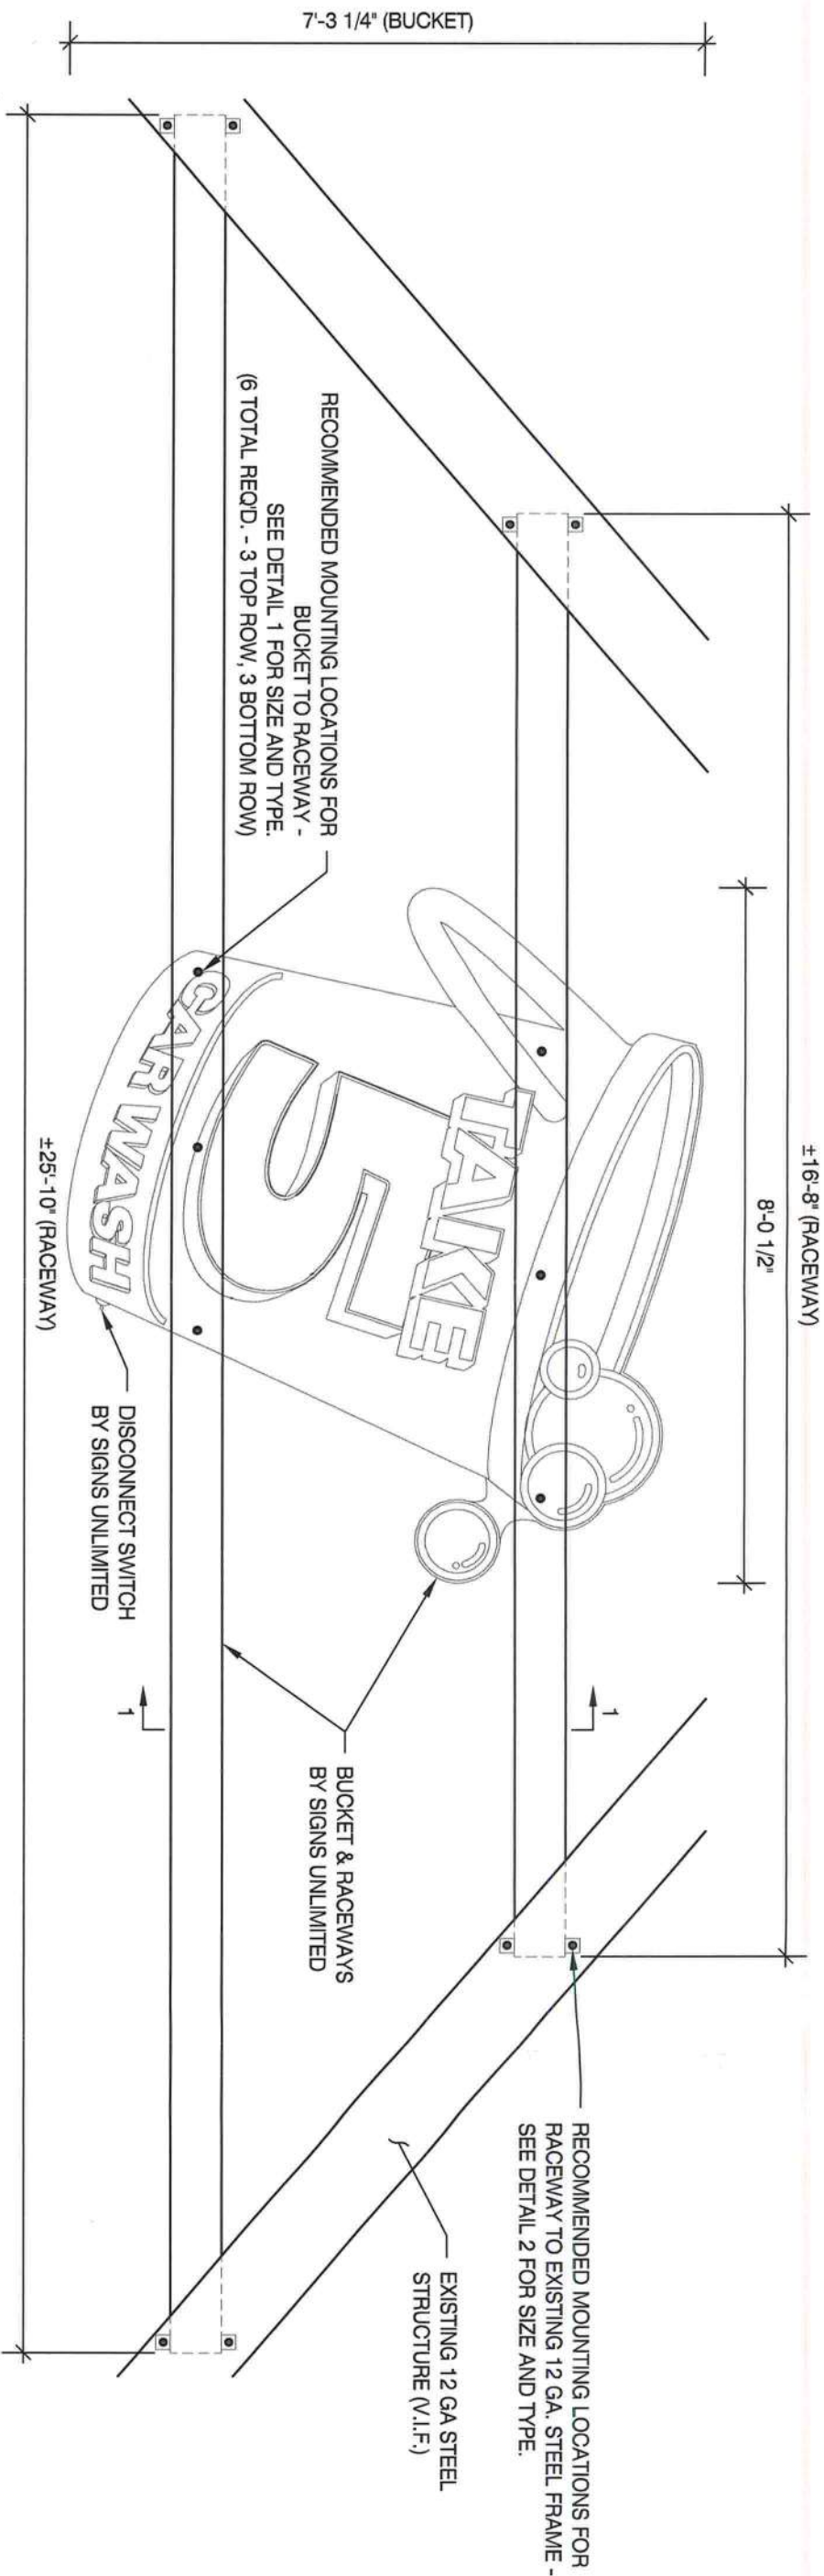
PROJECT:
345 West Duval Street, Lake City, Florida, 32055
DRAWING TITLE:
TAKE 5

DRAWN BY:
DEW
CHECKED BY:
TSM
COMM. NO.
220149.164
DATE:
09/27/22

REV #
DATE
DRAWN BY

DRAWING NO.
DWG.
4

DARREN S. ANTLE
P.E. LIC # 76813
9/18/23




THE SCOPE OF THIS ENGINEERING IS LIMITED TO THE ATTACHMENT OF THE SIGN TO RACEWAY AND RACEWAY TO THE EXISTING STRUCTURE. ALL OTHER ASPECTS ARE EXCLUDED FROM THE SCOPE OF THIS ENGINEERING. BUILDING ENGINEER TO VERIFY ADEQUACY OF THE EXISTING STRUCTURE TO RESIST ADDITIONAL LOADS SHOWN. THIS ENGINEER NOT RESPONSIBLE FOR EXISTING STRUCTURE.

87 1/4" CUSTOM LOGO W/ RACEWAYS - FRONT ELEVATION
SCALE: N.T.S. A

CALCULATIONS INCLUDE THE FOLLOWING CONSIDERATIONS AS OUTLINED IN THE 2020 FLORIDA BUILDING CODE (7th ED.):
CHAPTER 16-LOADS AND FORCES
CHAPTER 17-SPECIAL INSPECTIONS
CHAPTER 18-SOILS AND FOUNDATIONS
CHAPTER 19-CONCRETE
CHAPTER 20-ALUMINUM
CHAPTER 21-MASONRY
CHAPTER 22-STEEL
CHAPTER 23-WOOD
ALL SIGNS SHALL BE COMPLIANT WITH CURRENT NEC CODES

NOTES
1.) SEE MANUFACTURERS DRAWINGS FOR ADDITIONAL DETAILS AND DIMENSIONS.

* CLIENT - SIGNS UNLIMITED
* 2020 FLORIDA BUILDING CODE 7TH ED.
* RISK CATEGORY II
* 120 MPH WIND SPEED, EXP. C

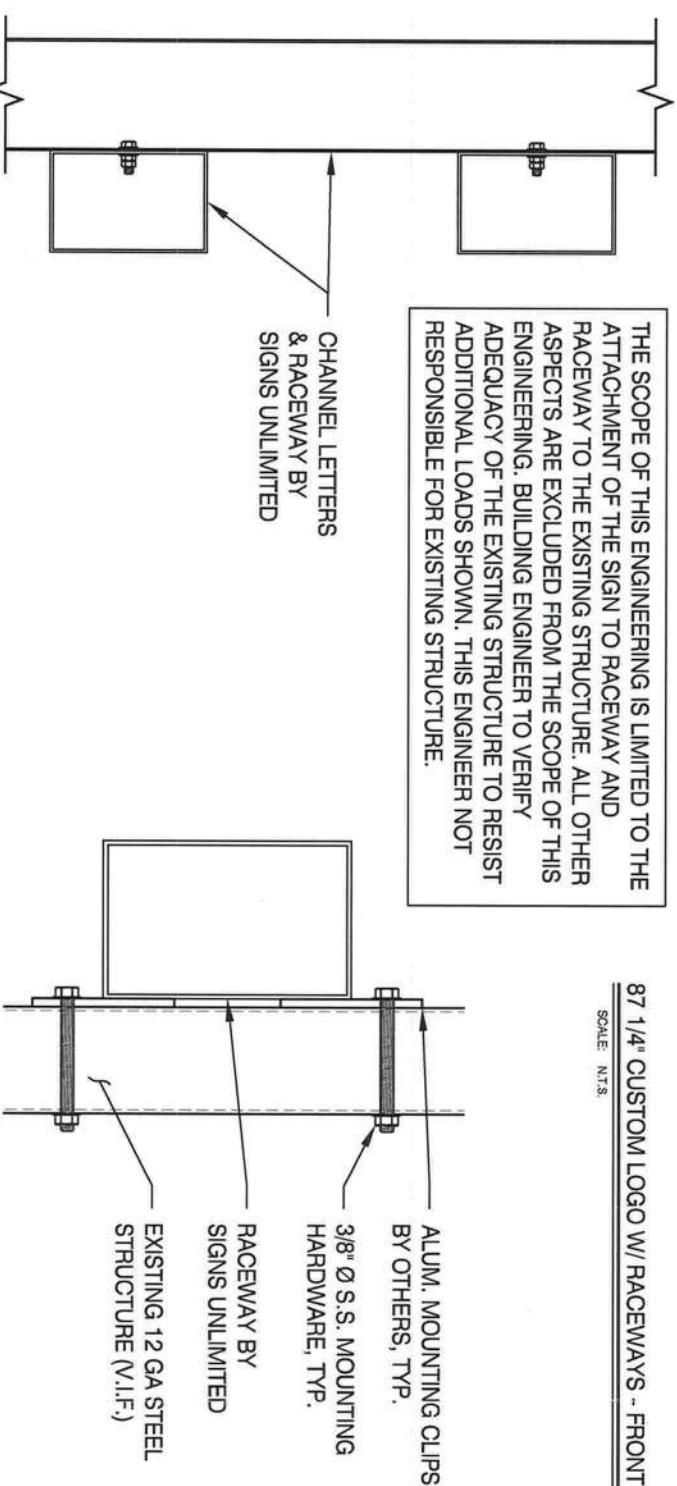

3/8" Ø S.S. BOLT W/ WASHER & NUT (6 REQD.)
SCALE: N.T.S. 1 (DUAL RACEWAY)

3/8" Ø S.S. THRU-BOLT W/ WASHER & NUT (4 REQD.)
SCALE: N.T.S. 2

MBI

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KNOXVILLE, TN 37919
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PROJECT:
345 West Duval Street, Lake City, Florida, 32055
DRAWING TITLE:
TAKE 5


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CHECKED BY: TSM
COMM. NO. 220149.164
CORP. L.I.C. # F02000002650
BUS. L.I.C. # AA26000828
ENG. C.O.A. # 29794

DATE: 09/27/22

REV # DATE DRAWN BY

DRAWING NO.
DWG. 1

SETH
DARREN S. ANTE
P.E. LIC # 76813
No. 76813
STATE OF
FLORIDA
9/18/22

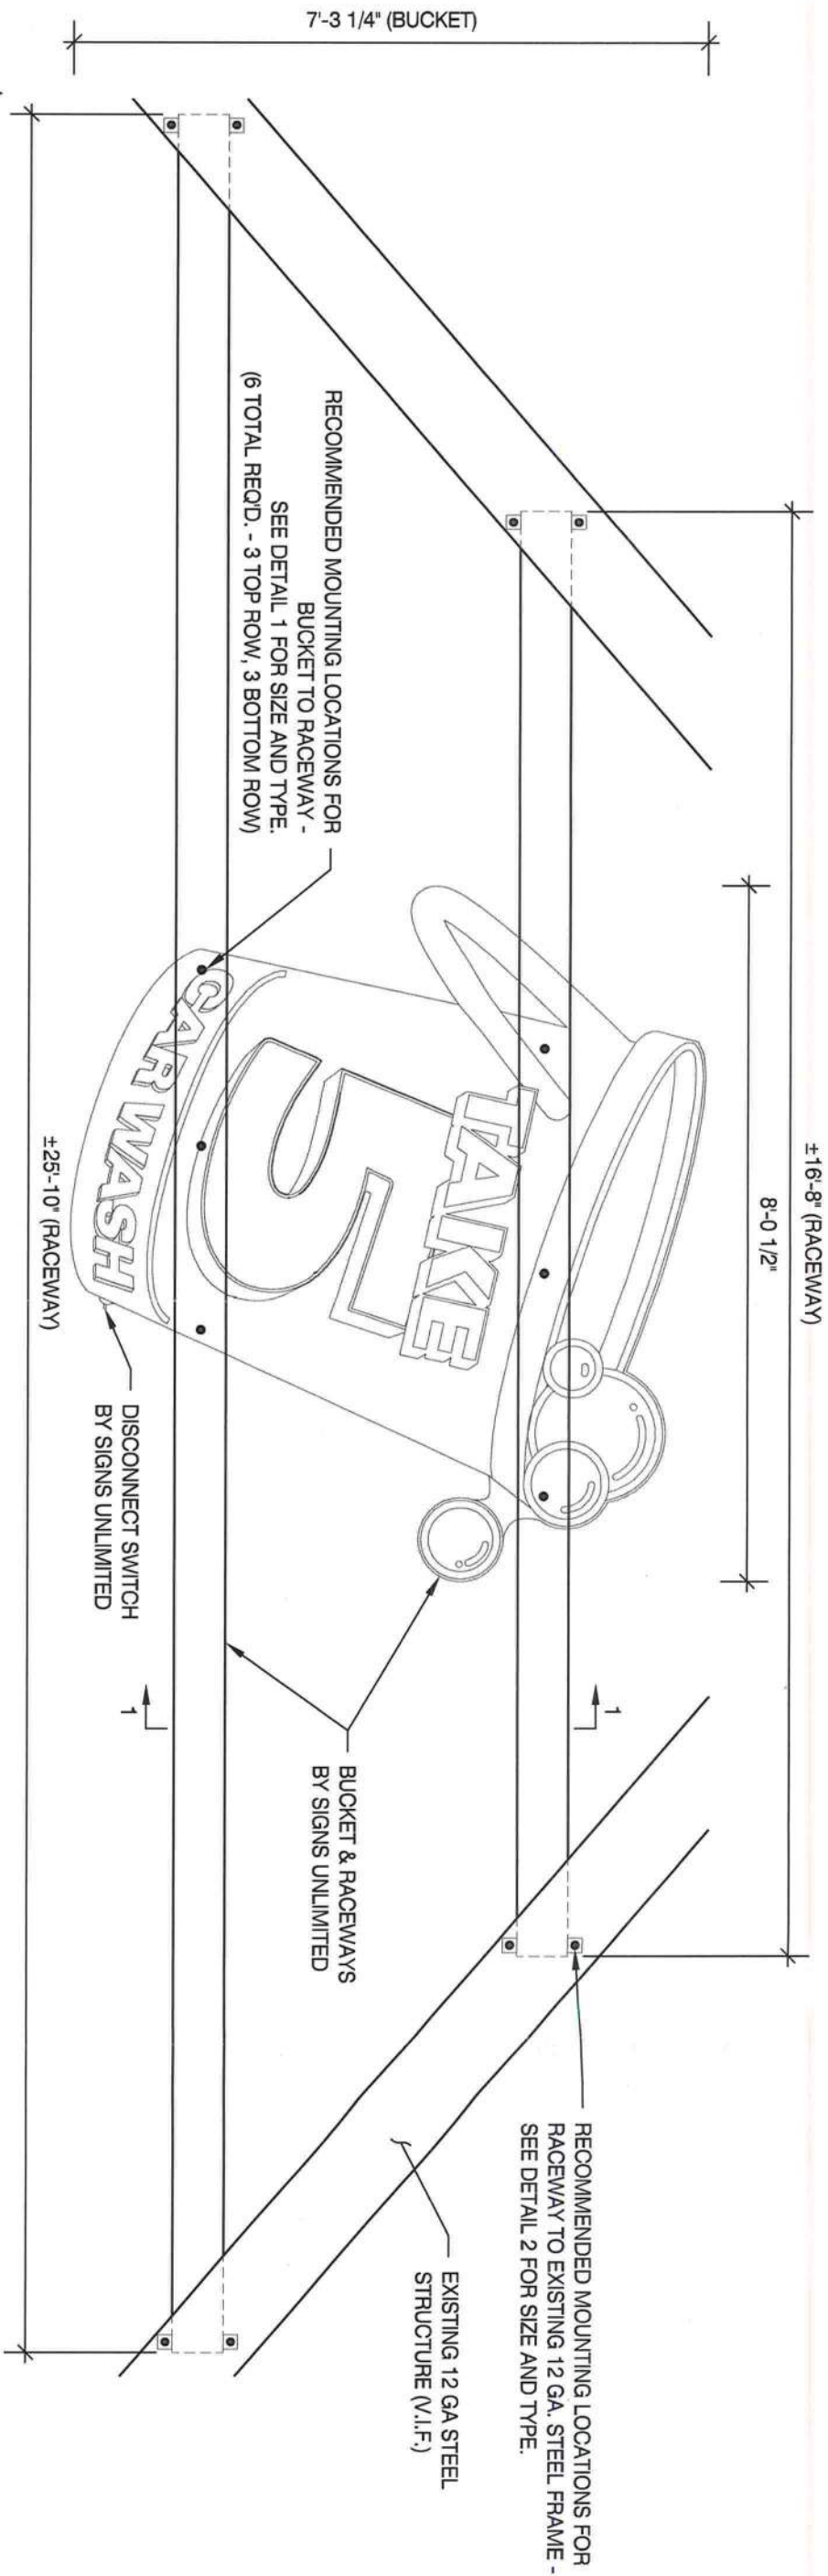

THE SCOPE OF THIS ENGINEERING IS LIMITED TO THE ATTACHMENT OF THE SIGN TO RACEWAY AND RACEWAY TO THE EXISTING STRUCTURE. ALL OTHER ASPECTS ARE EXCLUDED FROM THE SCOPE OF THIS ENGINEERING. BUILDING ENGINEER TO VERIFY ADEQUACY OF THE EXISTING STRUCTURE TO RESIST ADDITIONAL LOADS SHOWN. THIS ENGINEER NOT RESPONSIBLE FOR EXISTING STRUCTURE.

87 1/4" CUSTOM LOGO W/ RACEWAYS - FRONT ELEVATION
SCALE: N.T.S. A


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* RISK CATEGORY II
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3/8" Ø S.S. BOLT W/ WASHER & NUT (6 REQ'D.)
SCALE: N.T.S. 1

3/8" Ø S.S. THRU-BOLT W/ WASHER & NUT (4 REQ'D.)
SCALE: N.T.S. 2



SCALE: N.T.S.

SCALE: N.T.S.
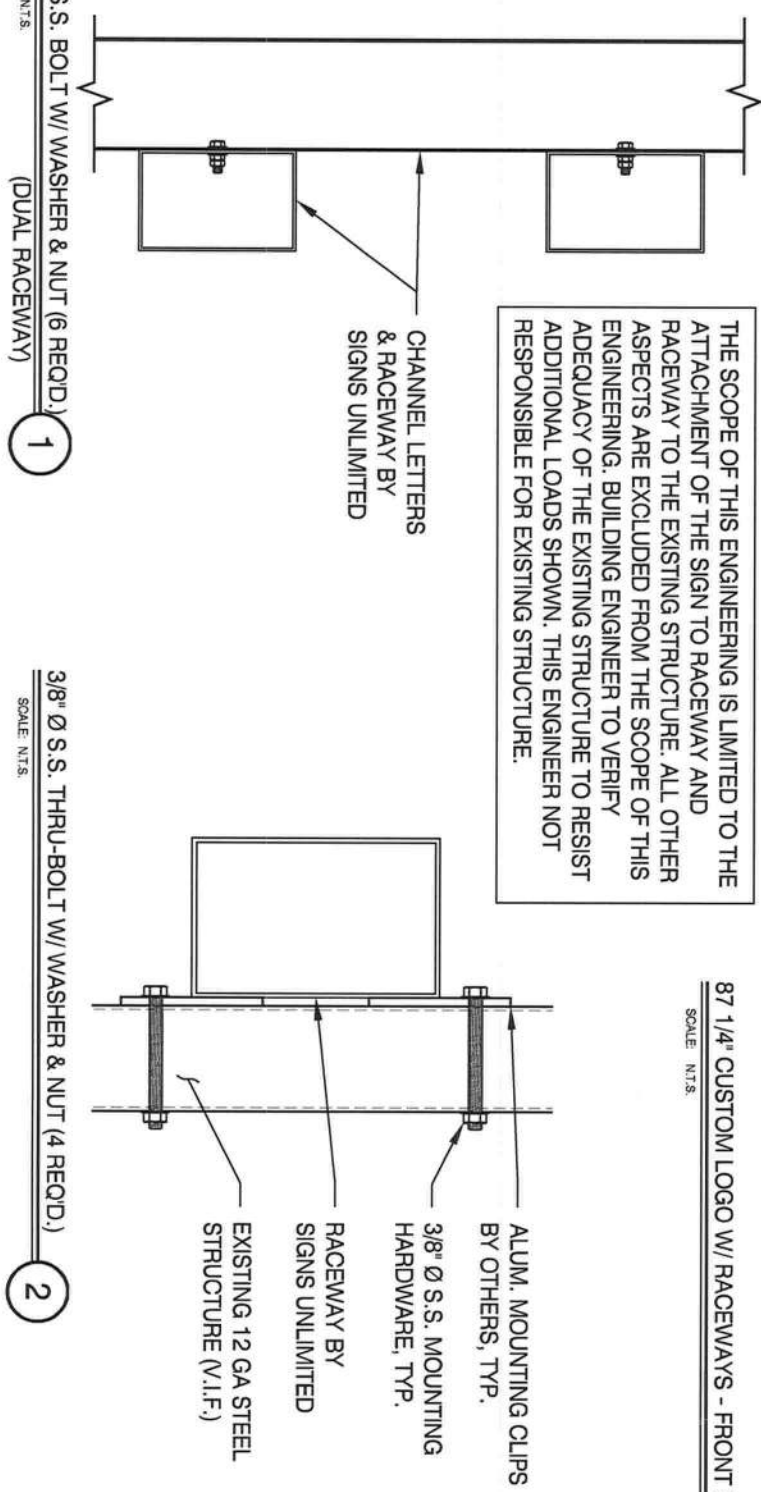
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COMM. NO. 220149.164

CORP. LIC. # F02000002650
BUS. LIC. # AA26000828
ENG. C.O.A. # 28794

DATE: 09/27/22

REV # DATE DRAWN BY

DRAWING NO.
DWG. 1

STATE OF FLORIDA
Professional Engineer
No. 76813
DARREN S. ANTLE
P.E. LIC # 76813
9/18/23