

AREA SUMMARY

CONDITIONED	1955 SF
GARAGE	544 SF
ENTRY	54 SF
ROOF	2553 SF

SWS = Indicates a shearwall segment location referring to the labeled section of wall lying between the adjacent window / door openings in either direction. The shearwall areas have a height/width aspect ratio of 3-1/2 : 1 or wider.

FLOOR PLAN

SCALE: 1/4 IN. = 1 FT.

ATTIC VENTILATION

Enclosed attics and enclosed rafter spaces formed where ceilings are applied directly to the underside of roof rafters shall have cross ventilation for each separate space by ventilating openings protected against the entrance of rain. Ventilating openings shall be provided with corrosion-resistant wire mesh, with a 1/8 inch (3.2 mm) minimum to 1/2 inch (6.4 mm) maximum openings.

The total net free ventilating area shall not be less than 1 to 150 of the area of the space ventilated except that the total area is permitted to be reduced to 1 to 300, provided at least 50 percent and not more than 80 percent of the required ventilating area is provided by ventilators located in the upper portion of the space to be ventilated at least 3 feet (914 mm) above eave or cornice vents with the balance of the required ventilation provided by eave or cornice vents.

Index to Sheets


SHEET A-1	SITE PLAN + FLOOR PLAN + ELEVATIONS
SHEET A-2	ELEVATIONS + GEN. NOTES
SHEET A-3	FOUNDATION + SECTIONS
SHEET A-4	ELECTRICAL
SHEET S-1	WIND ENGINEERING

Model Home

STONEHENGE PHASE 2 - LOT 17


NOTES

- 1.) Lot dimensions per plat of subdivision.
- 2.) Building location per contractor.
- 3.) It shall be the contractor's responsibility to verify all required building setbacks.

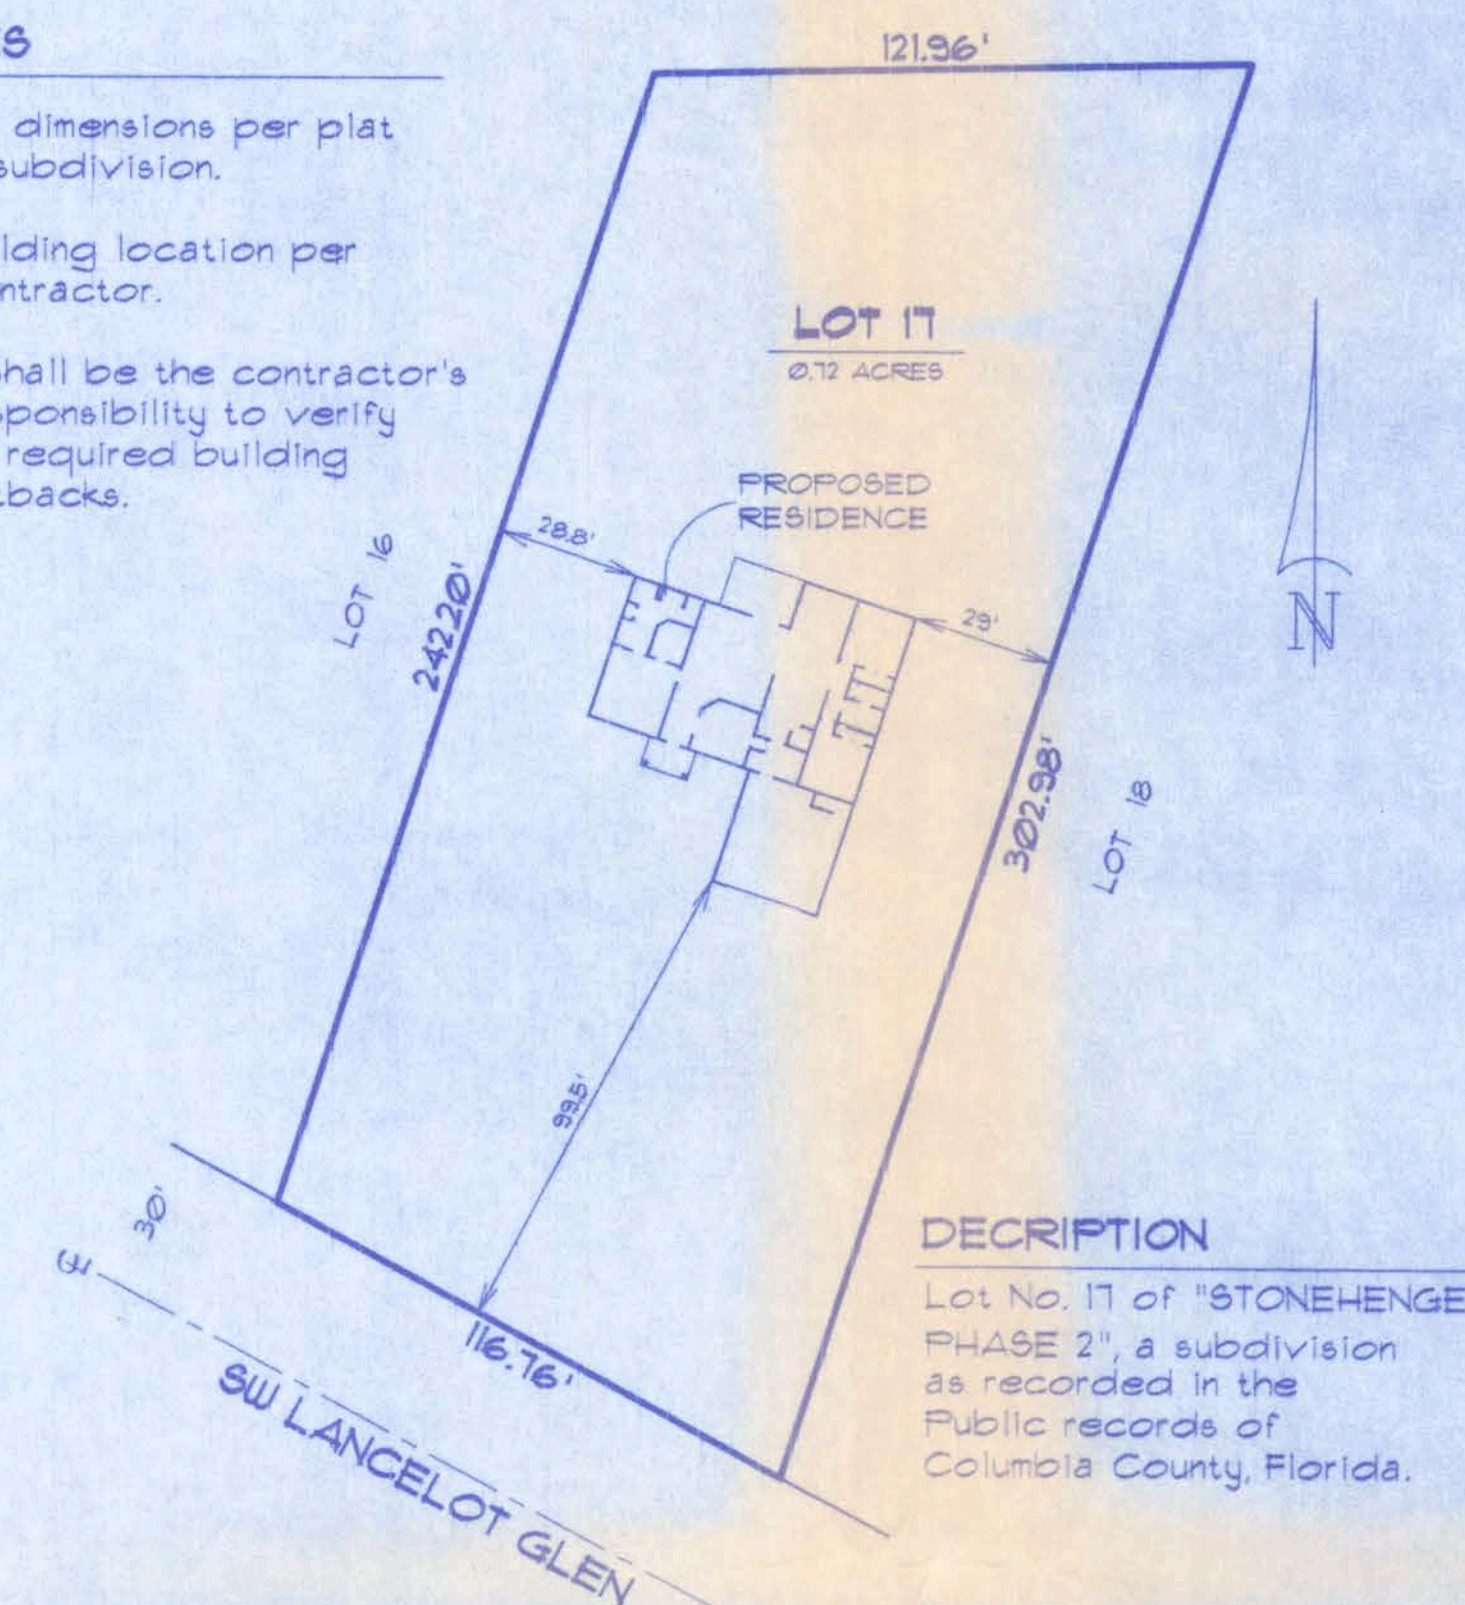

SITE PLAN

SCALE: 1 IN. = 40 FT.

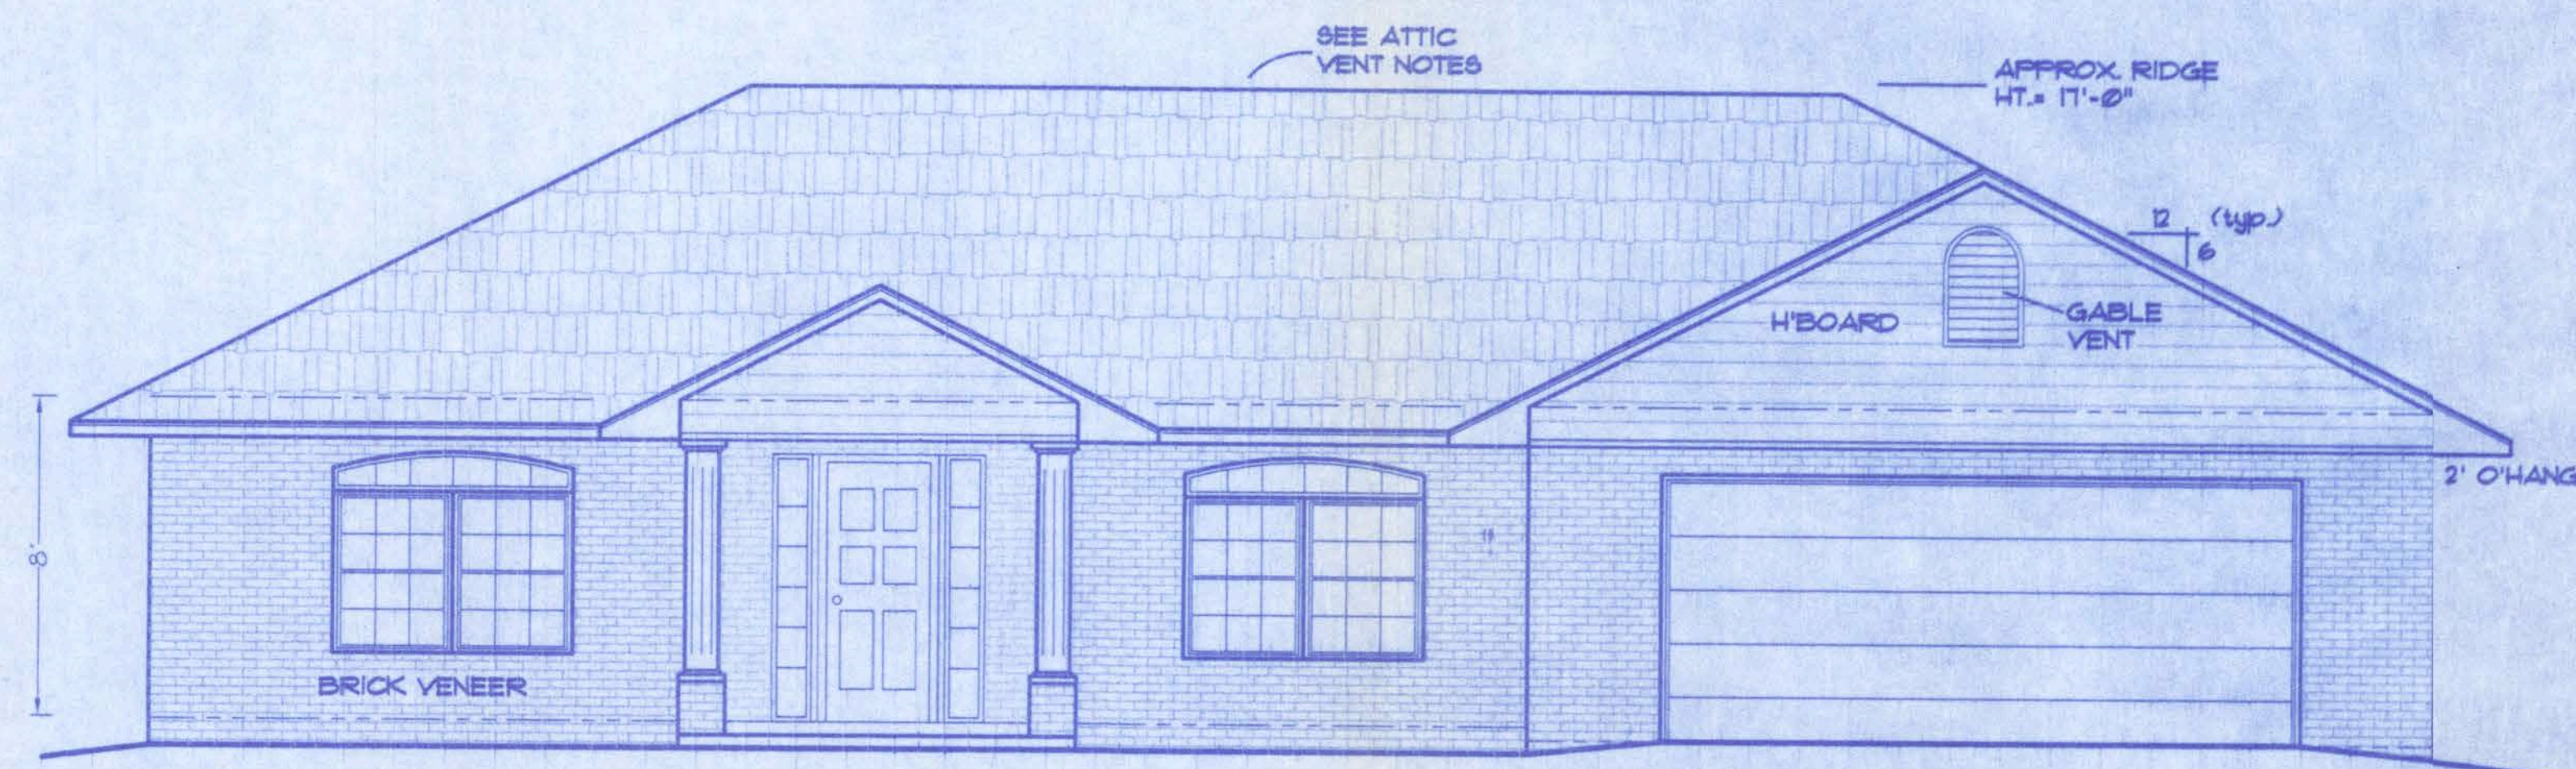

FRONT ELEVATION

SCALE: 1/4 IN. = 1 FT.

WINDLOAD ENGINEER: Mark Disosway, PE No.53915, POB 868, Lake City, FL 32056, 386-754-5419

CERTIFICATION: These plans and "Windload Engineering", Sheet S-1, attached, comply with Florida Building Code Residential 2004, Section R301.2.1 to the best of my knowledge.


LIMITATION: This design is valid for one building, at specified location, permitted within 90 days of signature date. In case of conflict, structural requirements, scope of work, and builder responsibilities on sheet S-1 control.

Location: LOT 17 - STONEHENGE PH 2 Job No.: 602072

A-1


FILE: OG-011	JONATHAN PERRY CONST.	SHEET: 1 OF 4
DATE: 2-6-06		CAD FILE: OG011
DRAWN: T A D		REV: 12-1-04
CHECK: T A D		REV: 12-1-04

PREPARED BY:
TIM DELBENE
Drafting + Technical Services
192 SW Sagewood Cir. Lake City, FL 32024
Phone (386) 755-5891

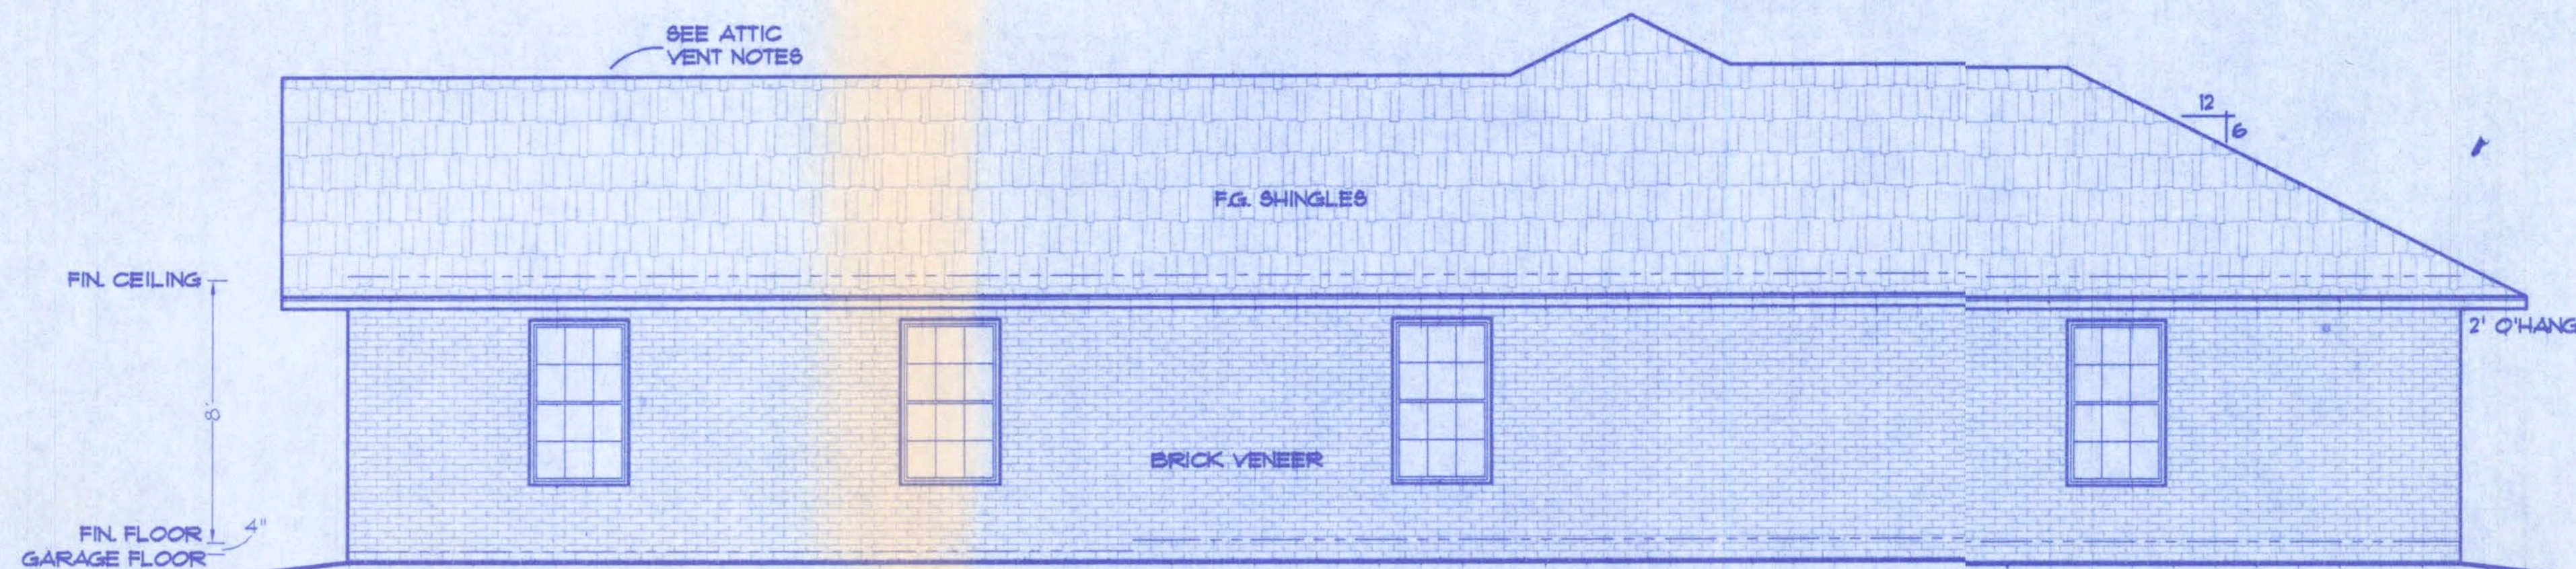


RIGHT ELEVATION

SCALE: 1/4 IN. = 1 FT.

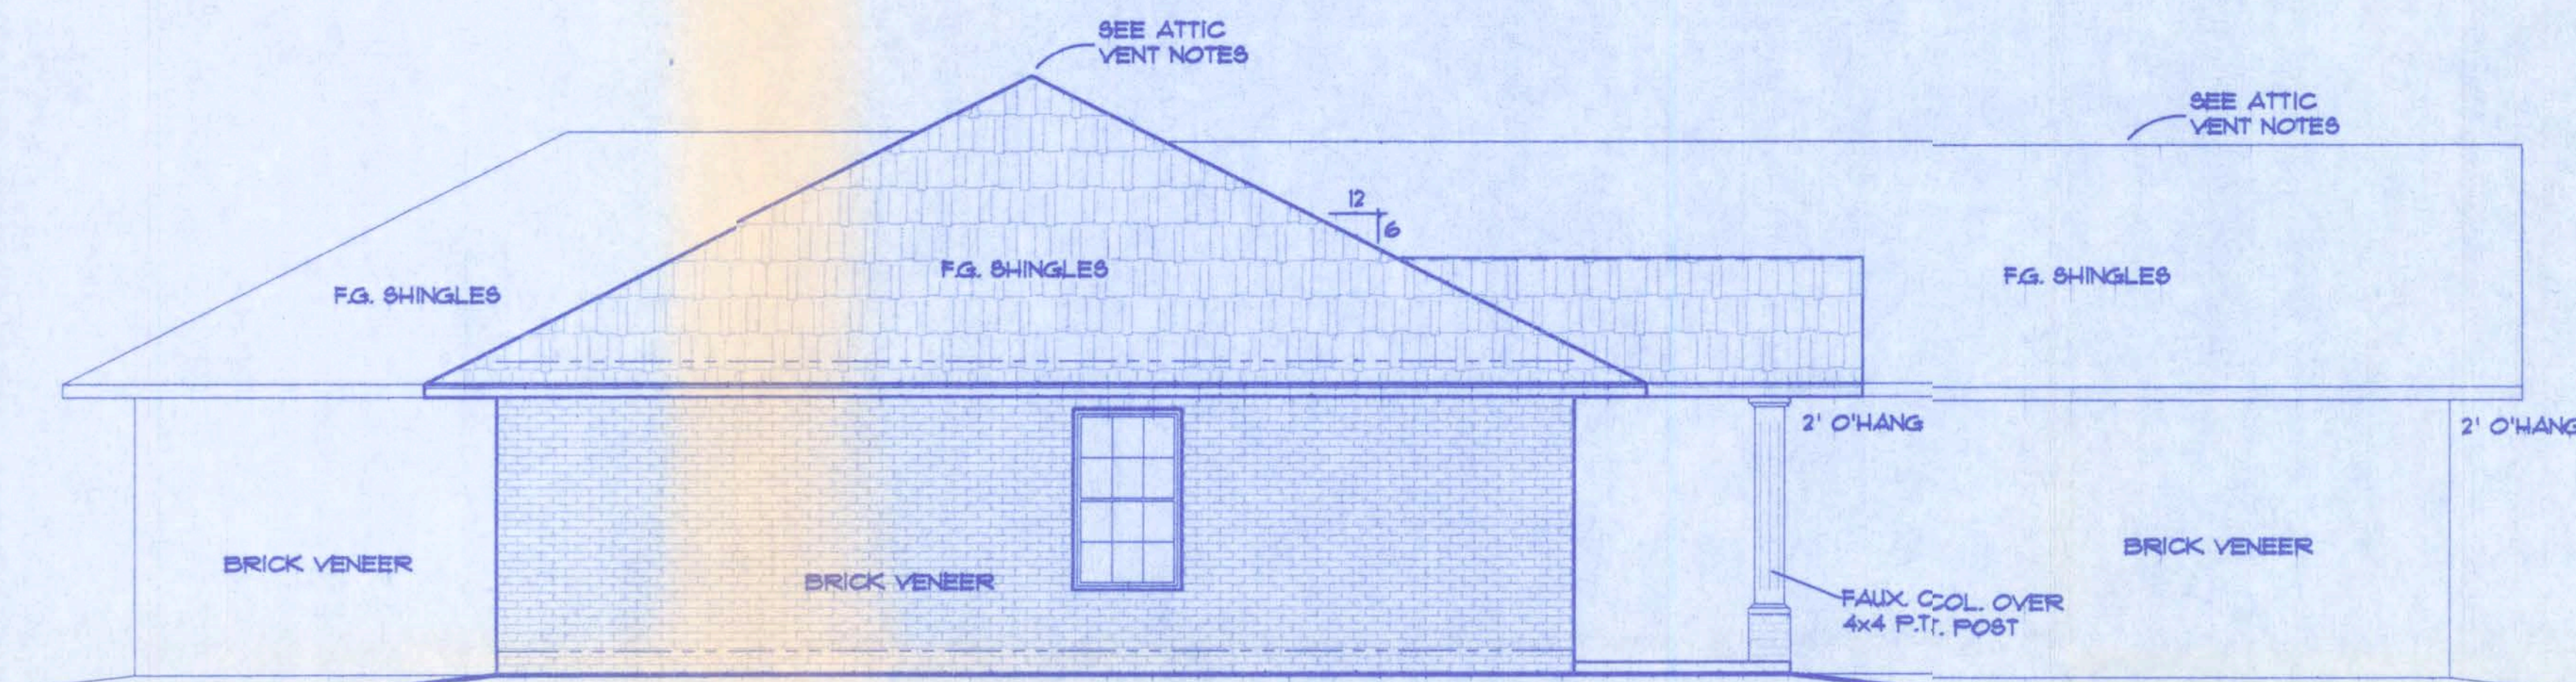


LEFT ELEVATION

SCALE: 1/4 IN. = 1 FT.

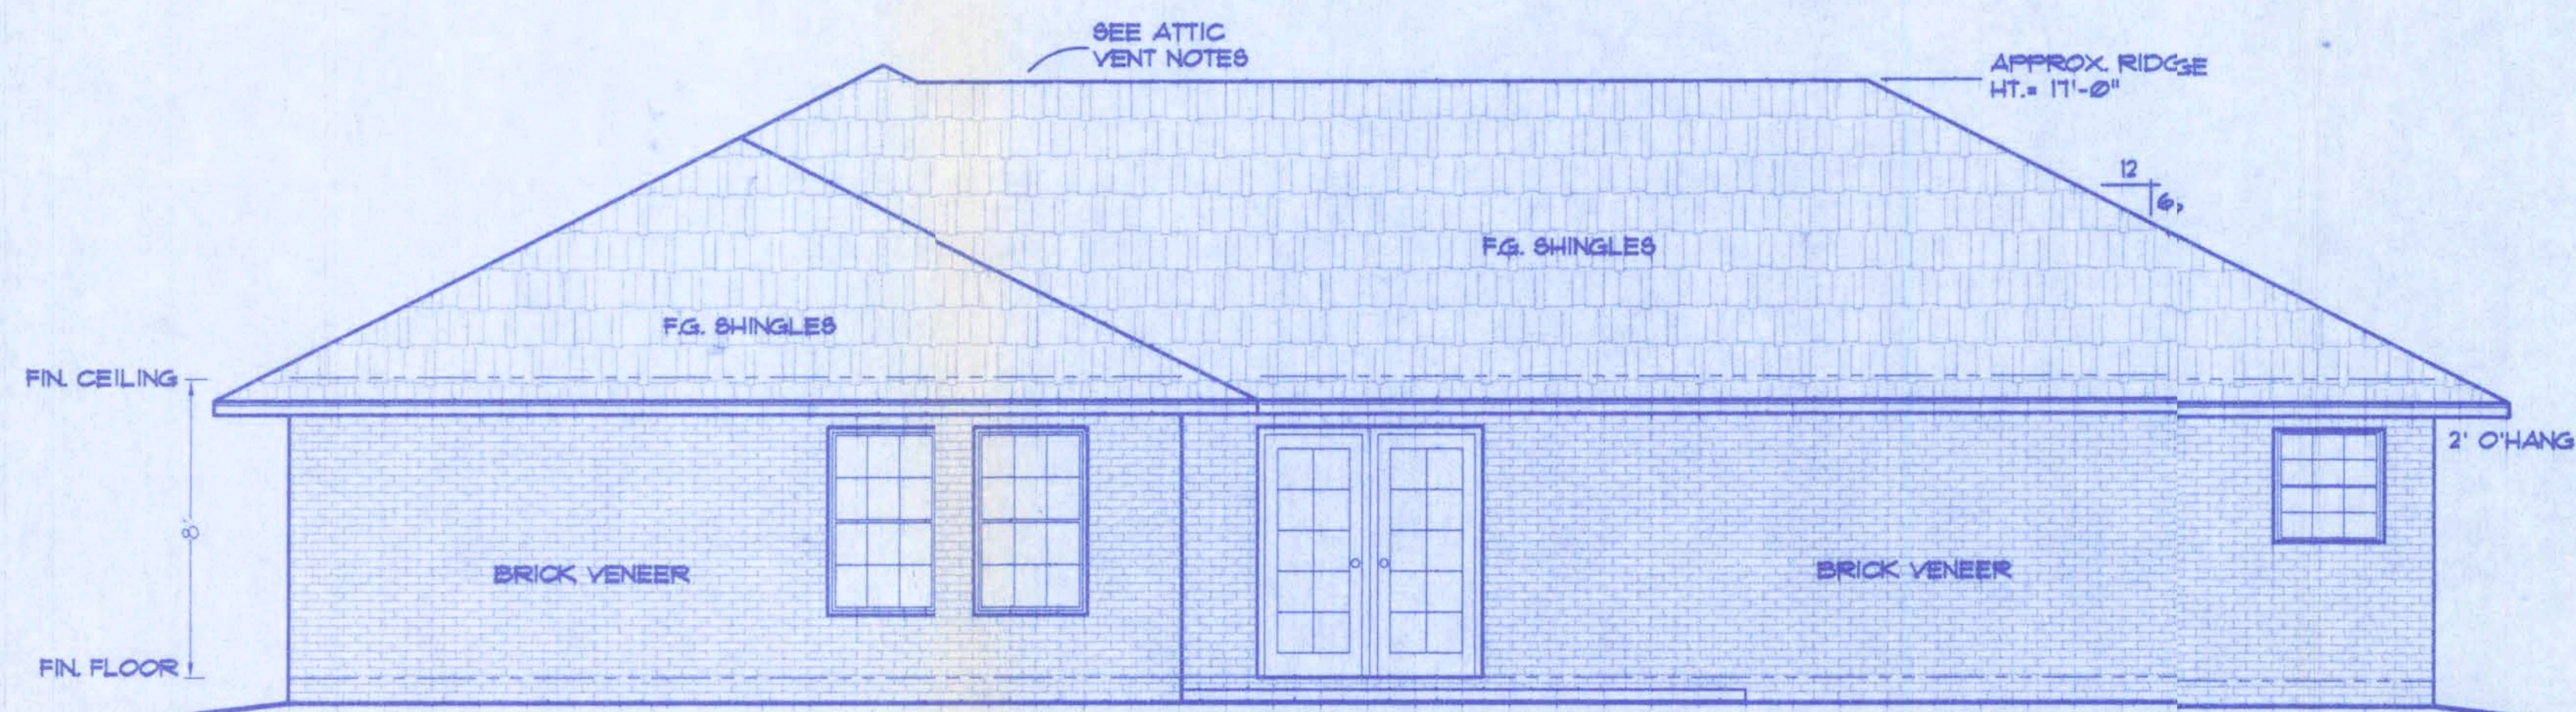

REAR ELEVATION

SCALE: 1/4 IN. = 1 FT.

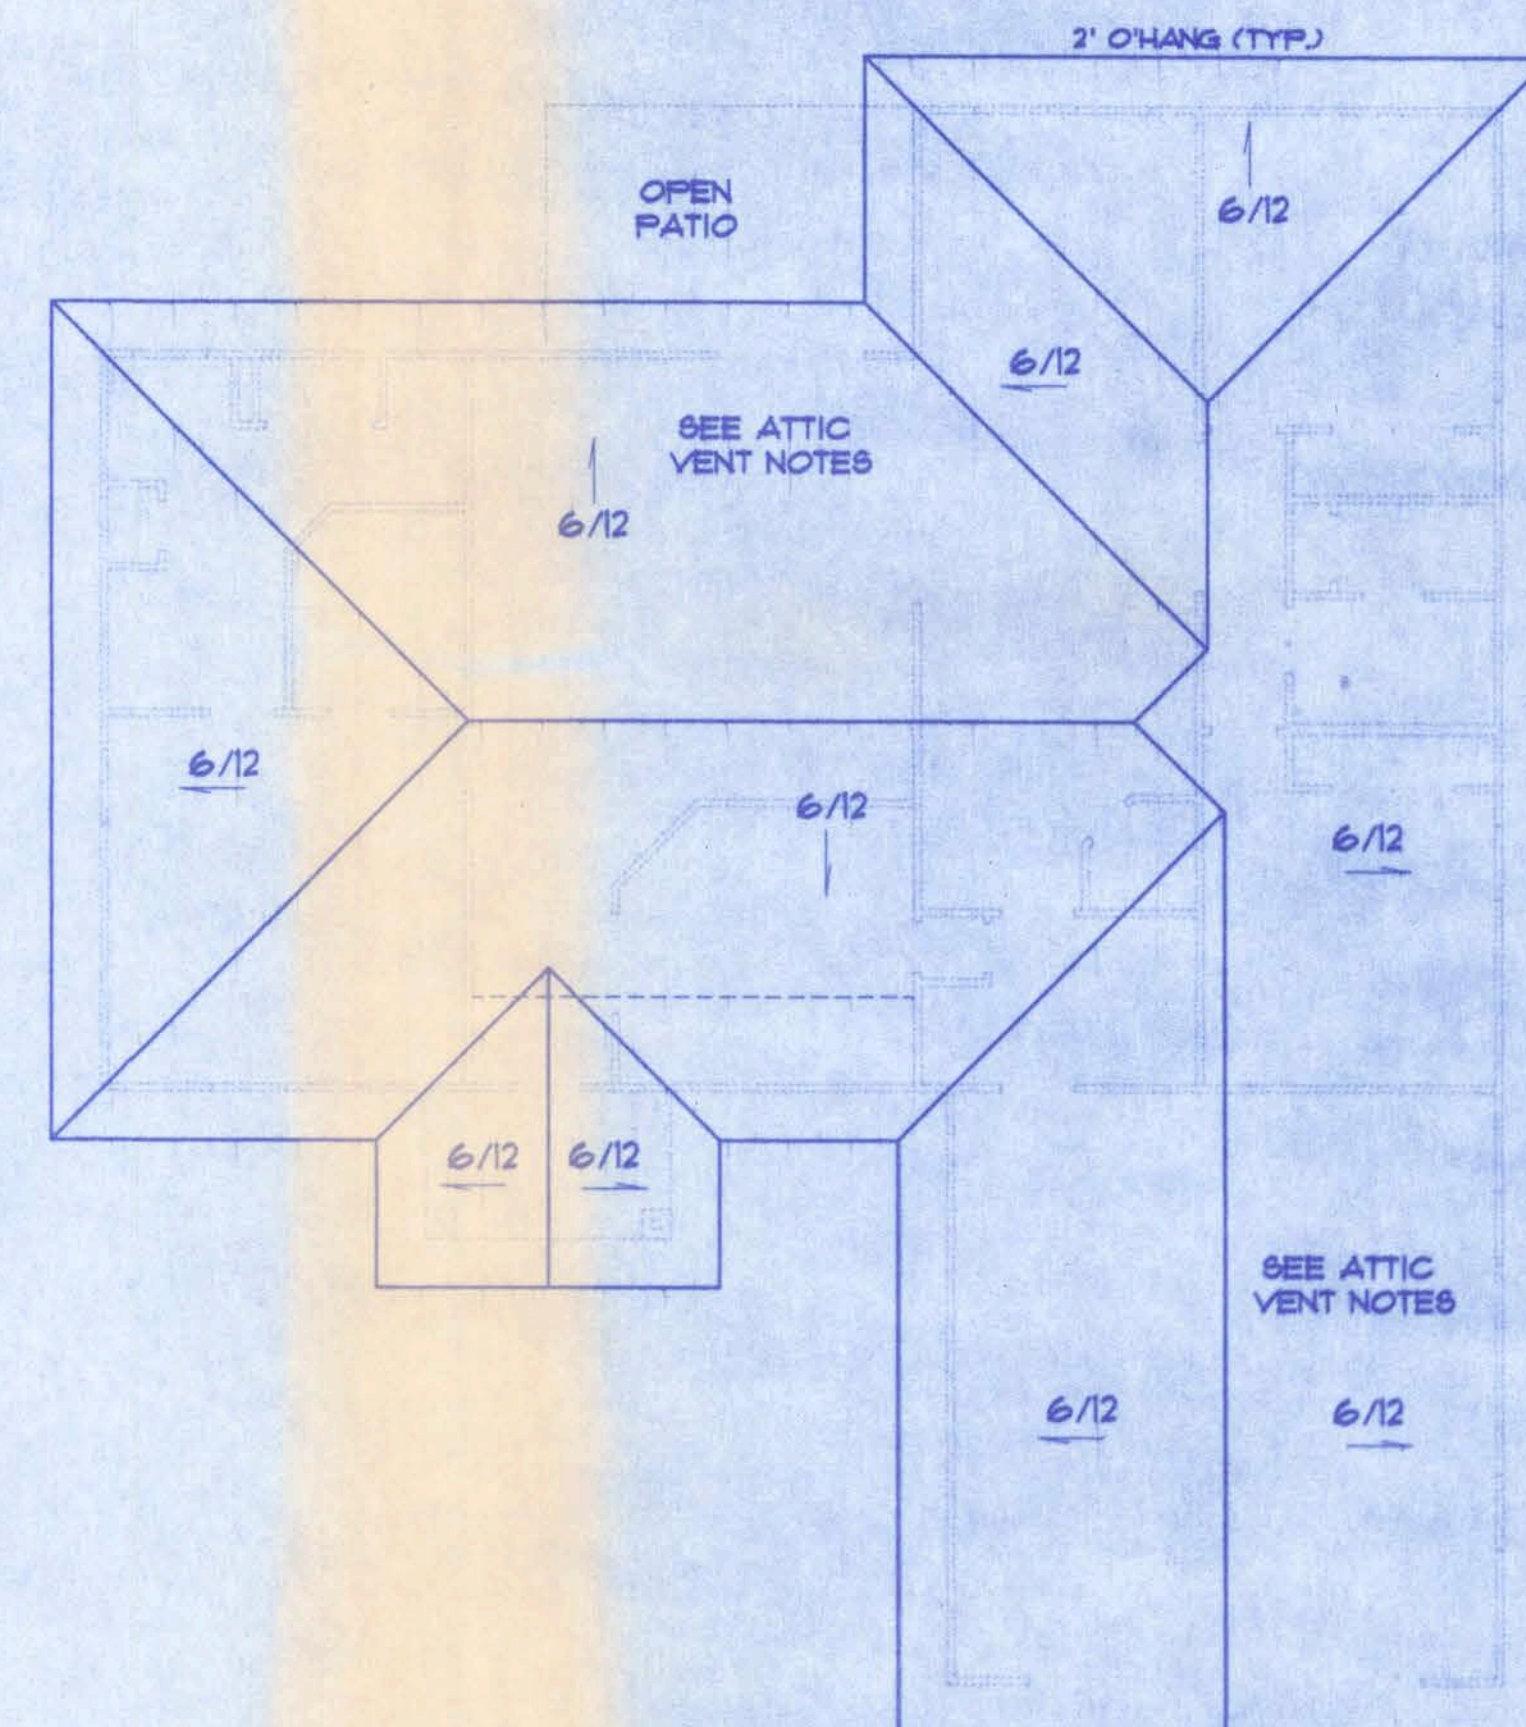

ROOF PLAN

SCALE: 1/8 IN. = 1 FT.

GENERAL NOTES

- 1.) See "Wind Load Detail Sheet S-1" and Wind Engineer's Notes for " data-bbox="592 573 775 595" data-label="Text">

data pertaining to Wind Design and compliance w/ Florida Building Code.
- 2.) All concrete used to be 2500 PSI strength or greater.
- 3.) HVAC duct and unit size/design is by engineered shop drawings from the AC contractor.
- 4.) Windows to be alum. framed and double glazed. Sizes shown are nominal and may vary with manufacturer.
- 5.) Roof Truss design is the responsibility of the supplier.
- 6.) The Truss Manufacturer shall prepare Shop Drawings indicating Truss placement, Girder locations, Truss-to-Truss Connections and any point loads. The Contractor shall notify the Designer of any point loads in excess of 2.0k for Fnd. Modification
- 7.) Site analysis or preparation information is not a part of this plan and is the responsibility of the owner.
- 8.) Cabinet and millwork detail is not a part of this plan. The plan is a general design and details shall be the responsibility of the owner and/or contractor.

ATTIC VENTILATION

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The total net free ventilating area shall not be less than 1 to 150 of the area of the space ventilated except that the total area is permitted to be reduced to 1 to 300, provided at least 50 percent and not more than 80 percent of the required ventilating area is provided by ventilators located in the upper portion of the space to be ventilated at least 3 feet (914 mm) above eave or cornice vents with the balance of the required ventilation provided by eave or cornice vents.

WINDLOAD ENGINEER: Mark Disosway, PE No.53915, POB 868, Lake City, FL 32056, 386-754-5419

CERTIFICATION: These plans and "Windload Engineering", Sheet S-1, attached, comply with Florida Building Code Residential 2004, Section R301.2.1 to the best of my knowledge.





LIMITATION: This design is valid for one building, at specified location, permitted within 90 days of signature date. In case of conflict, structural requirements, scope of work, and builder responsibilities on sheet S-1 control.

LOT 17 - STONEHENGE PH 2
Location: _____ Job No.: 602072

A-2

FILE: OG-011	JONATHAN PERRY CONST.	SHEET: 2 OF 4
DATE: 2-6-06		CAD FILE: OG011
DRAWN: T A D	PREPARED BY: TIM DELBENE Drafting + Technical Services	REV:
CHECK: T A D		REV:

192 SW Sagewood Cir., Lake City, FL 32024
Phone (386) 755-5891

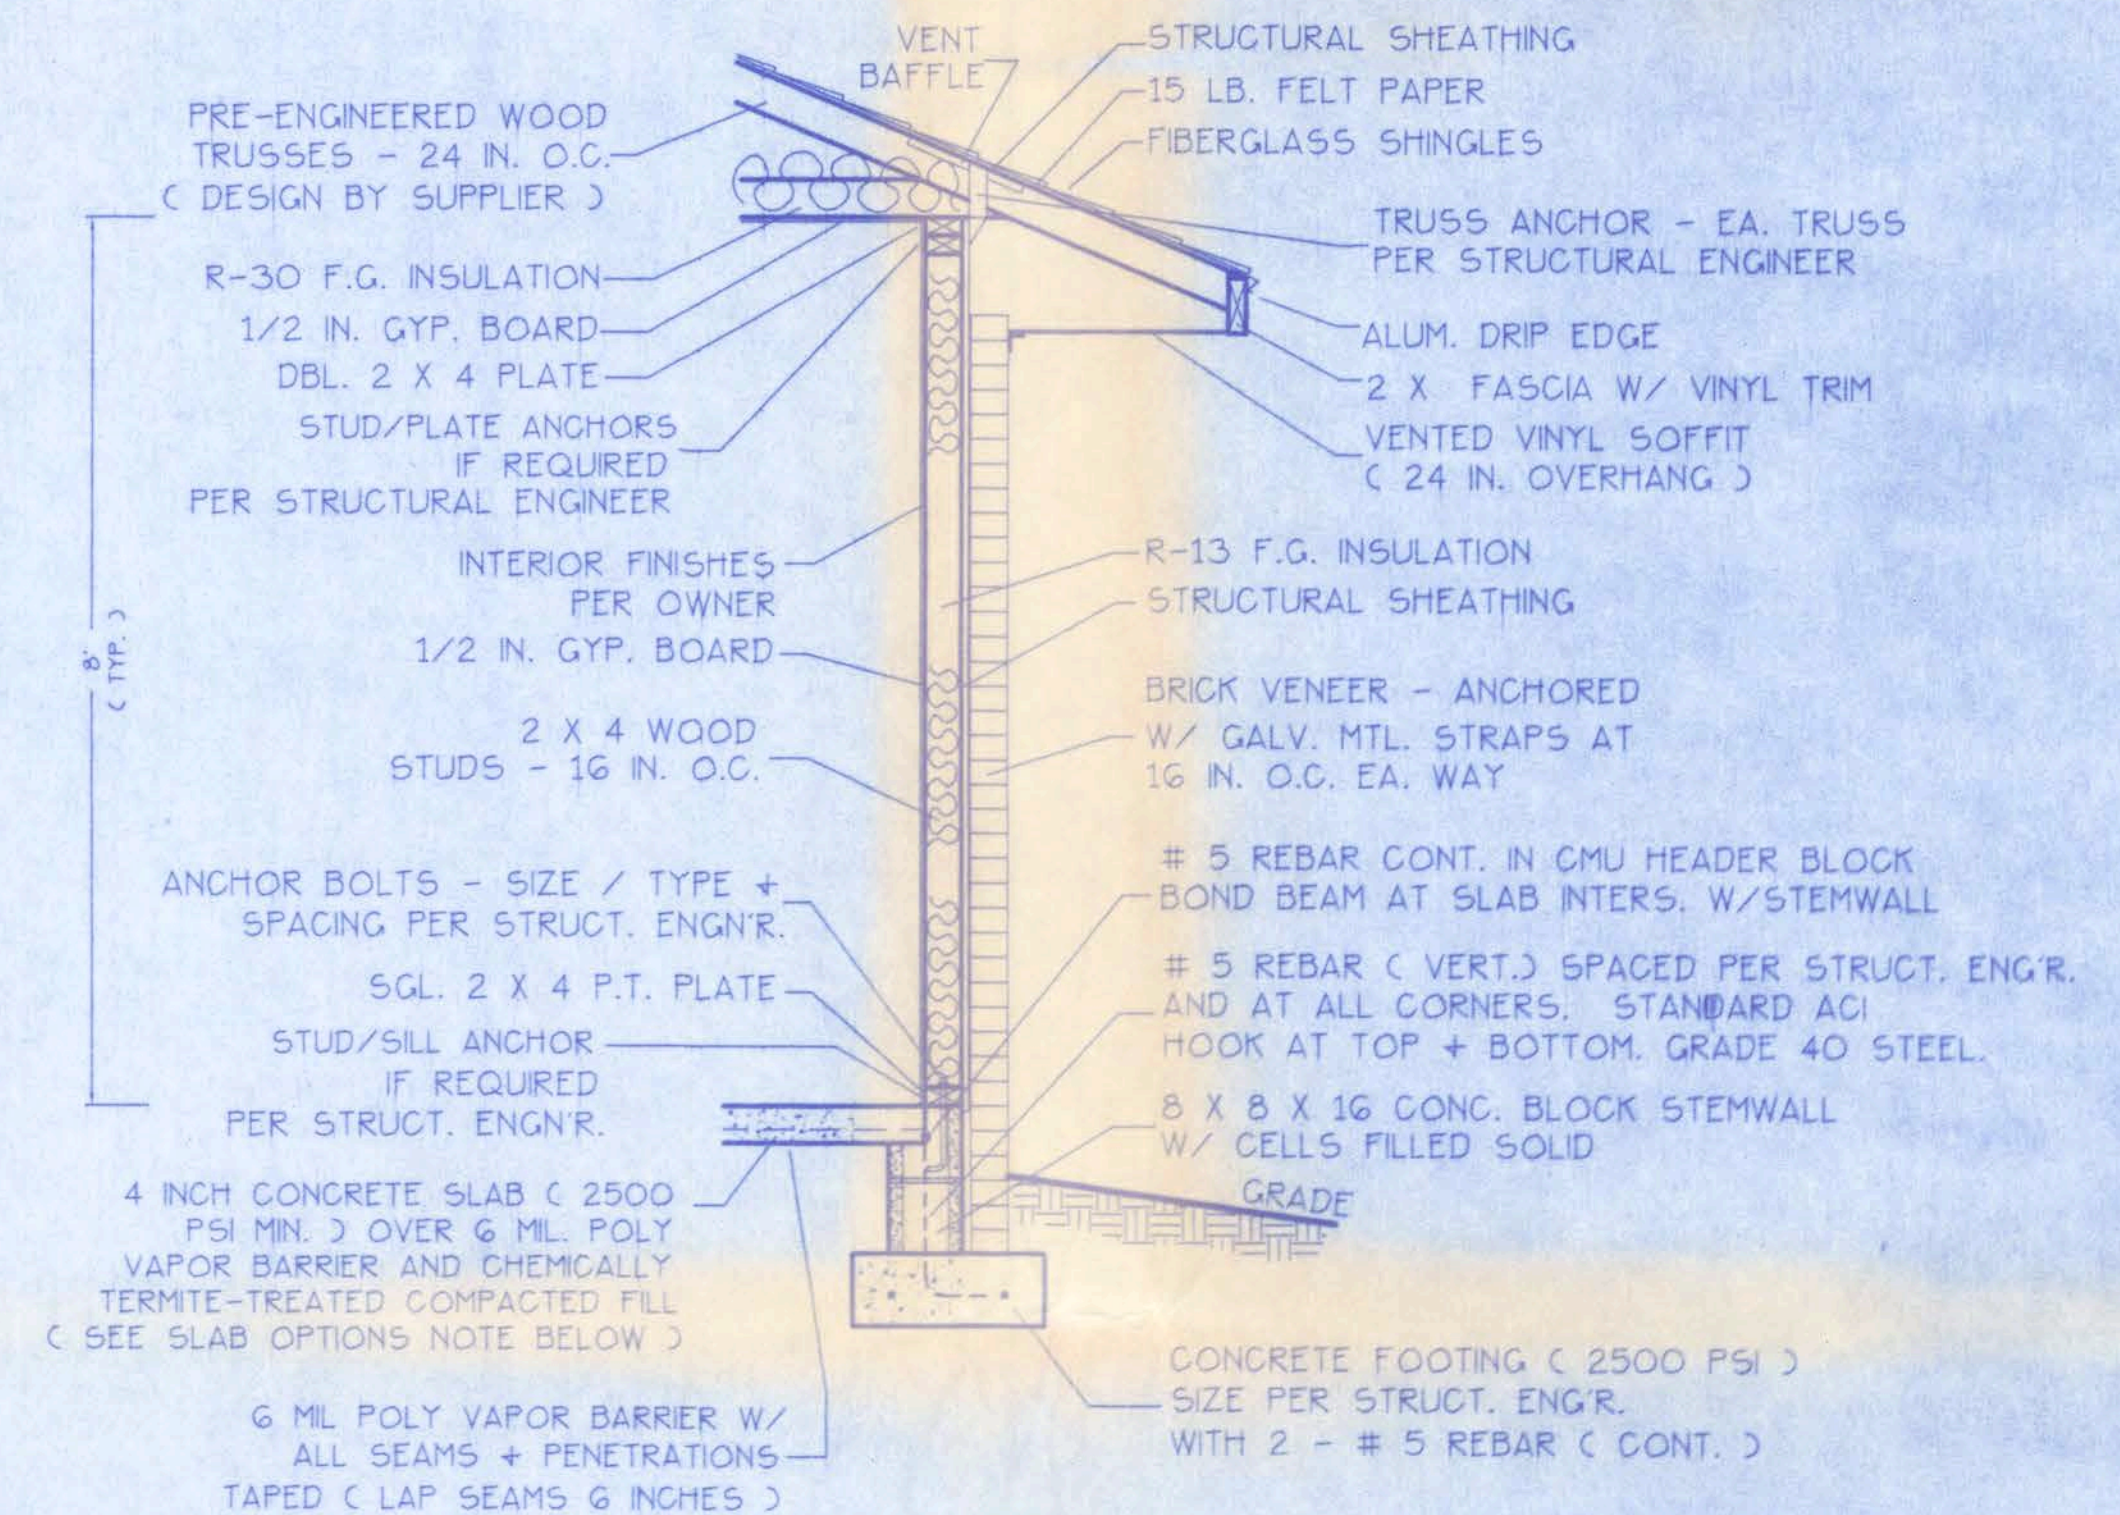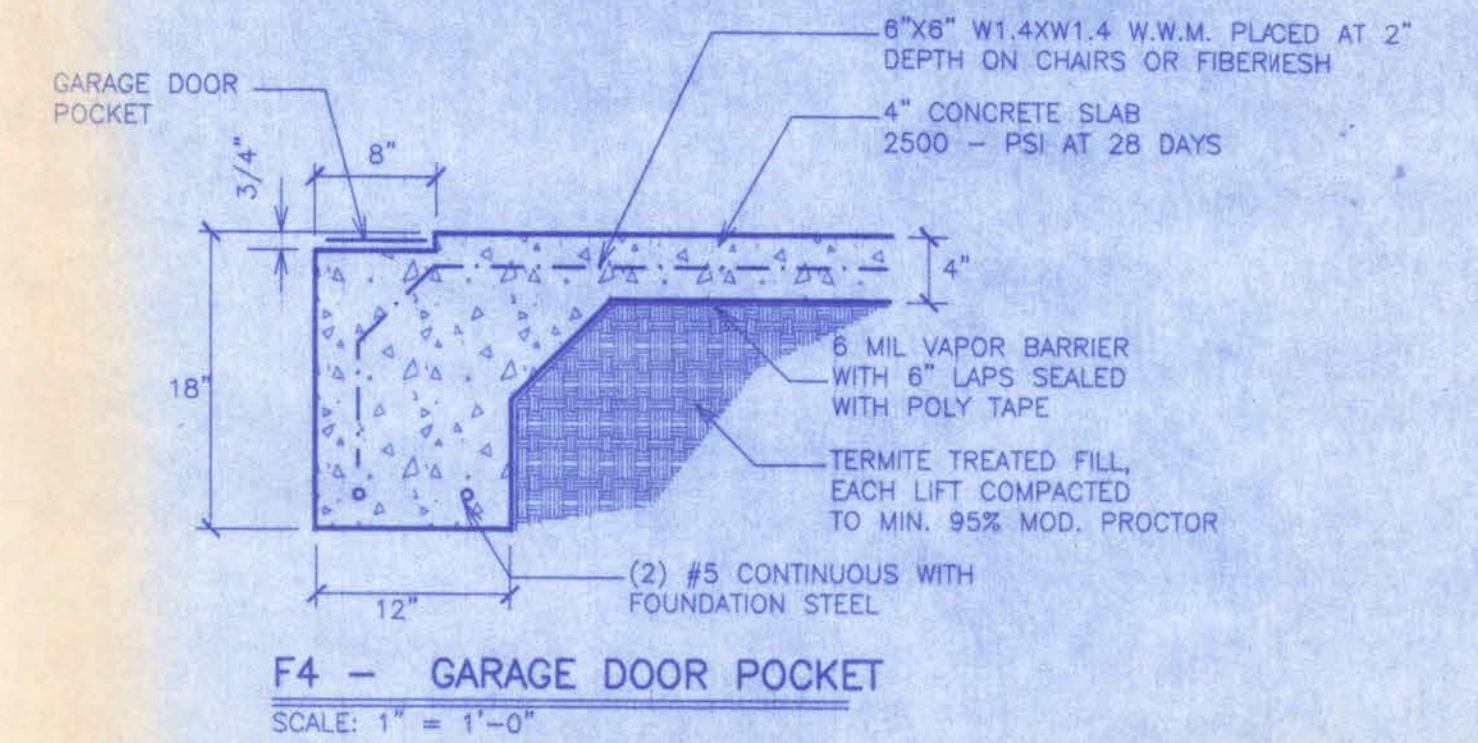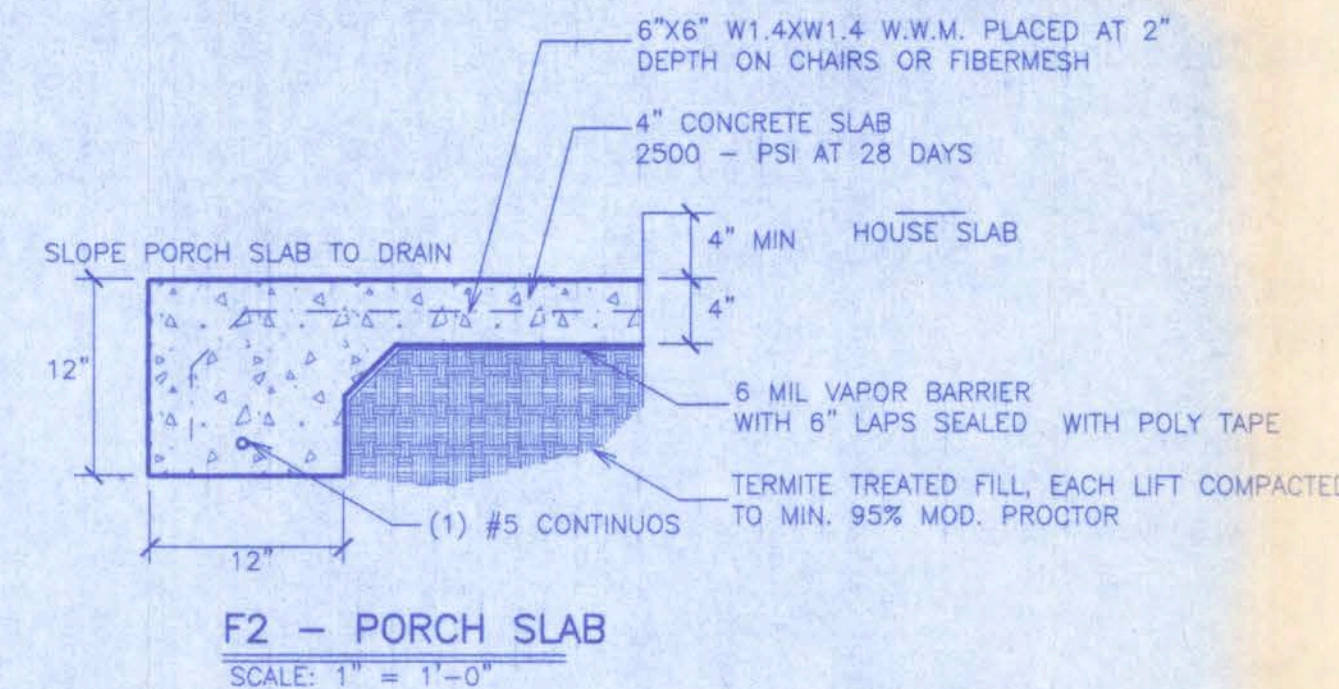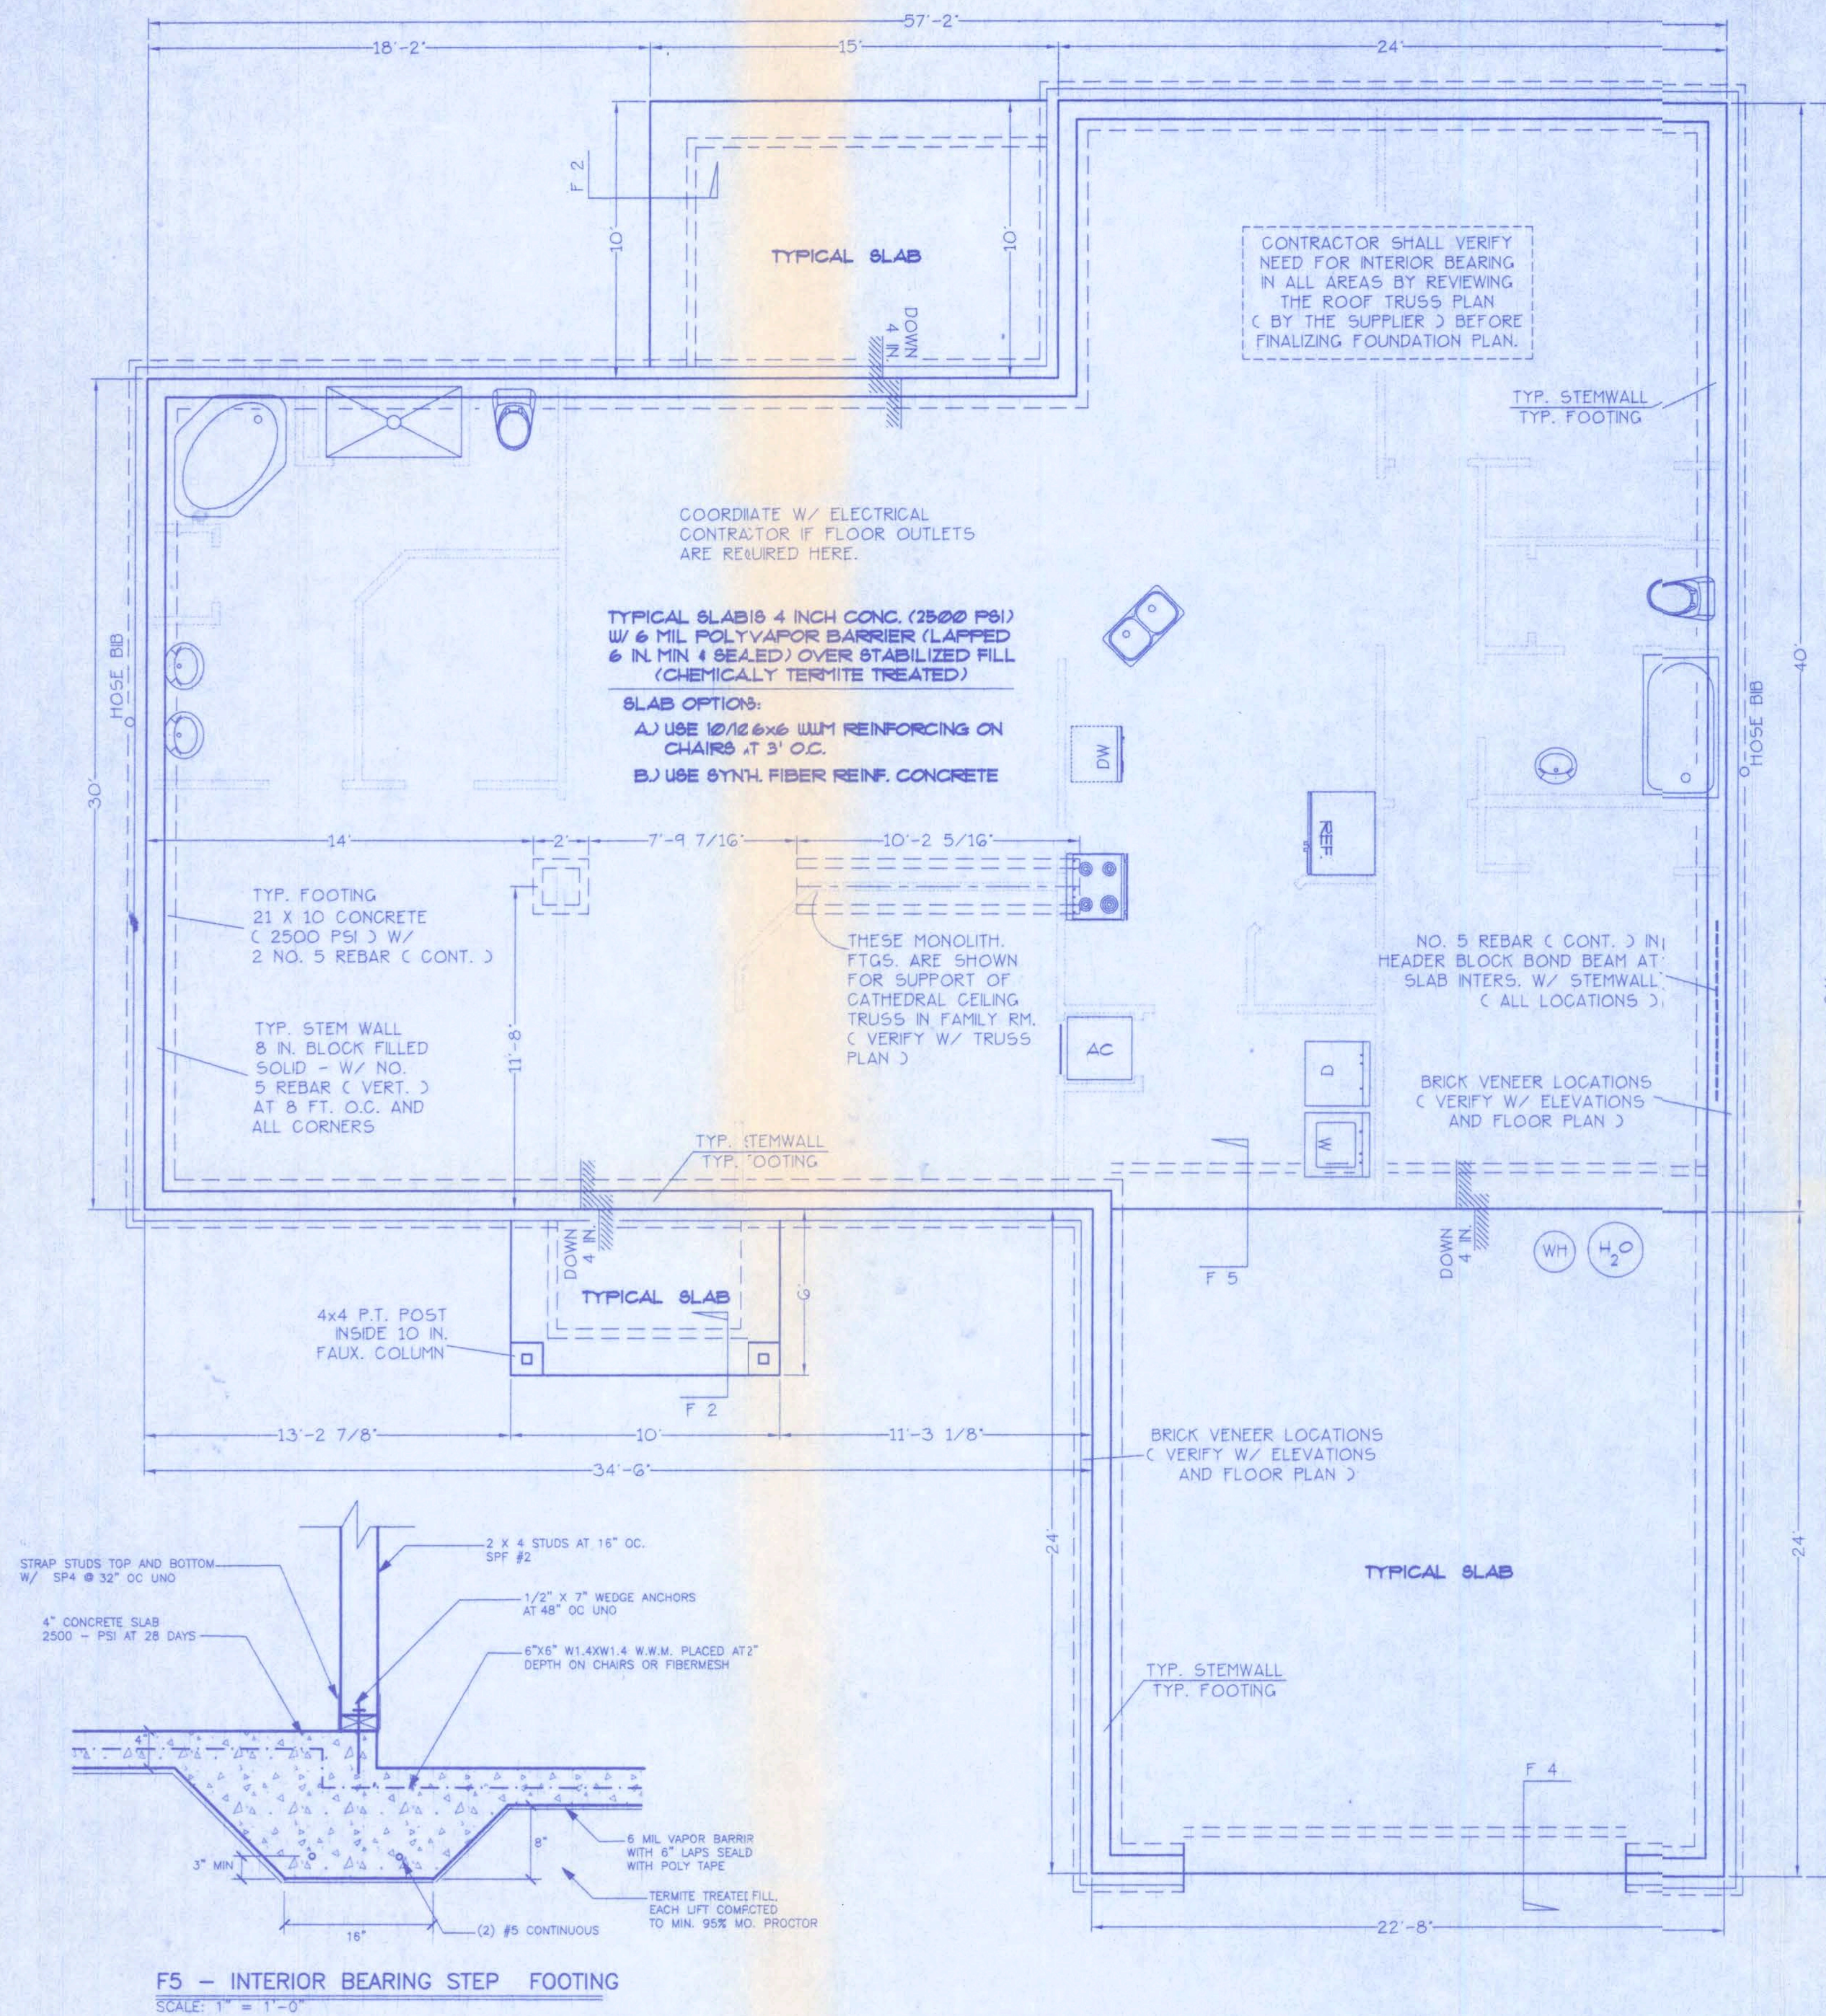

WINDLOAD ENGINEER: Mark Disosway, PE No.53915, POB 868, Lake City, FL 32056, 386-754-5419


CERTIFICATION: These plans and "Windload Engineering", Sheet S-1, attached, comply with Florida Building Code Residential 2004, Section R301.2.1 to the best of my knowledge.

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LOT 17 - STONEHENGE PH 2
Location: _____ Job No.: 602072

A-3

FILE: OG-D11	JONATHAN PERRY CONST.	SHEET: 3 OF 4
DATE: 2-6-06		CAD FILE: OGD11
DRAWN: T A D	PREPARED BY: TIM DELBENE Drafting + Technical Services	REV:
CHECK: T A D	192 SW Sagewood Gln. Lake City, FL 32024 Phone: (386) 755-5891	REV:

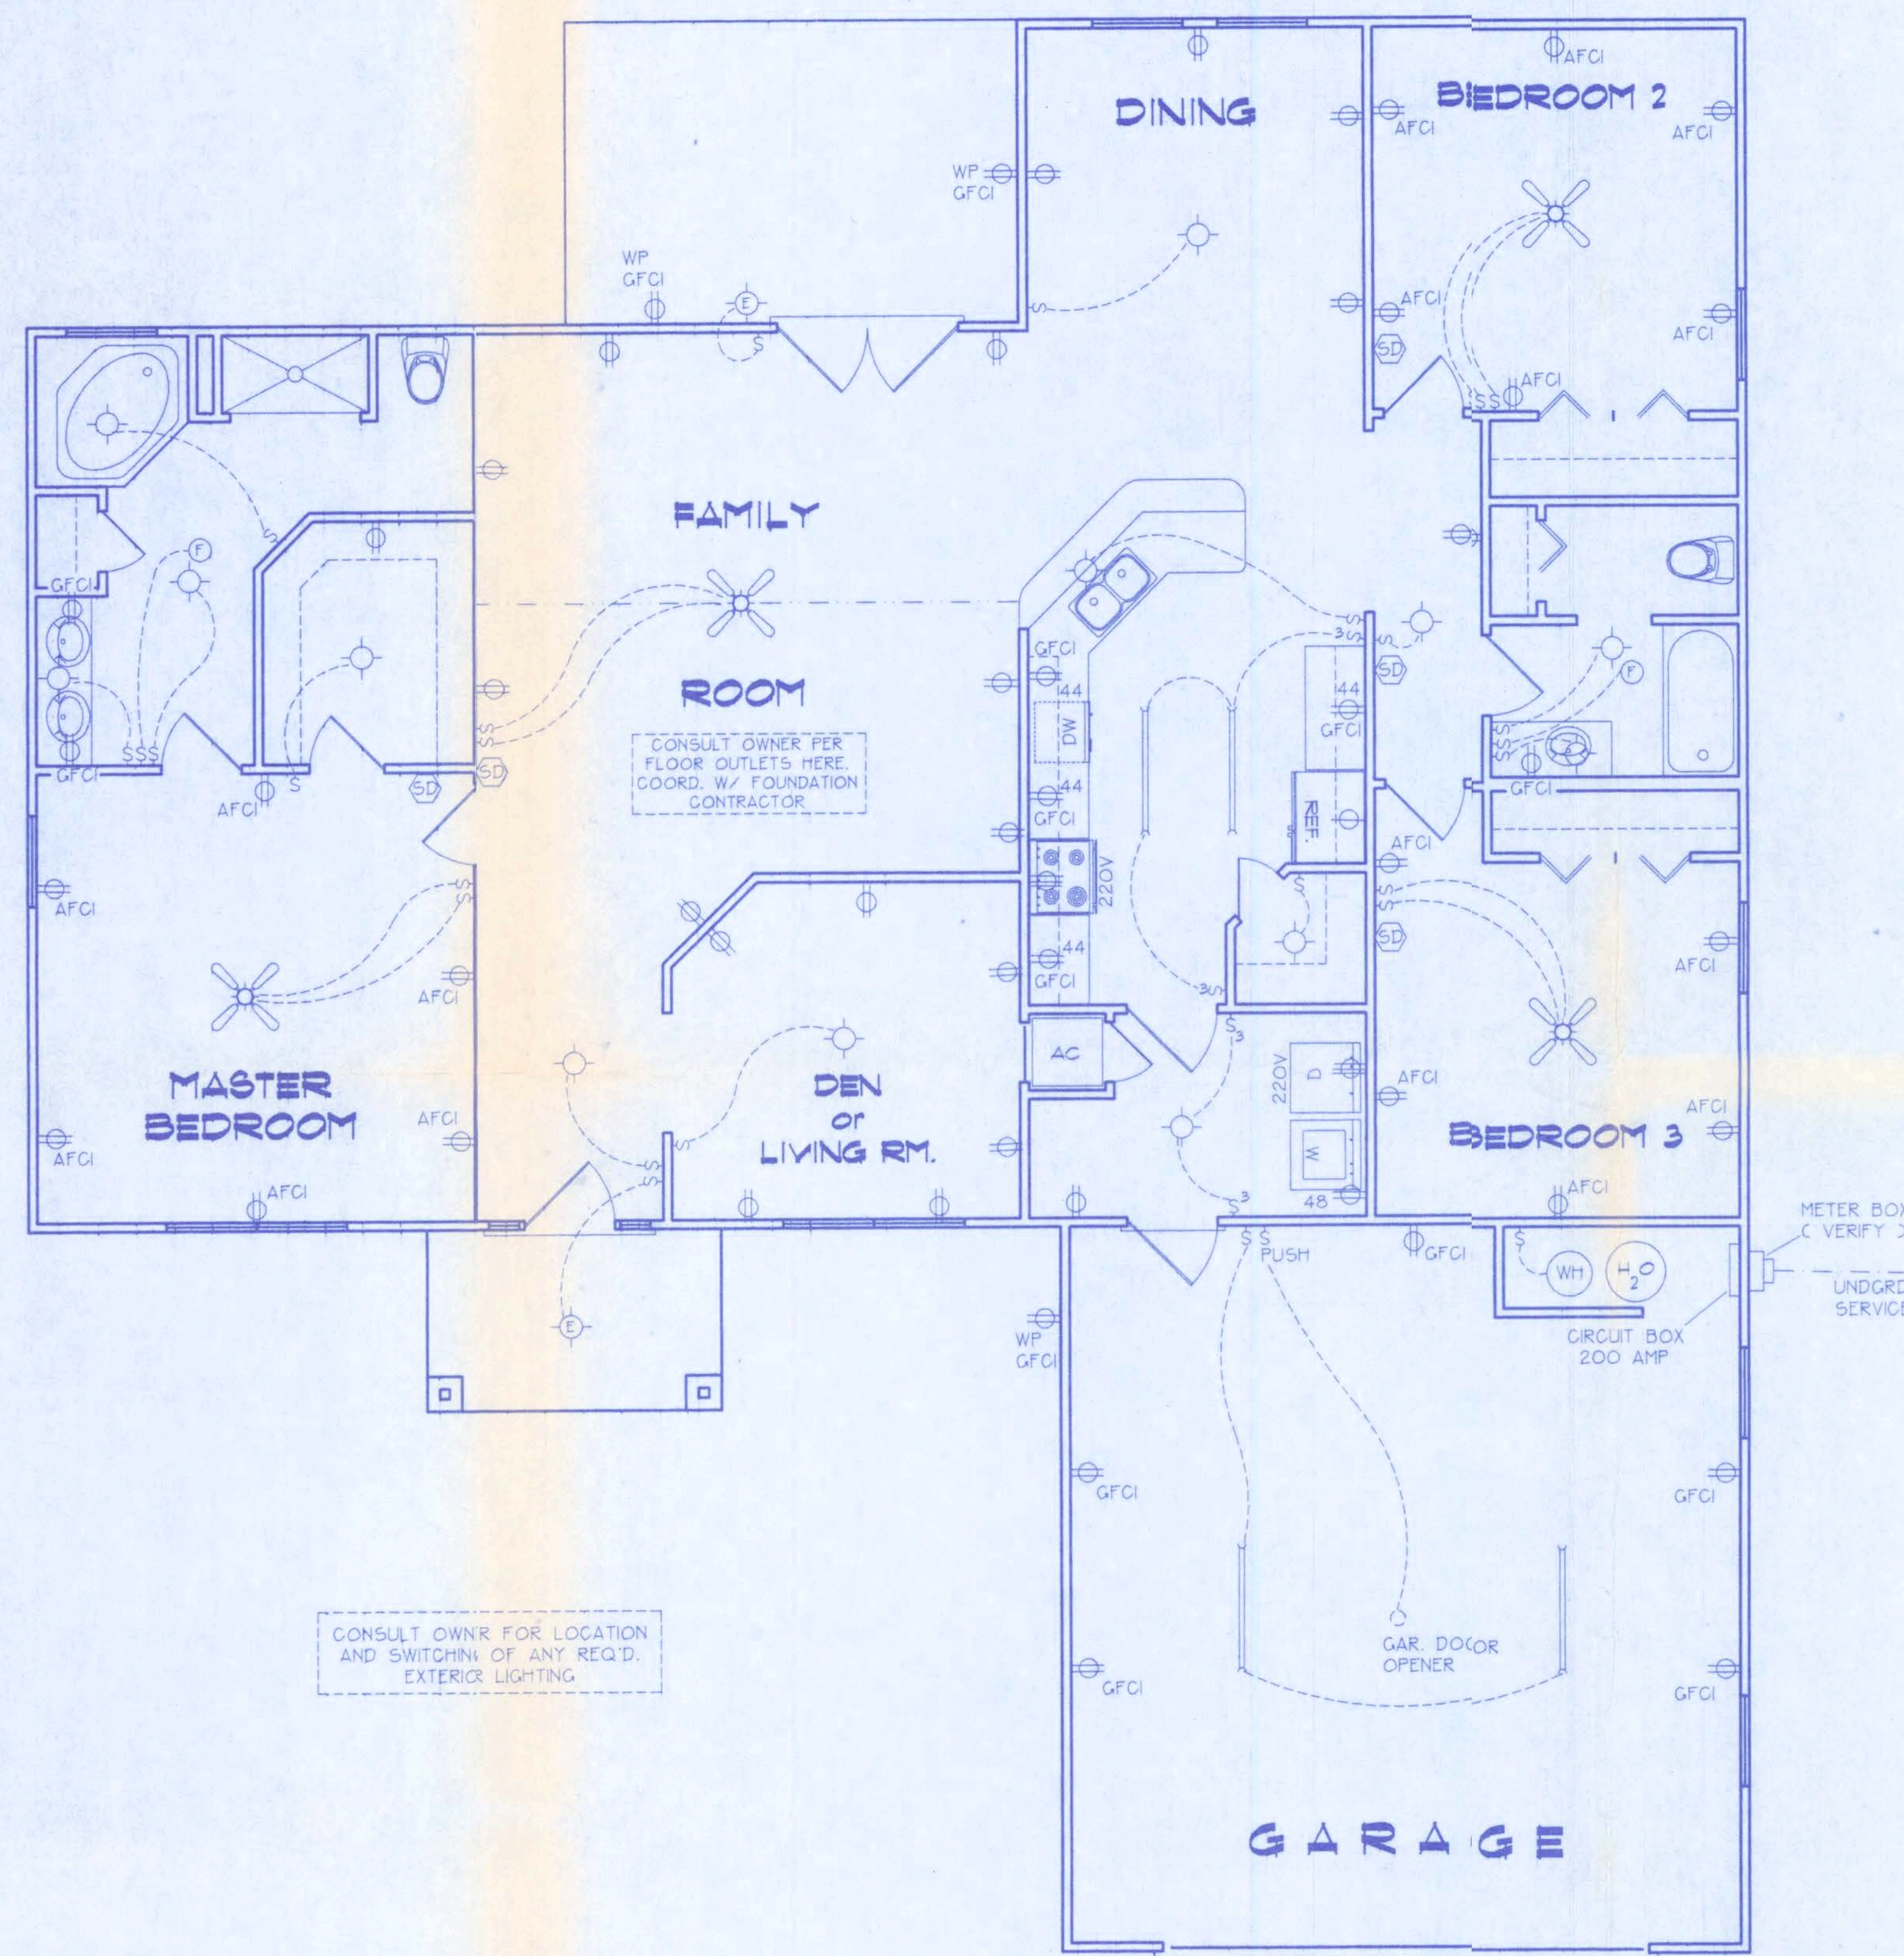

ELECTRICAL PLAN
NOT TO SCALE

ELECTRICAL SYMBOL LEGEND	
	= FLOURESCENT LIGHTING FIXTURE.
	= CEILING LIGHT FIXTURE
	= EXTERIOR LIGHTING FIXTURE
	= LIGHT SWITCH.
	= THREE-WAY SWITCH.
	= 110 V. DUPLEX OUTLET.
	= SPECIAL HEIGHT 110 V. DUPLEX OUTLET
	= GROUND FAULT CIRC. OUTLET
	= ARC FAULT CIRC. OUTLET
	= 110 V. SINGLE RECEPTACLE OUTLET.
	= 220 VOLT OUTLET (4 WIRE)
	= FAN LOCATION (CEILING)
	= FAN LOCATION (EXHAUST)
	= SMOKE DETECTOR


- ELECTRICAL PLAN NOTES**
- WIRE ALL APPLIANCES, HVAC UNITS AND OTHER EQUIPMENT PER MANUF. SPECIFICATIONS.
 - CONSULT THE OWNER FOR THE NUMBER OF SEPERATE TELEPHONE LINES TO BE INSTALLED.
 - ALL INSTALLATIONS SHALL BE PER NAT'L. ELECTRIC CODE.
 - ALL SMOKE DETECTORS SHALL BE 120V W/ BATTERY BACKUP OF THE PHOTOELECTRIC TYPE, AND SHALL BE INTERLOCKED TOGETHER. INSTALL INSIDE AND NEAR ALL BEDROOMS.
 - TELEPHONE, TELEVISION AND OTHER LOW VOLTAGE DEVICES OR OUTLETS SHALL BE AS PER THE OWNER'S DIRECTIONS, + IN ACCORDANCE W/ APPLICABLE SECTIONS OF NEC-LATEST EDITION.
 - ELECTRICAL CONTR SHALL BE RESPONSIBLE FOR THE DESIGN + SIZING OF ELECTRICAL SERVICE AND CIRCUITS.
 - ENTRY OF SERVICE (UNDERGROUND OR OVERHEAD) TO BE DETERMINED BY POWER COMPANY.

A-4


FILE: OG-011	JONATHAN PERRY CONST.	SHEET: 4 OF 4
DATE: 2-G-06		CAD FILE: 0GO11
DRAWN: T A D	PREPARED BY: TIM DELBENE Drafting + Technical Services 192 SW Sagewood Gln., Lake City, FL 32024 Phone (386) 755-5891	REV:
CHECK: T A D		REV:

REVISIONS


SOFTPLAN
ARCHITECTURAL DESIGN SOFTWARE

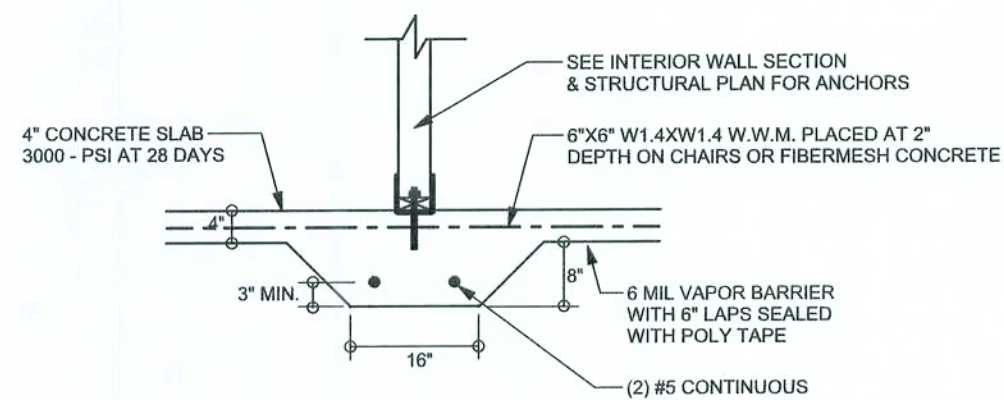


F2
S-2 INTERIOR BEARING FOOTING
SCALE: 1/2" = 1'-0"

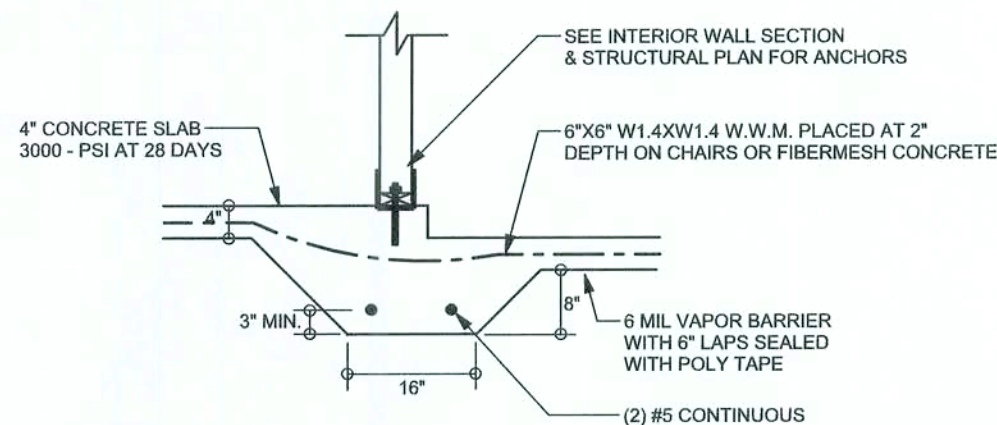


F3
S-2 INTERIOR BEARING STEP FOOTING
SCALE: 1/2" = 1'-0"

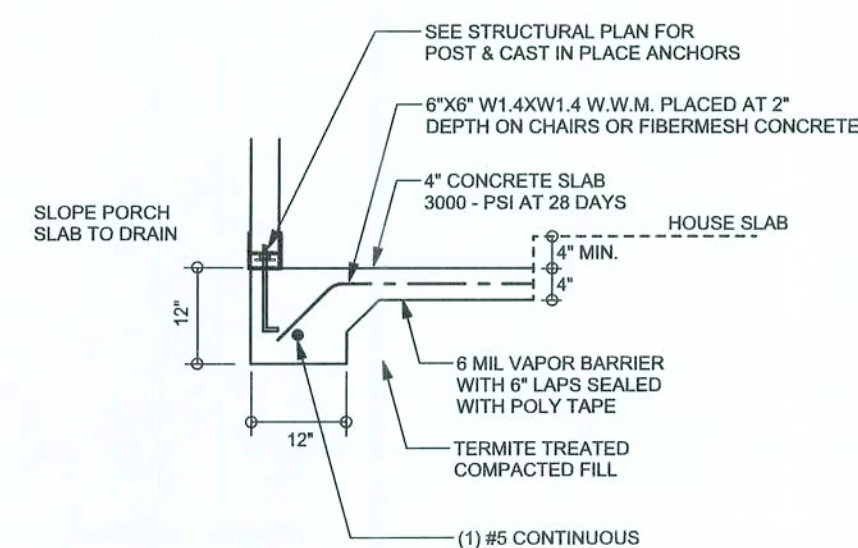


F5
S-2 PORCH FOOTING
SCALE: 1/2" = 1'-0"

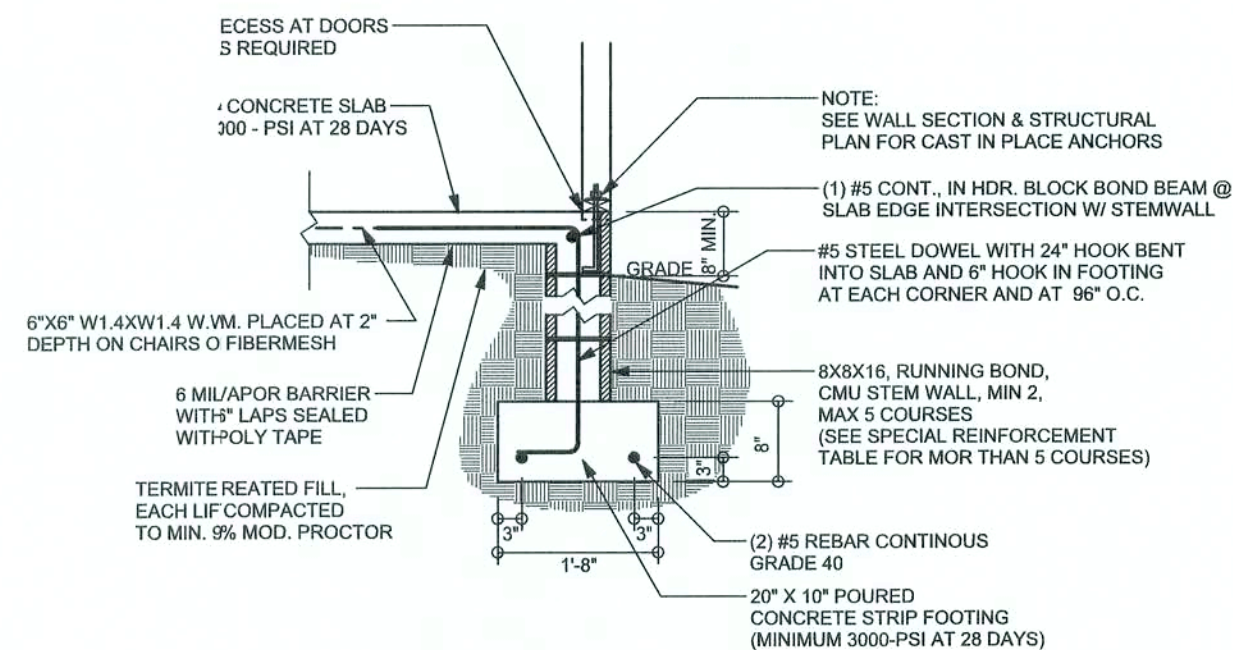


F9
S-2 STEM WALL FOOTING
SCALE: 1/2" = 1'-0"

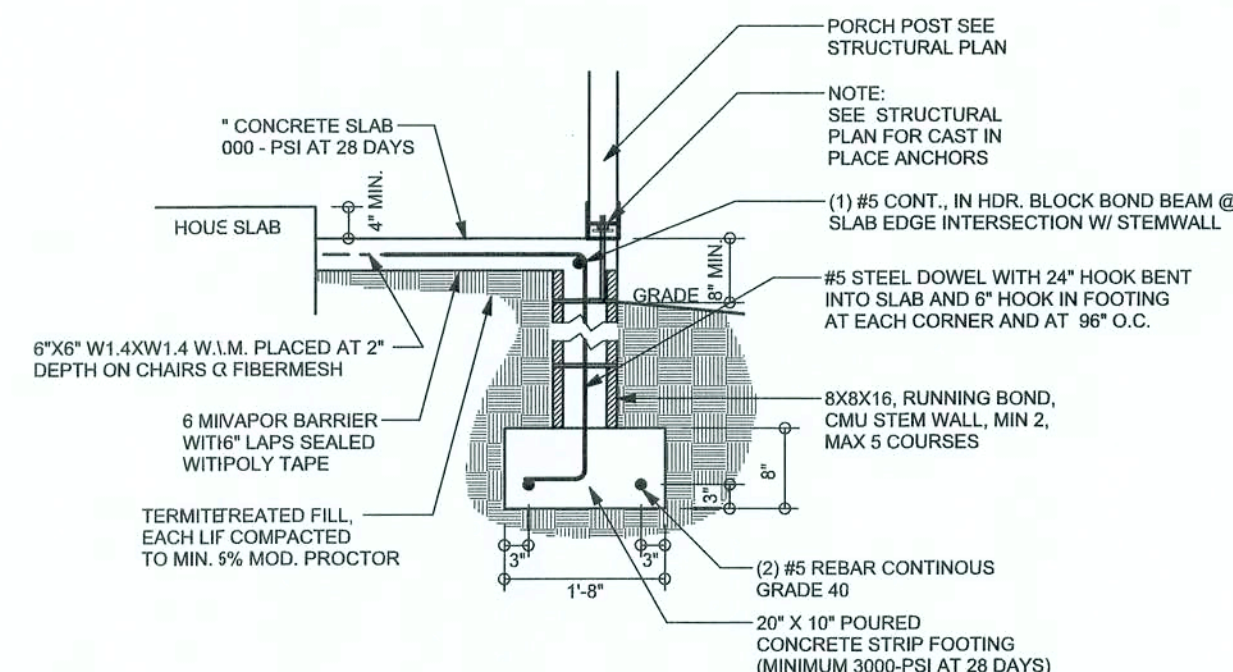

F12
S-2 ALT. STEM WALL PORCH FOOTING
SCALE: 1/2" = 1'-0"

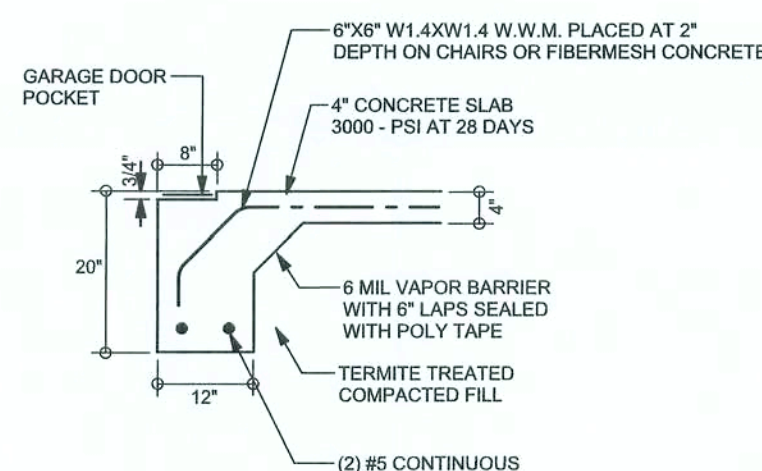

F13
S-2 ALT. STEM WALL GARAGE DOOR FOOTING
SCALE: 1/2" = 1'-0"

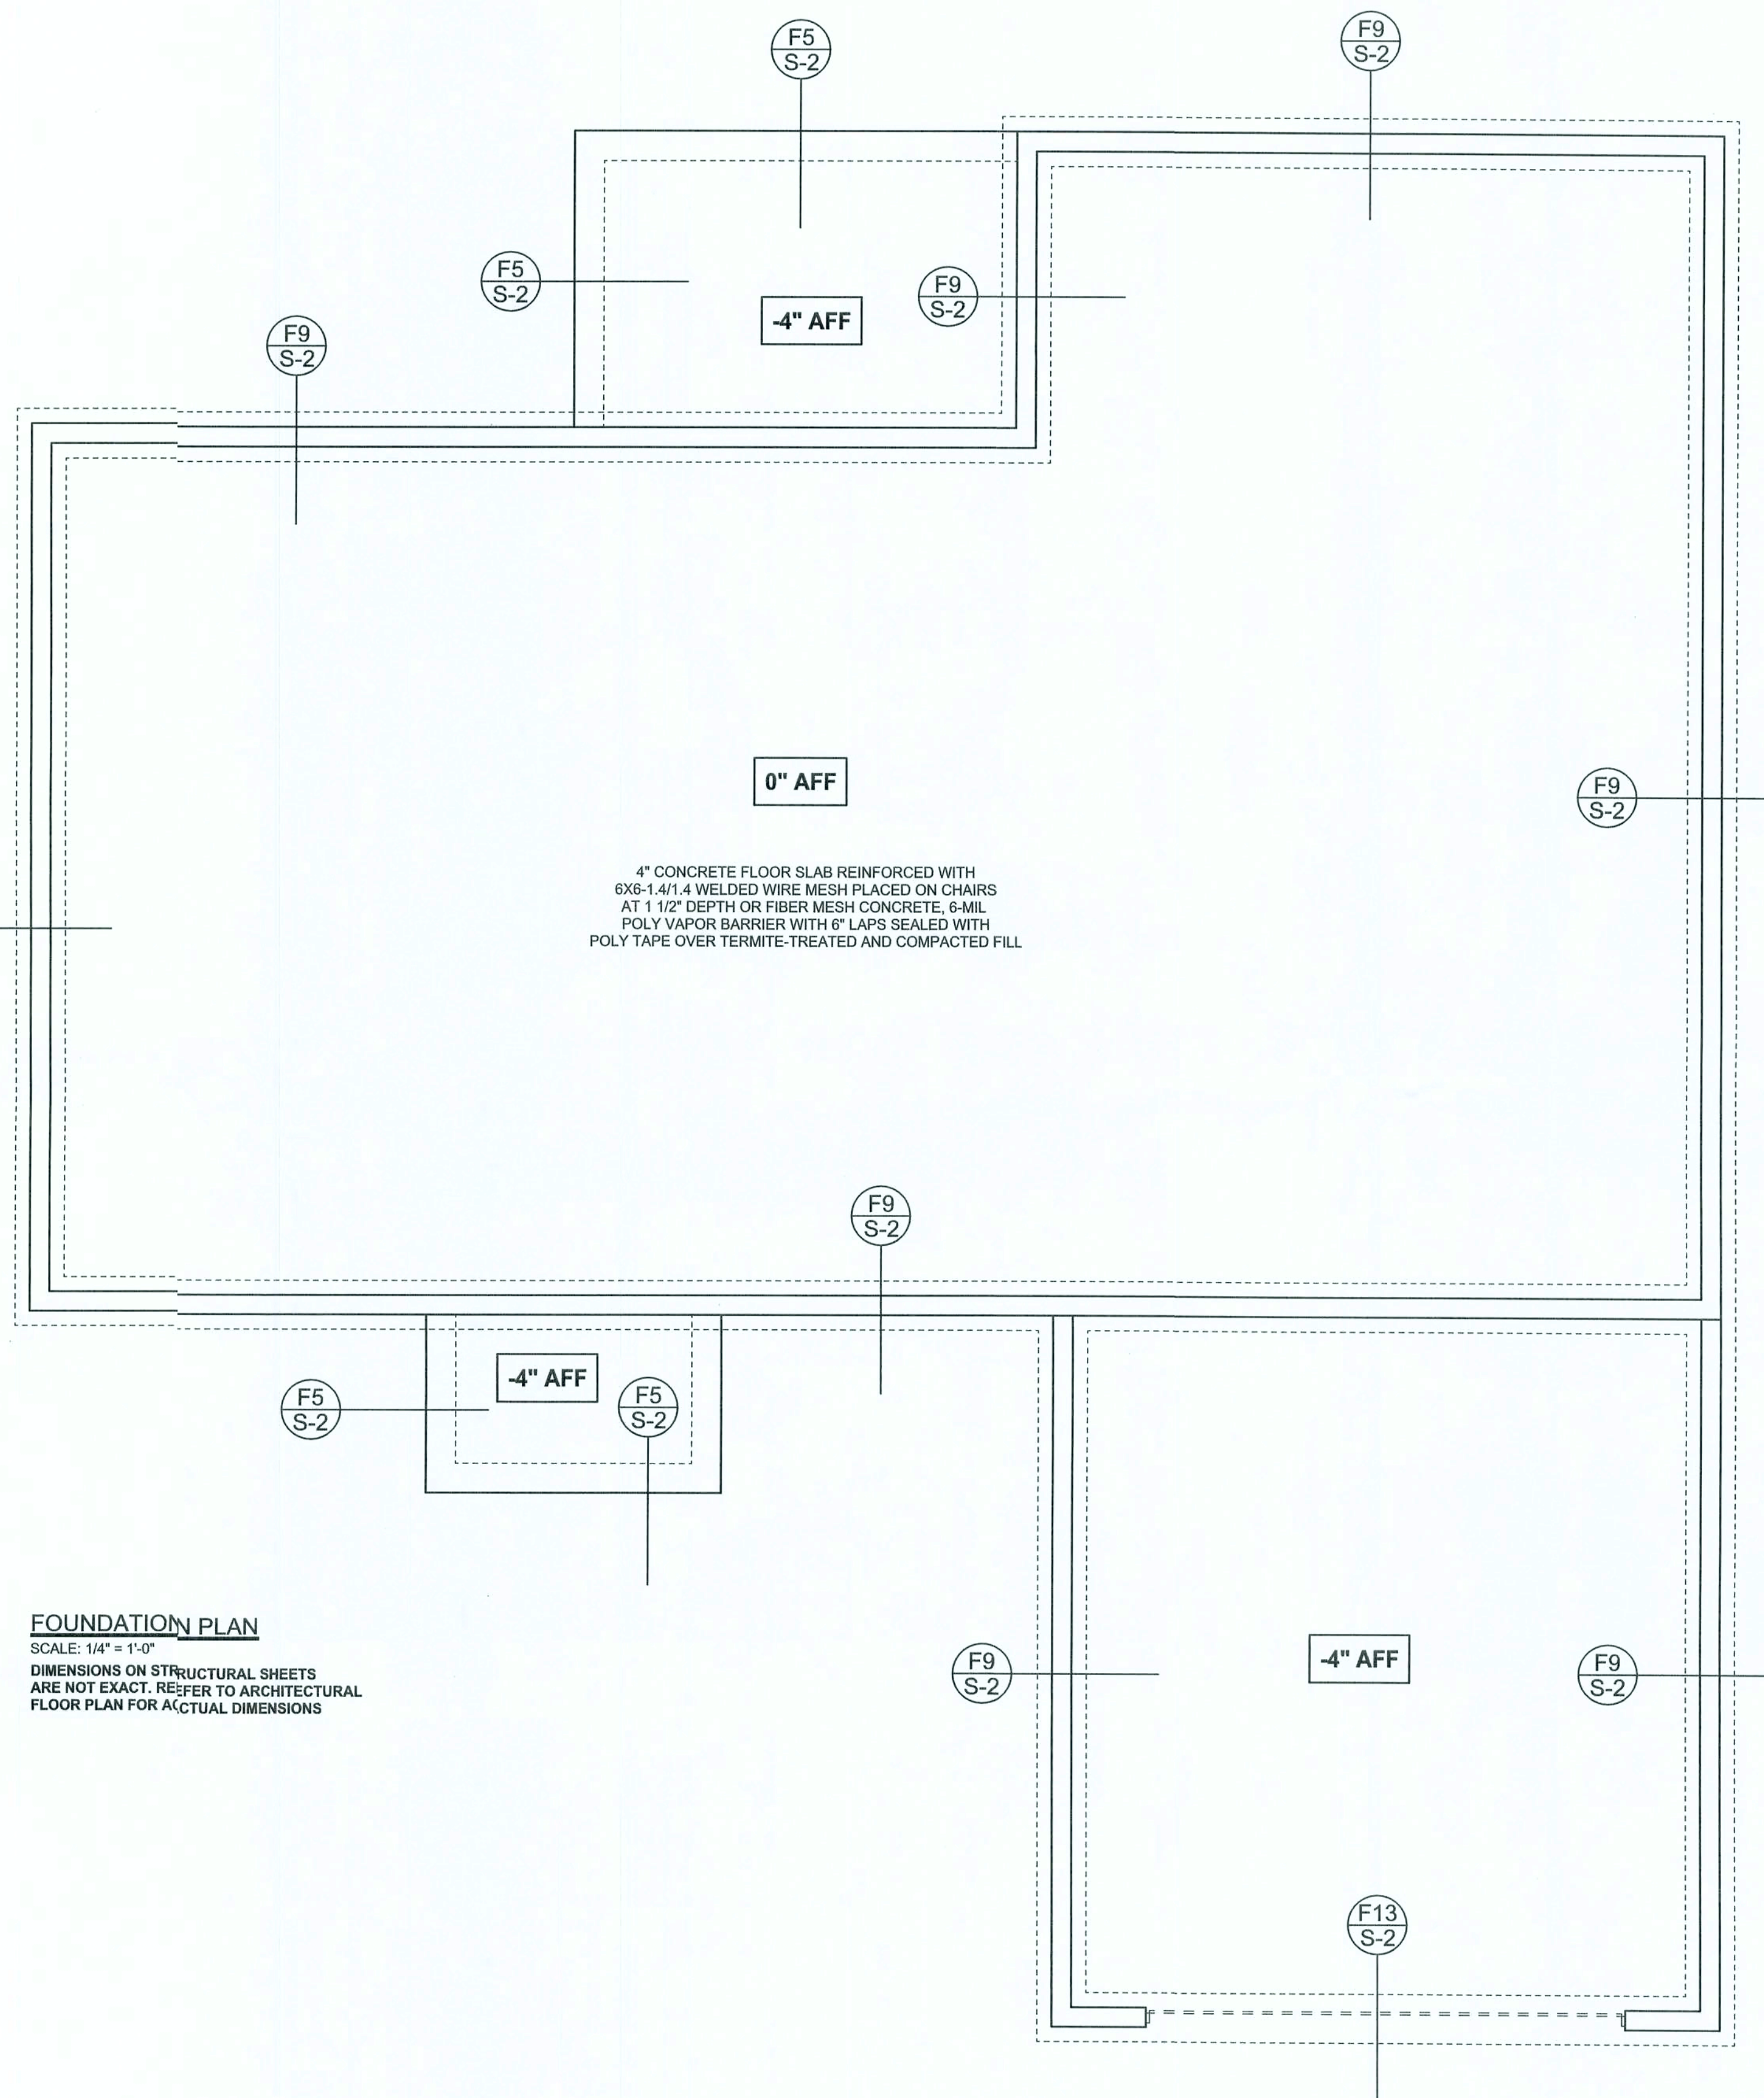

FOUNDATION PLAN
SCALE: 1/4" = 1'-0"
DIMENSIONS ON STRUCTURAL SHEETS
ARE NOT EXACT. REFER TO ARCHITECTURAL
FLOOR PLAN FOR ACTUAL DIMENSIONS

WINDLOAD ENGINEER: Mark Disosway,
P.E. No. 53815, P.O. Box 868, Lake City, FL
32056, 386-754-5419

DIMENSIONS:
Stated dimensions supersede scaled
dimensions. Refer all questions to
Mark Disosway, P.E. for resolution.
Do not proceed without clarification.

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his common law copyrights and property right in
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form or manner without first the express written
permission and consent of Mark Disosway.

CERTIFICATION: I hereby certify that I have
examined the plan, and that the applicable
portions of the plan, relating to wind engineering
comply with section R301.2.1, Florida building
code residential 2004, to the best of my
knowledge.

LIMITATION: This design is valid for one
building, at specified location.

MARK DISOSWAY
P.E. 53815

Mark Disosway
2/16/06
SEAL

Jonathan Perry

Spec House
Lot 17
Stonehenge S/D Phase II

ADDRESS:
Lot 17 Stonehenge S/D
Phase II Columbia County, Florida

Mark Disosway P.E.
P.O. Box 868
Lake City, Florida 32056
Phone: (386) 754 - 5419
Fax: (386) 269 - 4871

PRINTED DATE:
February 21, 2006

DRAWN BY: STRUCTURAL BY:
David Disosway

FINALS DATE:
21 / Feb / 06


JOB NUMBER:
602072

DRAWING NUMBER
S-2

OF 3 SHEETS

REVISIONS	

SCFPLAN
ARCHITECTURAL DESIGN SOFTWARE

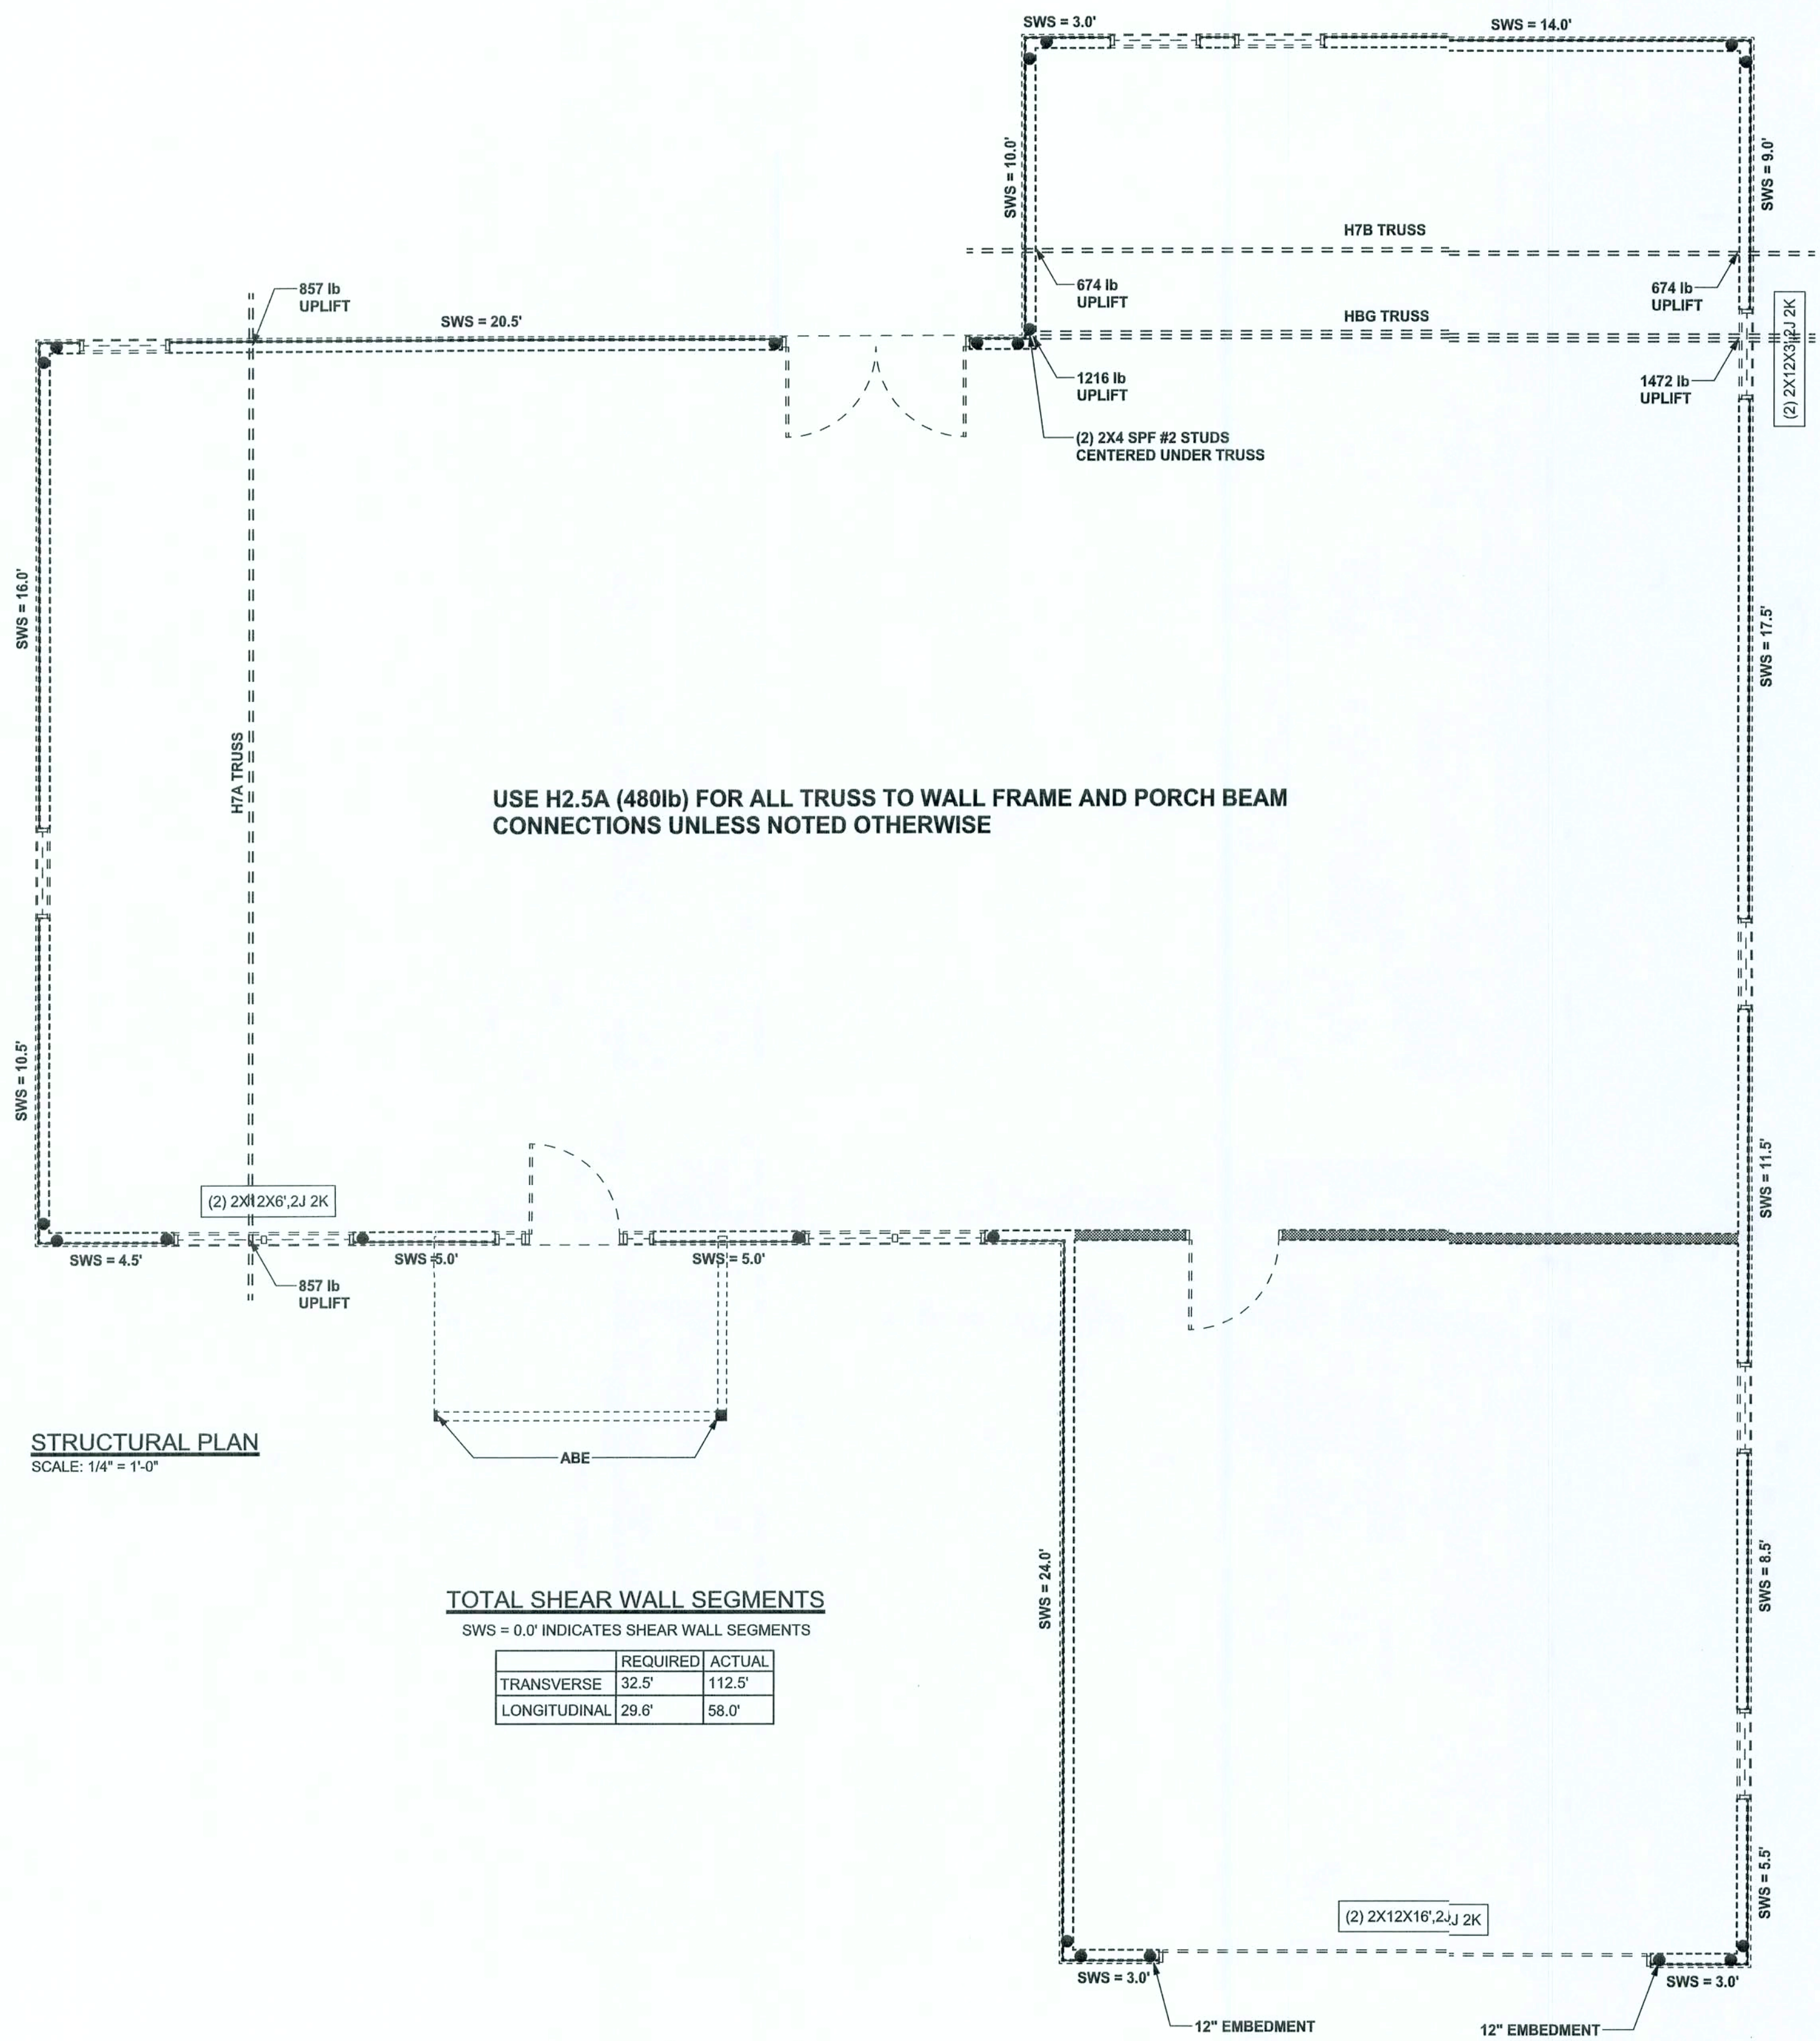

STRUCTURAL PLAN
SCALE: 1/4" = 1'-0"

TOTAL SHEAR WALL SEGMENTS
SWS = 0.0' INDICATES SHEAR WALL SEGMENTS

	REQUIRED	ACTUAL
TRANSVERSE	32.5'	112.5'
LONGITUDINAL	29.6'	58.0'

STRUCTURAL PLAN NOTES

- SN-1 ALL LOAD BEARING FRAME WALL & PORCH HEADERS SHALL BE A MINIMUM OF (2) 2X12 SYP#2 (U.O.)
- SN-2 ALL LOAD BEARING FRAME WALL HEADERS SHALL HAVE (1) JACK STUD & (1) KING STUD EACH SIDE (U.N.O.)
- SN-3 DIMENSIONS ON STRUCTURAL SHEETS ARE NOT EXACT. REFER TO ARCHITECTURAL FLOOR PLAN FOR ACTUAL DIMENSIONS
- SN-4 PERMANENT TRUSS BRACING IS TO BE INSTALLED AT LOCATIONS AS SHOWN ON THE SEALED TRUSS DRAWINGS. LATERAL BRACING IS TO BE RESTRAINED FR BCSI-03, BCSI-B1, BCSI-B2, & BCSI-B3. BCSI-B1, BCSI-B2, & BCSI-B3 ARE FURNISHED BY THE TRUSS SUPPLIER WITH THE SEALED TRUSS PACKAGE

WALL LEGEND


SWS = 0.0' [Symbol]	1ST FLOOR EXTERIOR WALL
SWS = 0.0' [Symbol]	2ND FLOOR EXTERIOR
IBW [Symbol]	1ST FLOOR INTERIOR BEARING WALLS SEE DETAILS ON SHEET S-1
IBW [Symbol]	2ND FLOOR INTERIOR BEARING WALLS SEE DETAILS ON SHEET S-1

THREADED ROD LEGEND

- [Symbol] INDICATES LOCATION OF:
1ST FLOOR 1/2" A307 ALL THREADED ROD
- [Symbol] INDICATES LOCATION OF:
2ND FLOOR 1/2" A307 ALL THREADED ROD

HEADER LEGEND

- [Symbol] (2) 2X12X0', 1J 1K ← HEADER/BEAM CALL-OUT (U.N.O.)
- [Symbol] NUMBER OF KING STUDS (FULL LENGTH)
- [Symbol] NUMBER OF JACK STUDS (UNDER HEADER)
- [Symbol] SPAN OF HEADER
- [Symbol] SIZE OF HEADER MATERIAL
- [Symbol] NUMBER OF PLIES IN HEADER

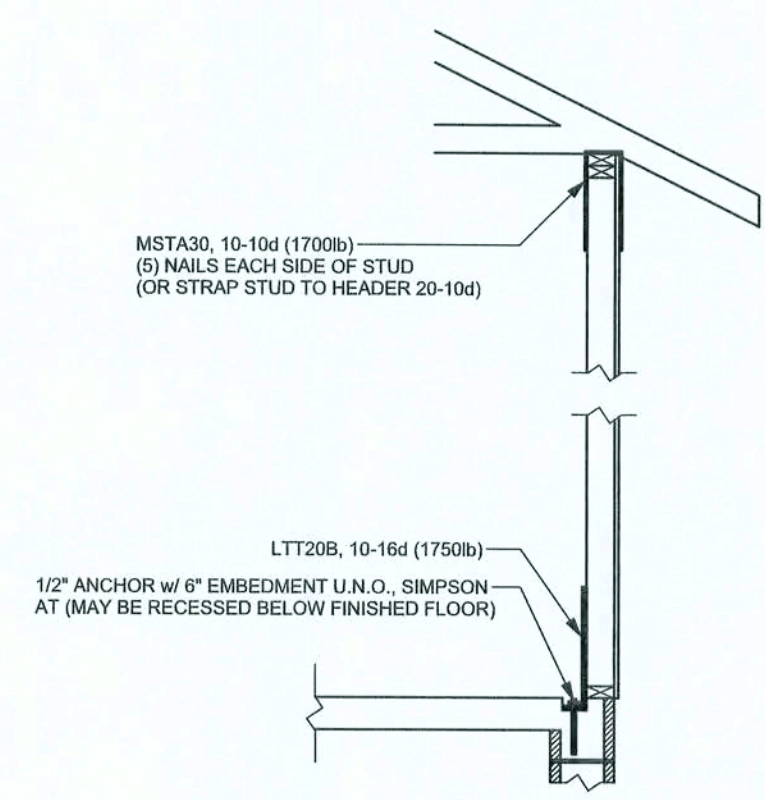

**ALTERNATE WALL TIE CONNECTION WHERE
THREADED ROD CANNOT BE PLACED IN WALL**
SCALE: 1/2" = 1'-0"

WINDLOAD ENGINEER: Mark Disosway,
P.E. No. 53915, P.O. Box 868, Lake City, FL
32056, 386-7545419

DIMENSIONS:
Stated dimensions supercede scaled dimensions. Refer all questions to Mark Disosway P.E. for resolution. Do not proceed without clarification.

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CERTIFICATION: I hereby certify that I have examined this plan, and that the applicable portions of the plan, relating to wind engineering comply with section R301.2.1, Florida building code residential 2004, to the best of my knowledge.

LIMITATION: This design is valid for one building, at specified location.

MARK DISOSWAY
P.E. 53915
[Signature]
2/16/06
SEAL

Jorathan Perry

Spec House
Lot 17
Stonehenge S/D Phase II

ADDRESS:
Lot 17 Stonehenge S/D
Phase II Columbia County, Florida

MarkDisosway P.E.
P.O. Box 868
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PRINTED DATE:
February 21, 2006

DRAWN BY: STRUCTURAL BY:
David Disosway

FINALS DATE:
21 / Feb / 06

JOE NUMBER:
602072

DRAWING NUMBER
S-3
OF 3 SHEETS

CONNECTIONS, WALL, & HEADER DESIGN IS BASED ON REACTIONS & UPLIFTS FROM TRUSS ENGINEERING FURNISHED BY BUILDER, ANDERSON TRUSS CO. (JOB #6-064)