




4605 EAST US HWY 90 LAKE CITY, FL 32025
PHONE: 386.965.9000 EMAIL: LANCHET@UFL.EDU

COVER SHEET

PROJECT NO.	G010
DATE	
ITEM NO.	3720426CPA
ITEM DATE	01/16/2022

CAMBRIDGE PREP ACA FOR CONSTRUCTION PLANS

Sheet List Table	
Sheet Number	Sheet Title
G010	COVER SHEET
C010	GENERAL NOTES
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C200	PAVING, GRADING & DRAINAGE PLAN
C201	PAVING, GRADING & DRAINAGE DETAILS
C300	STORMWATER MANAGEMENT PLAN
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C402	PIPE RESTRAINT SCHEDULE
C403	GRINDER PUMP LIFT STATION
C500	FOOT DRIVEWAY CONNECTION
C600	LIFE SAFETY PLAN

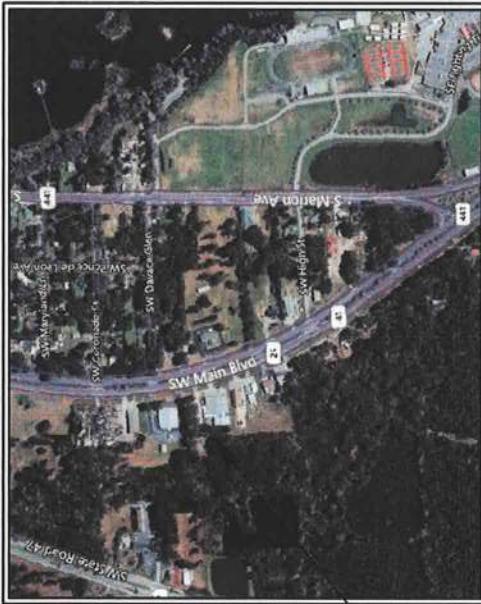

PROJECT LOCATION -

PLANS PREPARED FOR:
CAMBRIDGE PREP ACADEMY
2658 SW MAIN BLVD
LAKE CITY, FL, 32025
(386) 365-0837
JACKIEBRITT@MSN.COM

PERMIT DOCUMENTS
NOT FOR CONSTRUCTION




CAMBIDGE PREP ACADEMY
GENERAL NOTES
COLUMBIA COUNTY, FL



ENGINEERING & CONSULTING, LLC
4605 SE 87TH AVE HWY 99 LAKE CITY, FL 32025
PHONE: 386.965.9000 EMAIL: LANDGE@UFL.EDU

CAMBRIDGE PREP ACADEMY
EROSION CONTROL PLAN
COLUMBIA COUNTY, FL

PROJECT NO	SHLEI NO
J278876CPA	C020
REQUEST DATE	
08/04/2022	

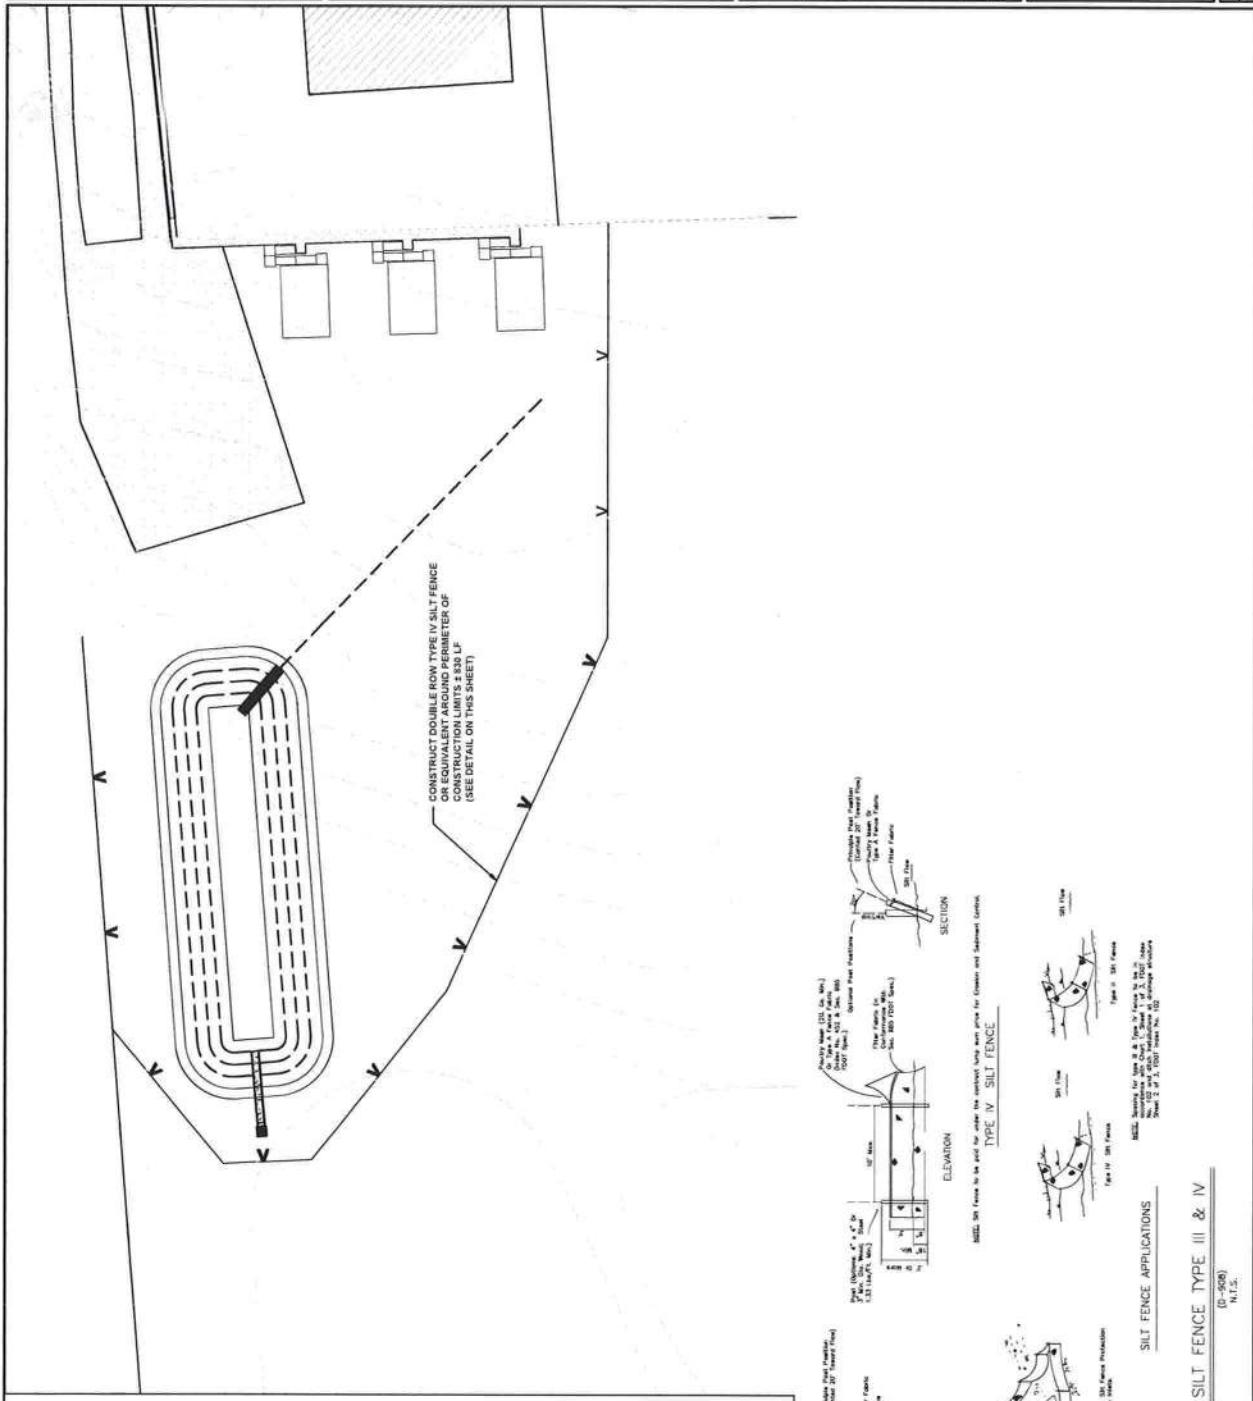

SECTION 10 | Page 163

- (1) THRU BROOK AND EUDIMENTATION CONTROL, FLAT CORRIDOR IN ACCORDANCE WITH THE REQUIREMENTS OF THE "FLORIDA DEVELOPMENT MANUAL" AND THE "FLORIDA BROWNS AND SEDIMENT CONTROL ASSOCIATION'S MANUAL".

(2) THE CONTRACTOR SHALL ASURE TO COLUMBIA COUNTY, SHINING AND SEDIMENT CONTROL, THAT THE CONTRACTOR WILL NOT OR CHANGES THIS PLAN TO A MORE EFFECTIVE CONTROL, BROUDN AND SEDIMENTATION CONTROL. THE CONTRACTOR SHALL BEAR ALL EXPENSES INCURRED BY THE FLORIDA BROWNS AND SEDIMENT CONTROL ASSOCIATION FOR MAINTAINING THIS CONTRACT.

(3) THE CONTRACTOR SHALL APPROVE THIS PLAN TO MEET ACTUAL FIELD CONDITIONS, ANY REVISIONS MADE AFTER CONSTRUCTION IS COMPLETE, ALL STRUCTURES SHALL BE REMOVED BY THE REVIEWING AGENCIES.

(4) SEGMENT AND EUDIMENT CONTROL FACILITIES, STORM DRAINAGE FACILITIES AND DEFENSIVE WALLS SHALL BE INSTALLED RIGHT TO OTHER CONSTRUCTION, REQUIRED TO CONTROL EUDIMENTATION.

(5) EUDIMENT CONTROL MEASURES SHALL BE INSPECTED WEEKLY, AND AFTER EACH RAINFALL AND REFACED AS NECESSARY.

(6) SEGMENT AND EUDIMENT CONTROL MEASURES SHALL NOT BE REMOVED UNTIL ALL CONSTRUCTION IS COMPLETE AND UNTIL A PERMANENT GROUND COVER HAS BEEN ESTABLISHED.

(7) ALL OPEN DRIPPING SWALES SHALL BE GRASSED AND RIPRAP SHALL BE PLACED AS REQUIRED TO CONTROL EUDIMENT.

(8) TALL FENCE SHALL BE LOCATED ON SITE TO PREVENT SEDIMENT AND EUDIMENT FROM BEING PRESENT ON SITES.

(9) 1. CONTRACTOR SHALL PLACE A DOUBLE ROW OF SILT FENCE IN AREAS WHERE RIPROOF IS USED IN SITUATED AREAS MAY ENTER WETLANDS.

2. DURING CONSTRUCTION AND AFTER CONSTRUCTION IS COMPLETE, ALL STRUCTURES SHALL BE REMOVED BY THE REVIEWING AGENCIES AND EXCESS SEAMENT.

3. ALL SLOPES STEEPER THAN 3:1 SHALL BE ADDED PROTECITON IN AREAS OF EUDIMENTATION.

4. ALL EUDIMENTATION PRACTICES SHALL BE INITIATED AS SOON AS PRACTICABLE IN AREAS OF EUDIMENTATION.

5. ALL EUDIMENTATION ACTIVITIES SHALL BE TEMPORARILY OR PERMANENTLY STOPPED OR REMOVED IF THE JOB WHERE CONSTRUCTION ACTIVITIES ARE LEFT UNPROTECTED FOR MORE THAN SEVEN DAYS.

6. ALL WASTE GENERATED ON THE PROJECT SHALL BE DISPOSED OF BY THE CONTRACTOR IN AN APPROPRIATE MANNER AS ACCEPTED.

7. EUDIMENT DIRT SHALL BE REMOVED DAILY.

8. EUDIMENT DIRT SHALL BE COVERED WITH TARPS.

9. NO LOADED HAUL TRUCKS SHALL BE COVERED WITH TARPS.


Date Created: May 11, 2022 Date Last Saved: June 16, 2022 Date Printed: June 16, 2022




CAMBRIDGE PREP ACADEMY
EXISTING CONDITIONS
COLUMBIA COUNTY, FL

STAFF DATE	NO. DESIGNATION	REASON FOR SURVEY
MANAGERS	NO. DESIGNATION	REASON FOR SURVEY
DESIGNERS	NO. DESIGNATION	REASON FOR SURVEY
STRUCTURAL	NO. DESIGNATION	REASON FOR SURVEY
MECHANICAL	NO. DESIGNATION	REASON FOR SURVEY
ELECTRICAL	NO. DESIGNATION	REASON FOR SURVEY
PLANT	NO. DESIGNATION	REASON FOR SURVEY
ENVIRONMENTAL	NO. DESIGNATION	REASON FOR SURVEY
STRUCTURAL	NO. DESIGNATION	REASON FOR SURVEY
MECHANICAL	NO. DESIGNATION	REASON FOR SURVEY
ELECTRICAL	NO. DESIGNATION	REASON FOR SURVEY
PLANT	NO. DESIGNATION	REASON FOR SURVEY
ENVIRONMENTAL	NO. DESIGNATION	REASON FOR SURVEY

CHIEF ENGINEER	DATE
CO 30	DATE

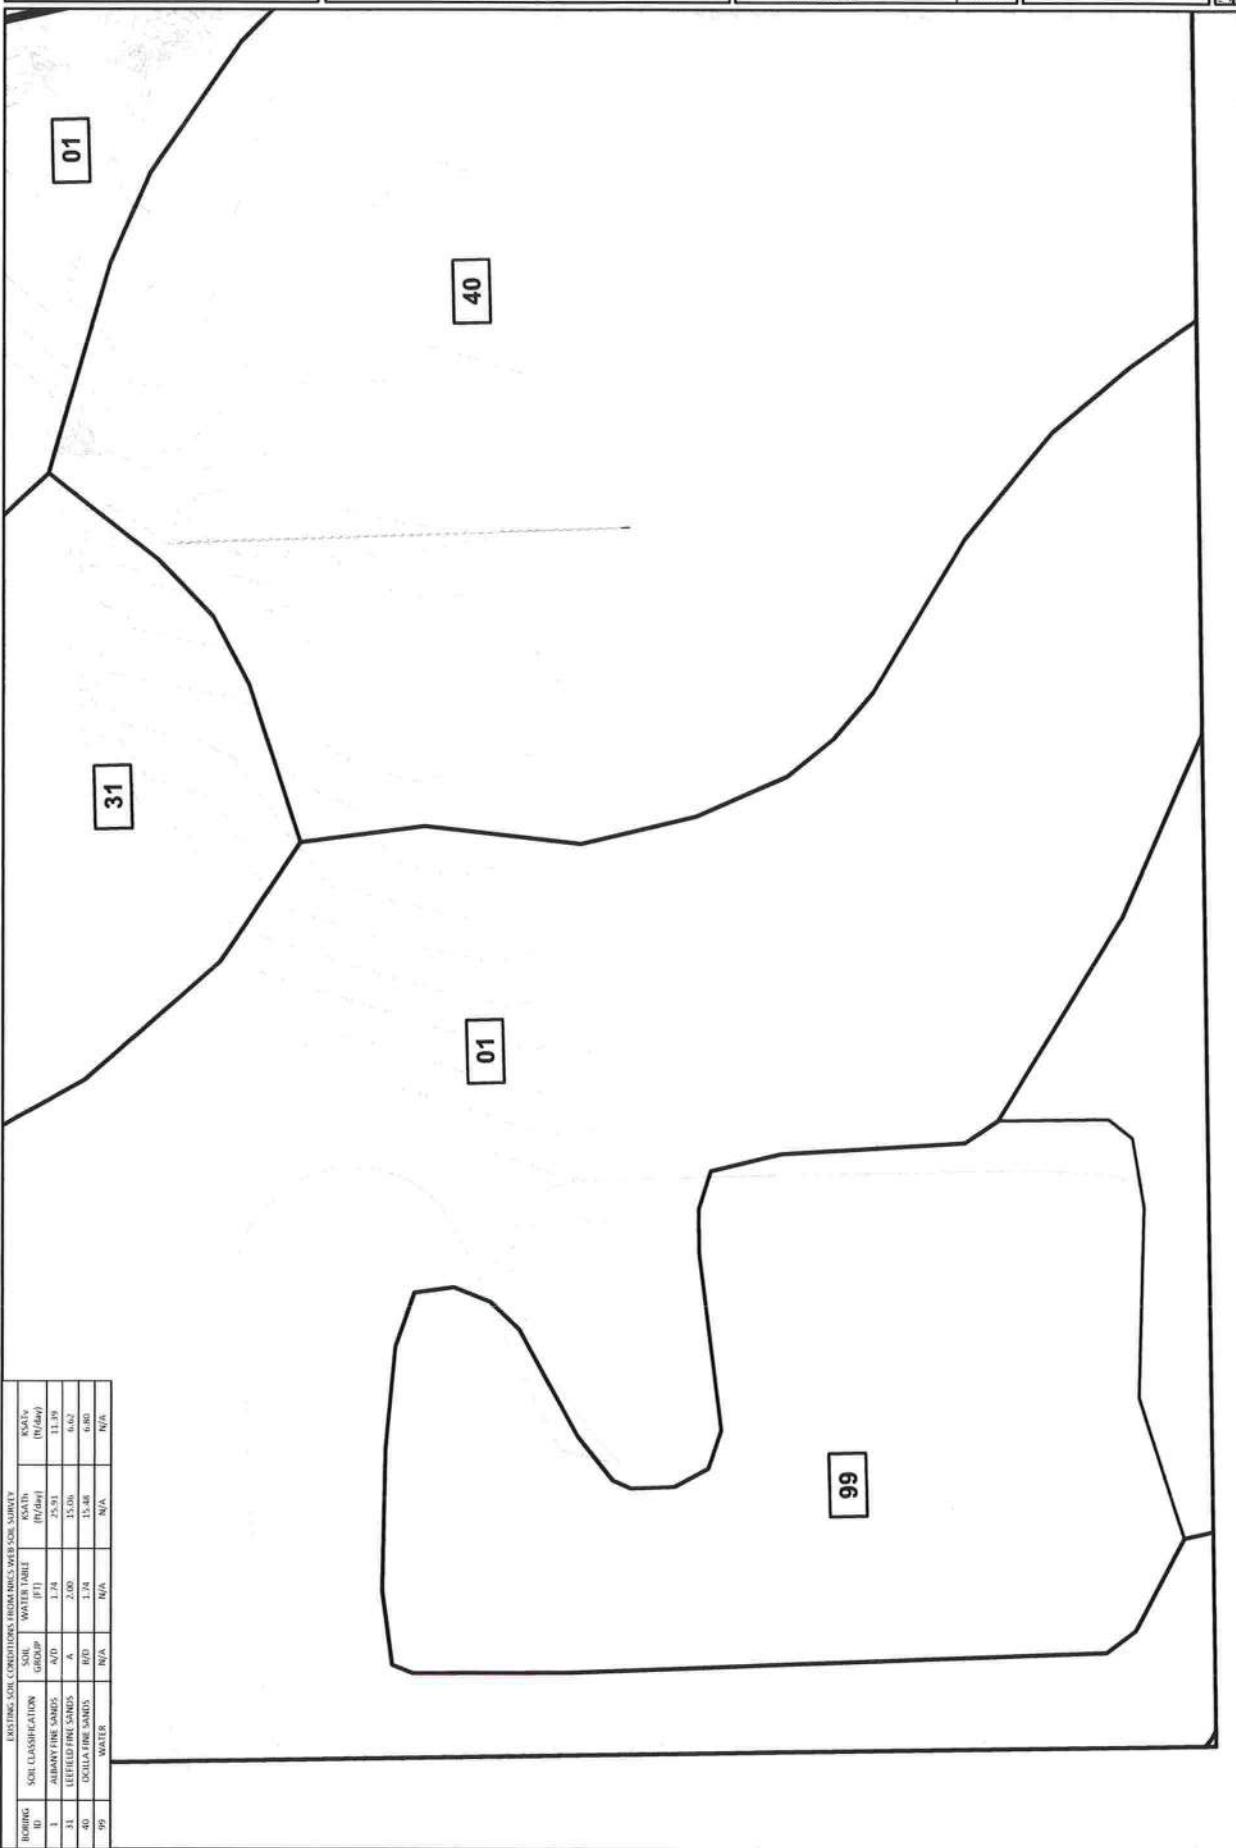

NES		ENGINEERING & CONSULTING, LLC PHONE: 386.965.9000 FAX: 386.965.9005
OVERALL DEVELOPMENT PLAN CAMBRIDGE PREP ACADEMY COLUMBIANA COUNTY, FL		
STREET NAME ADDRESS	200 SW MAIN RD, LANE CITY, FL 32055	
ZONING	C-1 COMMERCIAL	
LAND USE	GENERAL	
SETHACKS	ACREAGE	SIZE
DENSITY (UNITS PER ACRE)	20	15
STRUCTURE	ACREAGE	SIZE
DESCRIPTION	RESIDENTIAL	
MIN. LOT SIZE / ACRE	N/A	
MIN. LOT WIDTH	N/A	
MIN. LOT DEPTH	N/A	
MIN. LOT AREA	N/A	
FLOOR/CEILING AREA	1,000	
MAX. APPROXIMATE SURFACE	N/A	
MAX. HEIGHT OF STRUCTURES	15' MAX	
MIN. LIVABLE AREA (ZONING REQUIREMENT)	N/A	
LOT GEOMETRY		
PROPERTY A (EAS)	SIZE (ACRES)	% OF PROJECT
PROPERTY B (EAS)	0.01227	1.14%
PROPERTY C (EAS)	0.01227	1.14%
PROPERTY D (EAS)	0.01227	1.14%
PROPERTY E (EAS)	0.01227	1.14%
PROPERTY F (EAS)	0.01227	1.14%
PROPERTY G (EAS)	0.01227	1.14%
PROPERTY H (EAS)	0.01227	1.14%
PROPERTY I (EAS)	0.01227	1.14%
PROPERTY J (EAS)	0.01227	1.14%
PROPERTY K (EAS)	0.01227	1.14%
PROPERTY L (EAS)	0.01227	1.14%
PROPERTY M (EAS)	0.01227	1.14%
PROPERTY N (EAS)	0.01227	1.14%
PROPERTY O (EAS)	0.01227	1.14%
PROPERTY P (EAS)	0.01227	1.14%
PROPERTY Q (EAS)	0.01227	1.14%
PROPERTY R (EAS)	0.01227	1.14%
PROPERTY S (EAS)	0.01227	1.14%
PROPERTY T (EAS)	0.01227	1.14%
PROPERTY U (EAS)	0.01227	1.14%
PROPERTY V (EAS)	0.01227	1.14%
PROPERTY W (EAS)	0.01227	1.14%
PROPERTY X (EAS)	0.01227	1.14%
PROPERTY Y (EAS)	0.01227	1.14%
PROPERTY Z (EAS)	0.01227	1.14%
POST-DEVELOPMENT SITE CONDITIONS FOR DRAINAGE DESIGN		
OPEN SPACE	1,589	27%
POST-DEVELOPMENT SITE CONDITIONS FOR DRAINAGE DESIGN	1,589	
BUILDINGS & RAMP	1,017	0.57%
CLOSED SIDEWALK	1,017	0.27%
MALTED DRIVE	1,017	1.14%
TOTAL IMPROVED DIMENSIONS	4,056	4.48%
WATER (OTR 44-4)	1,017	0.05%
WATER (OTR 44-4)	4,056	1.07%

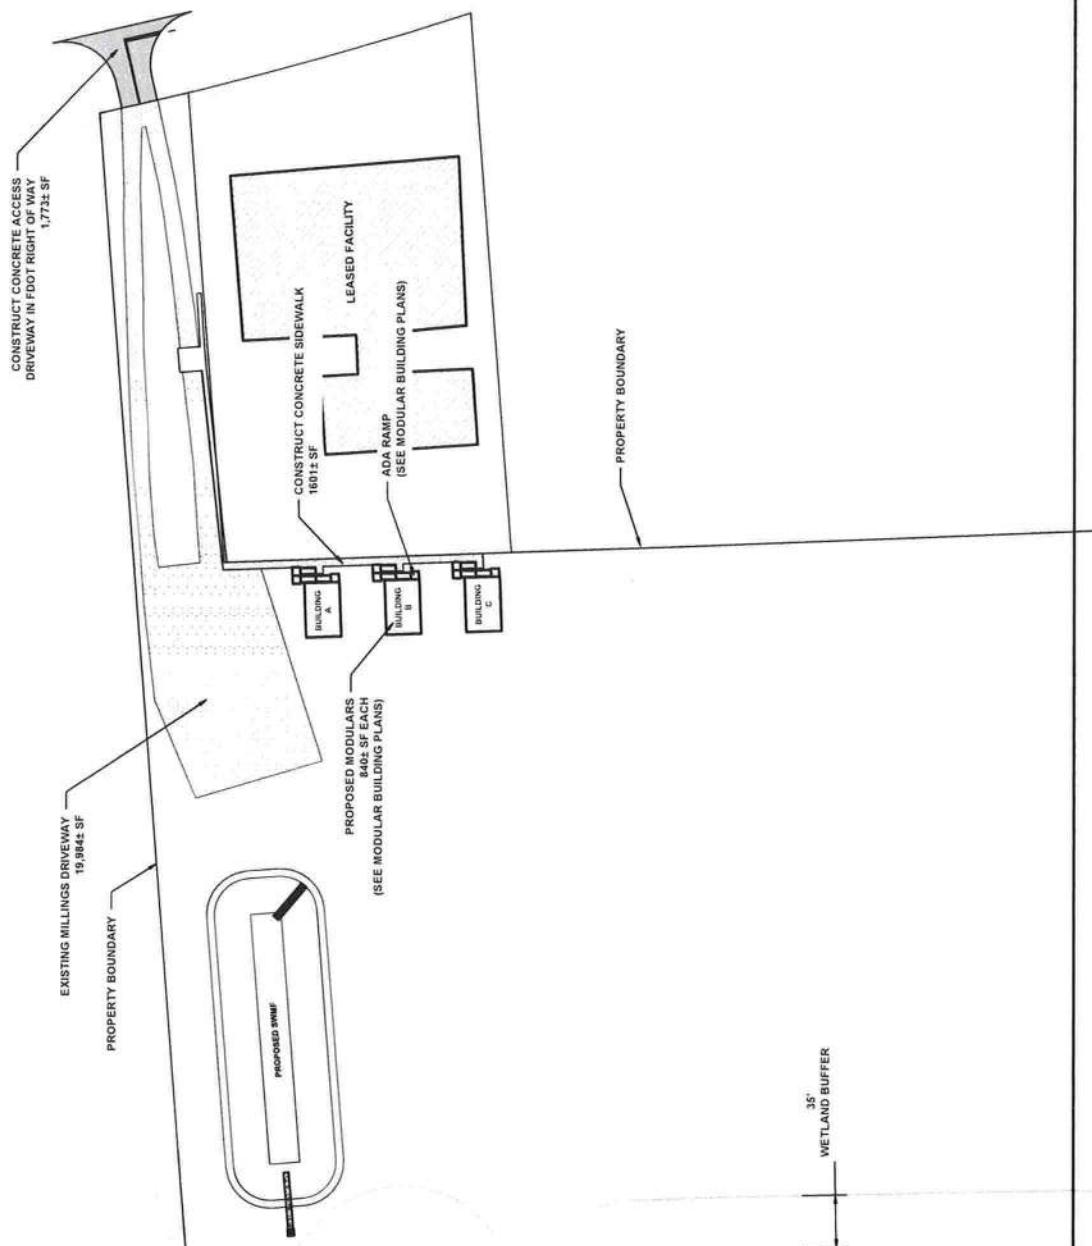




ENGINEERING & CONSULTING, LLC
4605 EAST US HWY 30 LAKE CITY, FL 32055
PHONE: 386.965.9000 EMAIL: LAKECITY@JONES.EDU

CAMBRIDGE PREP ACADEMY
GEOMETRIC PLAN
COLUMBIA COUNTY, FL

STRUCTURE NO. DATE DESIGNATION DRAWING NUMBER


L1			
L2			
L3			
L4			
L5			

CONTRACTOR / OWNER
PERMIT
DRAWN BY
APPROVED BY
FILE NO.
C-100
SHEET NO.
1 OF 1

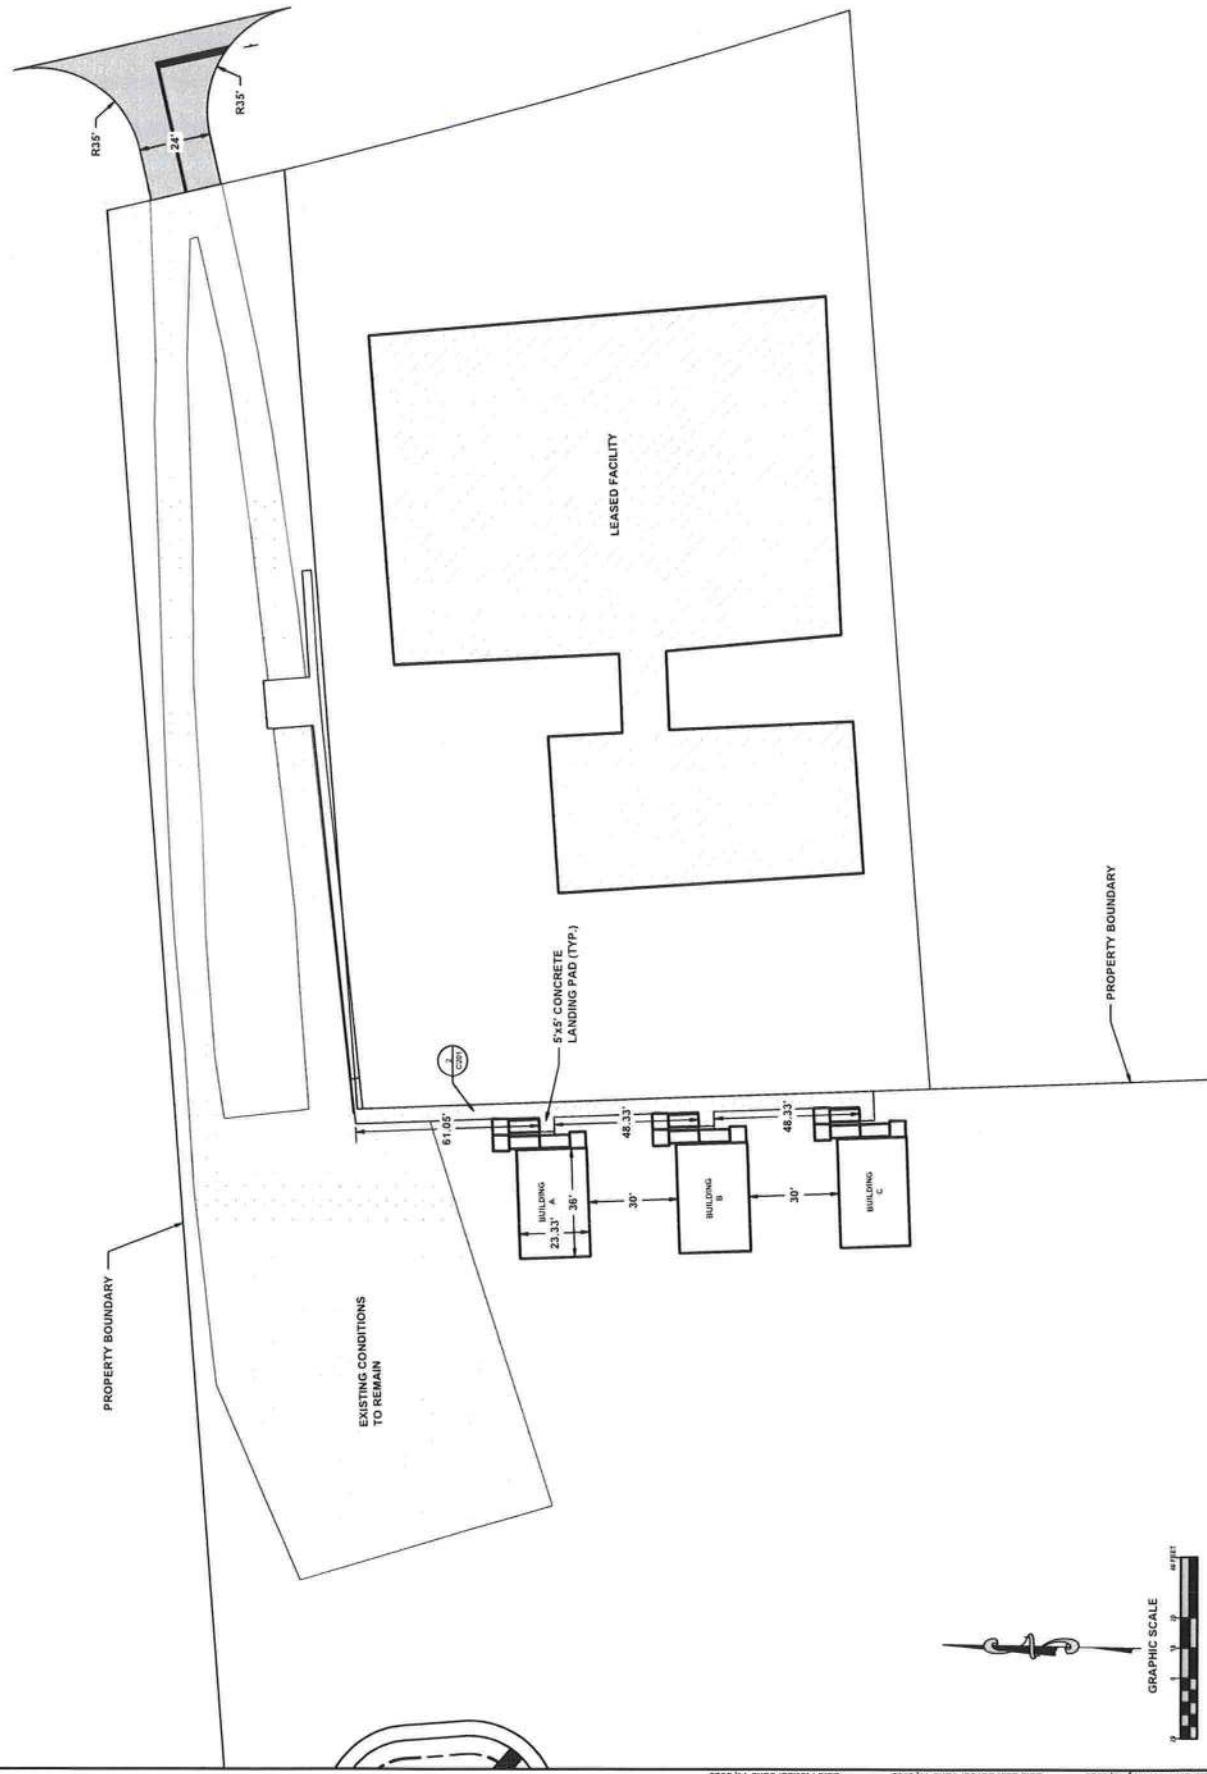

STORY DATE	NO.	DATE	DESIGNER	REVISION NUMBER

CONTRACTOR'S NAME	DATE

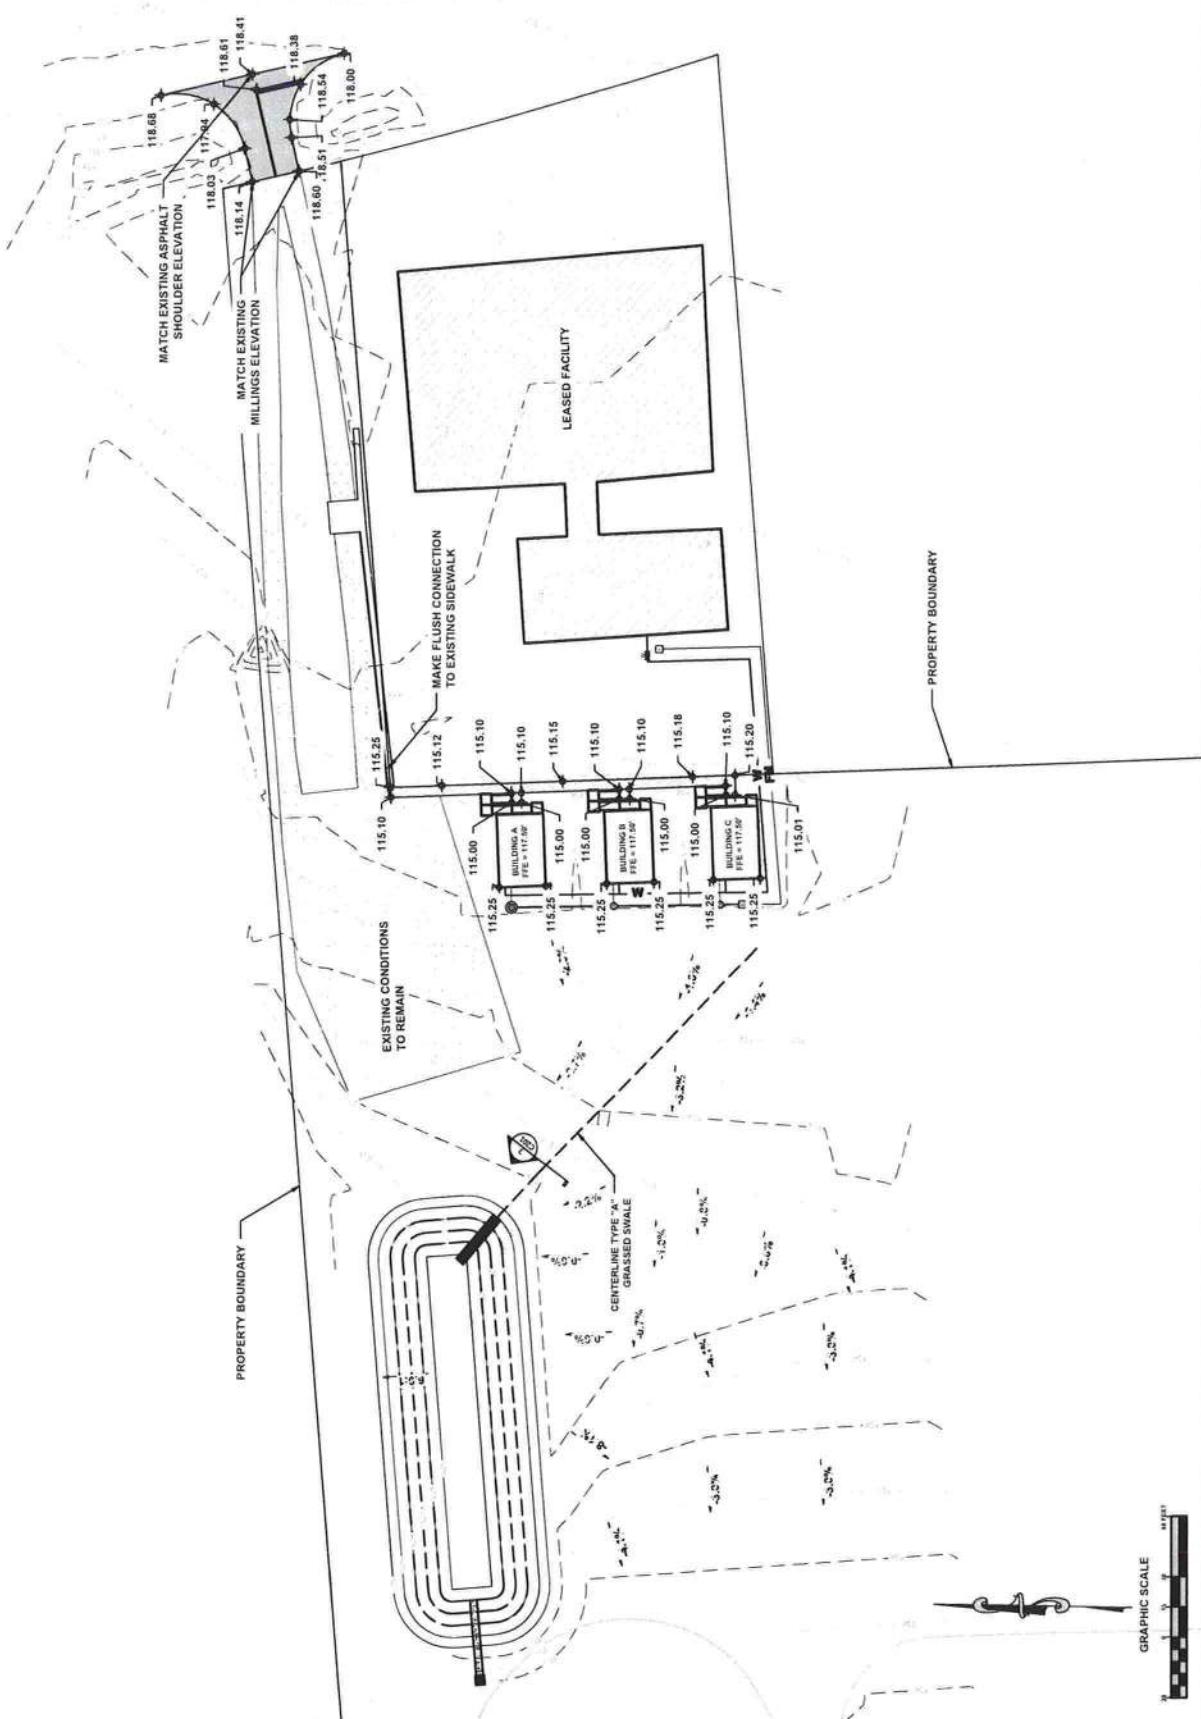





PAVING, GRAZING & DRAINAGE DETAILS
CAMBRIDGE PREP ACADEMY
COLUMBIA COUNTY, FL

STAKE DATE	DATE DESIGNATED
CHANGES IN	REVISED
QUANTITY	AMOUNT
ITEM	DESCRIPTION
UNIT	UNITS


CHARTERED - ONE PER SHEET
2022
C201

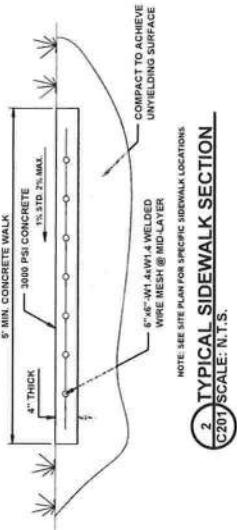

2 TYPICAL SIDEWALK SECTION
C201 SCALE: N.T.S.

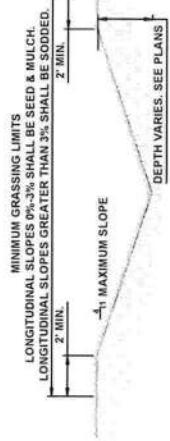

3 TYPE "A" GRASSED SWALE
C201 SCALE: N.T.S.

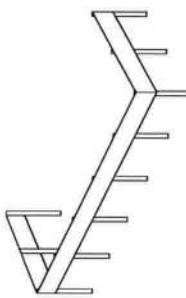

ENVRO-FPM
FIBERGLASS
POST MOUNT SKIMMER

DESCRIPTION:
SIDE WING LENGTH (SWL) X FRONT WIDTH (FW)
SIDE WING LENGTH (SWL) @ ANGLE DEGREE X
BLADE HEIGHT (BH)

EXAMPLE: FPM 24X7X24 @ 30° X 3.5 HIGH
STRUCTURAL POST:
FIBRE POST - 2" 1/2" SQ. X 1/4" WALL X LENGTH
FIBRE POST - 3" 5/8" SQ. X 1/4" WALL X LENGTH
ALUMINUM POST - 2" RND. X 1/8" WALL X LENGTH
ALUMINUM POST - 3" RND. X 1/8" WALL X LENGTH
GALV. STEEL POST - 2" RND. X 5/16" WALL X LENGTH


OTHER POST AVAILABLE BASED ON ENGINEER'S
STRENGTH REQUIREMENTS

MATERIAL:
ENVRO GLASHIMER STRUCTURAL FRP AS
SUPPLIED BY ENVIRONMENTAL COMPOSITES INC.
TAVARES, FL 32778 PHONES: 352-343-3449
3/4" OR 1" THICK BASED ON ENGINEERS
PERFORMANCE REQUIREMENTS. FOR MORE
INFORMATION SEE MATERIAL SPEC SHEET

COLOR:
DISAPPEARING GREEN

INSTALLATION HARDWARE:
5/16"-5/8" HEX HEAD BOLTS/WNLOCK NUTS

- DESIGN NOTES:
1. OIL SKIMMER EXTENDS FROM SIX INCHES BELOW WEIR INVERT
2. TWO WINGS ARE TO BE INSTALLED IN LINE WITH THE CONTROL STRUCTURE
3. THE OUTSIDE DIMENSION ACROSS THE FRONT OF THE STRUCTURE
4. THE LOCATION OF THE REINFORCING STEEL IN THE SPILLWAY
MUST CONFORM TO THE APPLICABLE STANDARDS TO AVOID
CONFLICT WITH THE EXPANSION ANCHORS USED TO ATTACH THE
SKIMMER.

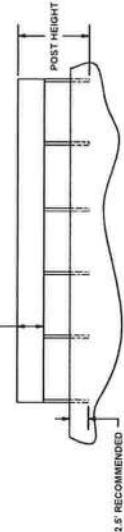

1 FREE STANDING POSTMOUNT ENVIRO GLASKIMER DETAIL
C201 SCALE: N.T.S.




PHONE: 386.965.9000 EMAIL: NELAND@NLT.COM
ADDRESS: 4605 EAST US HWY 95, LAKE CITY, FL 32055

STORMWATER MANAGEMENT PLAN
CAMPBELL COUNTY, FL
STORMWATER PREP ACADEMY

ST DATE	DATE	DESCRIPTION	REV/EDITION

PROJECT NO.	REF ID:
C300	FS4202
ENTRANCE LANE	SECTION LINE

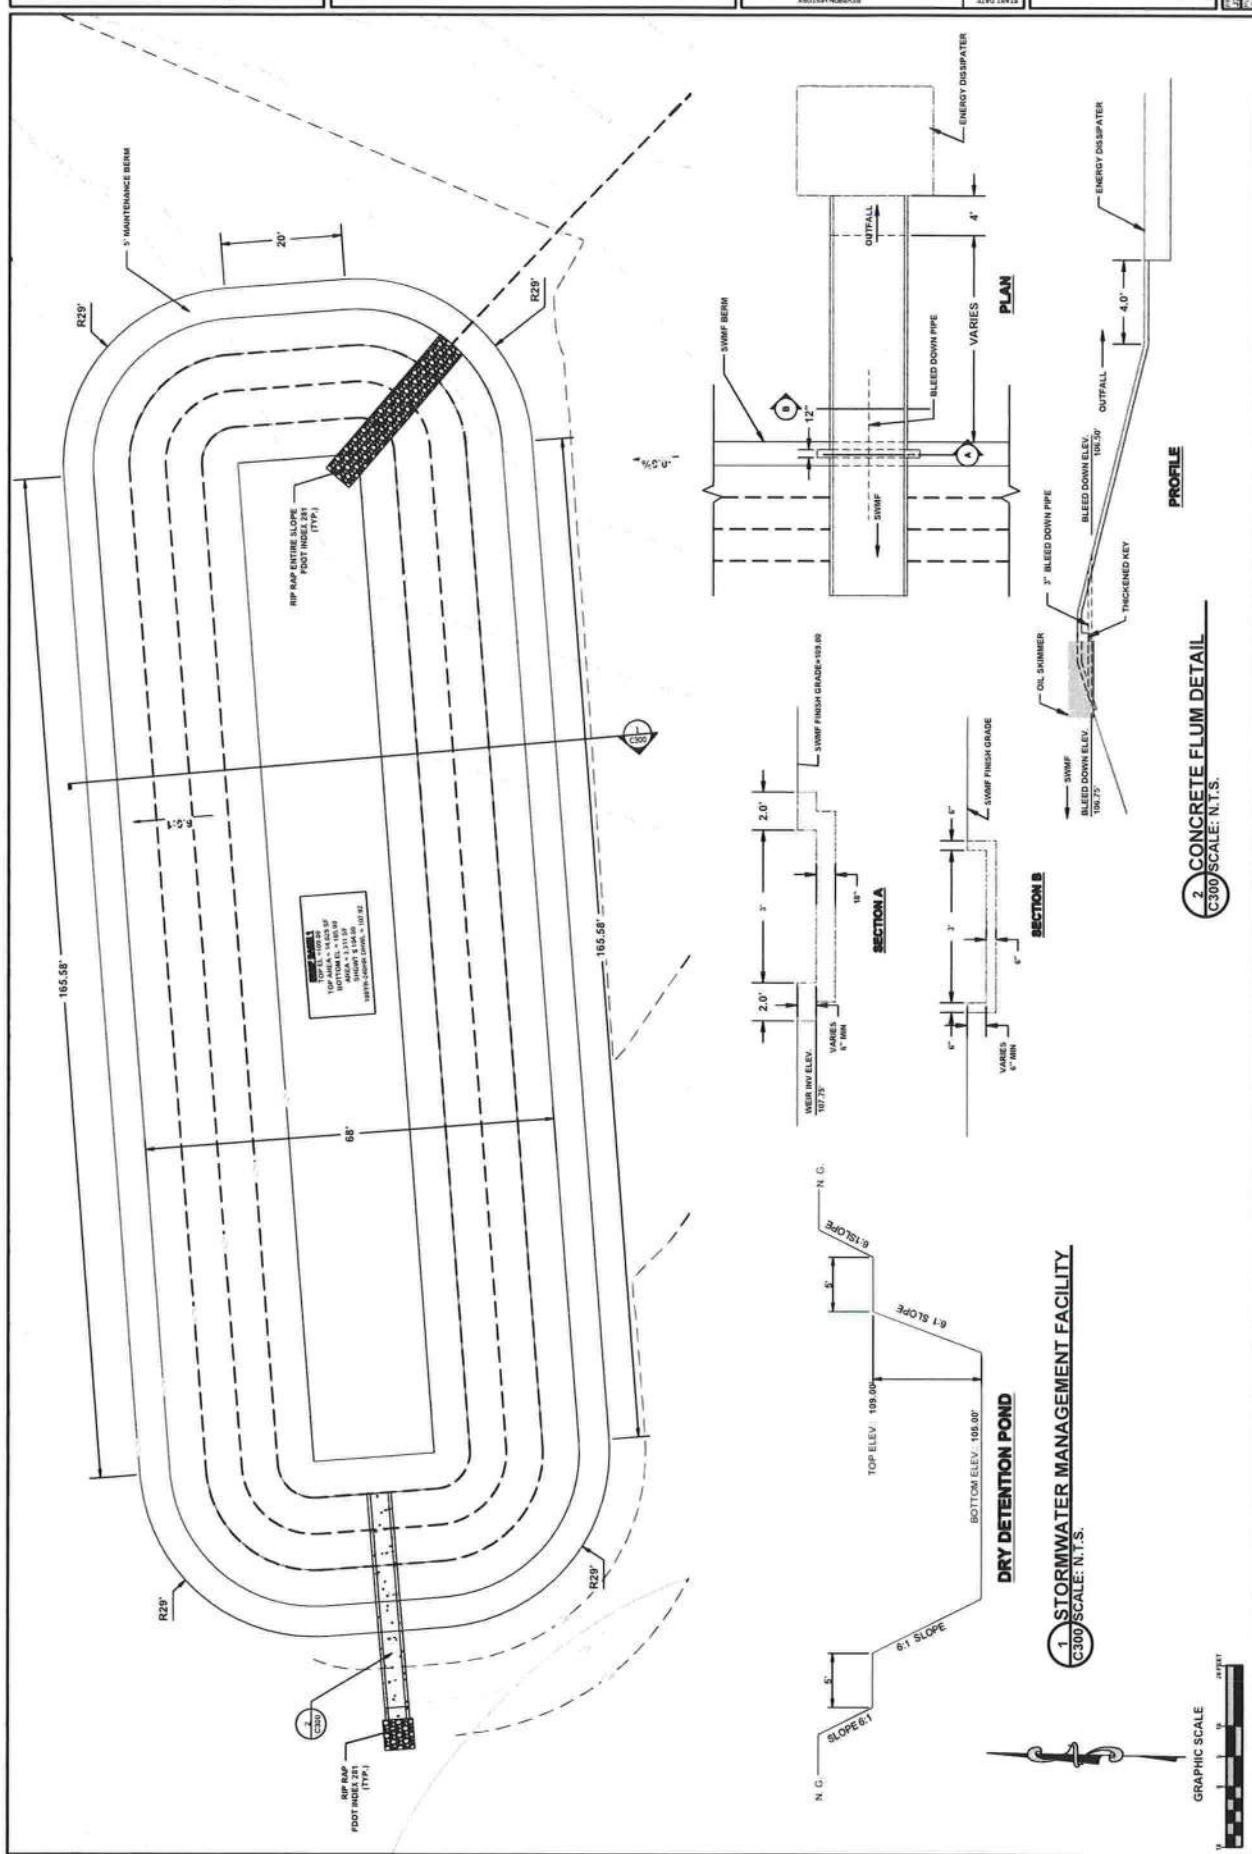





CAMBRIDGE PREP ACADEMY
UTILITY PLANS
COLUMBIA COUNTY, FL

STREET NAME	NO.	DATE	DESIGNATION	MEASUREMENTS
DRIVEWAY				

CONTINUATION OF SHEET NO.	1
FILE NUMBER	A400
DATE DRAWN	JUN 14 2022

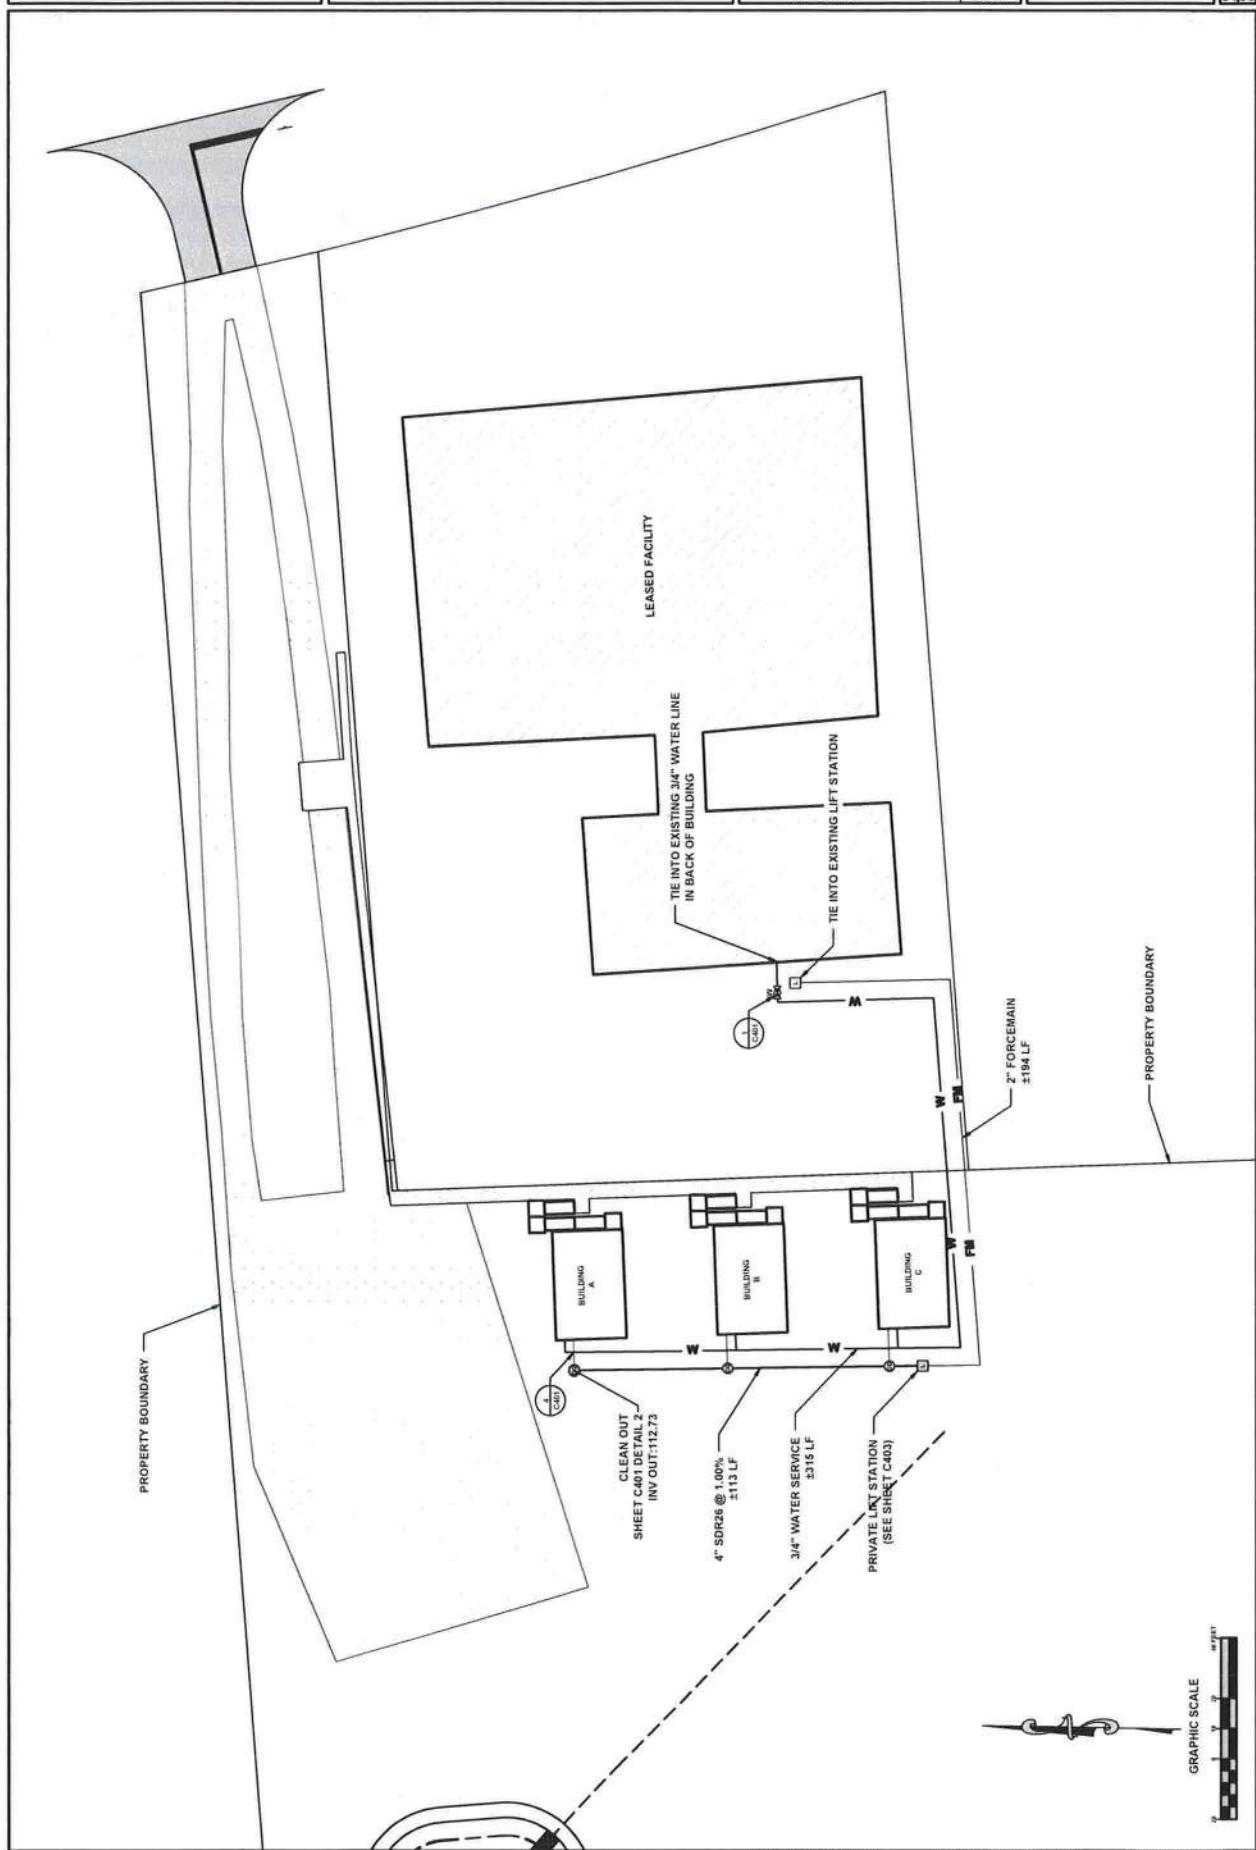





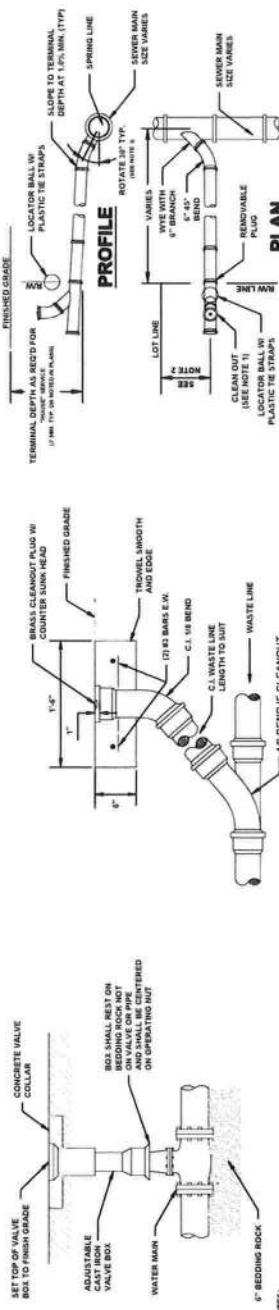

1 VALVE & BOX DETAIL
 C401 SCALE: N.T.S.

2 CLEAN OUT DETAIL
 C401 SCALE: N.T.S.

4 PIPE CONFLICT DETAIL
 C401 SCALE: N.T.S.

3 SANITARY SEWER SERVICE LATERAL
 C401 SCALE: N.T.S.

5 WATER/SEWER SEPARATION DETAIL
 C401 SCALE: N.T.S.

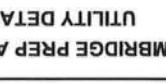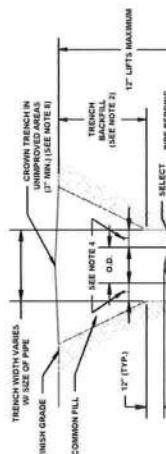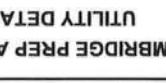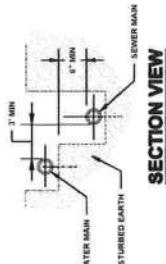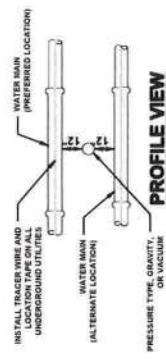6 TRENCH & BACKFILL DETAIL
 C401 SCALE: N.T.S.




PHONE: 386.965.9000 EMAIL: LANCASTER@FLUTTER.COM
4605 EAST US HWY 90 LAKE CITY, FL 32025

CAMBRIDGE PREP ACADEMY
PIPE RESTRAINT SCHEDULE
COLUMBIA COUNTY, FL

REDUCERS	TEES (NOTE 5)					
	RUN SIZE [IN.]	HORIZONTAL BENDS	VERTICAL OFFSETS	VALVES OR DEAD-ENDS	SIZE [FT.]	RUN BRANCH SIZE [FT.]
NOMINAL PIPE SIZE	90° BENDS L. [FT.]	45° BENDS L. [FT.]	22.5° BENDS L. [FT.]	11.25° BENDS L. [FT.]	45° BENDS (SEE NOTE 4)	RUN BRANCH SIZE [FT.]
4	20	8	4	2	20	3
6	28	10	5	2	28	4
8	36	14	6	3	36	5
10	40	18	8	4	45	6
12	50	20	9	4	52	8
14	56	23	10	5	60	9
16	60	26	11	6	67	10
18	69	29	12	6	74	12
20	75	32	13	7	80	13
24	76	33	15	7	81	14
30	88	36	18	9	97	16
36	100	40	20	10	110	20
42	115	48	23	11	125	24
48	125	52	25	12	140	30
					340	20"
					20"	16"
					12"	12"
					10"	10"
					8"	8"
					6"	6"
					4"	4"

PVC PIPE RESTRAINT NOTES:

1. THIS SCHEME SHALL BE UTILIZED ON ALL WATER, SEWER FORCE MAIN OR RECLAIMED WATER SYSTEMS. ALL FITTINGS SHALL BE RESTRAINED TO LENGTHS INDICATED ON THE ABOVE SCHEDULE, AT A MINIMUM, UNLESS OTHERWISE INDICATED. ALL REQUIRED RESTRAINTS SHALL BE INCLUDED IN PRICE OF FITTING, VALVE OR PIPE.
2. ASSUMPTIONS: PVC PIPE, SAFETY FACTOR = 1.5; TEST PRESSURE = 150 PSI, SOIL = GM OR SM, TRENCH E.A. DEPTH OF COVER = 20" AND SMALLER PIPE SIZE OR 36 INCHES FOR 24" AND LARGER PIPE SIZE.
3. BENDS AND VALVES: SHALL BE RESTRAINED ON EACH SIDE OF FITTING.
4. VERTICAL OFFSETS: ARE APPROX. 3 FEET COVER ON TOP AND APPROX. 8 FEET COVER ON BOTTOM. PER THE DETAILS, LU IS THE RESTRAINED LENGTH FOR THE UPPER (TOP) LEVEL, LI IS THE RESTRAINED LENGTH FOR THE LOWER (DEEPER) LEVEL. ASSUME 45 DEGREE BENDS.
5. TEES: TOTAL LENGTH BETWEEN FIRST JOINTS OR RESTRAINED LENGTH ON EITHER SIDE OF THE RUN SHALL BE TOTAL LENGTH (MIN.) SEE SCHEDULE ABOVE FOR RESTRAINT LENGTH ON TEE - BRANCH LINE.
6. HOPE TO PVC TRANSITION: THE PVC PIPE SIDE SHALL BE RESTRAINED TO 36 FT (MIN.).
7. THE INSTALLATION OF BELL/HARNESS RESTRAINTS AT PVC JOINTS (DR-18 & 25 PIPE) SHALL BE COMPLETED PER THE MANUFACTURERS' RECOMMENDATION, WHICH INCLUDES NOT OVER-TIGHTENING THE PARALLEL RODS/NUTS. THESE NUTS SHOULD ONLY BE SNUG TIGHT. THE HOME MARKS ON THE PIPE SHOULD ALWAYS BE VISIBLE AFTER THE RESTRAINT IS INSTALLED. OVERHANGING THE JOINT MAY CAUSE A FAILURE AT THE BELL RESULTING IN A SERVICE OUTAGE.

PVC PIPE RESTRAINT NOTES:

- RECLAIMED WATER SYSTEMS, ALL FITTINGS SHALL BE RESTRAINED TO LENGTHS INDICATED ON THE ABOVE SCHEDULE. AT A MINIMUM, 1 INCH LESS, OTHERWISE INDICATED. ALL REQUIRED RESTRAINTS SHALL BE INCLUDED IN PRICE OF FITTING. VALVE OR PIPE OR SMA TRENCH TYPE, DEPTH OF COVER = 30 INCHES FOR 30° AND SMALLER PIPE, OR 36 INCHES FOR 24° AND LARGER PIPE.

2. ASSUMPTIONS: PVC PIPE, SAFETY FACTOR = 1.5, TEST PRESSURE = 150 PSL SOIL

3. BENDS AND VALVES: SHALL BE RESTRAINED ON EACH SIDE OF FITTING.

4. VERTICAL OFFSETS: ARE APPROX. 3 FEET COVER ON TOP AND APPROX. 8 FEET COVER ON BOTTOM. FOR THE DETAILS, IT IS THE RESTRAINED LENGTH ON THE (TOP) LEVEL, L IS THE RESTRAINED LENGTH FOR THE LOWER DEEPER LEVEL. (48 DEGREE BENDS).

5. TEES: TOTAL LENGTH BETWEEN FIRST JOINTS OR RESTRAINED LENGTH ON EITHER SIDE OF THE REINFORCING SHALL BE AT A TOTAL DISTANCE OF 30 FEET (MING. SEE SCHEDULE).



6. HOPE TO PVC TRANSITION: THE PVC PIPE SIDE SHALL BE RESTRAINED 35 FT (MING. SEE SCHEDULE) FOR RESTRAINT LINE TO THE BRANCH LINE.

7. THE INSTALLATION OF BELL HARNESSES RESTRAINTS AT PVC JOINTS D8-18 & 26 PVC SHALL BE COMPLETED PER THE MANUFACTURERS RECOMMENDATIONS. THESE NUTS SHOULD ONLY INCLUDES NOTICE OF TIGHTENING THE PARALLEL ROD/NUTS. THESE NUTS SHOULD ONLY BE SNUG TIGHT. THE HOME MARKS ON THE PIPE SHOULD ALWAYS BE VISIBLE. AFTER THE RESTRAINT IS INSTALLED, OVERHANGING THE PIPE MAY CAUSE A FAILURE.

NOTE 8

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THRUST BLOCK FOR TEES & PLUGS			
SIZE	SQ. FT. BEARING		
	TEE	A	B
		C	SURFACE
4"	16"	16"	18"
6"	20"	24"	18"
8"	26"	32"	18"
10"	32"	40"	18"
12"	36"	48"	24"
14"	40"	56"	24"
16"	48"	60"	24"
18"	56"	64"	24"
20"	60"	76"	24"
24"	72"	90"	24"
30"	80"	102"	24"
36"	86"	108"	24"

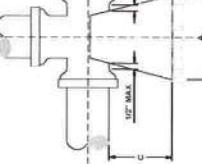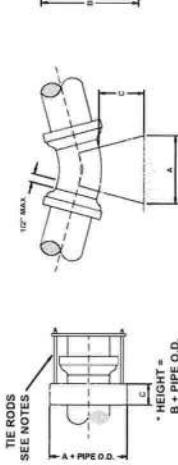

1 THRUST BLOCK SIZE CHAR:
C402 SCALE: N.T.S.






PHONE: 386.965.9000 EMAIL: LANDGEAR@URGEON.COM
4605 EAST RD HWY 90 LAKE CITY, FL 32025

CAMBRIDGE PREP ACADEMY
FDOT DRIVEWAY CONNECTION
COLUMBIA COUNTY, FL

CHRISTOPHER L. JONES
PEM 3477
DATE _____
SHEET NO. 1
C500
PROJECT NO.
2200476CPA
DATE _____

FIBER CONNECTION NOTES:

1. CONSTRUCT DRIVEWAY PIER FOOT STANDARD INDEX 330-001 FOR NEW DRIVEWAY.
 2. MATCH EXISTING ELEVATIONS FOR EDGE OF TRAVEL LANE, EDGE OF PAVEMENT, AND MILLINGS DRIVEWAY.
 3. THE EXISTING ASPHALT PAVED SHOULDER SHALL BE MECHANICALLY SAW CUT AND REMOVED AS WELL AS ALL PRE-EXISTING SUBGRADE MATERIALS WITHIN THE LIMITS OF THE PROJECT IMPROVEMENTS WORK ZONE OR AS MAY BE CALLED FOR UNDER THE STATE DOT PERMIT.
 4. ALL PERMITTED PAVEMENT STRIPPING PERTAINING TO THIS ACCESS PERMIT SHALL REQUIRE CERTIFIED LEAD FREE, THERMOPLASTIC MARKING MATERIALS AS THE FINAL PLACEMENT ITEM. TEMPORARY TRAFFIC BEARING SHALL BE REQUIRED TO BE IN PLACE 30 MINUTES BEFORE OFFICIAL SUNDOWN. TEMPORARY TRAFFIC BEARING PAINTS AND THERMOPLASTIC MARKING MATERIALS SHALL BE LEAD FREE AND SHALL MEET/CONTAIN FOO MINIMUM SPECIFICATIONS FOR NIGHT REFLECTIVITY. TEMPORARY RMWS SHALL BE INSTALLED DURING BOTH TEMPORAL AND PERMANENT STRIPPING PHASES. REMOVAL OF EXISTING STRIPPING SHALL BE HYDRO-BLASTED.
 5. FAILURE BY THE PERMITTEE AND/OR HIS/HER CONTRACTOR TO HAVE A CERTIFIED STRIPPING PLAN ON SITE BEFORE THE START OF PAVING CAN BE REASON TO SUSPEND THE APPROVED PERMIT UNTIL SUCH TIME AS THE PERMITTEE AND/OR HIS/HER CONTRACTOR CORRECTS THE SITUATION TO THE SATISFACTION OF THE ON-SITE STATE DOT PERMITS PERSONNEL/INSPECTOR.
 6. FOR MAINTENANCE OF TRAFFIC PLAN REFER TO FOOT STANDARD PLANS 102-400, 102-401, 102-402, 102-403, AND 102-425.
 7. 24 INCH STOP BARS TO BE PLACED AT ALL INTERSECTIONS IN ACCORDANCE WITH CURRENT EDITION FFOT DESIGN STANDARDS INDEX 17346.
 8. THE PERMITTEE SHALL CONTACT THE DOT PERMITS OFFICE A MINIMUM OF 48 HOURS IN ADVANCE OF THE PLANNED CONNECTION.

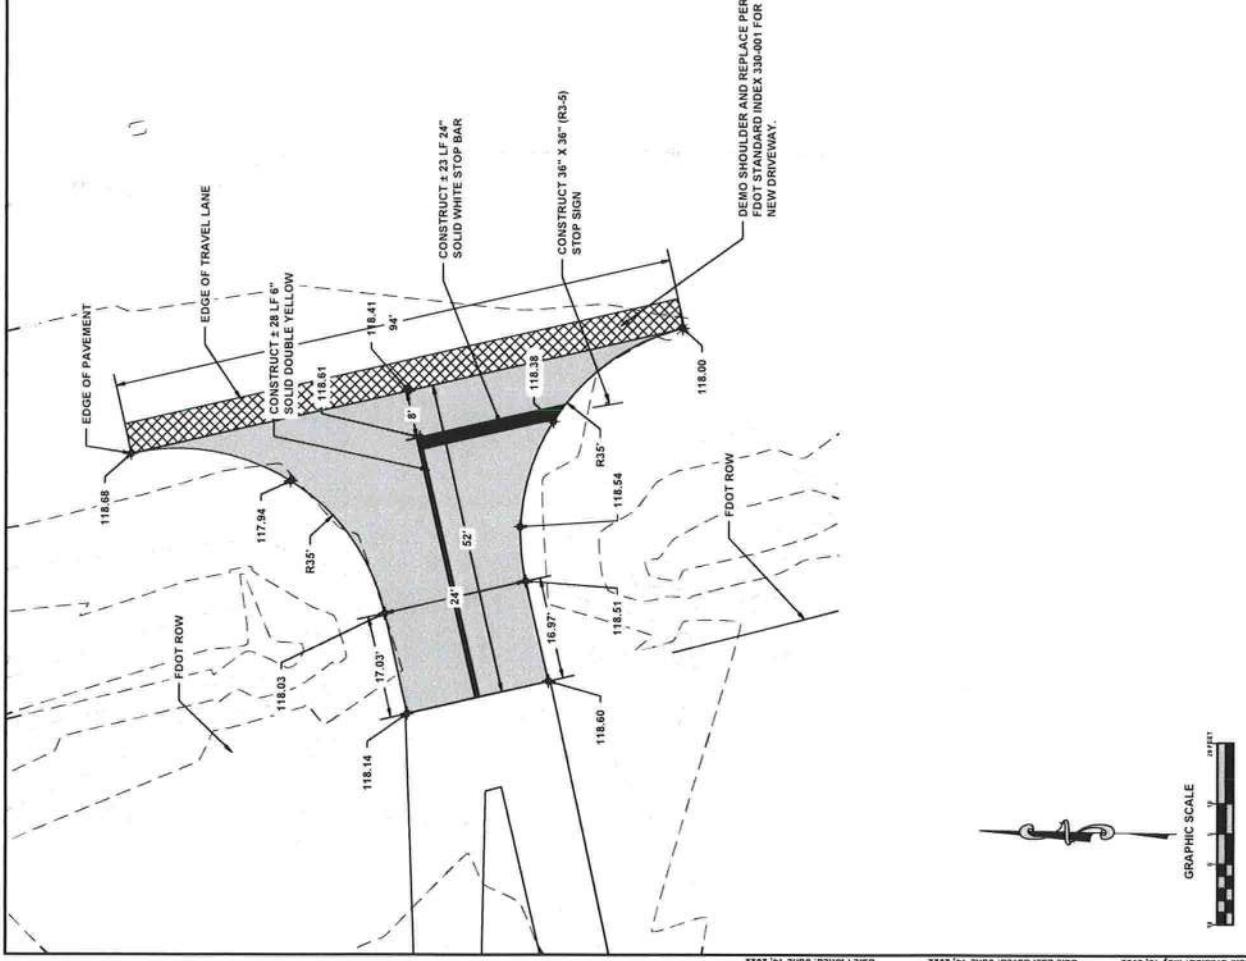



CAMBRIDGE PREP ACADEMY
LIFE SAFETY PLAN

COLUMBIA COUNTY, FL

4605 CRAY RD CONSULTING, LTD.
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STAKE DATE	06/16/2022	DATE ISSUED BY	ESCAPE ROUTE
REVISION NUMBER	01	DATE ISSUED BY	OUTLET BY
ANNUAL INSPECTION	06/16/2022	DATE ISSUED BY	ESCAPE ROUTE
STAKE DATE	06/16/2022	DATE ISSUED BY	OUTLET BY
REVISION NUMBER	01	DATE ISSUED BY	ESCAPE ROUTE

ENVIRONMENTAL, 2000A PERMIT NO.	FILE NUMBER
ESCAPE ROUTE	ESCAPE ROUTE



- LIFE SAFETY NOTES:**
1. LIFE SAFETY PLAN SHALL MEET THE REQUIREMENTS OF THE FLORIDA FIRE PREVENTION CODE (FPPC), 11TH EDITION (2010).
 2. OCCUPANCY TYPE SHALL BE "EDUCATIONAL," IN ACCORDANCE WITH THE DEFINITION SET FORTH IN SECTION 6.3.5 OF THE FPPC.
 3. BUILDING STRUCTURES TOTAL 2550 SQUARE FEET AND WOULD BE CLASSIFIED AS TYPE C (ONE STORY) IN THE FPPC.
 4. ONE CONCRETE HYDRANT WILL BE SITES OF ROTATION OF TWO DIVISIONS FOR TYPE III HYDRANTS. IT IS THE RESPONSIBILITY OF THE PROPERTY OWNER TO MAINTAIN REQUIRED FLOW AND PRESSURE DURATION FOR BUILDINGS PER THE FPPC.
 5. CITY OF LAKE CITY, CITY OF DEPARTMENT OF PUBLIC UTILITIES AND OPERATES THESE PUBLIC UTILITIES AND PROVIDED THE FIRE FLOW CALCULATIONS FOR THE HYDRANTS AT THIS SITE.
 6. THE DISTANCE MEASURED ALONG THE ROADWAY FROM THE FIRE HYDRANT TO NEAREST POINT OF ANY BUILDING IS 2550 FEET.

