


Hollingsworth  
598 NW Brady Circle  
Lake City, FL 32055

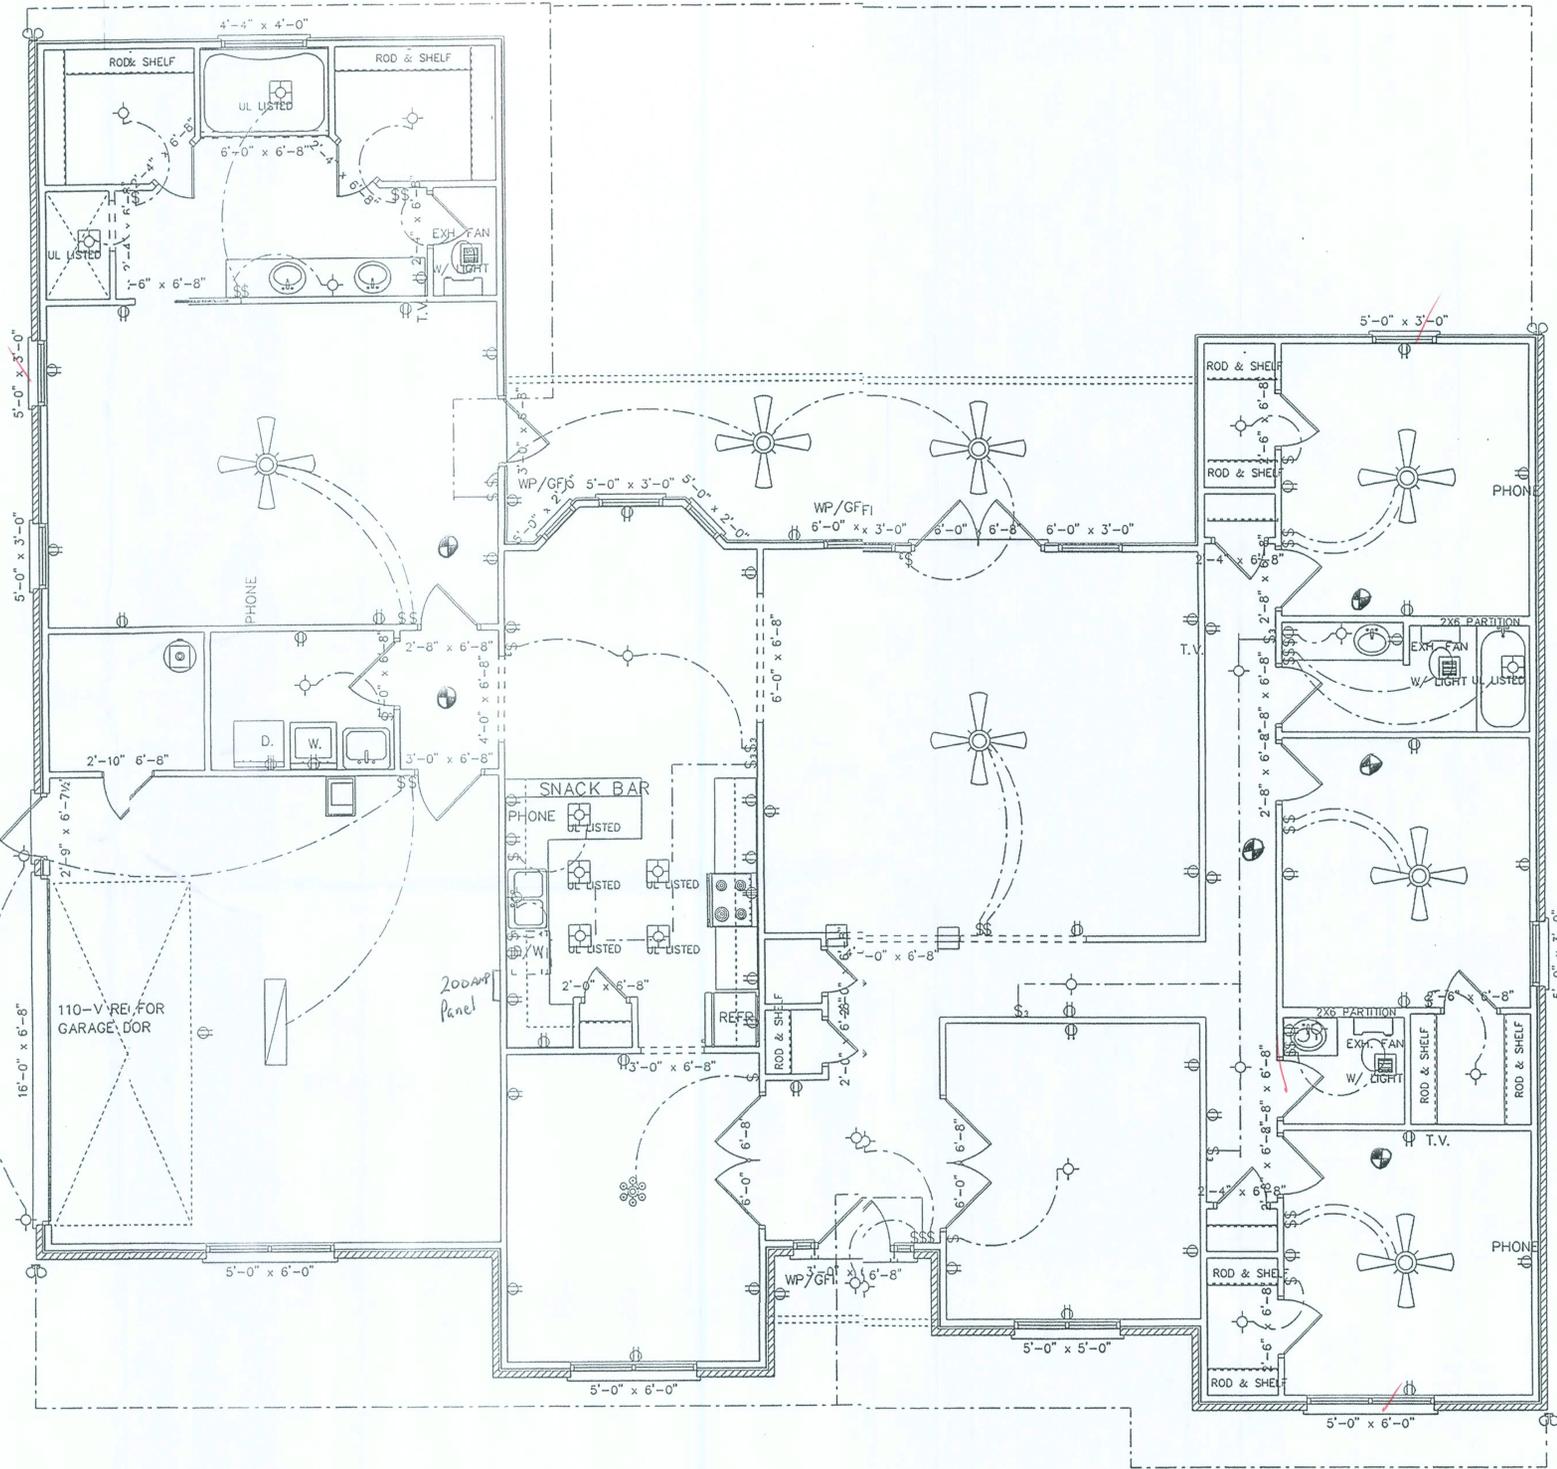

NOTE:  
⊕ Smoke Detector


ELECTRICAL PLAN 1/4" = 1'-0"	The Hampton Model		AREA SUMMARY	ALL WORK SHALL COMPLY WITH THE STANDARD BUILDING CODE AND ALL OTHER APPLICABLE LOCAL CODES AND ORDINANCES.
	October 26, 2005 12:48 PM	LAKE CITY, FLORIDA	LIVING AREA (FRAME) 2706 SF GARAGE 484 SF PORCHES 280 SF TOTAL AREA 3470 SF	
SHEET # 4	PLANS BY: <i>[Signature]</i>			

Hollingsworth  
598 NW Brady Circle  
Lake City, FL 32055

357#




Hollingsworth  
598 NW Brady Circle  
Lake City, FL 32055

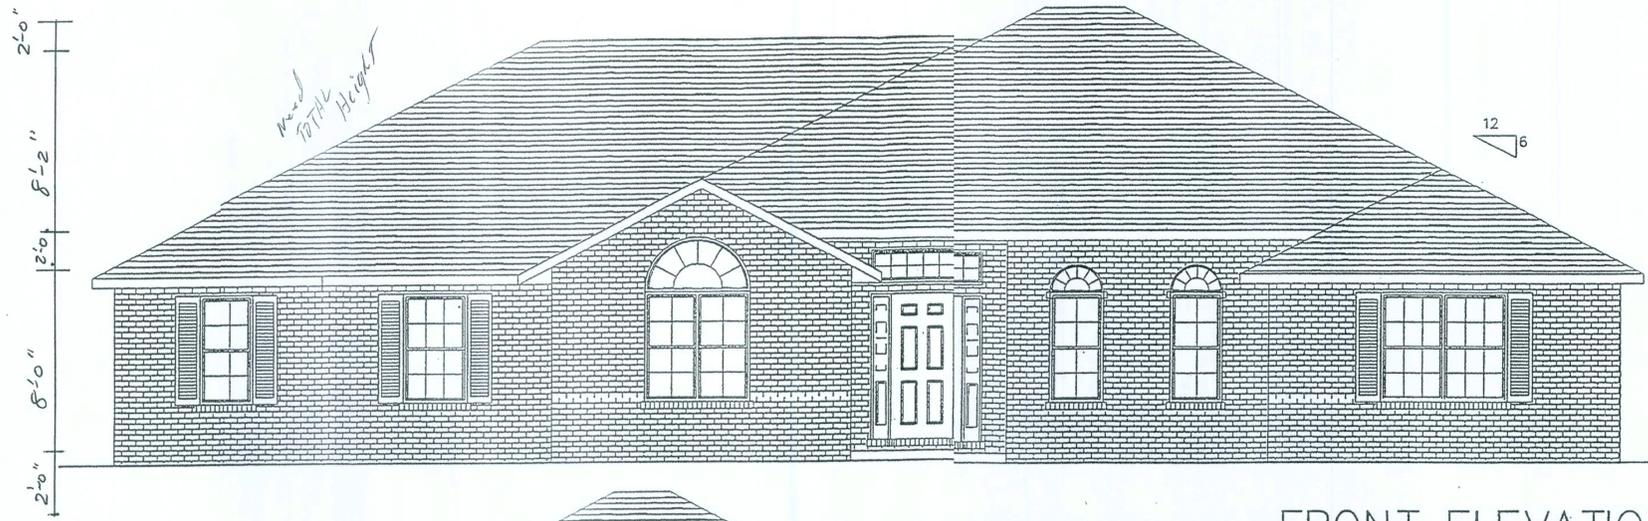


FRONT ELEVATION




REAR ELEVATION

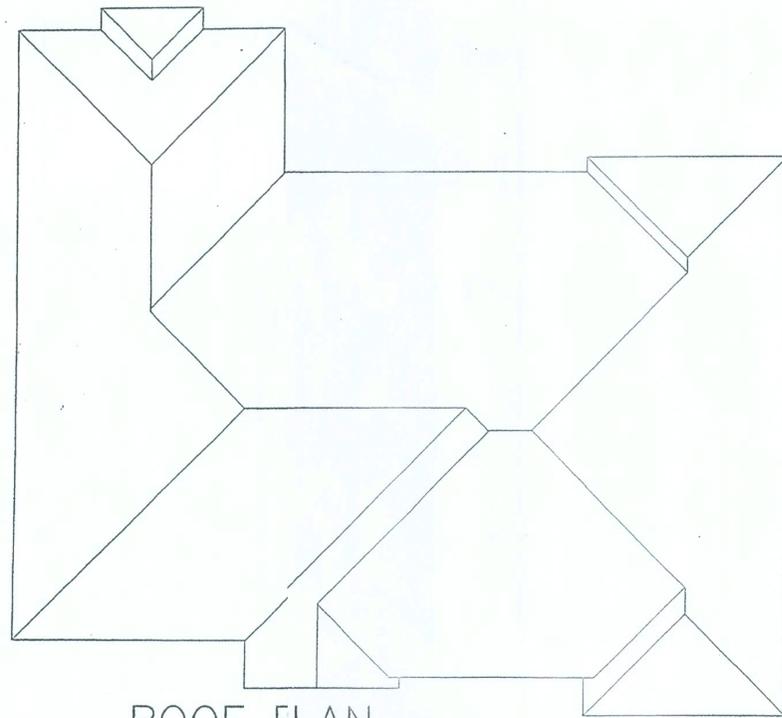

ROOF FLAN

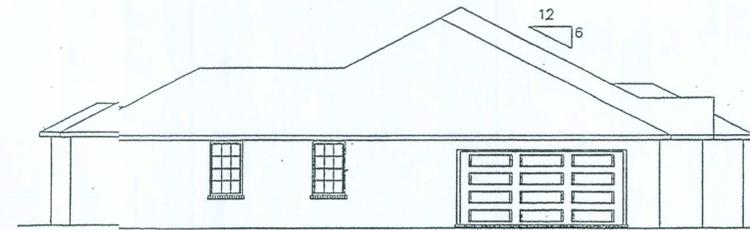

RIGHT ELEVATION

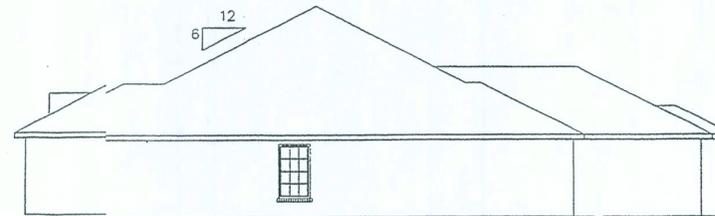

LEFT ELEVATION

ALL WORK SHALL COMPLY WITH THE STANDARD BUILDING CODE AND ALL OTHER APPLICABLE LOCAL CODES AND ORDINANCES.

AREA SUMMARY  
LIVING AREA (FRAME) 2706 SF  
598 NW Brady Circle GARAGE 484 SF  
Lake City, FL 32055 PORCHES 280 SF  
TOTAL AREA 3470 SF


The Hampton II Model  
LAKE CITY, FLORIDA  
Hollingsworth:  
598 NW Brady Circle  
Lake City, FL 32055

EXTERIOR ELEVATIONS  
1/4" = 10"  
September 19, 2005  
09:34 AM  
SHEET #  
1




REVISIONS	


**SOFTPLAN**  
ARCHITECTURAL DESIGN SOFTWARE

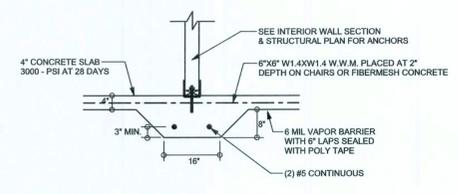


**F2 INTERIOR BEARING FOOTING**  
SCALE: 1/2" = 1'-0"

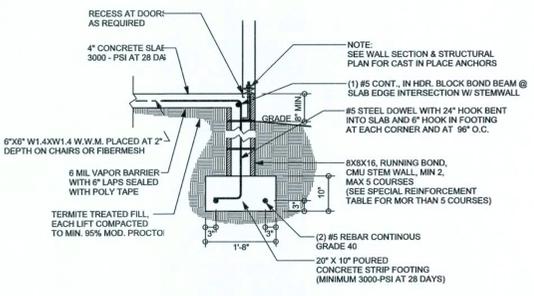


**F9 STEM WALL FOOTING**  
SCALE: 1/2" = 1'-0"

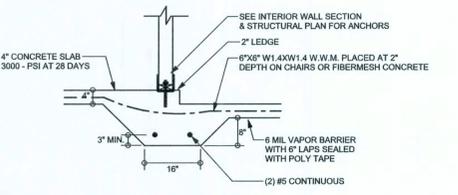


**F3 INTERIOR BEARING STEP FOOTING**  
SCALE: 1/2" = 1'-0"

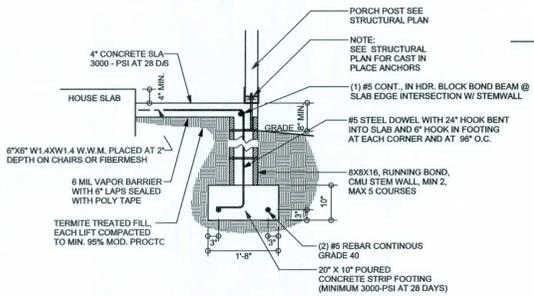


**F12 ALT. STEM WALL PORCH FOOTING**  
SCALE: 1/2" = 1'-0"

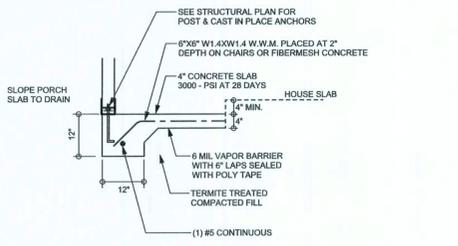


**F5 PORCH FOOTING**  
SCALE: 1/2" = 1'-0"

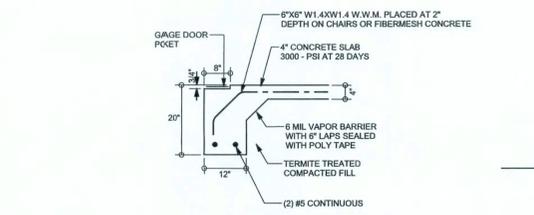

**F13 ALT. STEM WALL GARAGE DOOR FOOTING**  
SCALE: 1/2" = 1'-0"

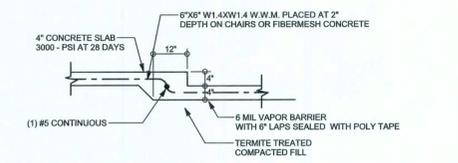

**F6 TYPICAL NON-BEARING STEP FOOTING**  
SCALE: 1/2" = 1'-0"

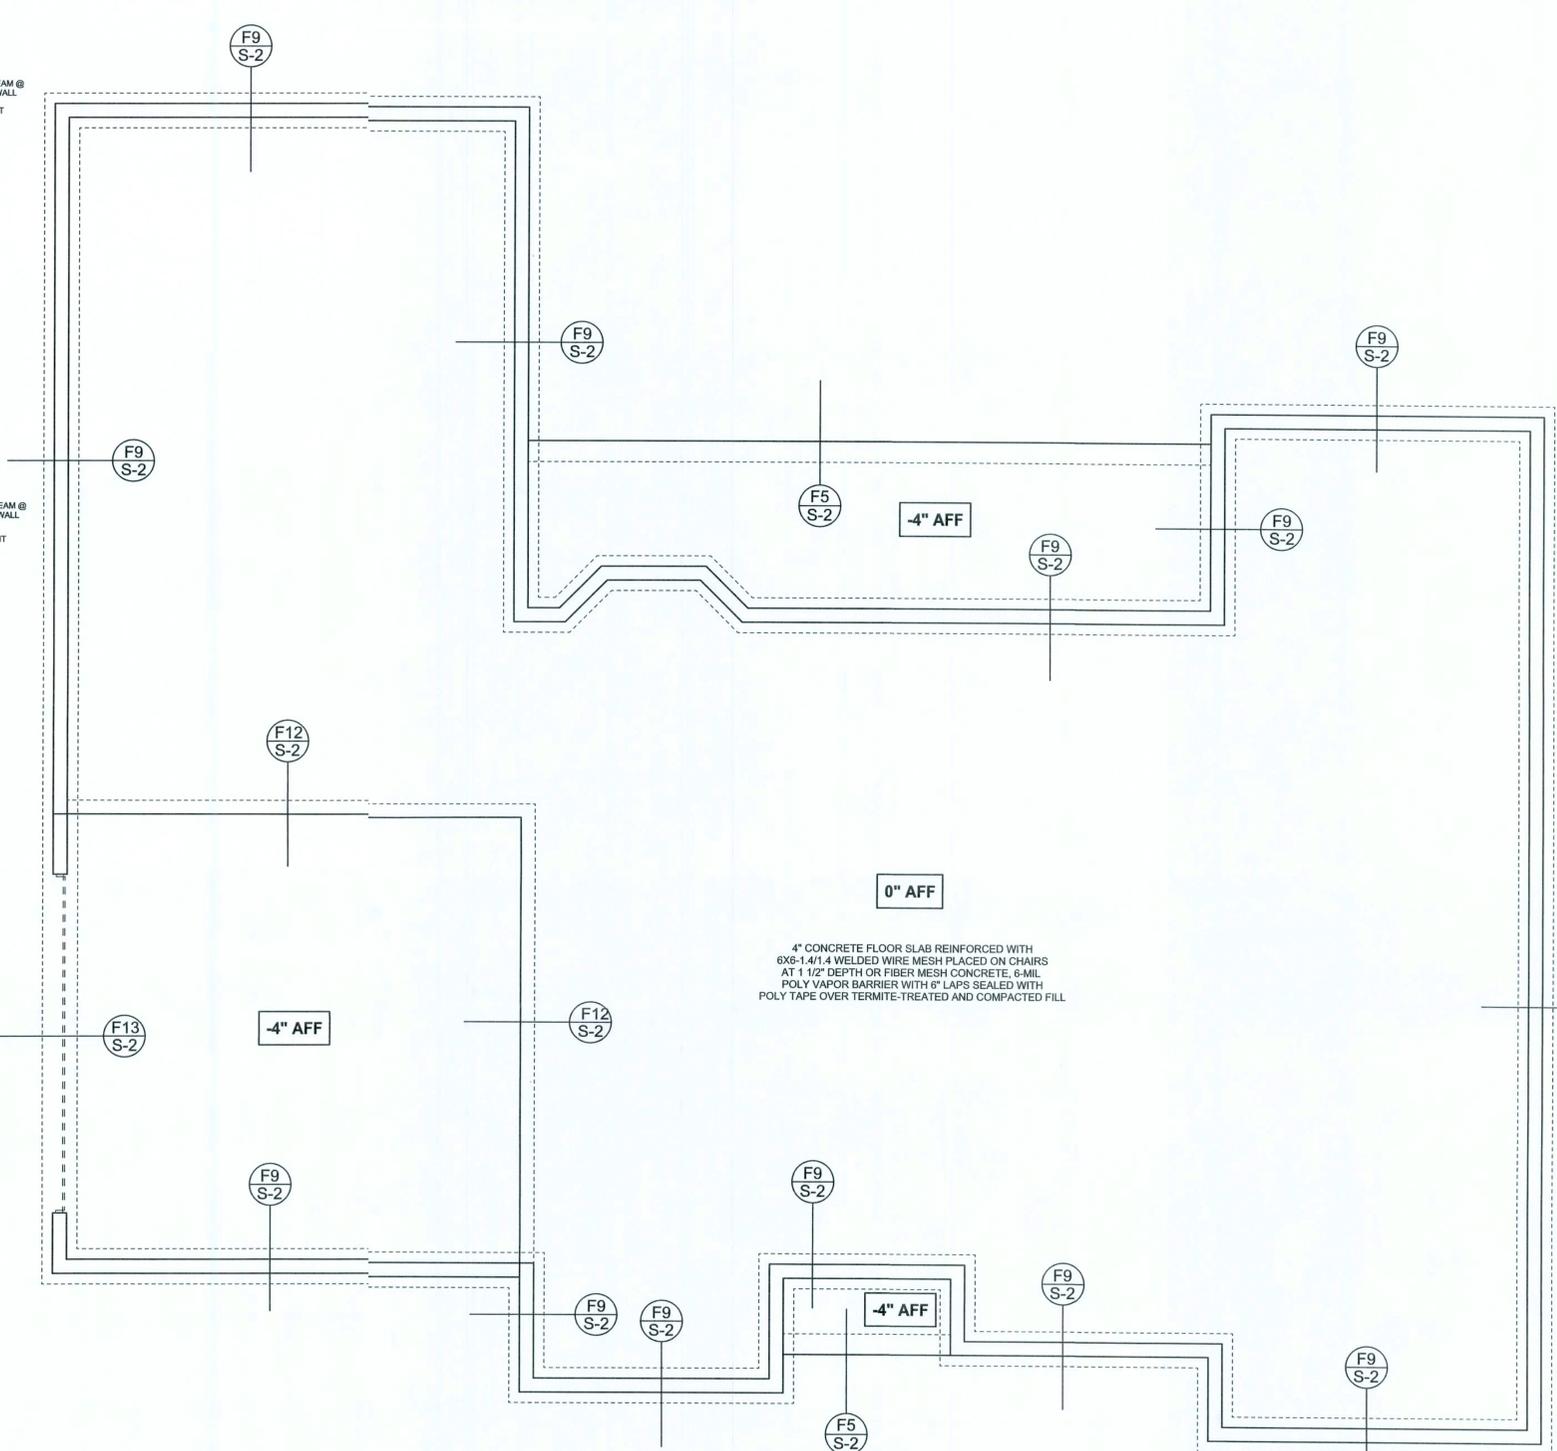

**FOUNDATION PLAN**  
SCALE: 1/4" = 1'-0"  
DIMENSIONS ON STRUCTURAL SHEETS  
ARE NOT EXACT. REFER TO ARCHITECTURAL  
FLOOR PLAN FOR ACTUAL DIMENSIONS

WINDLOAD ENGINEER: Mark Disoway,  
PE No. 53915, POB 368, Lake City, FL  
32056, 386-754-5419

**DIMENSIONS:**  
Stated dimensions superseded scaled  
dimensions. Refer all questions to  
Mark Disoway, P.E. for resolution.  
Do not proceed without clarification.

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not to be reproduced, altered, copied in any  
form or manner without first express written  
permission and consent of Mark Disoway.

**CERTIFICATION:** I hereby certify that I have  
examined this plan, and that the applicable  
portions of the plan, relating to civil engineering  
comply with section 1609, Florida building code  
2004, to the best of my knowledge.

**LIMITATION:** This design is valid for one  
building, at specified location.

MARK DISOWAY  
P.E. 53915  
*Mark Disoway*  
12-31-08  
SEAL

Hollingsworth  
Residence

ADDRESS:  
Columbia Count, Florida


Mark Disoway P.E.  
P.O. Box 368  
Lake City, Florida 32056  
Phone: (386) 754 - 5419  
Fax: (386) 261 - 4871

PRINTED DATE:  
January 14, 2008  
ENGINEERING DRAWN BY:  
David Disoway

FINALS DATE:  
13 / Jan / 08

JOB NUMBER:  
801141  
DRAWING NUMBER  
**S-2**  
OF 6 SHEETS

REVISIONS	

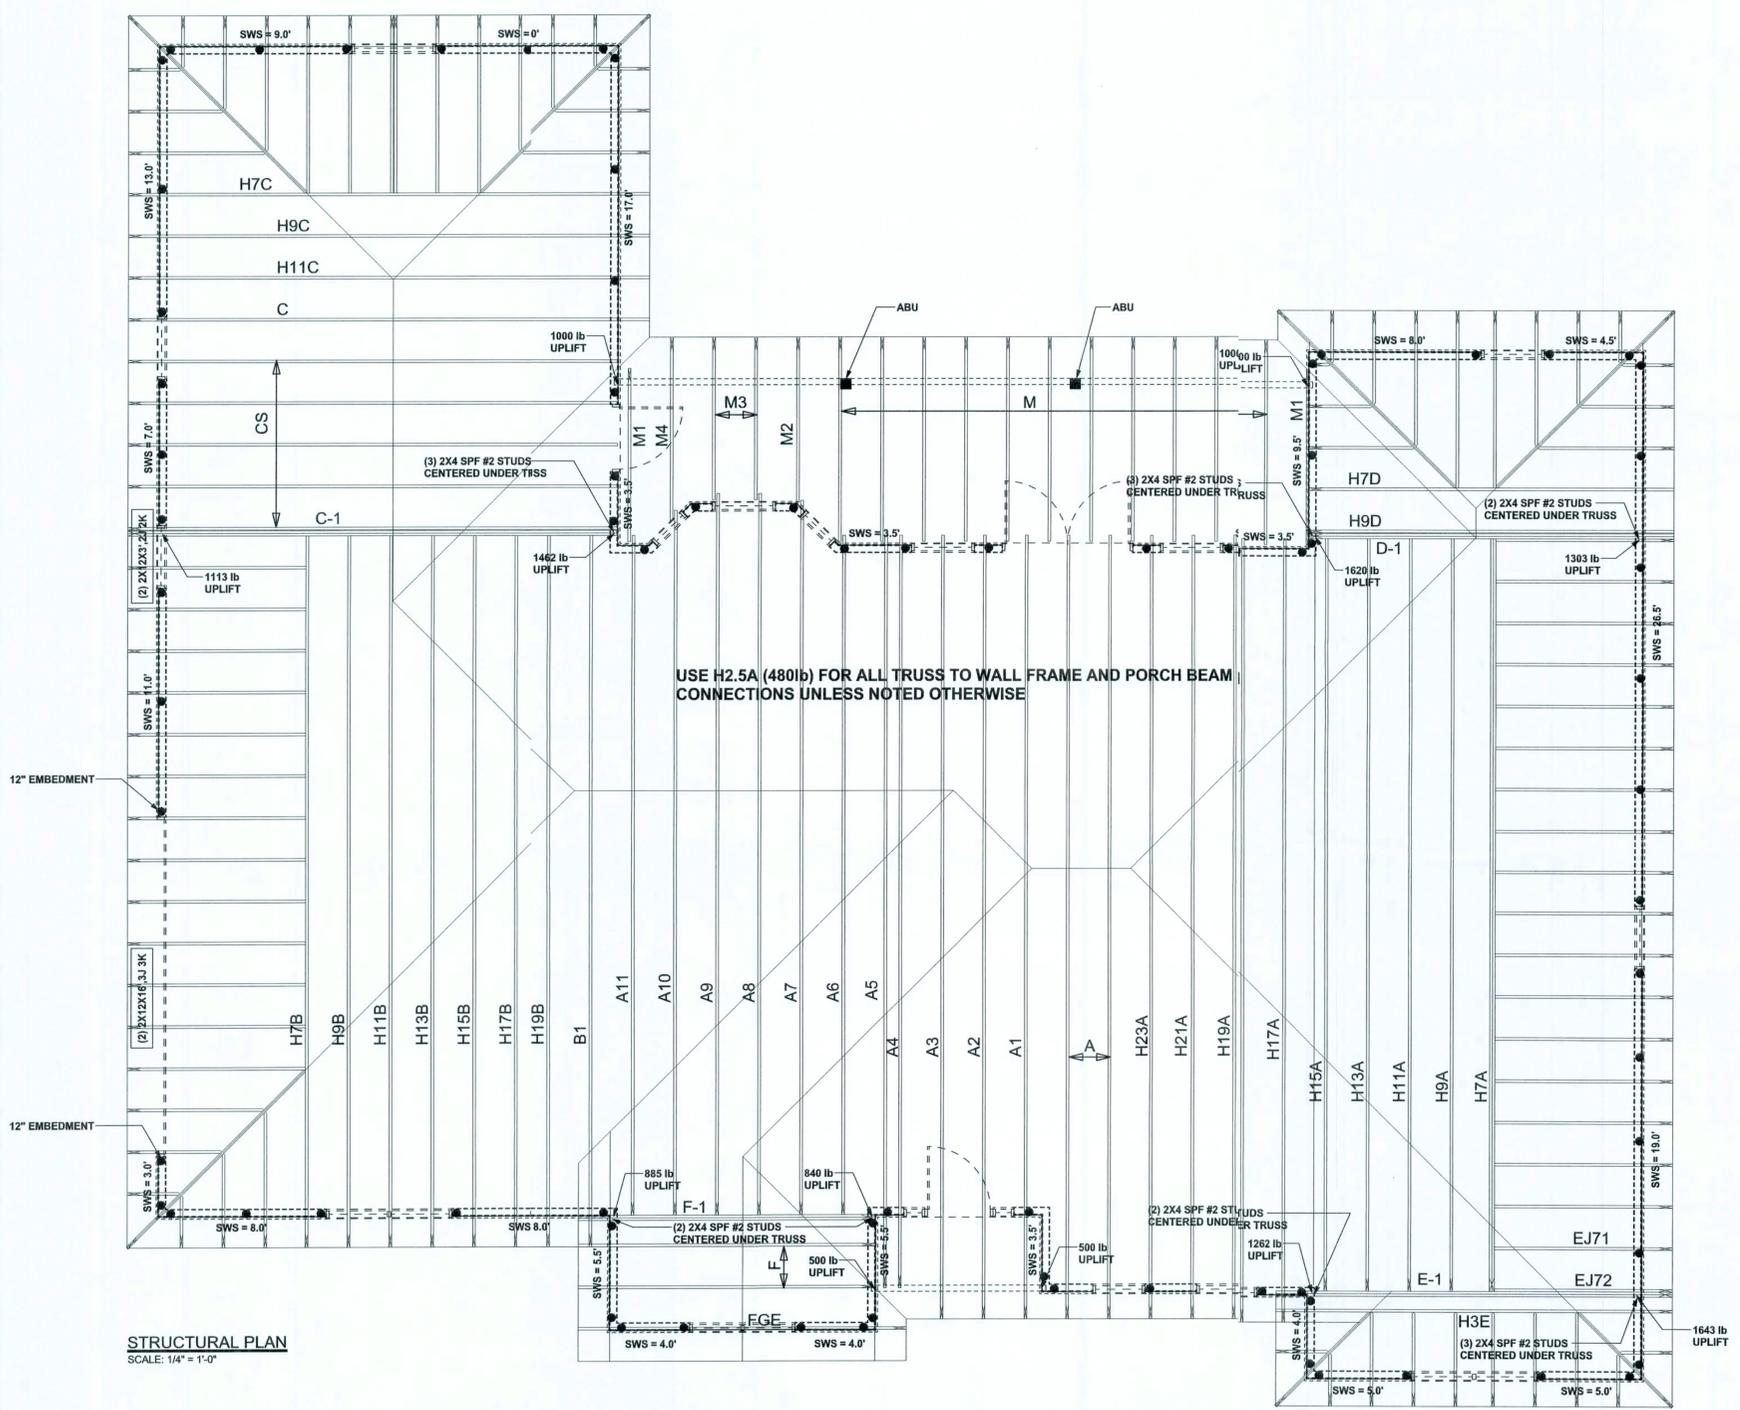

**STRUCTURAL PLAN NOTES**

- SN-1 ALL LOAD BEARING FRAME WALL & PORCH HEADERS SHALL BE A MINIMUM OF (2) 2X12 SYP#2 (U.N.O.)
- SN-2 ALL LOAD BEARING FRAME WALL HEADERS SHALL HAVE (1) JACK STUD & (1) KING STUD EACH SIDE (U.N.O.)
- SN-3 DIMENSIONS ON STRUCTURAL SHEETS ARE NOT EXACT. REFER TO ARCHITECTURAL FLOOR PLAN FOR ACTUAL DIMENSIONS
- SN-4 PERMANENT TRUSS BRACING IS TO BE INSTALLED AT LOCATIONS AS SHOWN ON THE SEALED TRUSS DRAWINGS. LATERAL BRACING IS TO BE RESTRAINED PER BCSI-03, BCSI-01, BCSI-02, & BCSI-03. BCSI-01, BCSI-02, & BCSI-03 ARE FURNISHED BY THE TRUSS SUPPLIER, WITH THE SEALED TRUSS PACKAGE

**WALL LEGEND**

SWS = 0.0'	1ST FLOOR EXTERIOR WALL
SWS = 0.0'	2ND FLOOR EXTERIOR
IBW	1ST FLOOR INTERIOR BEARING WALLS SEE DETAILS ON SHEET S-1
IBW	2ND FLOOR INTERIOR BEARING WALLS SEE DETAILS ON SHEET S-1

**THREADED ROD LEGEND**

- INDICATES LOCATION OF:  
1ST FLOOR 1/2" A307 ALL THREADED ROD
- ⊗ INDICATES LOCATION OF:  
2ND FLOOR 1/2" A307 ALL THREADED ROD

**HEADER LEGEND**

- (2) 2X12X0', 1J 1K → HEADER/BREAM CALL-OUT (U.N.O.)
- ↑ NUMBER OF KING STUDS (FULL LENGTH)
- ↑ NUMBER OF JACK STUDS (UNDER HEADER)
- ↑ SPAN OF HEADER
- ↑ SIZE OF HEADER MATERIAL
- ↑ NUMBER OF PLYS IN HEADER

**TOTAL SHEAR WALL SEGMENTS**

SWS = 0.0' INDICATES SHEAR WALL SEGMENTS

	REQUIRED	ACTUAL
TRANSVERSE	38.5'	128.0'
LONGITUDINAL	32.8'	71.5'

WINDLOAD ENGINEER: Mark Disosway,  
PE No. 53915, PCB 868, Lake City, FL  
32056, 386-754-5419

**DIMENSIONS**  
Stated dimensions supercede all other dimensions. Refer all questions to Mark Disosway, P.E. for resolution. Do not proceed without clarification.

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**CERTIFICATION:** I hereby certify that I have examined this plan, and that its applicable portions of the plan, relating to wind engineering comply with section 1609, Florida building code 2004, to the best of my knowledge.

**LIMITATION:** This design is valid for one building, at specified location.

MARK DISOSWAY  
P.E. 53915  
*Mark Disosway*  
14 JAN 08  
SEAL

Hollingsworth  
Residence

ADDRESS:  
Columbia County Florida

Mark Disosway P.E.  
P.O. Box 668  
Lake City, Florida 32056  
Phone: (386) 754 - 5419  
Fax: (386) 269- 4871

PRINTED DATE:  
January 14, 2008

ENGINEERING DRAWN BY:  
David Disosway

FINALS DATE:  
13 / Jan / 08

JOB NUMBER:  
80114


DRAWING NUMBER  
**S-3**  
OF 6 SHEETS

CONNECTIONS, WALL, & HEADER DESIGN IS BASED ON REACTIONS & UPLIFTS FROM TRUSS ENGINEERING FURNISHED BY BUILDER, ANDERSON TRUSS CO. (JOB #5-482)




REVISIONS	


SOFTPLAN  
ARCHITECTURAL DESIGN SOFTWARE

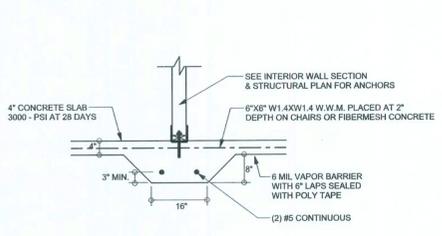


**F2**  
**S-2** INTERIOR BEARING FOOTING  
SCALE: 1/2" = 1'-0"

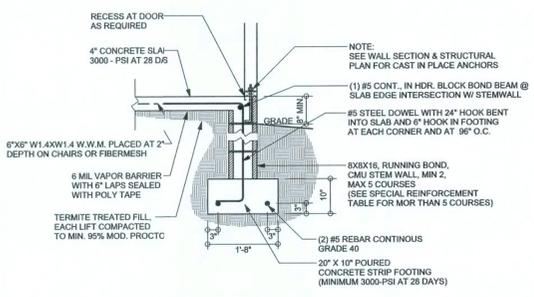


**F9**  
**S-2** STEM WALL FOOTING  
SCALE: 1/2" = 1'-0"

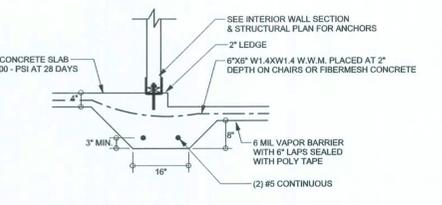


**F3**  
**S-2** INTERIOR BEARING STEP FOOTING  
SCALE: 1/2" = 1'-0"

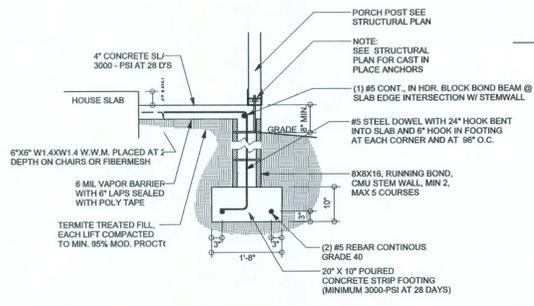


**F12**  
**S-2** ALT. STEM WALL PORCH FOOTING  
SCALE: 1/2" = 1'-0"

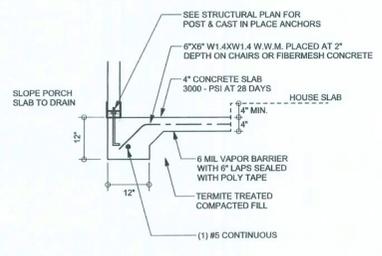


**F5**  
**S-2** PORCH FOOTING  
SCALE: 1/2" = 1'-0"

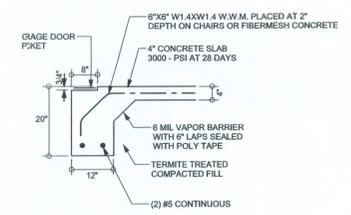

**F13**  
**S-2** AT. STEM WALL GARAGE DOOR FOOTING  
SCALE: 1/2" = 1'-0"

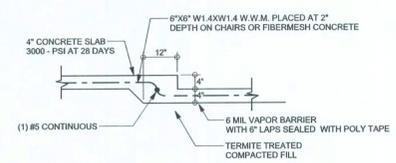

**F6**  
**S-2** TYPICAL NON-BEARING STEP FOOTING  
SCALE: 1/2" = 1'-0"

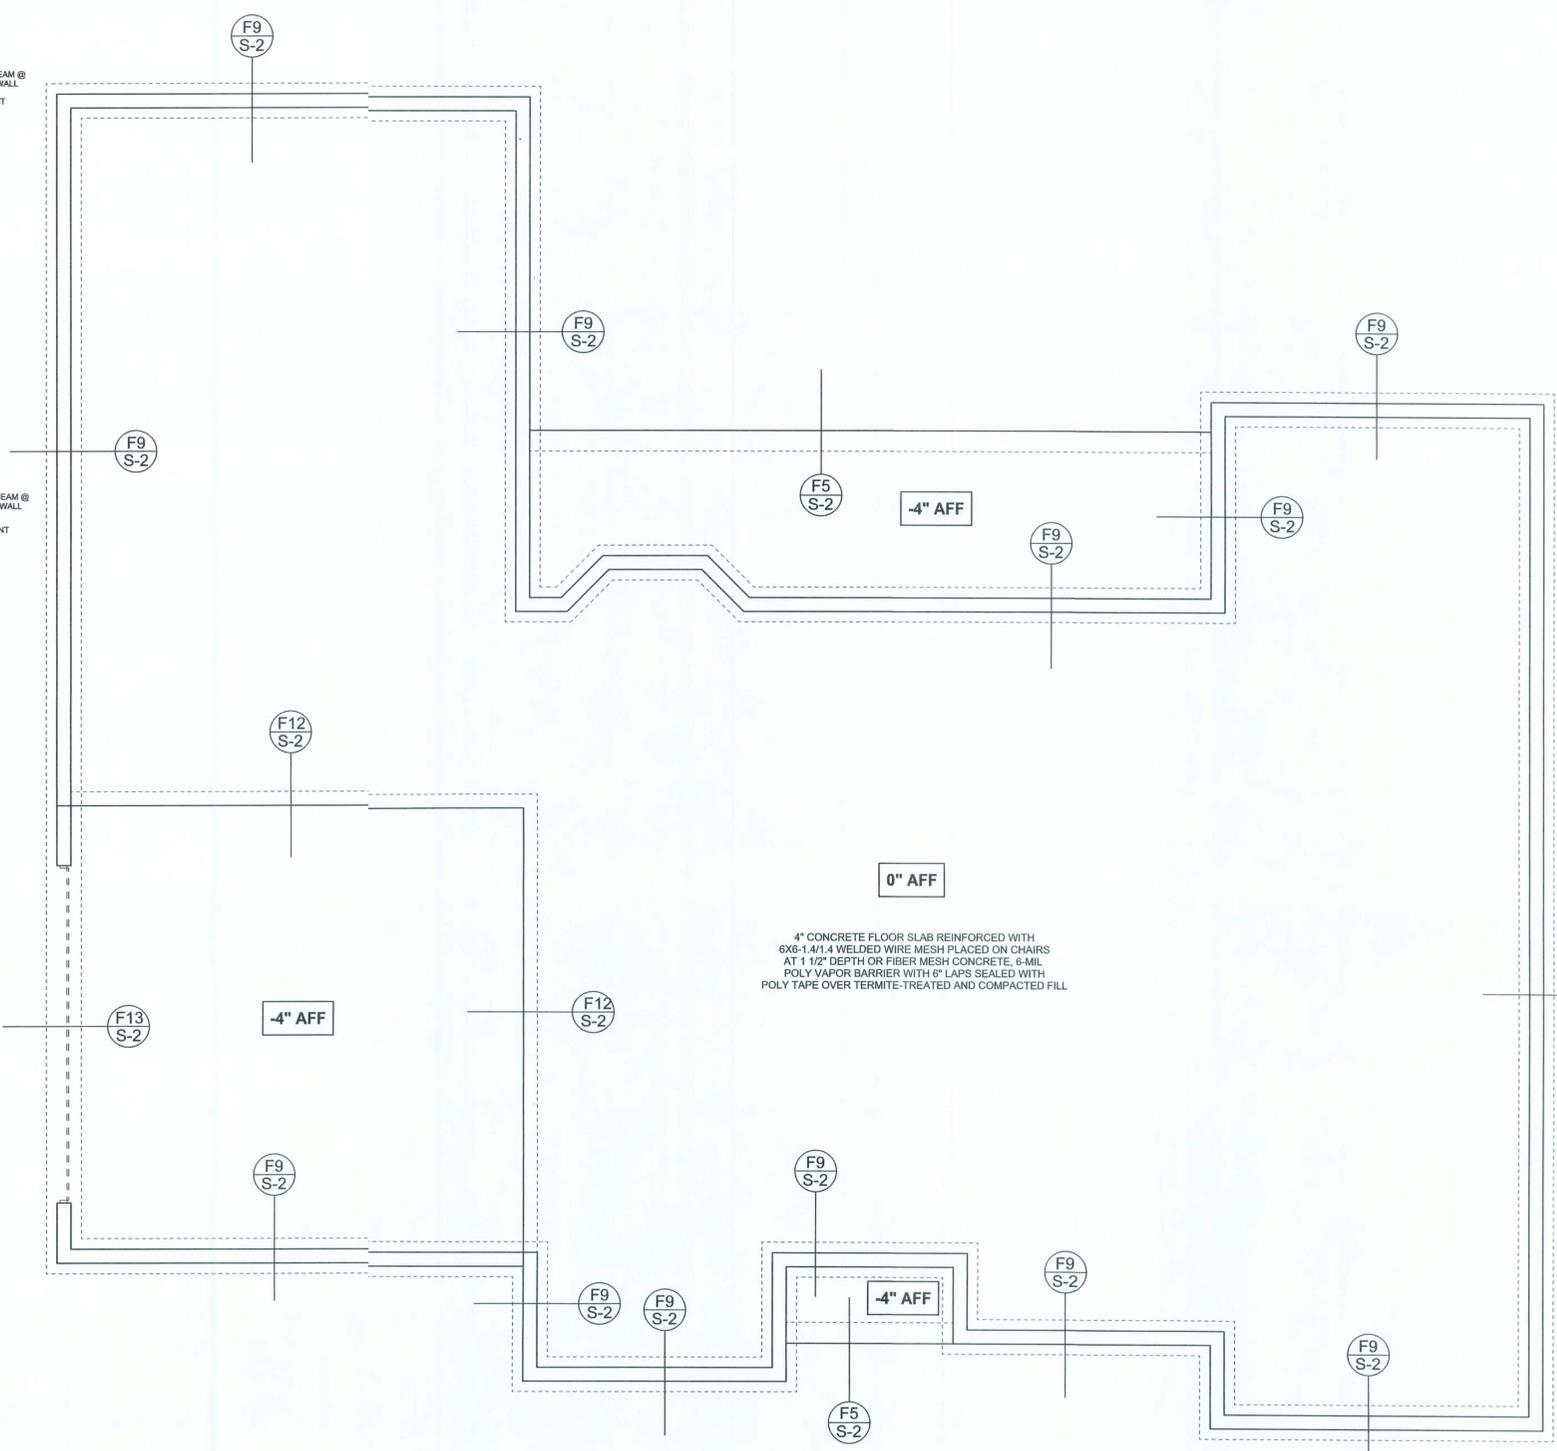

**FOUNDATION PLAN**  
SCALE: 1/4" = 1'-0"  
DIMENSIONS ON STRUCTURAL SHEETS  
ARE NOT EXACT. REFER TO ARCHITECTURAL  
FLOOR PLAN FOR ACTUAL DIMENSIONS

WINDLOAD ENGINEER: Mark Disosway,  
P.E. No. 53915, POB 868, Lake City, FL  
32056, 386-754-5419

DIMENSIONS:  
Shaded dimensions superseded scaled  
dimensions. Refer all questions to  
Mark Disosway, P.E. for resolution.  
Do not proceed without clarification.

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permission and consent of Mark Disosway.

CERTIFICATION: I hereby certify that I have  
examined this plan, and that the applicable  
portions of the plan, relating to my engineering  
comply with section 1609, Florida building code  
2004, to the best of my knowledge.

LIMITATION: This design is valid for one  
building, at specified location.

MARK DISOSWAY  
P.E. 0091  
*Mark Disosway*  
2.1.08  
SEAL

Hollingsworth  
Residence

ADDRESS:  
Columbia County, Florida

Mark Disosway P.E.  
P.O. Box 868  
Lake City, Florida 32056  
Phone: (386) 754 - 5419  
Fax: (386) 269 - 4871

PRINTED DATE:  
July 03, 2008


ENGINEERING DRAWN BY:  
David Disosway

FINALS DATE:  
03.Jul.08

JOB NUMBER:  
801141a

DRAWING NUMBER  
**S-2**  
OF 3 SHEETS

REVISIONS	

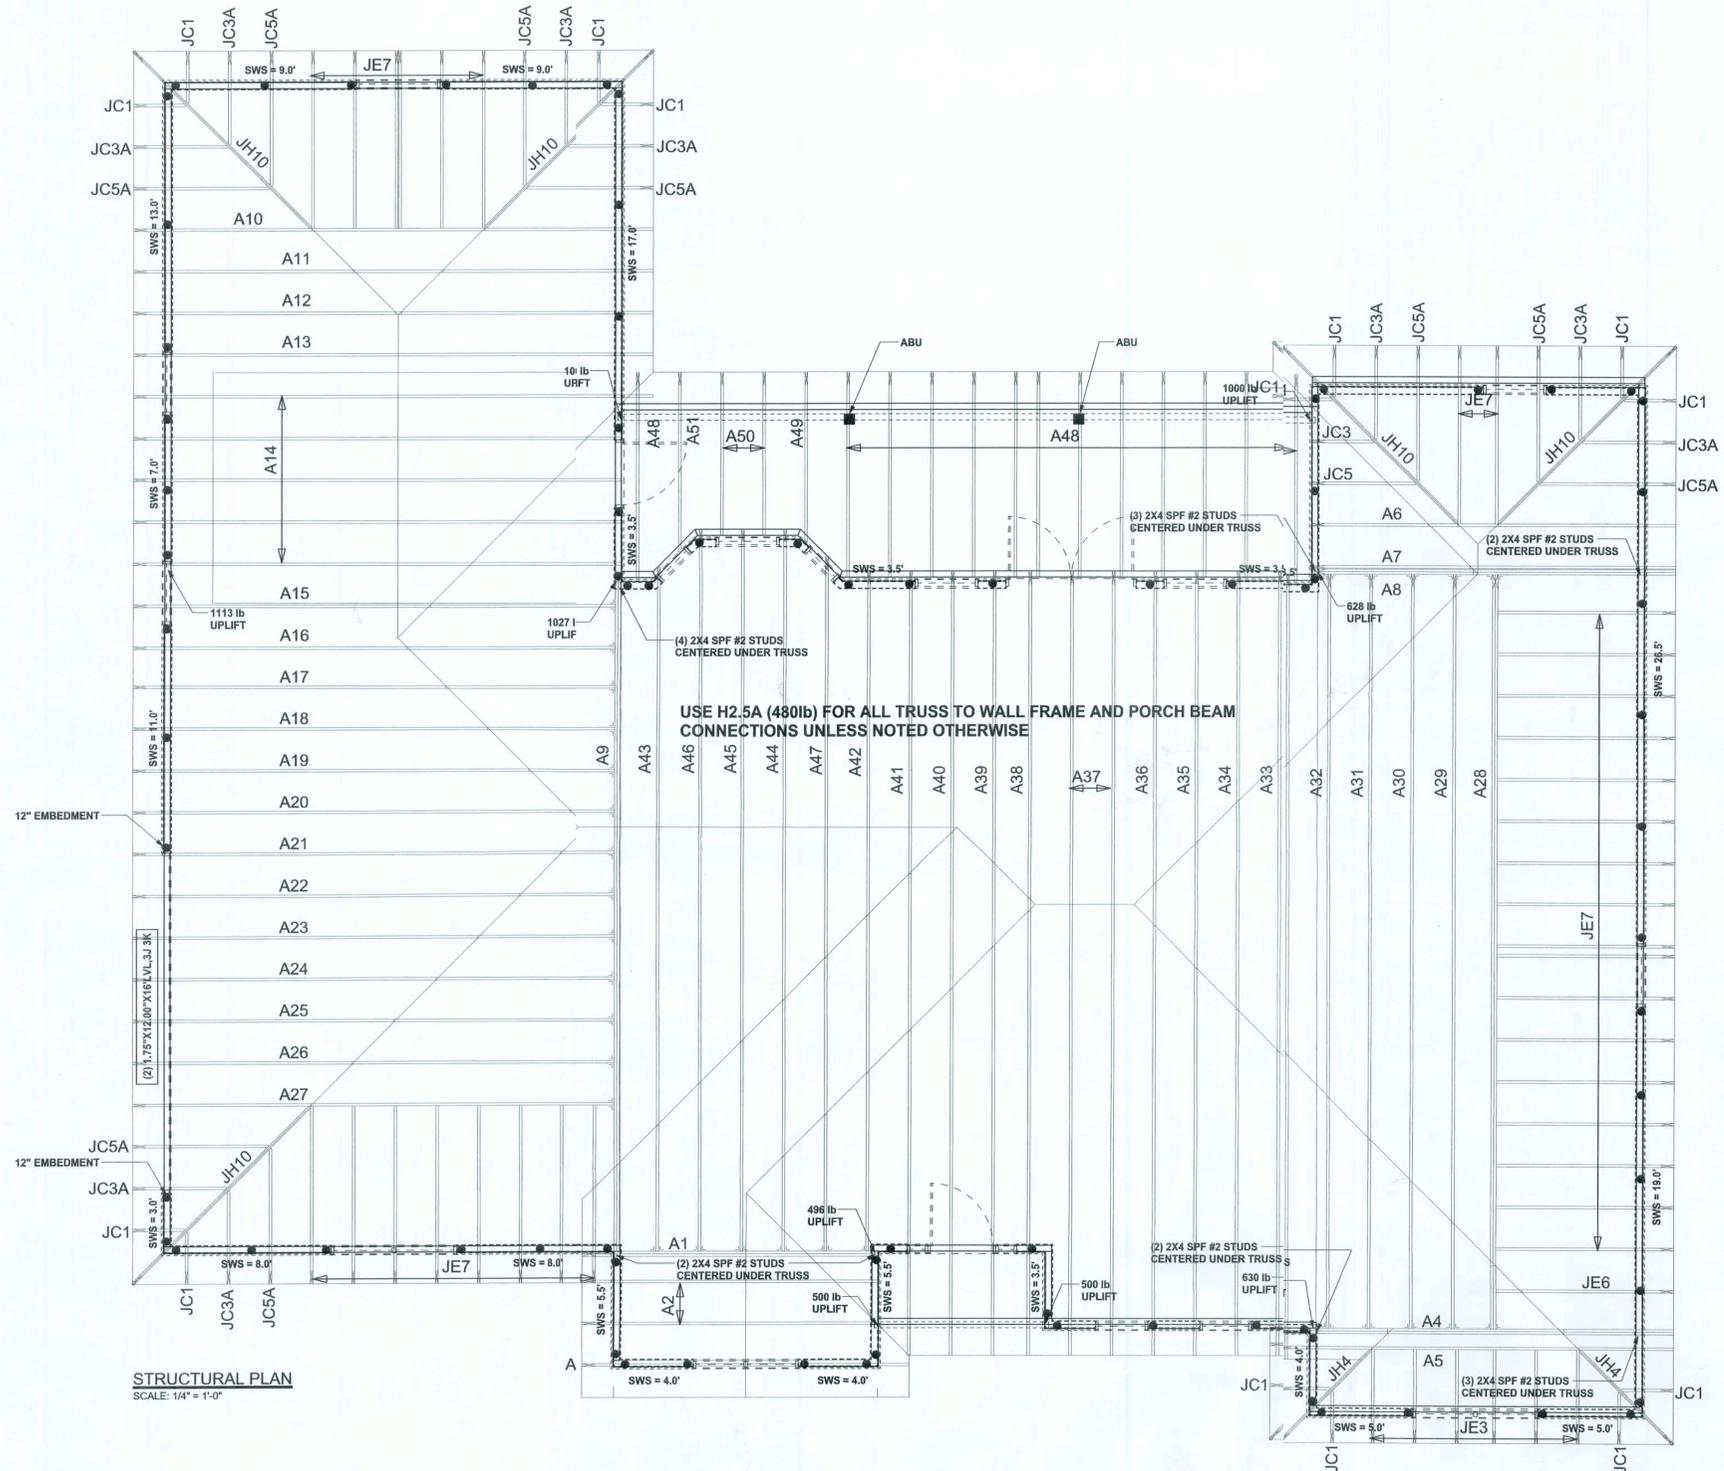

**STRUCTURAL PLAN NOTES**

- SN-1 ALL LOAD BEARING FRAME WALL & PORCH HEADERS SHALL BE A MINIMUM OF (2) 2X12 SYP#2 (U.N.O.)
- SN-2 ALL LOAD BEARING FRAME WALL HEADERS SHALL HAVE (1) JACK STUD & (1) KING STUD EACH SIDE (U.N.O.)
- SN-3 DIMENSIONS ON STRUCTURAL SHEETS ARE NOT EXACT. REFER TO ARCHITECTURAL FLOOR PLAN FOR ACTUAL DIMENSIONS
- SN-4 PERMANENT TRUSS BRACING IS TO BE INSTALLED AT LOCATIONS AS SHOWN ON THE SEALED TRUSS DRAWINGS. LATERAL BRACING IS TO BE RESTRAINED PER BCSI-03, BCSI-B1, BCSI-B2, & BCSI-B3. BCSI-B1, BCSI-B2, & BCSI-B3 ARE FURNISHED BY THE TRUSS SUPPLIER, WITH THE SEALED TRUSS PACKAGE

**WALL LEGEND**

	1ST FLOOR EXTERIOR WALL
	2ND FLOOR EXTERIOR
	1ST FLOOR INTERIOR BEARING WALLS SEE DETAILS ON SHEET S-1
	2ND FLOOR INTERIOR BEARING WALLS SEE DETAILS ON SHEET S-1

**THREADED ROD LEGEND**

- 
- 

**HEADER LEGEND**

- 
- 
- 
- 
- 
- 

**STRUCTURAL PLAN**  
SCALE: 1/4" = 1'-0"

**TOTAL SHEAR WALL SEGMENTS**  
SWS = 0.0' INDICATES SHEAR WALL SEGMENTS

	REQUIRED	ACTUAL
TRANSVERSE	38.5'	128.0'
LONGITUDINAL	32.8'	71.5'

CONNECTIONS, WALL, & HEADER DESIGN IS BASED ON REACTIONS & UPLIFTS FROM TRUSS ENGINEERING FURNISHED BY BUILDER. W.B. HOWLANDS (JOB #5194)

WINDLOAD ENGINEER: Mark Disoway, P.E. No. 33815, PCB 908, Lake City, FL 32056, 386-754-5419

**DIMENSIONS:** Stated dimensions supercede called dimensions. Refer all questions to Mark Disoway, P.E. for resolution. Do not proceed without clarification.

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**CERTIFICATION:** I hereby certify that I have examined this plan, and that the applicable portions of the plan, relating to me engineering comply with section 1609, Florida building code 2004, to the best of my knowledge.

**LIMITATION:** This design is valid for one building, at specified location.

MARK DISOWAY  
P.E. 33815  
*Mark Disoway*  
3/16/08  
SEAL

Hollingsworth Residence:

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Columbia County, Florida

Mark Disoway P.E.  
P.O. Box 848  
Lake City, Florida 32056  
Phone: (386) 754- 5419  
Fax: (386) 269- 4871

PRINTED DATE  
July 03, 2008

ENGINEERING DRAWN BY:  
David Disoway

FINALS DATE:  
03Jul08

JOB NUMBER:  
801141a

DRAWING NUMBER  
**S-3**  
OF 3 SHEETS