
SOFTPL AND ARCHITECTURAL DESIGN SOFTWARE

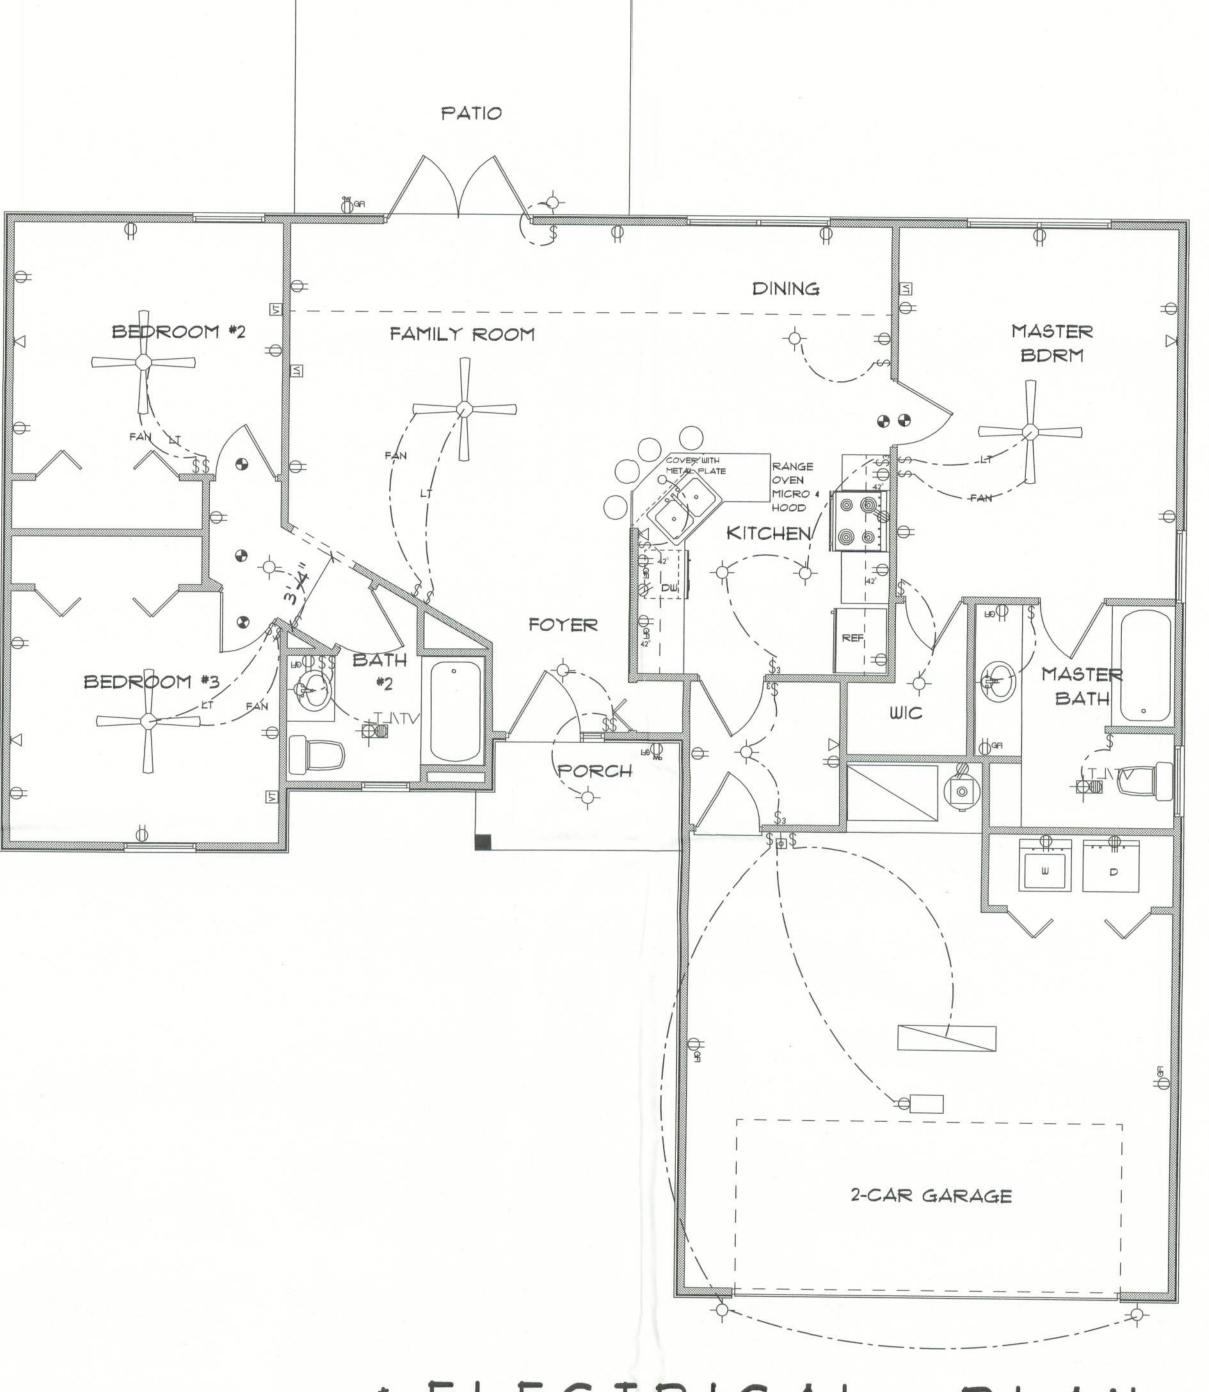

ELECTRICAL	COUNT	SYMBO
Light	11	<b>-</b>
automatic garage dr opener	1	Ď
cable ty outlet	4	M
ceiling fan	4	
fluorescent It fixture	1	
garage dr opener	1	d
gfi waterproof outlet	2	Q <sub>W</sub>
light	2	<b></b>
outlet	26	q
outlet 220v	3	å
outlet gfi	٦	Pau
smoke detector	5	•
switch	21	\$
ewitch 3 way	4	\$.
telephone	5	V
vent light combo	2	VT/LT

## ELECTRICAL PLAN NOTES

- WIRE ALL APPLIANCES, HYAC UNITS AND OTHER EQUIPMENT PER MANUFACTORS SPECIFICATIONS.
- CONSULT THE OWNER FOR THE NUMBER OF SEPERATE TELEPHONE LINES TO BE INSTALLED.
- ALL INSTALLATIONS SHALL BE PER NATIONAL ELECTRIC CODE.
- ALL SMOKE DETECTORS SHALL BE 120V W/BATTERY BACKUP OF THE PHOTOELECTRIC TYPE, AND SHALL BE INTERLOCKED TOGETHER, INSTALL INSIDE AND NEAR ALL BEDROOMS.
- TELEPHONE, TELEVVISION AND OTHER LOW VOLTAGE DEVICES OR OUTLETS SHALL BE AS PER THE OWNERS DIRECTION AND IN ACCORDANCE WITH APPLICABLE SECTIONS OF NATIONAL ELCT. CODE LATEST EDITION.
- E-7 ELECTRICAL CONTRACTOR SHALL BE RESPONSIBLE FOR THE DESIGN AND SIZING OF ELECTRICAL SERVICE AND CIRCUITS.
- ENTRY OF SERVICE UNDERGROUND OR OVERHEAD) IS TO BE DETERMINED BY THE POWER COMPANY.
  - ALL BEDROOM RECEPTICALS ARE TO BE AFCI (ARC FAULT CIRCUIT

THE THOMAS LOT \*19

> LAKE CITY FLORIDA

Teena M. Ruffo 251 NW Hall of Fame Dr. Lake City, Florida 32055 Phone: (386) 755 - 9993 Cell: (386) 867 - 1191 Email: easystreet@lani.net

PRINTED DATE: November 16, 2005

DRAWN BY: CHECKED BY: Teena M. Ruffo Teena M. Ruffe

FINIALS DATE:

JOB NUMBER:

DRAWING NUMBER A-2

OF 2 SHEETS

\* ELECTRICAL PLAN \*

SCALE : 1/4" = 1'-0"