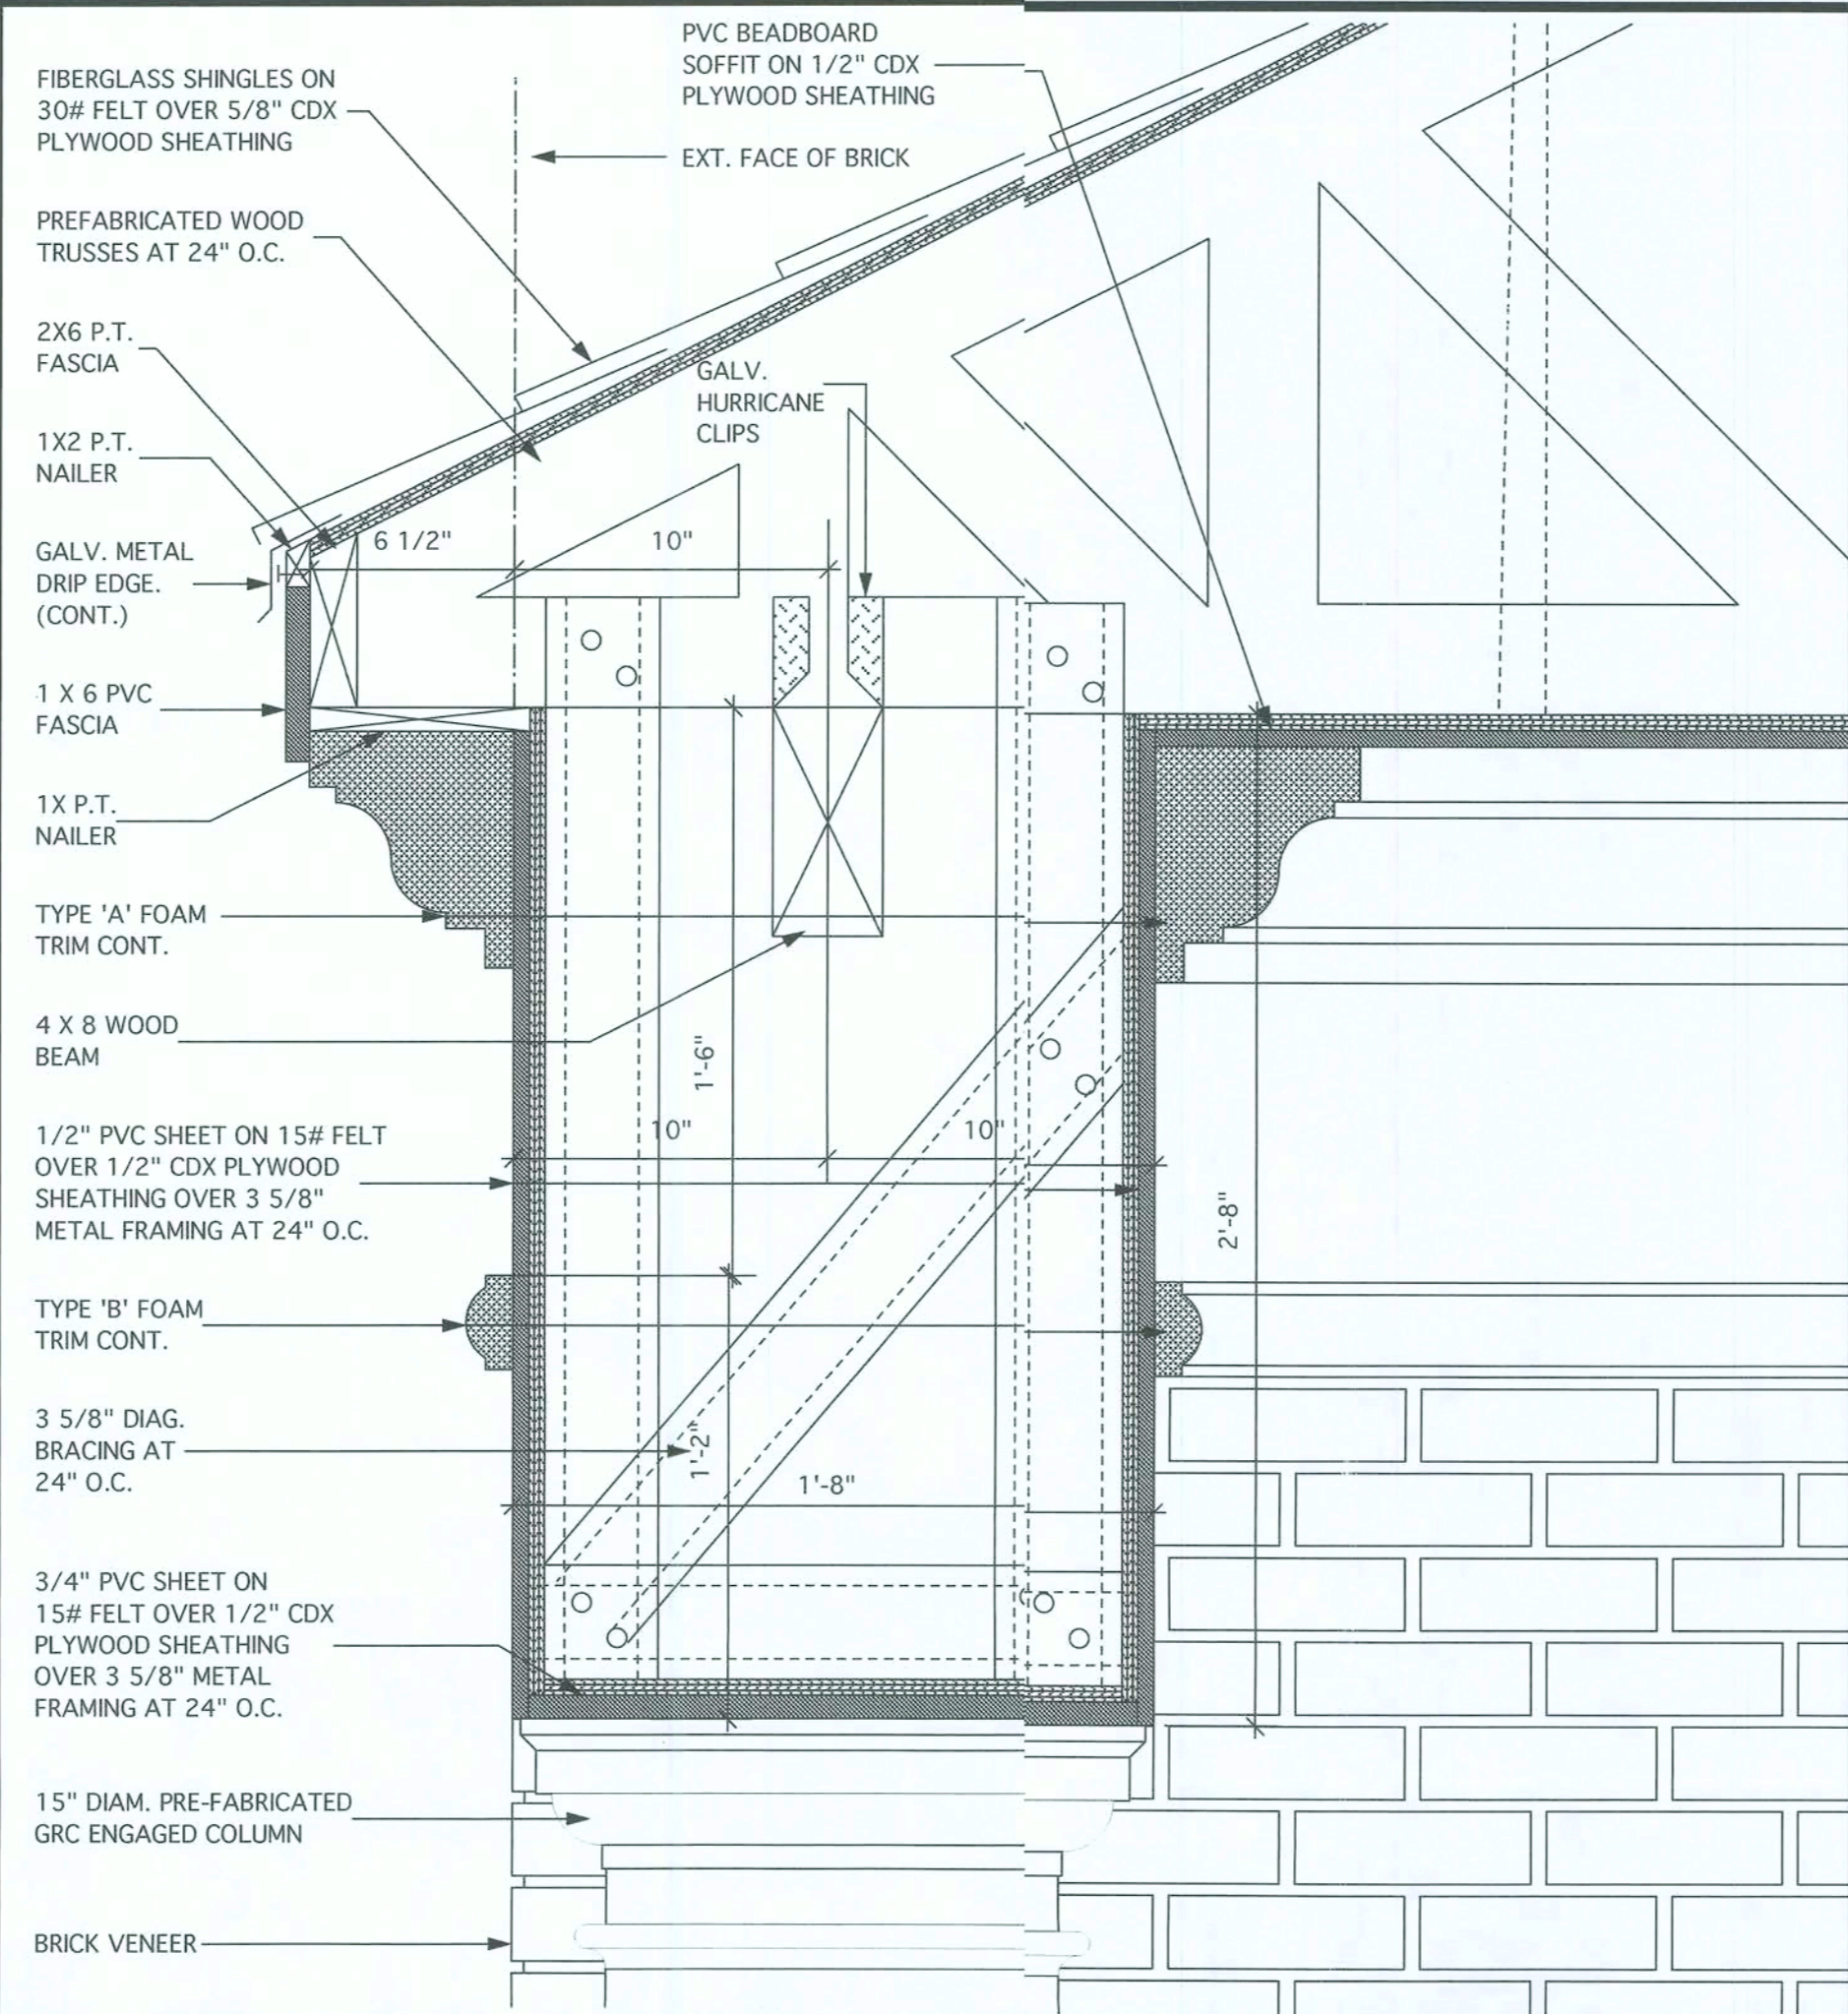



1 DETAIL - ROOF EAVE

SCALE: 3" = 1'-0"




2 DETAIL - ROOF EAVE

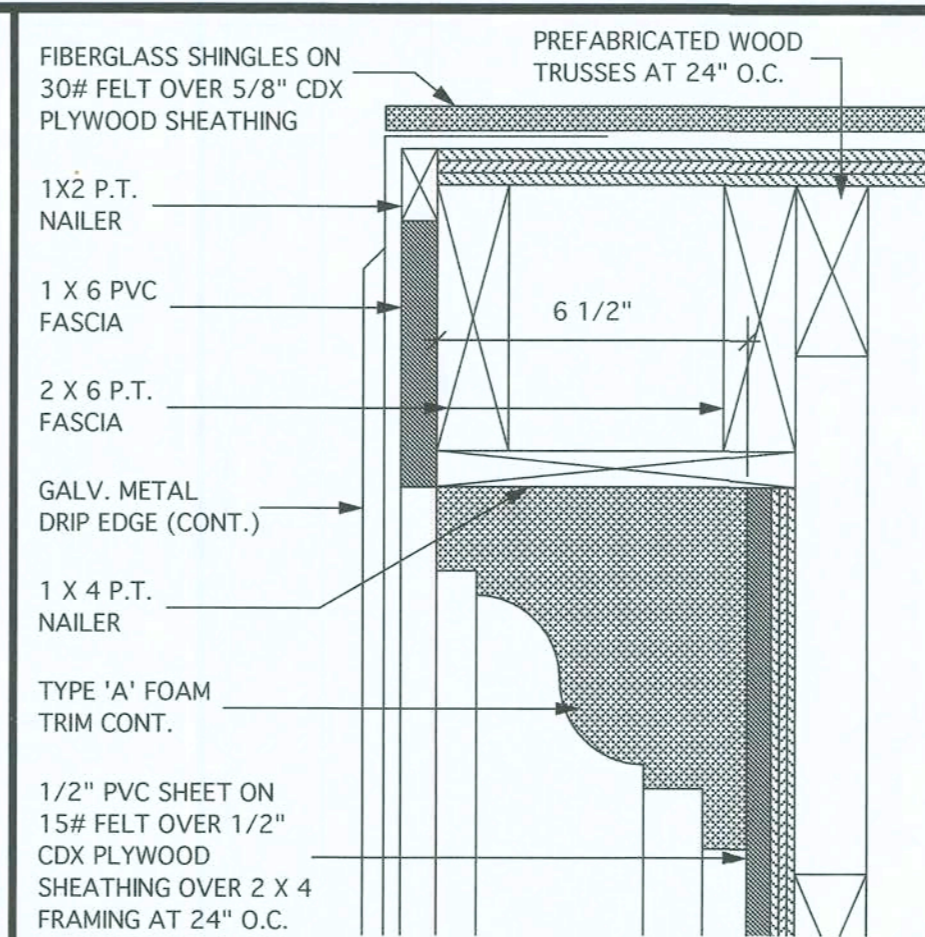SCALE: 2" = 1'-0"




3 DETAIL - GABLE END

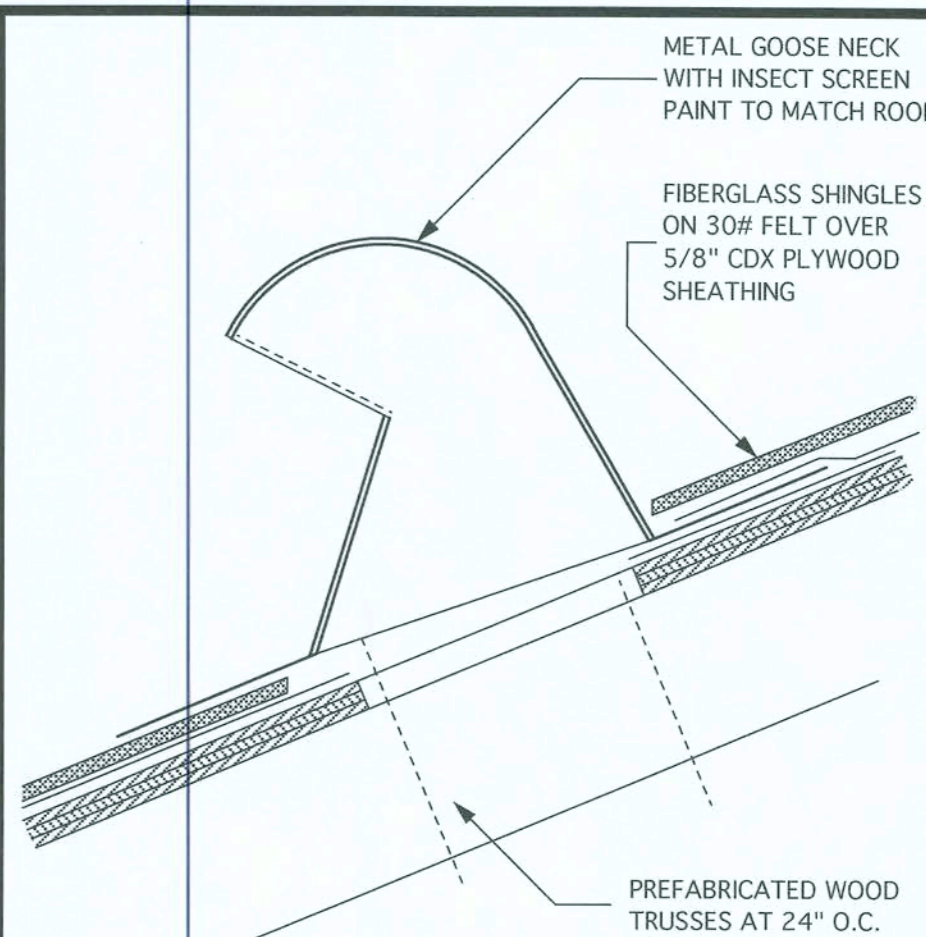SCALE: 3" = 1'-0"




4 DETAIL - GOOSENECK

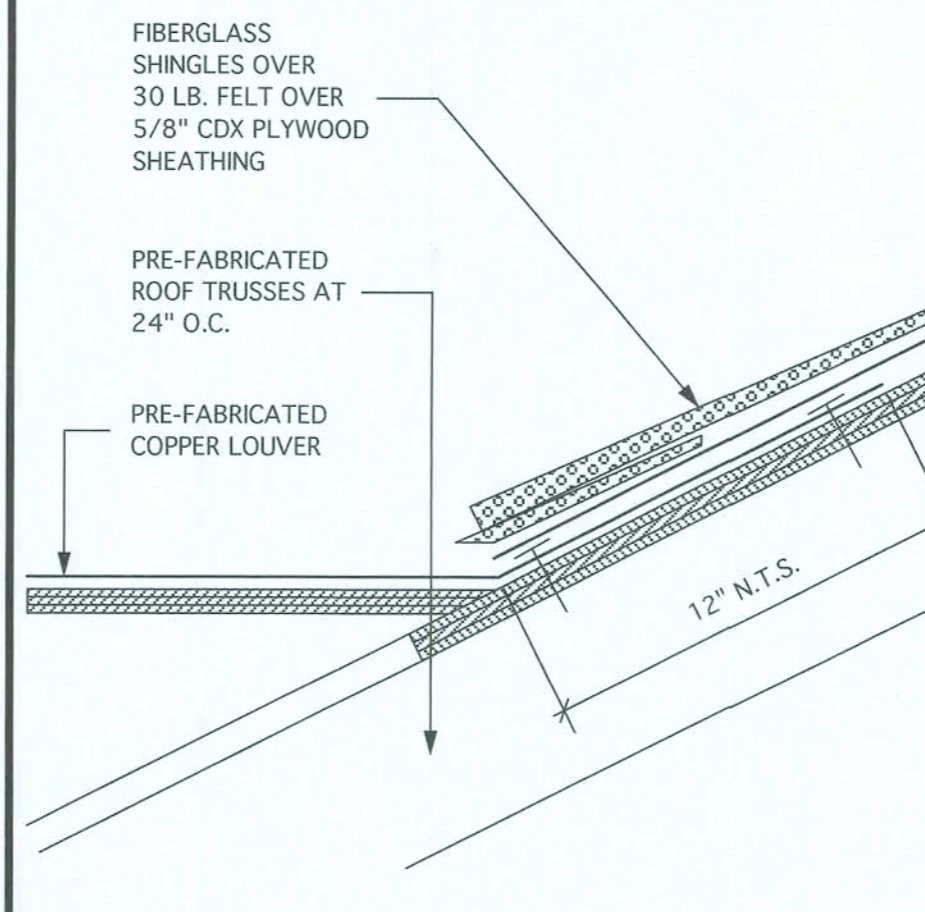SCALE: 3" = 1'-0"




5 DETAIL - LOUVERED DORMER

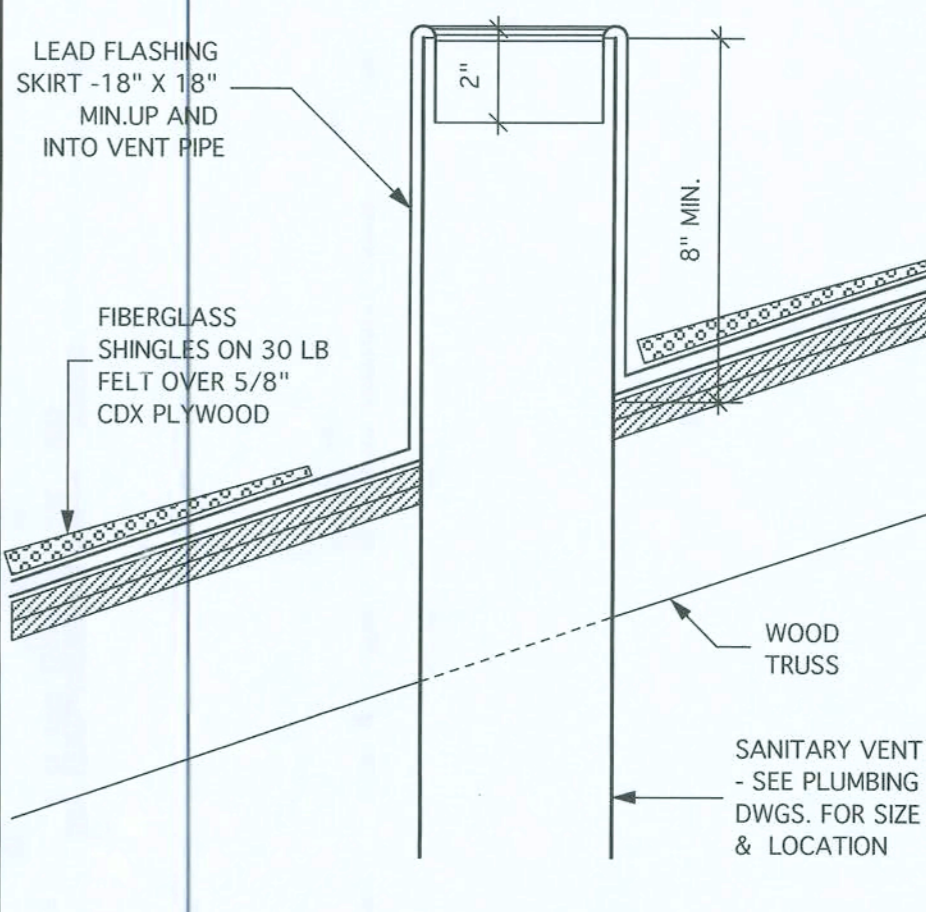SCALE: 3" = 1'-0" AT TOP OF LOUVER




6 DETAIL - VENT THRU ROOF

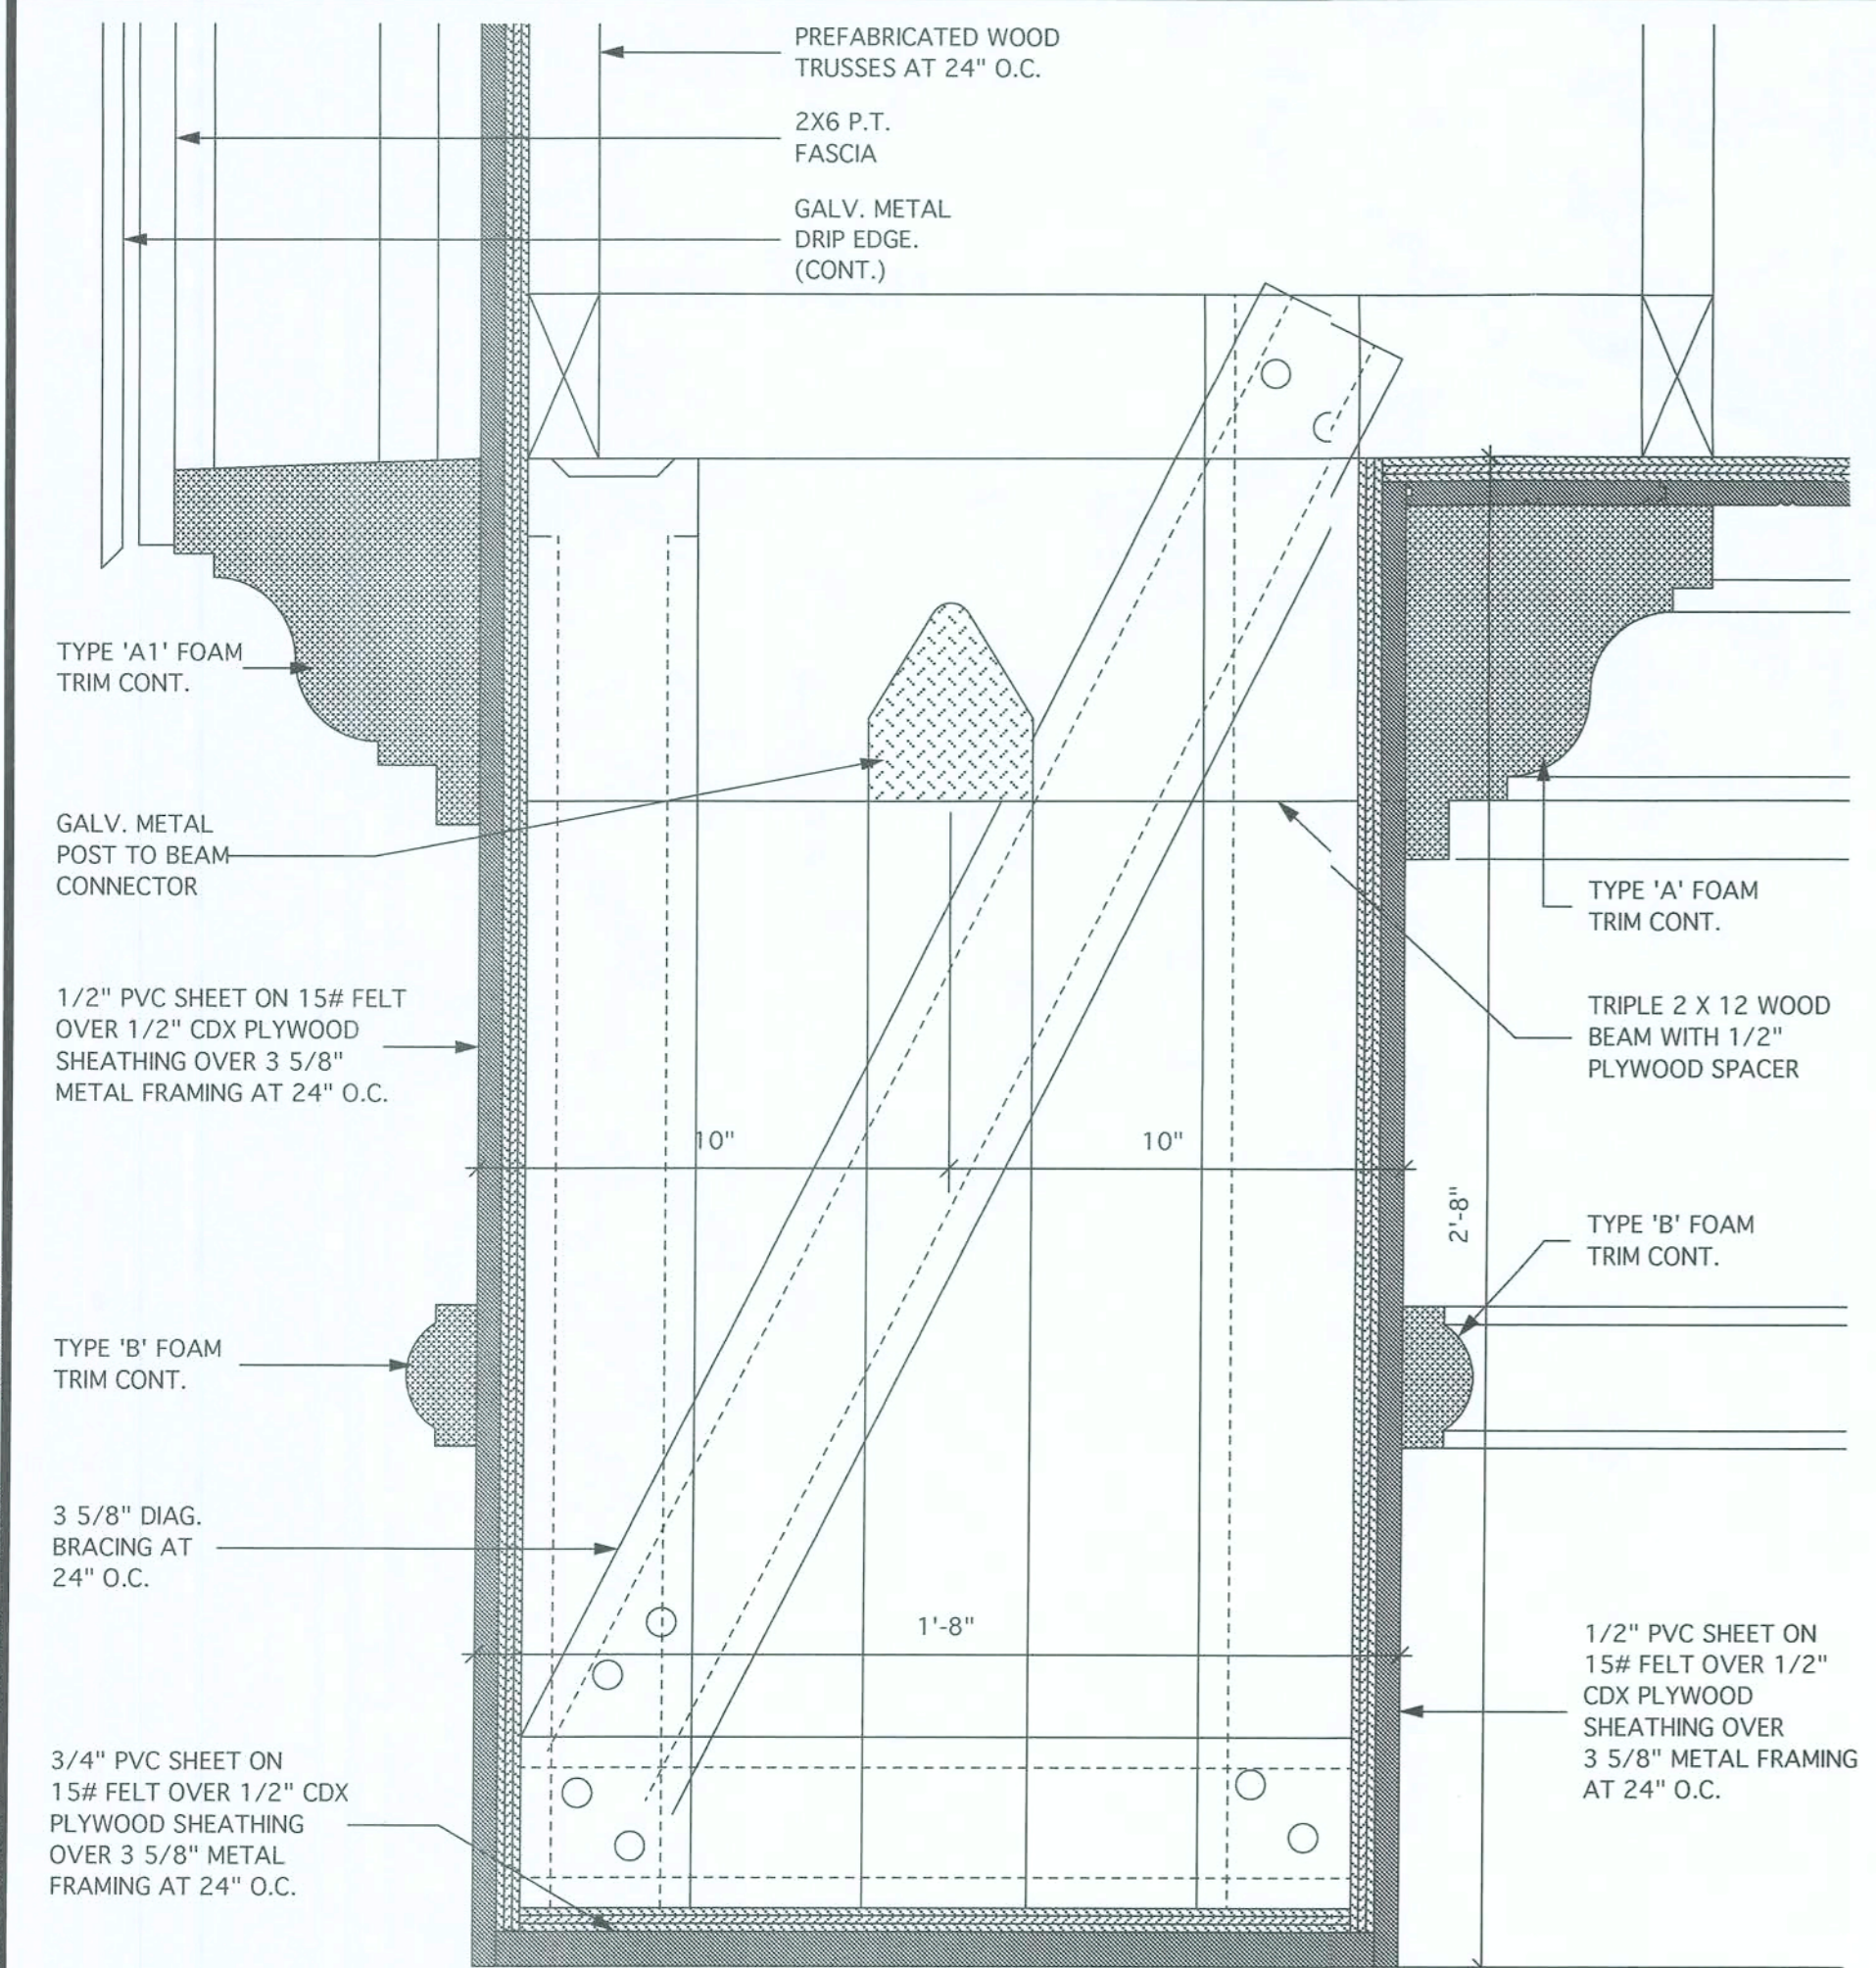SCALE: 3" = 1'-0"




7 DETAIL - ROOF EAVE

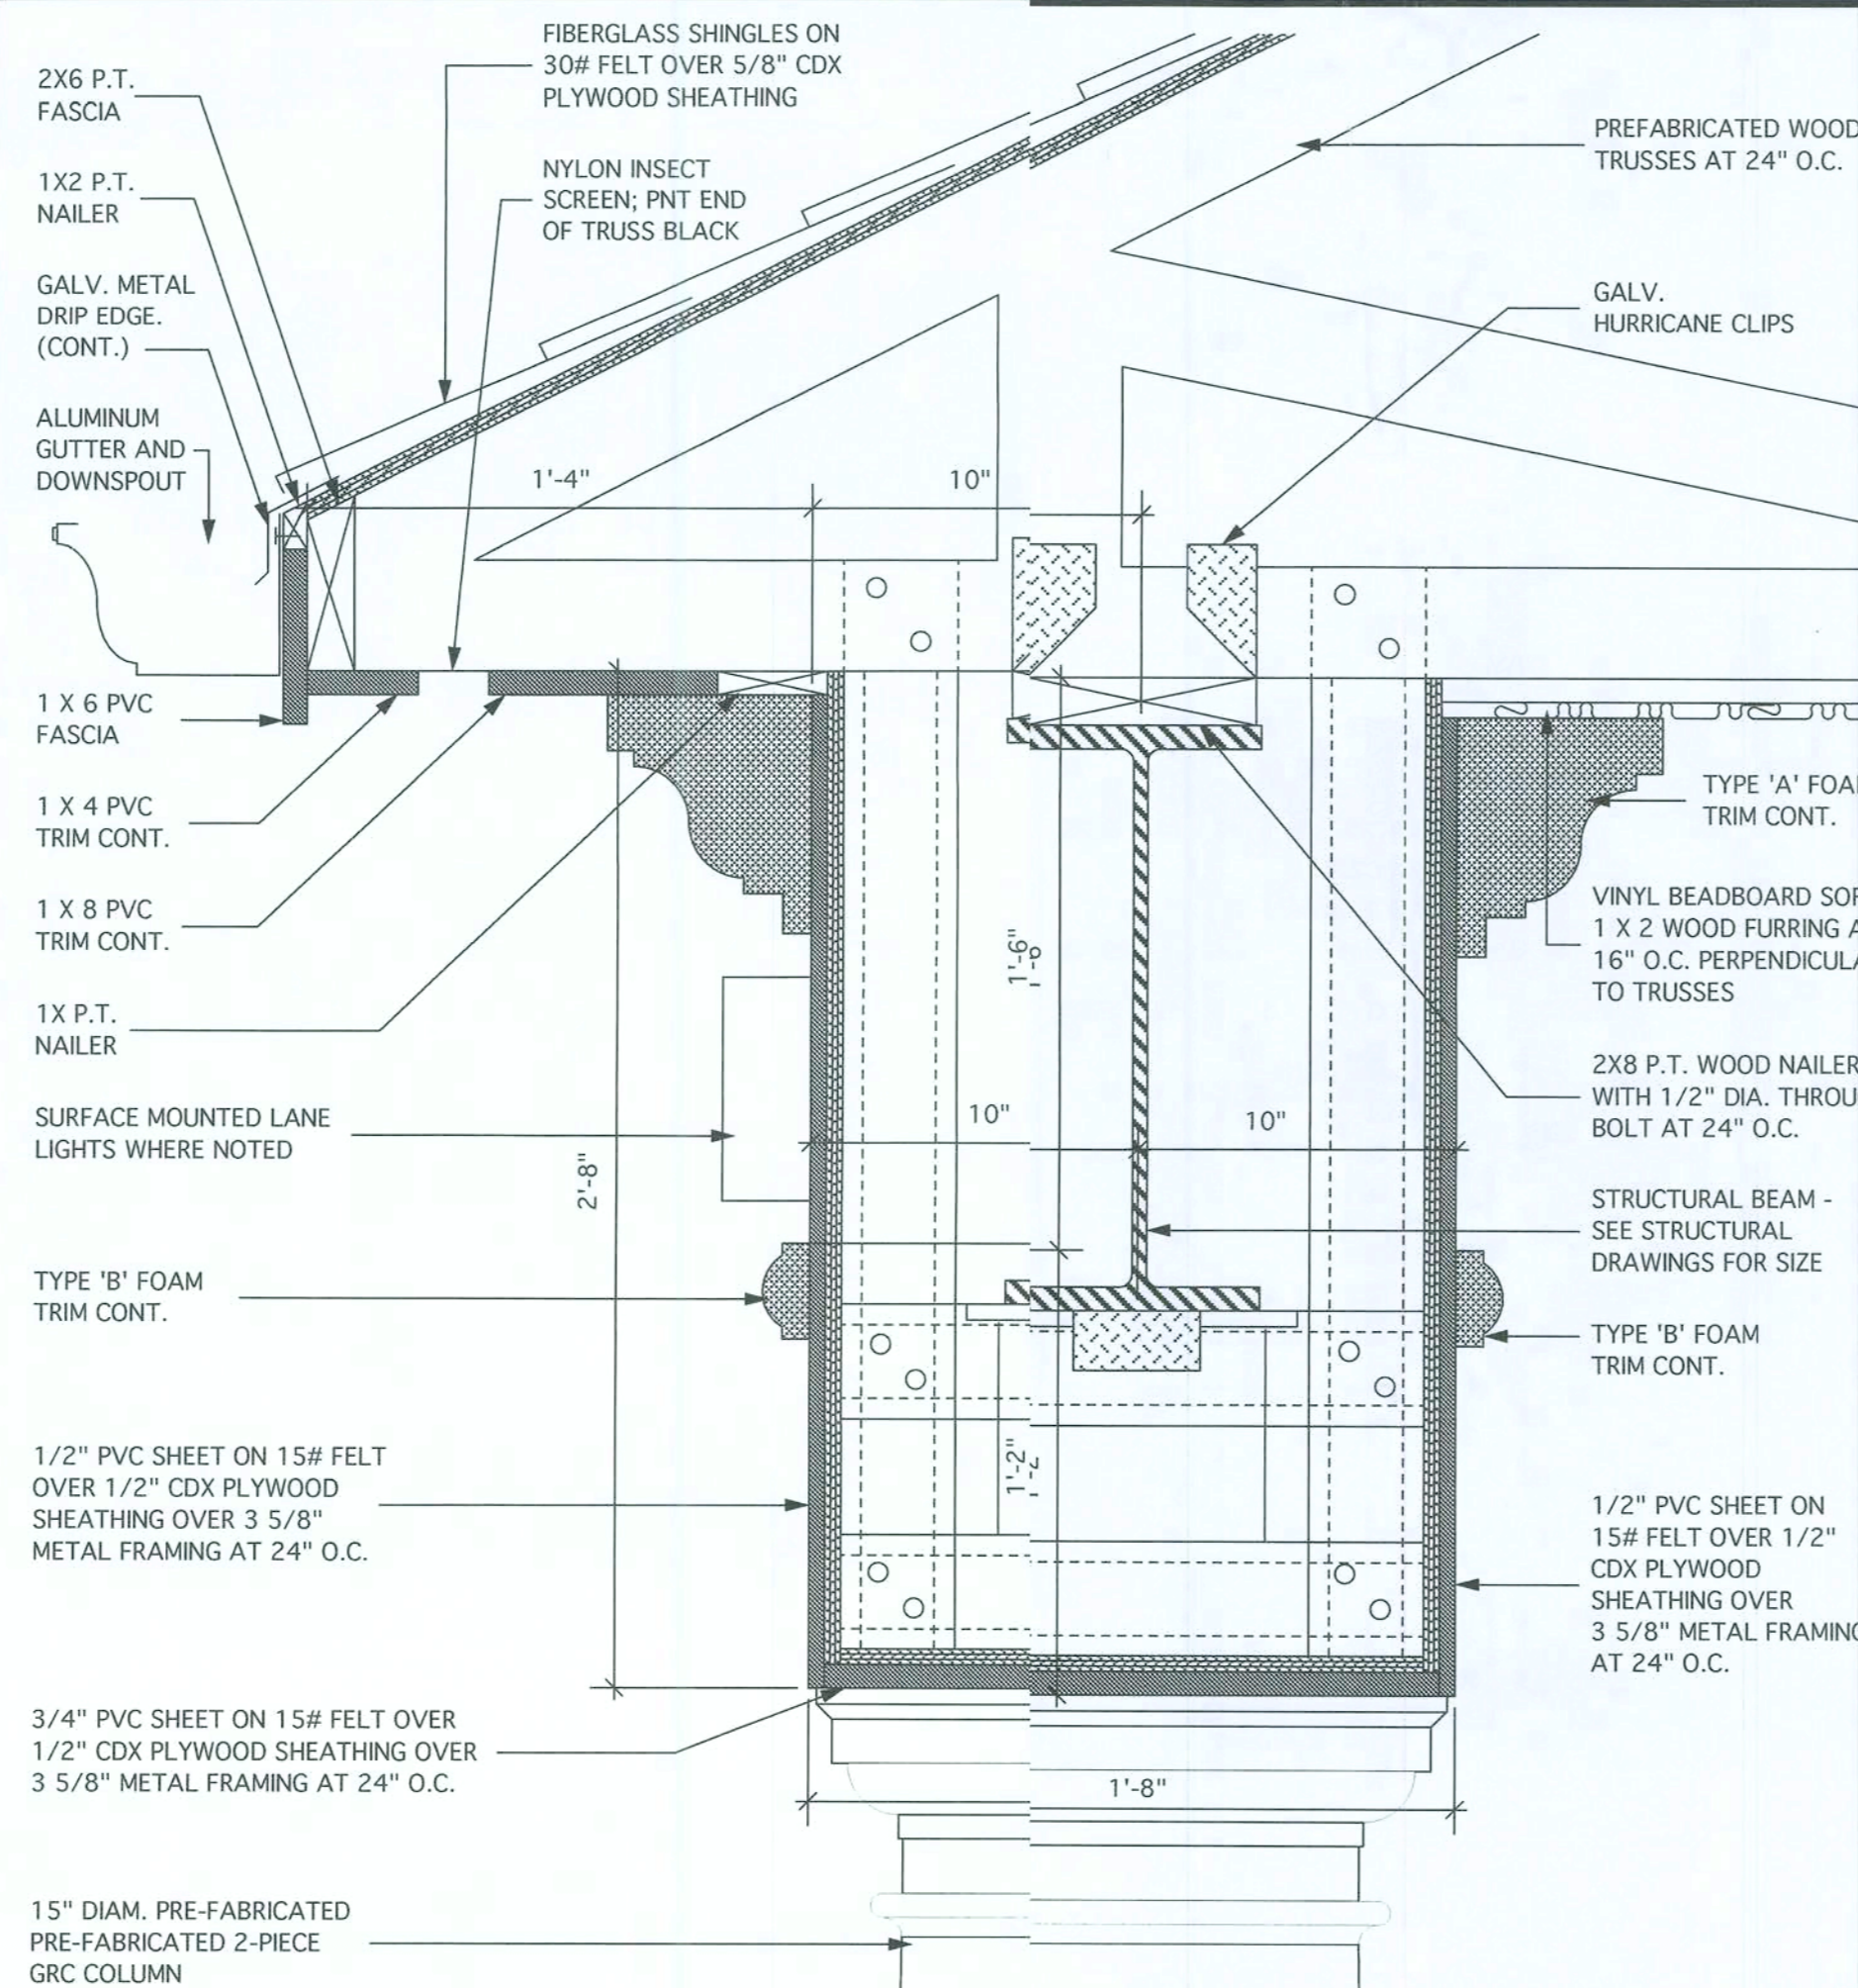SCALE: 3" = 1'-0"



8 DETAIL - ROOF EAVE

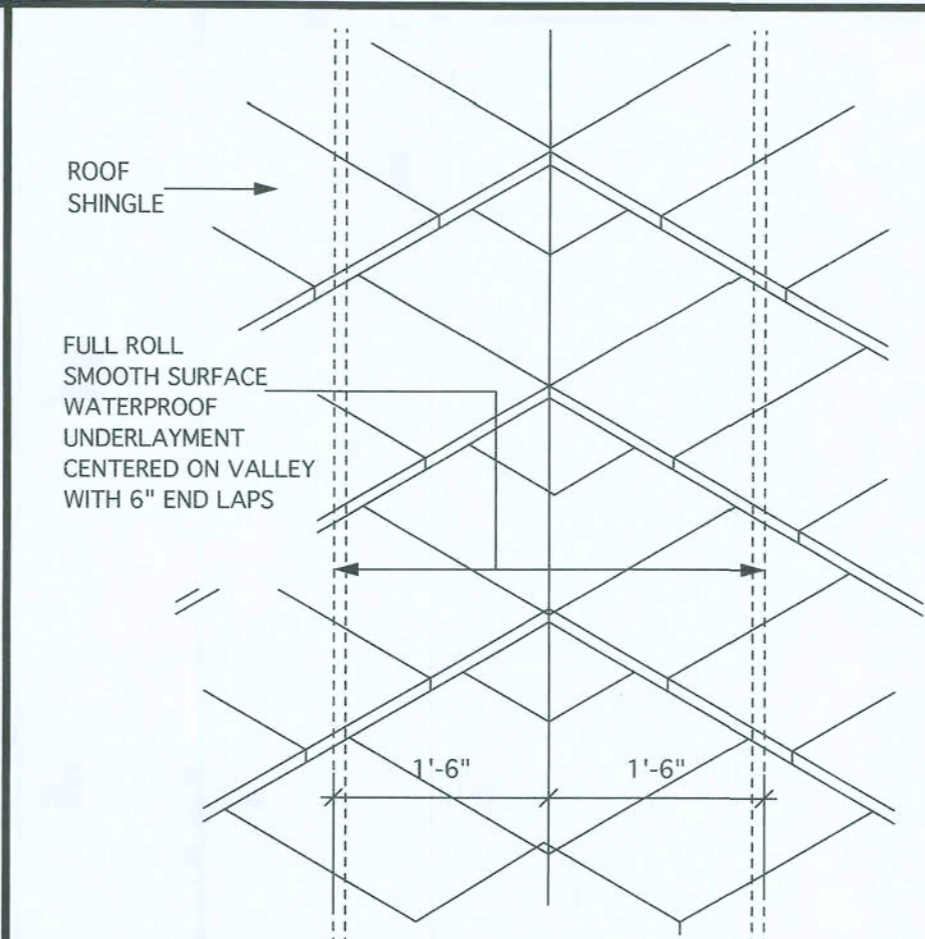SCALE: 2" = 1'-0"



9 DETAIL - ROOF VALLEY - CLOSED

SCALE: 3/4" = 1'-0"



10

9

11

12

DESIGN SERVICES INCORPORATED
1778 N. PARK AVENUE, SUITE 100, MAITLAND, FL 32751,
TELEPHONE (407) 629-5755

WEST OFFICE
(NEW BRANCH BANK)
LAKE CITY, FLORIDA

PEOPLES
STATE BANK

LICENSE NO. F00061

ARCHITECTURE
INTERIOR DESIGN
SPACE PLANNING

GENERAL NOTES

FASTENERS NOTES:

METAL STUD TO METAL STUD - MIN. 2 - NO. 10 PAN HEAD SELF TAPPING SCREWS AT EACH JOINT

METAL STUD TO CONCRETE - HLT-1 DMI 22P8 POWER ACTUATED FASTENERS AT 12" O.C. AT CONTINUOUS TRACKS OR MIN. 2 AT EACH JOINT - PROVIDE 1 1/4" PENETRATION

METAL STUD TO WOOD - NO. 10 FLAT HEAD COUNTERSUNK SELF TAPPING SCREWS AT 12" O.C. AT CONTINUOUS TRACKS OR MIN. 2 AT EACH JOINT - PROVIDE 1 1/4" PENETRATION

PLYWOOD TO METAL STUD - NO. 10 FLAT HEAD COUNTERSUNK SELF TAPPING SCREWS AT 6" O.C. AT EDGES 12" O.C. INTERMEDIATE

2 X WOOD TO 2 X WOOD - STUD TO PLATE - TOE NAIL - 4 - 8d COMMON STUD TO PLATE - FACE - 2 - 16d - COMMON STUD TO STUD - FACE - 2 - 16d COMMON

2 X WOOD TO CONCRETE - 1/4" TAPCONS AT 12" O.C. AT CONTINUOUS TRACKS OR MIN. 2 AT EACH JOINT - PROVIDE 1" PENETRATION

PLYWOOD TO 2 X WOOD - 8d COMMON 6" O.C. AT DGES, 12" O.C. INTERMEDIATE

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INTERIOR ELEVATION KEY

MARK DATE REVISIONS

COMM. NO. 06003.00 DRAWN: KLP

DATE: 02/15/06 CHECKED: ELM

SCALE: AS NOTED

FILE: 06003.00-DETAILS 30 (ROOF)

DETAILS

SEAL

ARCHITECT/CONSULTANT

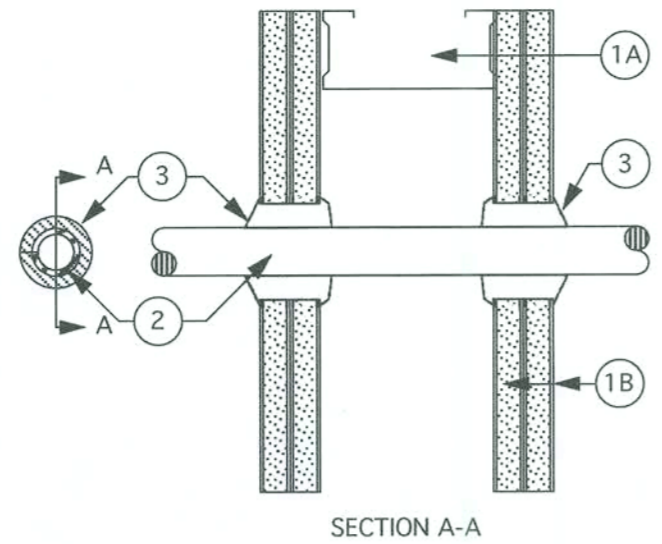
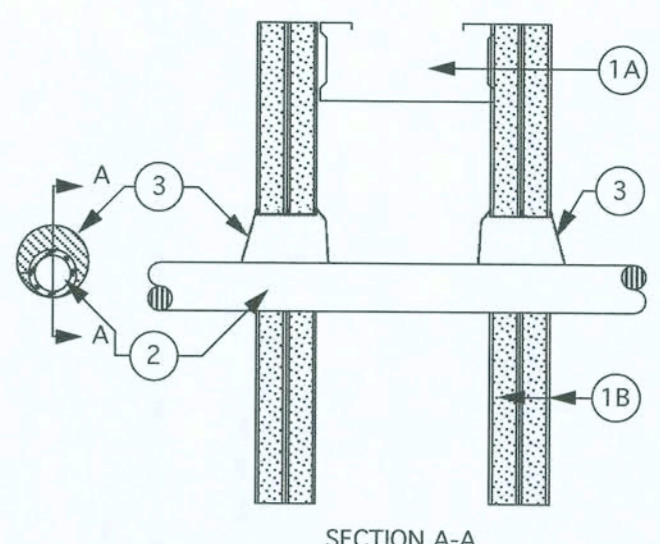
EDDIE L. MUSE

JUN 07 2006

LICENSE NO. AR-12112

SHEET NUMBER

A-8.30

<div>SYSTEM NO. W-L-1001</div> <div>F RATINGS - 1, 2, 3 AND 4 HR (SEE ITEMS 2 AND 3) T RATINGS - 0, 1, 2, 3 AND 4 HR (SEE ITEM 3) L RATING AT AMBIENT - LESS THAN 1 CM/SQ FT L RATING AT 400° F - LESS THAN 1 CM/SQ FT</div> <div>1. WALL ASSEMBLY - THE 1, 2, 3, OR 4 HR FIRE RATED GYPSUM WALLBOARD/STUD WALL ASSEMBLY SHALL BE CONSTRUCTED OF THE MATERIALS AND IN THE MANNER DESCRIBED IN THE INDIVIDUAL U300 OR U400 SERIES WALL OR PARTITION DESIGNS IN THE UL FIRE RESISTANCE DIRECTORY AND SHALL INCLUDE THE FOLLOWING CONSTRUCTION FEATURES: A. STUDS - WALL FRAMING MAY CONSIST OF EITHER WOOD STUDS (MAX 2 HR FIRE RATED ASSEMBLY) OR STEEL CHANNEL STUDS. WOOD STUDS TO CONSIST OF NOM 2 BY 4 IN LUMBER SPACED 16 IN OC WITH NOM 2 BY 4 IN LUMBER END PLATES AND CROSS BRACES. STEEL STUDS TO BE MIN. 3-5/8 IN. WIDE BY 1-3/8 IN. DEEP CHANNELS SPACED MAX 24 IN. OC. B. WALLBOARD, GYPSUM - NOM 1/2 OR 5/8 IN. THICK, 4 FT. WIDE WITH SQUARE OR TAPERED EDGES. THE GYPSUM WALLBOARD TYPE, THICKNESS, NUMBER OF LAYERS, FASTENER TYPE AND SHEET ORIENTATION SHALL BE AS SPECIFIED IN THE INDIVIDUAL U300 OR U400 SERIES DESIGN IN THE UL FIRE RESISTANCE DIRECTORY. MAX. DIAM OF OPENING IS 13-1/2 IN. C. PIPE OR CONDUIT - NOM 12 IN. DIAM (OR SMALLER) SCHEDULE 10 (OR HEAVIER) STEEL PIPE, NOM 12 IN. DIAM (OR SMALLER) SERVICE WEIGHT (OR HEAVIER) CAST IRON SOIL PIPE, NOM 12 IN. DIAM (OR SMALLER) CLASS 50 (OR HEAVIER) DUCTILE IRON PIPE, NOM 6 IN. DIAM (OR SMALLER) STEEL CONDUIT, NOM 4 IN. DIAM (OR SMALLER) STEEL ELECTRICAL METAL TUBING, NOM 6 IN. DIAM (OR SMALLER) TYPE L OR (OR HEAVIER) COPPER TUBING OR NOM 1 IN. DIAM (OR SMALLER) FLEXIBLE STEEL CONDUIT. WHEN COPPER PIPE IS USED, MAX F RATING OF FIRESTOP SYSTEM (ITEM 3) IS 2 H. STEEL PIPES OR CONDUITS LARGER THAN NOM 4 IN. DIAM MAY ONLY BE USED IN WALLS CONSTRUCTED USING STEEL CHANNEL STUDS. A MAX OF ONE PIPE OR CONDUIT IS PERMITTED IN THE FIRESTOP SYSTEM. PIPE OR CONDUIT TO BE INSTALLED NEAR CENTER OF STUD CAVITY WIDTH AND TO BE RIGIDLY SUPPORTED ON BOTH SIDES OF WALL ASSEMBLY.</div> <div></div> <div>2. CABLES - INDIVIDUAL CABLE OR MAX 1 IN. DIAM. CABLE BUNDLE INSTALLED IN THROUGH OPENING WITH ANNUAL SPACE OF 0 IN. (POINT OF CONTACT) TO MAX. 3/4 IN. CABLE TO BE RIGIDLY SUPPORTED ON BOTH SIDES OF WALL ASSEMBLY. THE FOLLOWING TYPES AND SIZES OF CABLES MAY BE USED: A. MAX 150 PAIR, 24 AWG COPPER CONDUCTOR OR TELEPHONE CABLE WITH POLYVINYL WALLBOARD (ON INSULATION AND JACKET MATERIALS). WHEN MAX 25 PAIR TELEPHONE CABLE IS USED, F RATING IS 2 HR. WHEN 50 TO 150 PAIR TELEPHONE CABLE IS USED IN 1 HR FIRE RATED WALL, F RATING IS 1 HR. B. MAX. NO. 10 JG MULTIPLE COPPER CONDUCTOR TYPE NM (BOMEX) NONMETALLIC SHEATHED CLE WITH PVC INSULATION AND JACKET MATERIALS. WHEN TYPE NM CABLE IS USED, MAX. RATING IS 1 1/2 HR. C. MULTIPLE FIBEROPTICAL COMMUNICATION CABLE JACKETED WITH PVC AND HAVING A OUTSIDE DIAM OF 5/8 IN. WHEN FIBER OPTIC CABLE IS USED, MAX. F RATING IS 2 HR. D. MAX 12 AWG ULTRACONDUCTOR (MAX SEVEN CONDUCTORS) POWER/CONTROL CABLE WITH CROSS LINKED ETHYLENE POLYMER (XLPE) INSULATION AND XLPE OR PVC JACKET MATERIALS. WHEN MULTILINDUCTOR POWER/CONTROL CABLE IS USED, MAX. F RATING IS 2 HR. E. MAX FOUR CONDUCTOR WITH GROUND NO. 2 AWG (OR SMALLER) ALUMINUM SER CABLES WITH POLYVYL CHLORIDE INSULATION AND JACKET MATERIALS. 3. FILL, VOID OR CAVITY MATERIAL - CAULK - CAULK OR PUTTY FILL MATERIAL. INSTALLED TO COMPLETELY FILL ANNUAL SPACE BETWEEN CABLE AND GYPSUM WALLBOARD AND/OT A MIN 1/4 IN. DIAM BEAD OF CAULK APPLIED TO PERIMETER OF PIPE OR CONDUIT AT ITS EGRESS FROM THE WALL. CAULK INSTALLED SYMMETRICALLY ON BOTH SIDES OF WALL ASSEMBLY. THE HOURLY F RATING OF THE FIRESTOP SYSTEM IS DEPENDENT UPON THE HOURLY FIRE RATINGS OF THE WALL ASSEMBLY IN WHICH IT IS INSTALLED, AS SPECIFIED IN THE FOLLOWING TABLE. THE HOURLY F RATING OF THE FIRESTOP SYSTEMS DEPENDENT UPON THE TYPE OR SIZE OF THE PIPE OR CONDUIT AND THE HOURLY FIRE RATINGS OF THE WALL ASSEMBLY IN WHICH IT IS INSTALLED, AS TABULATED BELOW: M IN PIPE OR CONDUIT (C) OT T RATING, HR DIAM. IN. RATING, HR VENTED (V) 1 0 TO 3/16 1 OR 2 0-1 OR 2 1 1/4 TO 1/2 3 OR 4 3 OR 4 3/4 0 TO 1/4 1 OR 2 0 0 TO 1/4 1 OR 2 0 1/2 TO 1/2 3 OR 4 0 1 1/4 TO 1/2 3 OR 4 0 1 3/8 IN. DEEP CHANNELS SPACED MAX 24 IN. OC WHEN COPPER PIPE USE, T RATING IS 0 H. OT 1 1/2 IN. ANNUAL SPACE APPLIES ONLY WHEN TYPE CP-25 WB+ CAULK IS USED AND ONLY WHEN THIN THICKNESS OF THE GYPSUM WALLBOARD IS 5/8 IN. FOR 1 HR RATED WALLS AND 1/4 IN. FOR 2 HR RATED WALLS MINNESOTA MINING & MFG. CO. - CP 25WB+ BEARING UL CLASSIFICATION MARKING</div> <div>SYSTEM NO. W-L-2088</div> <div>F RATINGS - 1 & 2 HR (SEE ITEM 1) T RATINGS - 0, 1, & 2 (SEE ITEM 2) L RATING AT AMBIENT - LESS THAN 1 CM/SQ FT L RATING AT 400° F - LESS THAN 1 CM/SQ FT</div> <div>1. WALL ASSEMBLY - THE 1 OR 2 HR FIRE RATED GYPSUM WALLBOARD/STUD WALL ASSEMBLY SHALL BE CONSTRUCTED OF THE MATERIALS AND IN THE MANNER DESCRIBED IN THE INDIVIDUAL U300 OR U400 SERIES WALL OR PARTITION DESIGNS IN THE UL FIRE RESISTANCE DIRECTORY AND SHALL INCLUDE THE FOLLOWING CONSTRUCTION FEATURES: A. STUDS - WALL FRAMING MAY CONSIST OF EITHER WOOD STUDS (MAX 2 HR FIRE RATED ASSEMBLY) OR STEEL CHANNEL STUDS. WOOD STUDS TO CONSIST OF NOM 2 BY 4 IN LUMBER SPACED 16 IN. OC. STEEL STUDS TO BE MIN. 3-1/2 IN. WIDE AND SPACED MAX 24 IN. OC. B. WALLBOARD, GYPSUM - THICKNESS, TYPE, NUMBER OF LAYERS AND FASTENERS AS REQUIRED IN THE INDIVIDUAL WALL AND PARTITION DESIGN. DIAMETER OF OPENING SHALL BE 7/8 IN. LARGER THAN THE OUTSIDE DIAMETER PIPE OR CONDUIT (ITEM 2). C. THROUGH PENETRANTS - ONE NONMETALLIC PIPE OR CONDUIT TO BE INSTALLED EITHER CONCENTRICALLY OR ECCENTRICALLY WITHIN THE FIRESTOP SYSTEM. THE ANNUAL SPACE BETWEEN PIPE OR CONDUIT AND PERIPHERY OF OPENING FOR NOM 1 1/4 IN. DIAMETER (OR SMALLER) PIPE OR CONDUIT SHALL BE 0 IN. (POINT CONTACT) TO MAX. 7/8 IN. THE ANNUAL SPACE FOR PIPE OR CONDUIT GREATER THAN NOM 1 1/4 IN. DIAMETER SHALL MIN. 1/2 IN. TO MAX. 1 IN. PIPE OR CONDUIT TO BE RIGIDLY SUPPORTED ON BOTH SIDES OF WALL ASSEMBLY. THE FOLLOWING TYPES AND SIZES OF NON METALLIC PIPES OR CONDUITS MAY BE USED: A. POLYVINYL CHLORIDE (PVC) - NOM 2 IN. DIAMETER (OR SMALLER) SCHEDULE 40 SOLID CORE PVC PIPE FOR USE IN CLOSED (PROCESS OR SUPPLY) OR VENTED (DRAIN, WASTE OR VENT) PIPING SYSTEM. B. CHLORINATED POLYVINYL CHLORIDE (CPVC) PIPE - NOM 2 IN. DIAMETER (OR SMALLER) SDR17 CPVC PIPE FOR USE IN CLOSED (PROCESS OR SUPPLY) OR VENTED (DRAIN, WASTE, OR VENT) PIPING SYSTEM. C. POLYVINYL CHLORIDE (PVC) - NOM 3 IN. DIAMETER (OR SMALLER) SCHEDULE 40 SOLID CORE PVC PIPE FOR USE IN CLOSED (PROCESS OR SUPPLY) PIPING SYSTEMS. D. CHLORINATED POLYVINYL CHLORIDE (CPVC) PIPE - NOM 3 IN. DIAMETER (OR SMALLER) SDR17 CPVC PIPE FOR USE IN CLOSED (PROCESS OR SUPPLY) PIPING SYSTEMS. E. RIGID NONMETALLIC CONDUIT - NOM 3 IN. DIAMETER (OR SMALLER) SCHEDULE 40 PVC CONDUIT INSTALLED IN ACCORDANCE WITH ARTICLE 347 OF THE NATIONAL ELECTRIC CODE (NFPA NO. 70). F. ELECTRICAL NONMETALLIC TUBING (ENT) - NOM 1 IN. DIAMETER (OR SMALLER) ENT FORMED OF PVC, INSTALLED IN ACCORDANCE WITH ARTICLE 331 OF THE NATIONAL ELECTRIC CODE (NFPA NO. 70). SEE RIGID NONMETALLIC CONDUIT (DZRT) AND ELECTRICAL NONMETALLIC TUBING (ENT) IN ULL CONSTRUCTION MATERIALS DIRECTORY FOR NAMES OF MANUFACTURERS. THE HOURLY F RATING IS DEPENDENT ON THE HOURLY RATING OF THE WALL ASSEMBLY, THE PIPE OR CONDUIT SIZE AND WHETHER THE PIPE IS INTENDED FOR USE IN A CLOSED OR VENTED SYSTEM, AS SHOWN IN THE FOLLOWING TABLE: M IN PIPE WALL ASSEMBLY (C) OT T RATING, HR DIAM. IN. RATING, HR VENTED (V) 1 1/2 TO 1 1/4 1 C 1 1/2 TO 1 1/4 1 C 2 1/2 TO 1 1/4 2 V 1 1/2 TO 1 1/4 2 V 0 2 2 V 0 2 2 V 0 3. FILL, VOID OR CAVITY MATERIAL - CAULK OR PUTTY - MIN. THICKNESS OF 5/8 IN. AND 1 1/4 IN. OF CAULK OR PUTTY FOR 1 AND 2 HR RATED WALL ASSEMBLY, RESPECTIVELY. 1. APPLIED WITH ANNUAL SPACE BETWEEN PIPE OR CONDUIT AND PERIPHERY OF THE OPENING, FLUSH WITH BOTH SURFACES OF WALL ASSEMBLY. AT THE POINT CONTACT LOCATION BETWEEN PIPE OR CONDUIT AND GYPSUM WALLBOARD, A MIN. 1/2 IN. DIAMETER BEAD OF CAULK OR PUTTY SHALL BE APPLIED AT THE PIPE OR CONDUIT/WALLBOARD INTERFACE ON BOTH SURFACES OF WALL ASSEMBLY.</div> <div></div> <div>1</div> <div>FIRE RATED WALL PENETRATION SYSTEMS</div> <div>NO SCALE</div> <div>2</div> <div>FIRE RATED WALL PENETRATION SYSTEMS</div> <div>NO SCALE</div> <div>3</div> <div>FIRE RATED WALL PENETRATION SYSTEMS</div> <div>NO SCALE</div> <div>4</div> <div>FIRE RATED WALL PENETRATION SYSTEMS</div> <div>NO SCALE</div> <div>5</div> <div>DETAIL - 1 HOUR FIRE RATED CEILING</div> <div>SCALE: 1/2 FULL</div> <div>6</div> <div>7</div> <div>8</div> <div>9</div> <div>10</div> <div>11</div> <div>12</div> <div>13</div> <div>14</div> <div>15</div>
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06003.00-DETAILS 50 (FR)
Wed, May 24, 2006 10:46:57 AM

DESIGN SERVICES INCORPORATED
1778 N. PARK AVENUE, SUITE 100, MAITLAND, FL 32751,
TELEPHONE (407) 629-5755

ARCHITECTURE
INTERIOR DESIGN
SPACE PLANNING

LICENSE NO. F00061

WEST OFFICE
(NEW BRANCH BANK)
LAKE CITY, FLORIDA

PEOPLES
STATE BANK

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1
4
3
2

INTERIOR
ELEVATION
KEY

MARK DATE REVISIONS

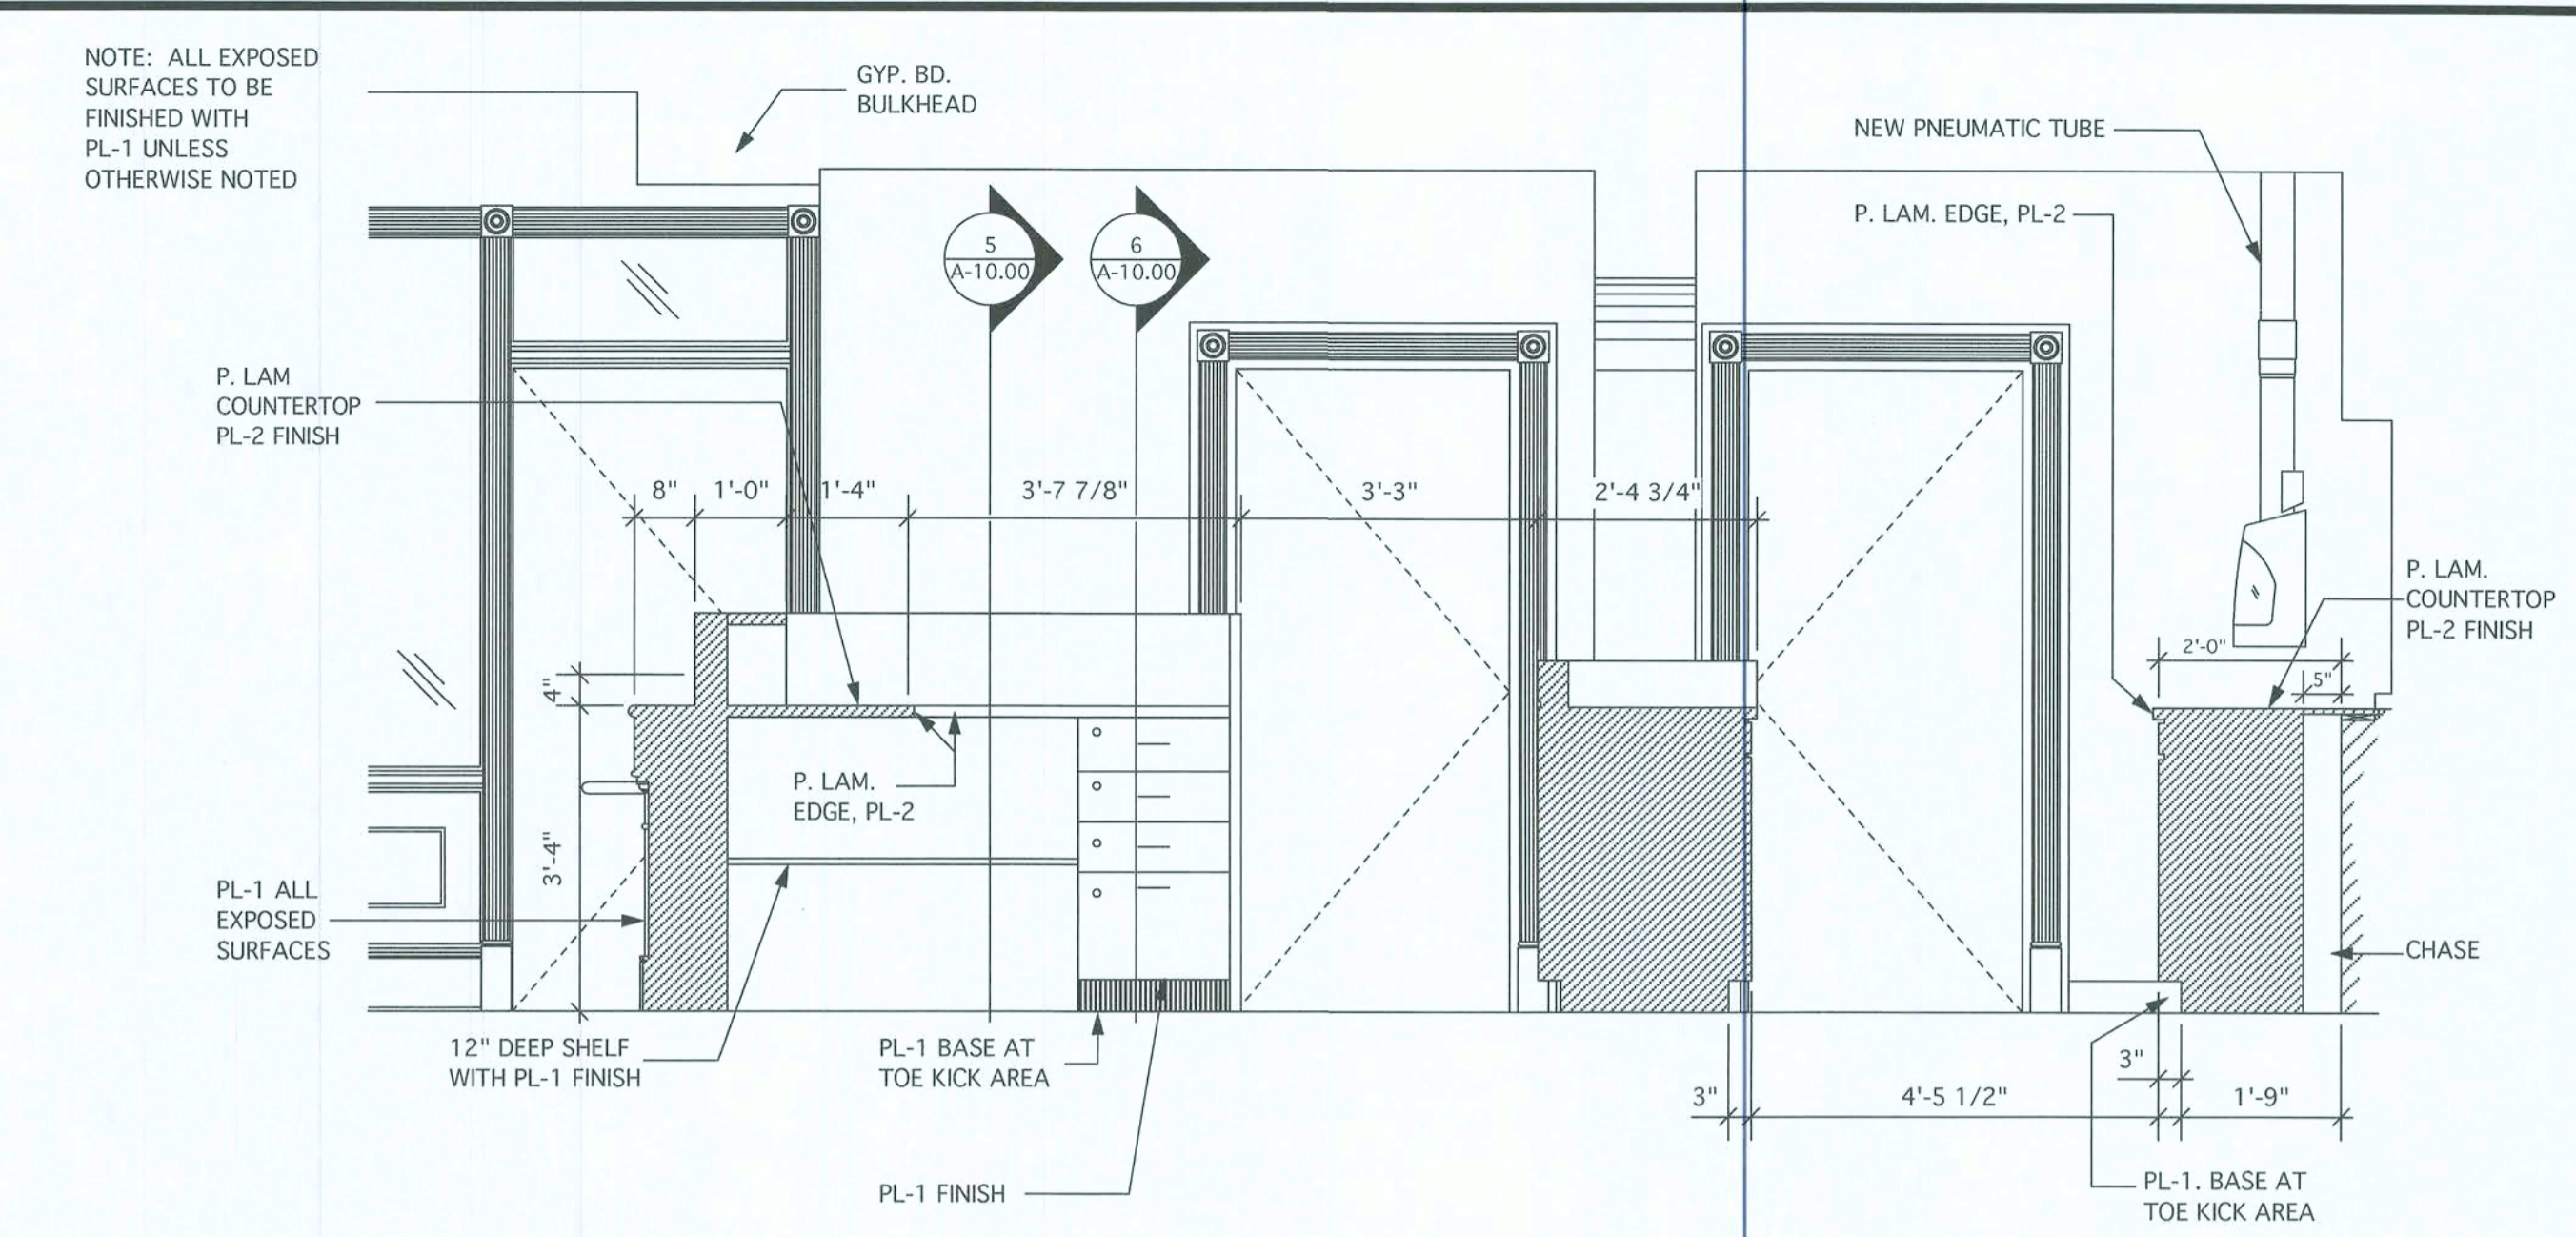
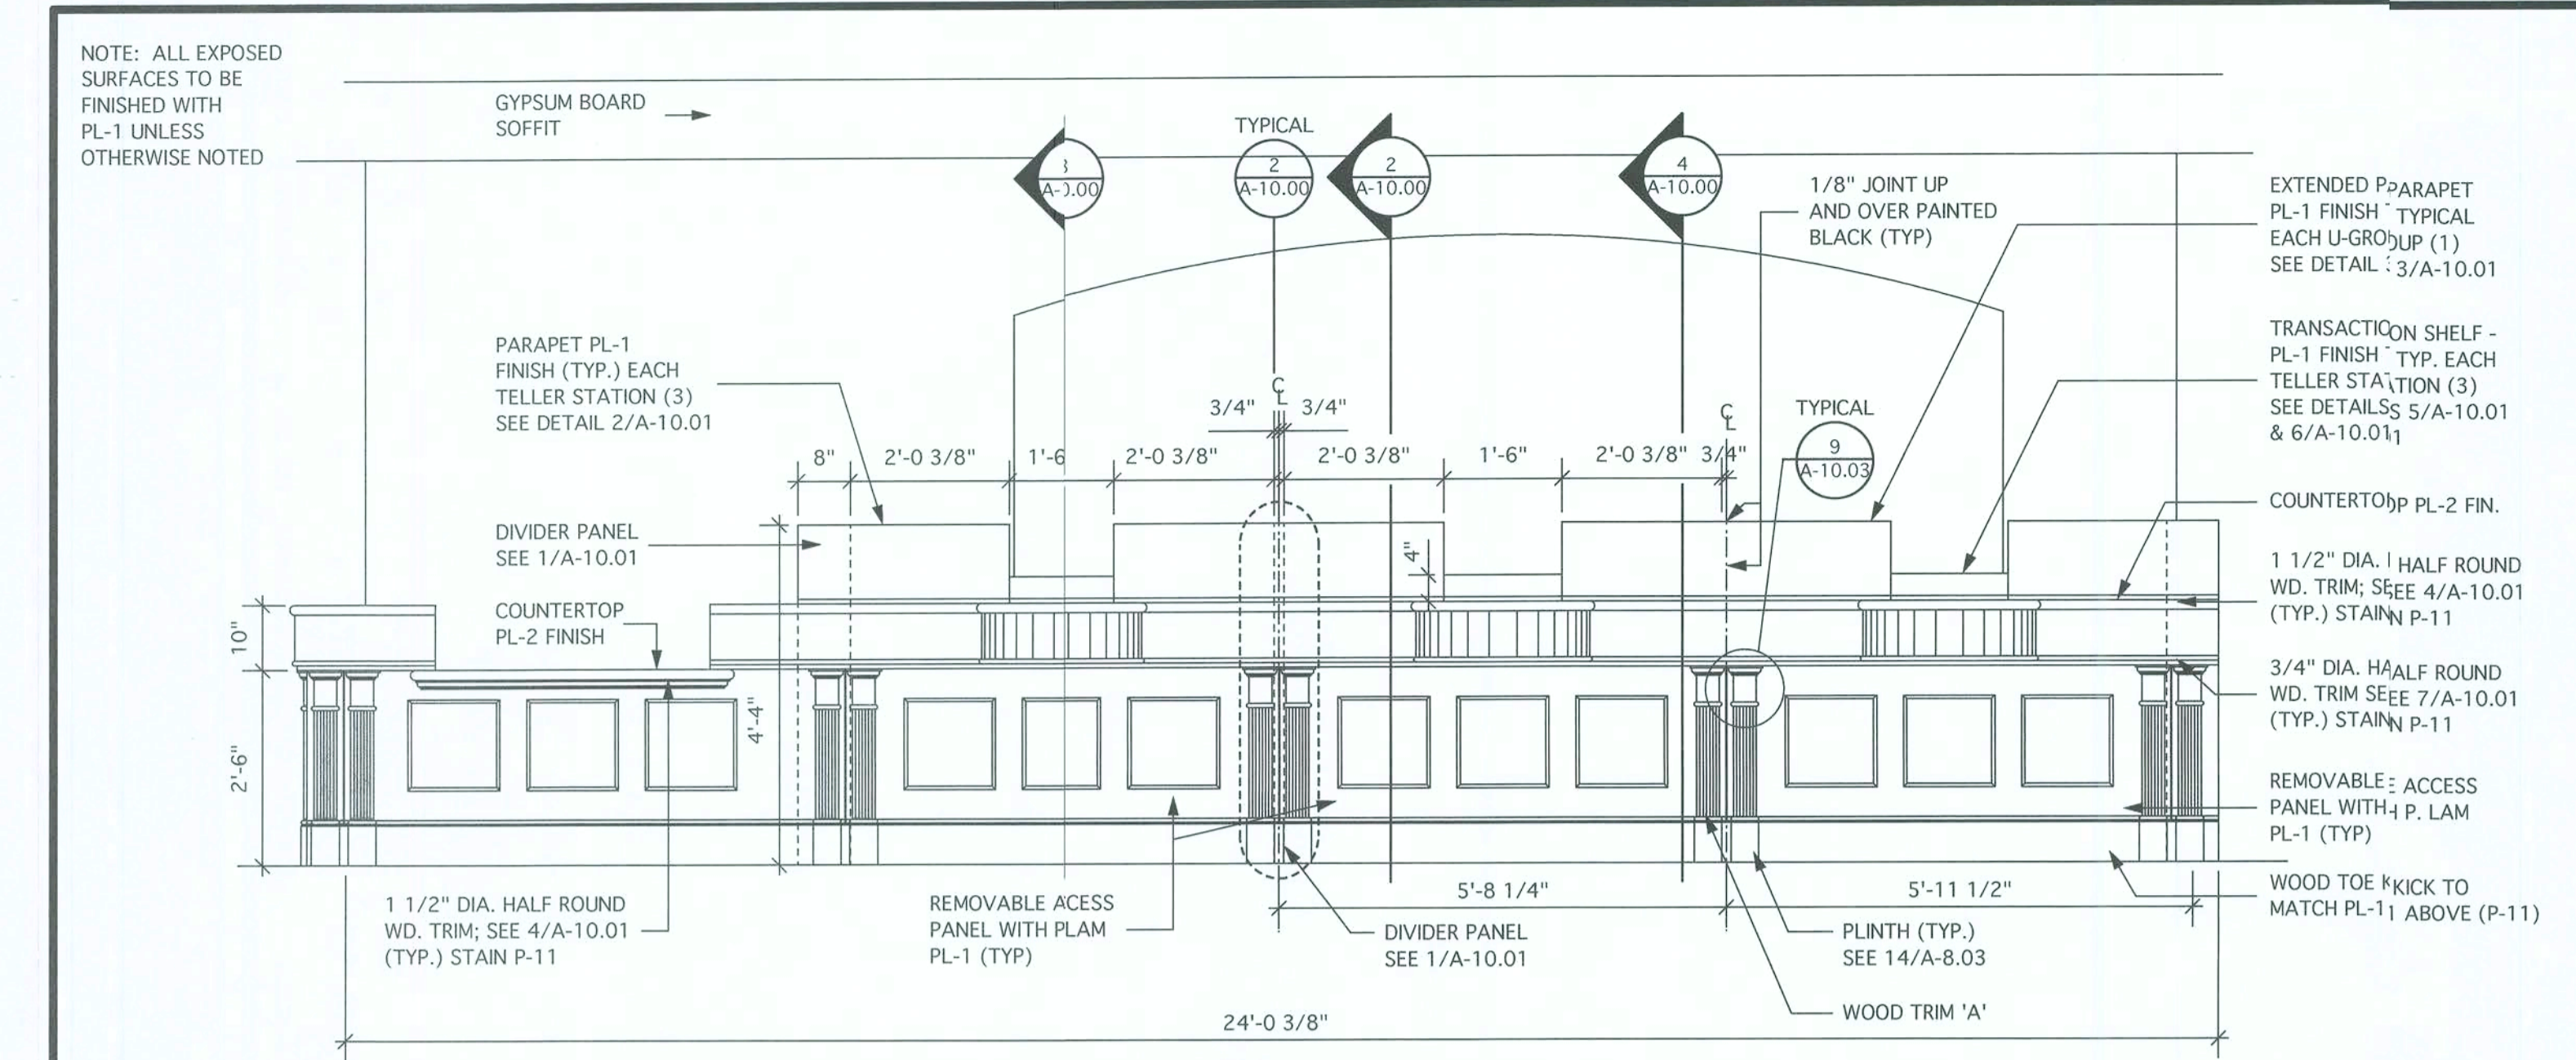
COMM. NO. 06003.00 DRAWN: KLP
DATE: 02/15/06 CHECKED: ELM
SCALE: AS NOTED
FILE: 06003.00-DETAILS 50 (FR)

DETAILS

SEAL



ARCHITECT/CONSULTANT

EDDIE L. MUSE
JUN 07 2006
LICENSE NO. AR-12112
SHEET NUMBER
A-8.50





4 TELLERLINE #112
1/2" = 1'-0"

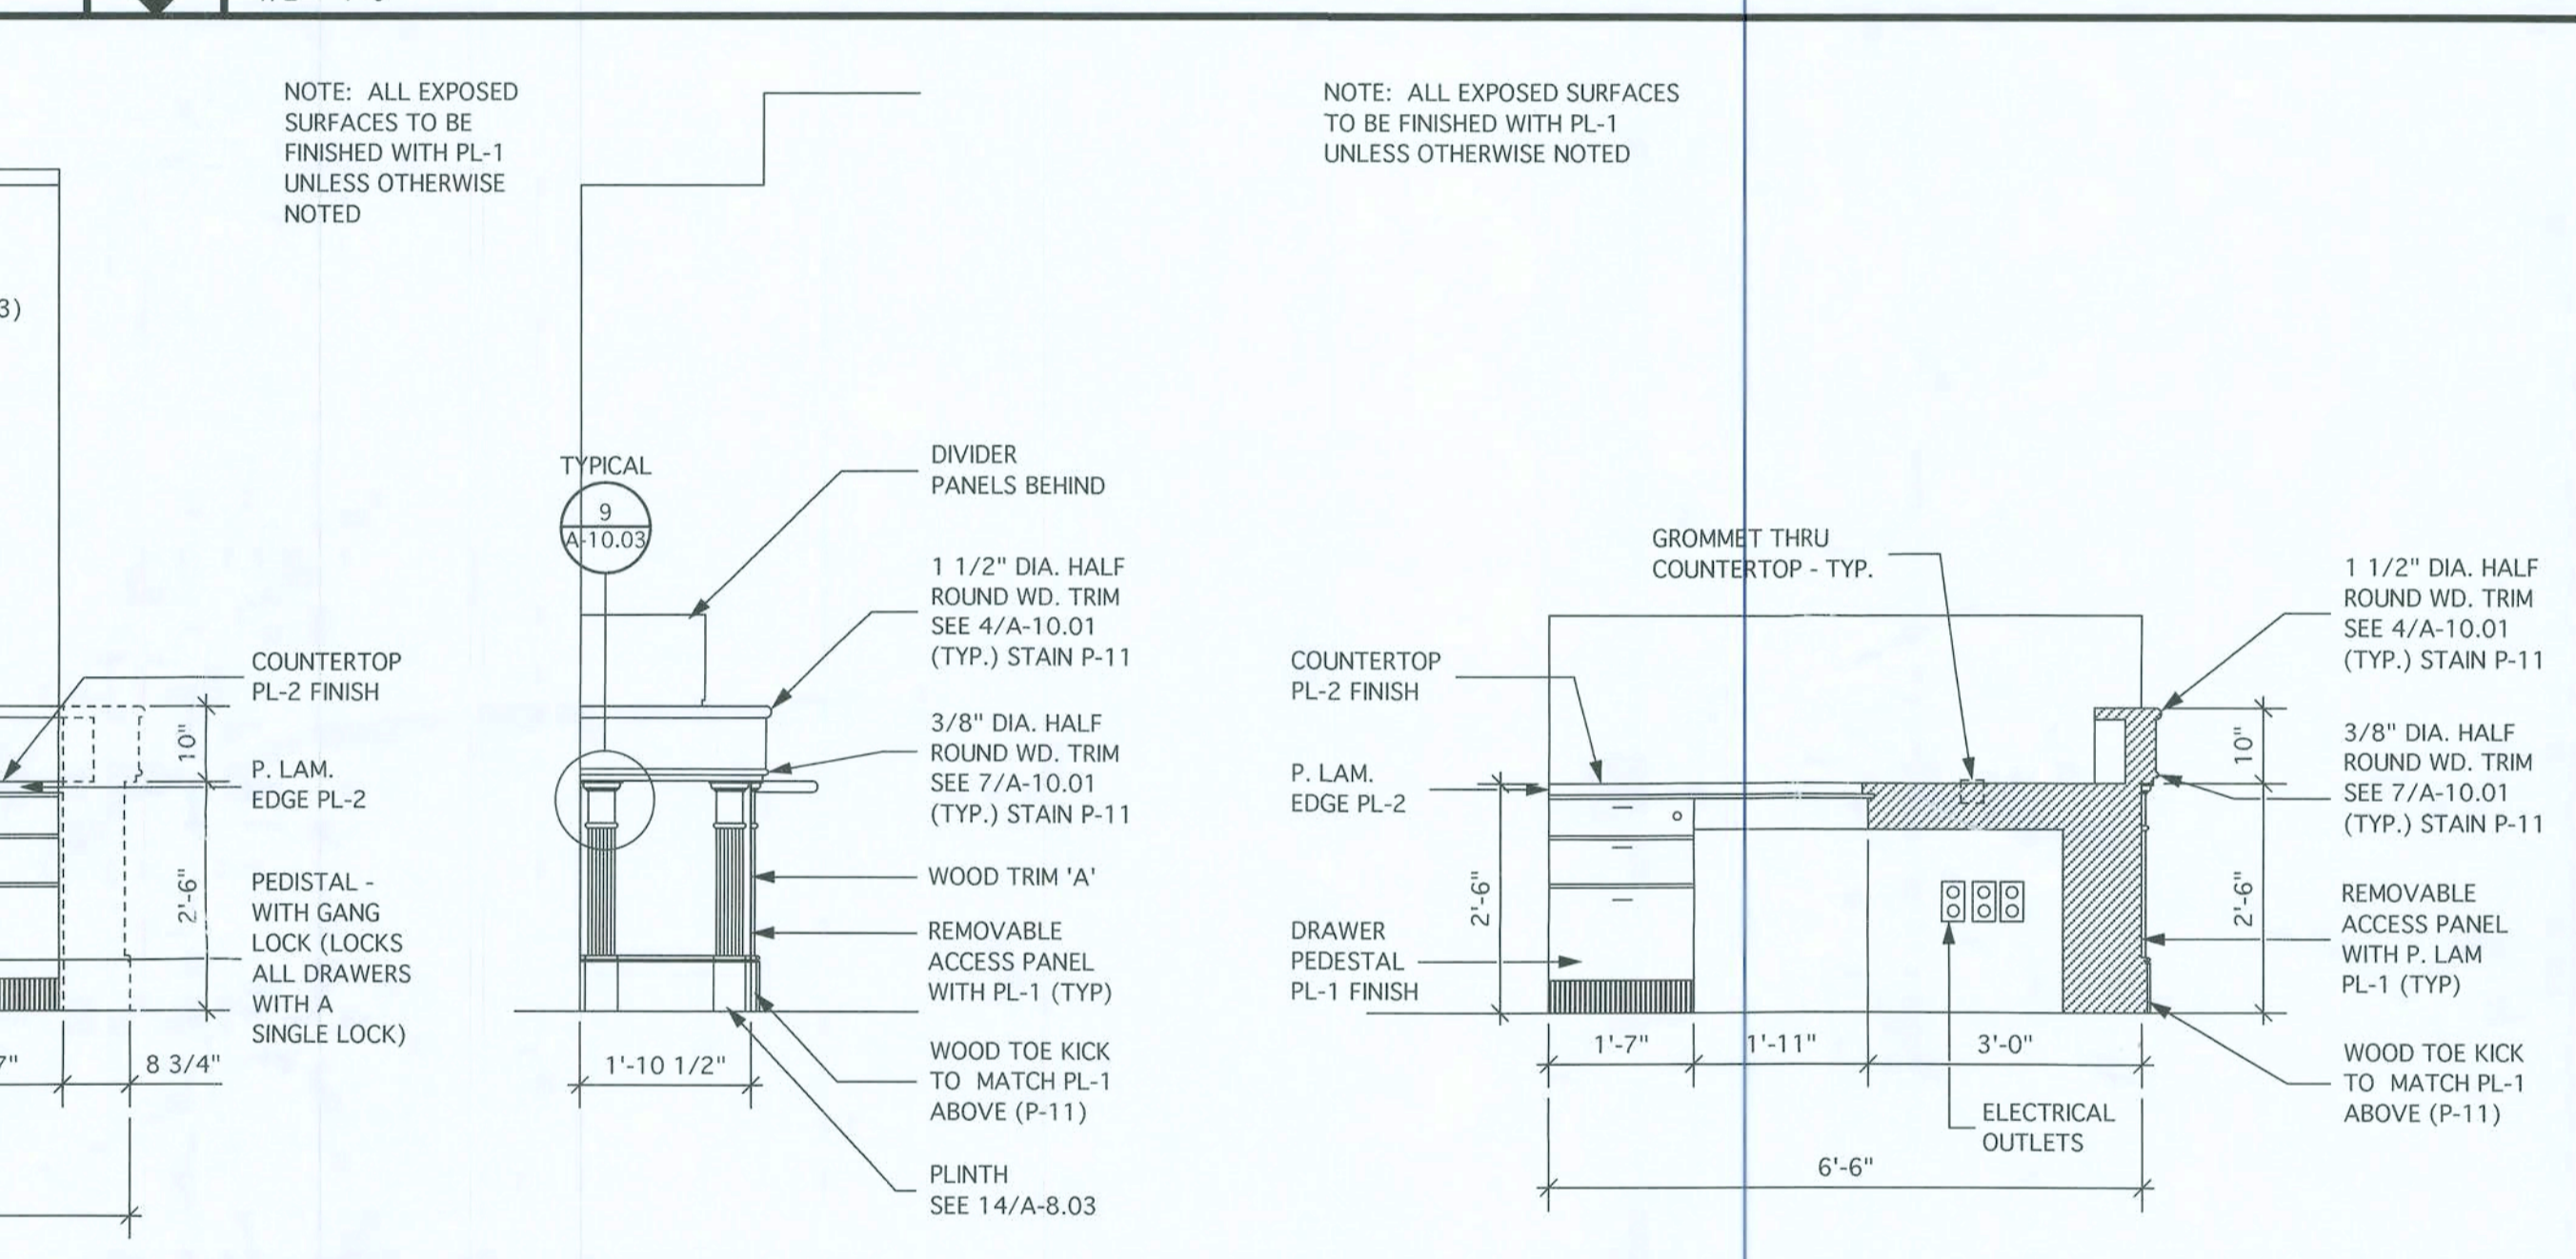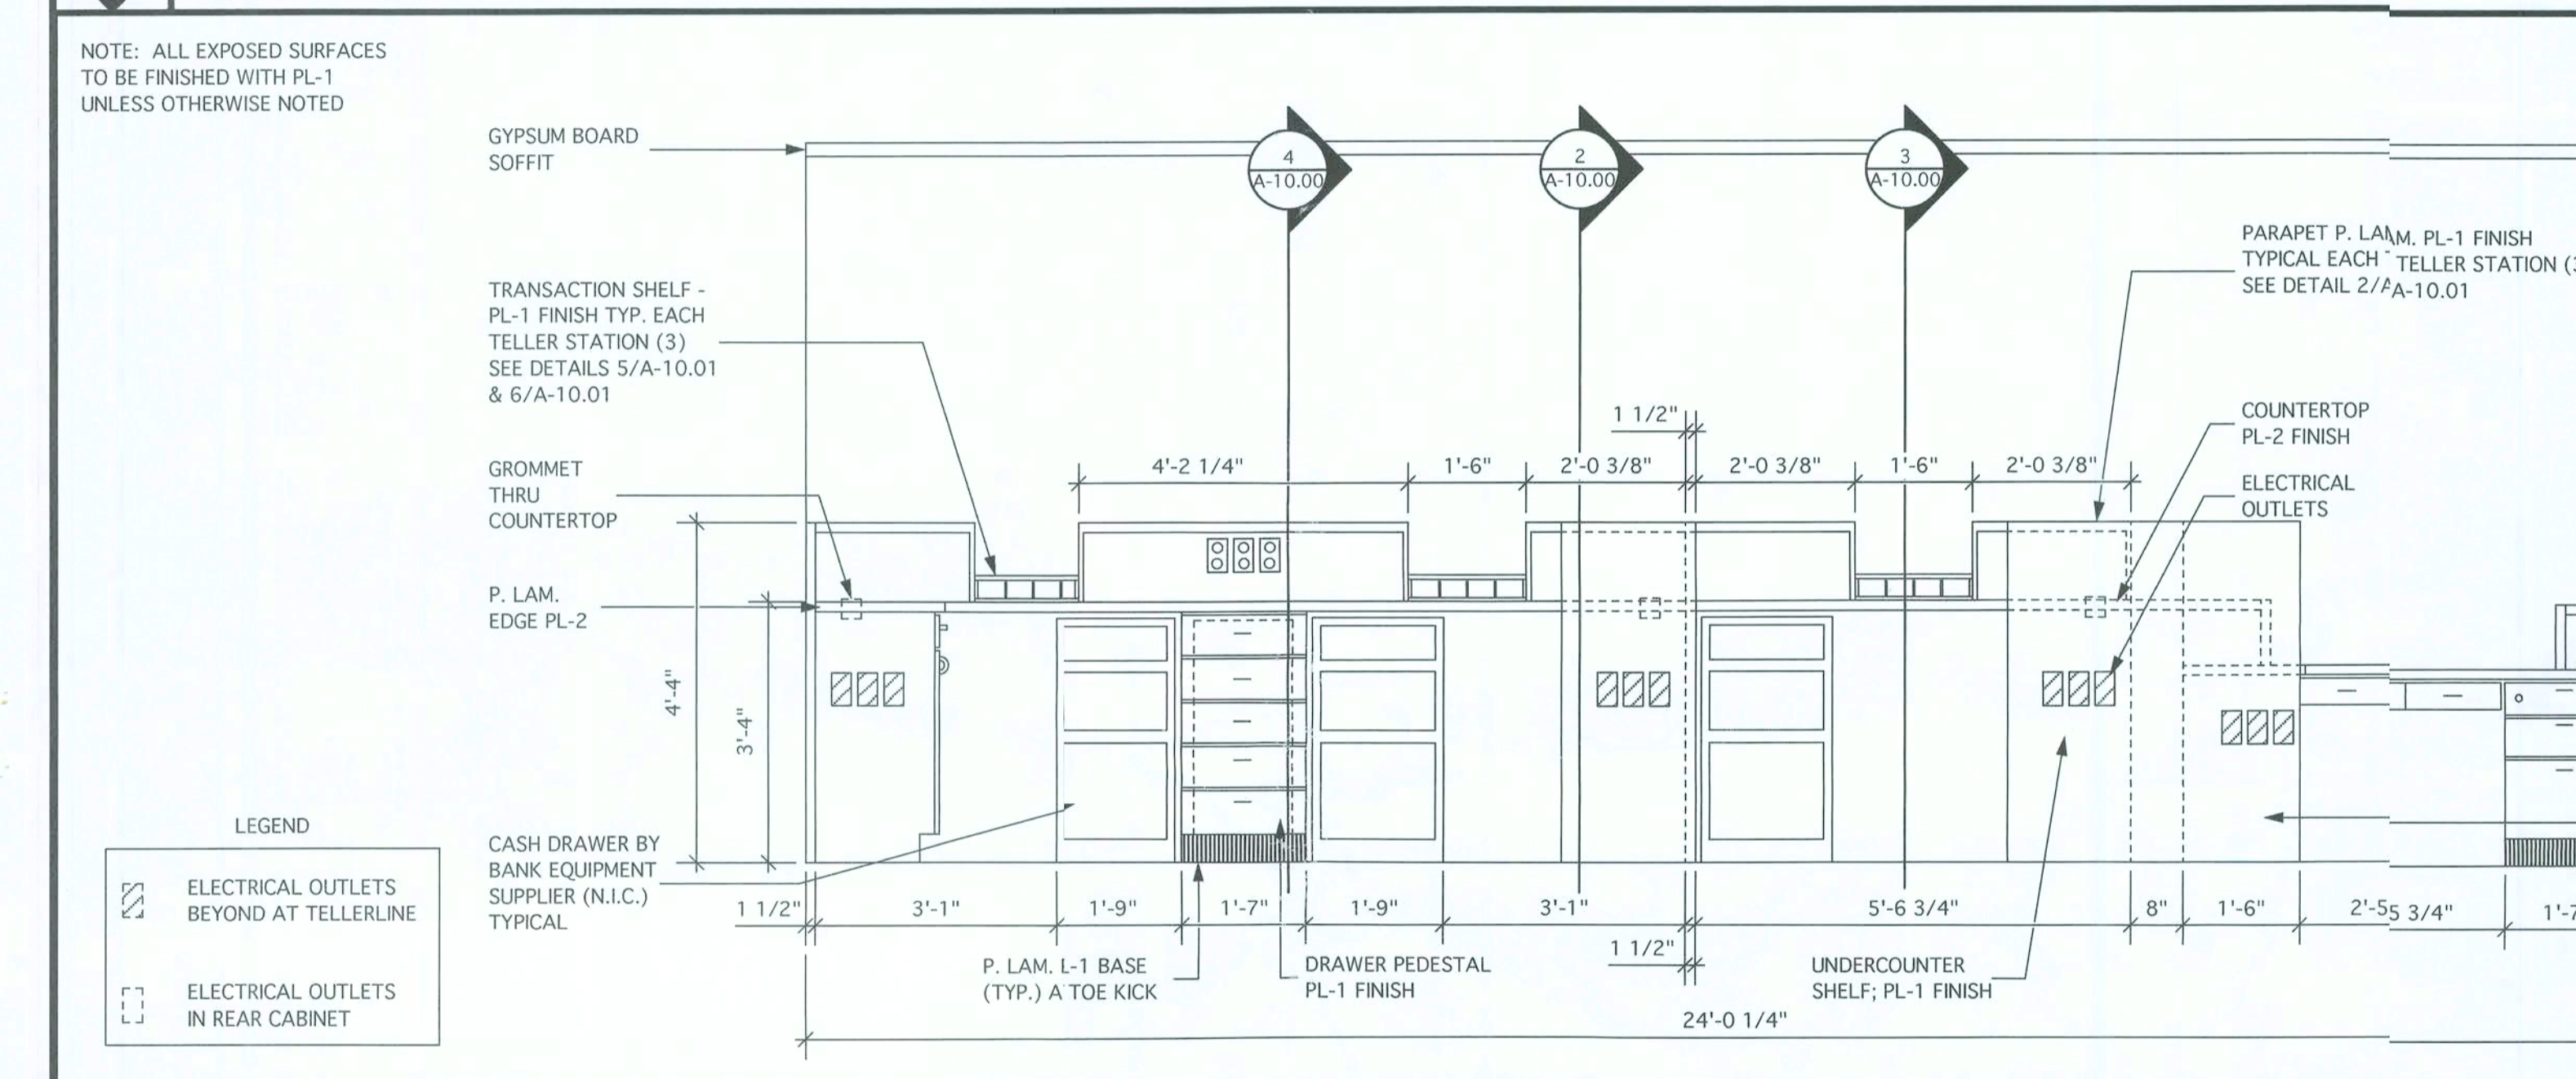3 TELLERLINE #112 AND DRIVE-IN TELLERS #113
1/2" = 1'-0"



2 TELLERLINE #112
1/2" = 1'-0"

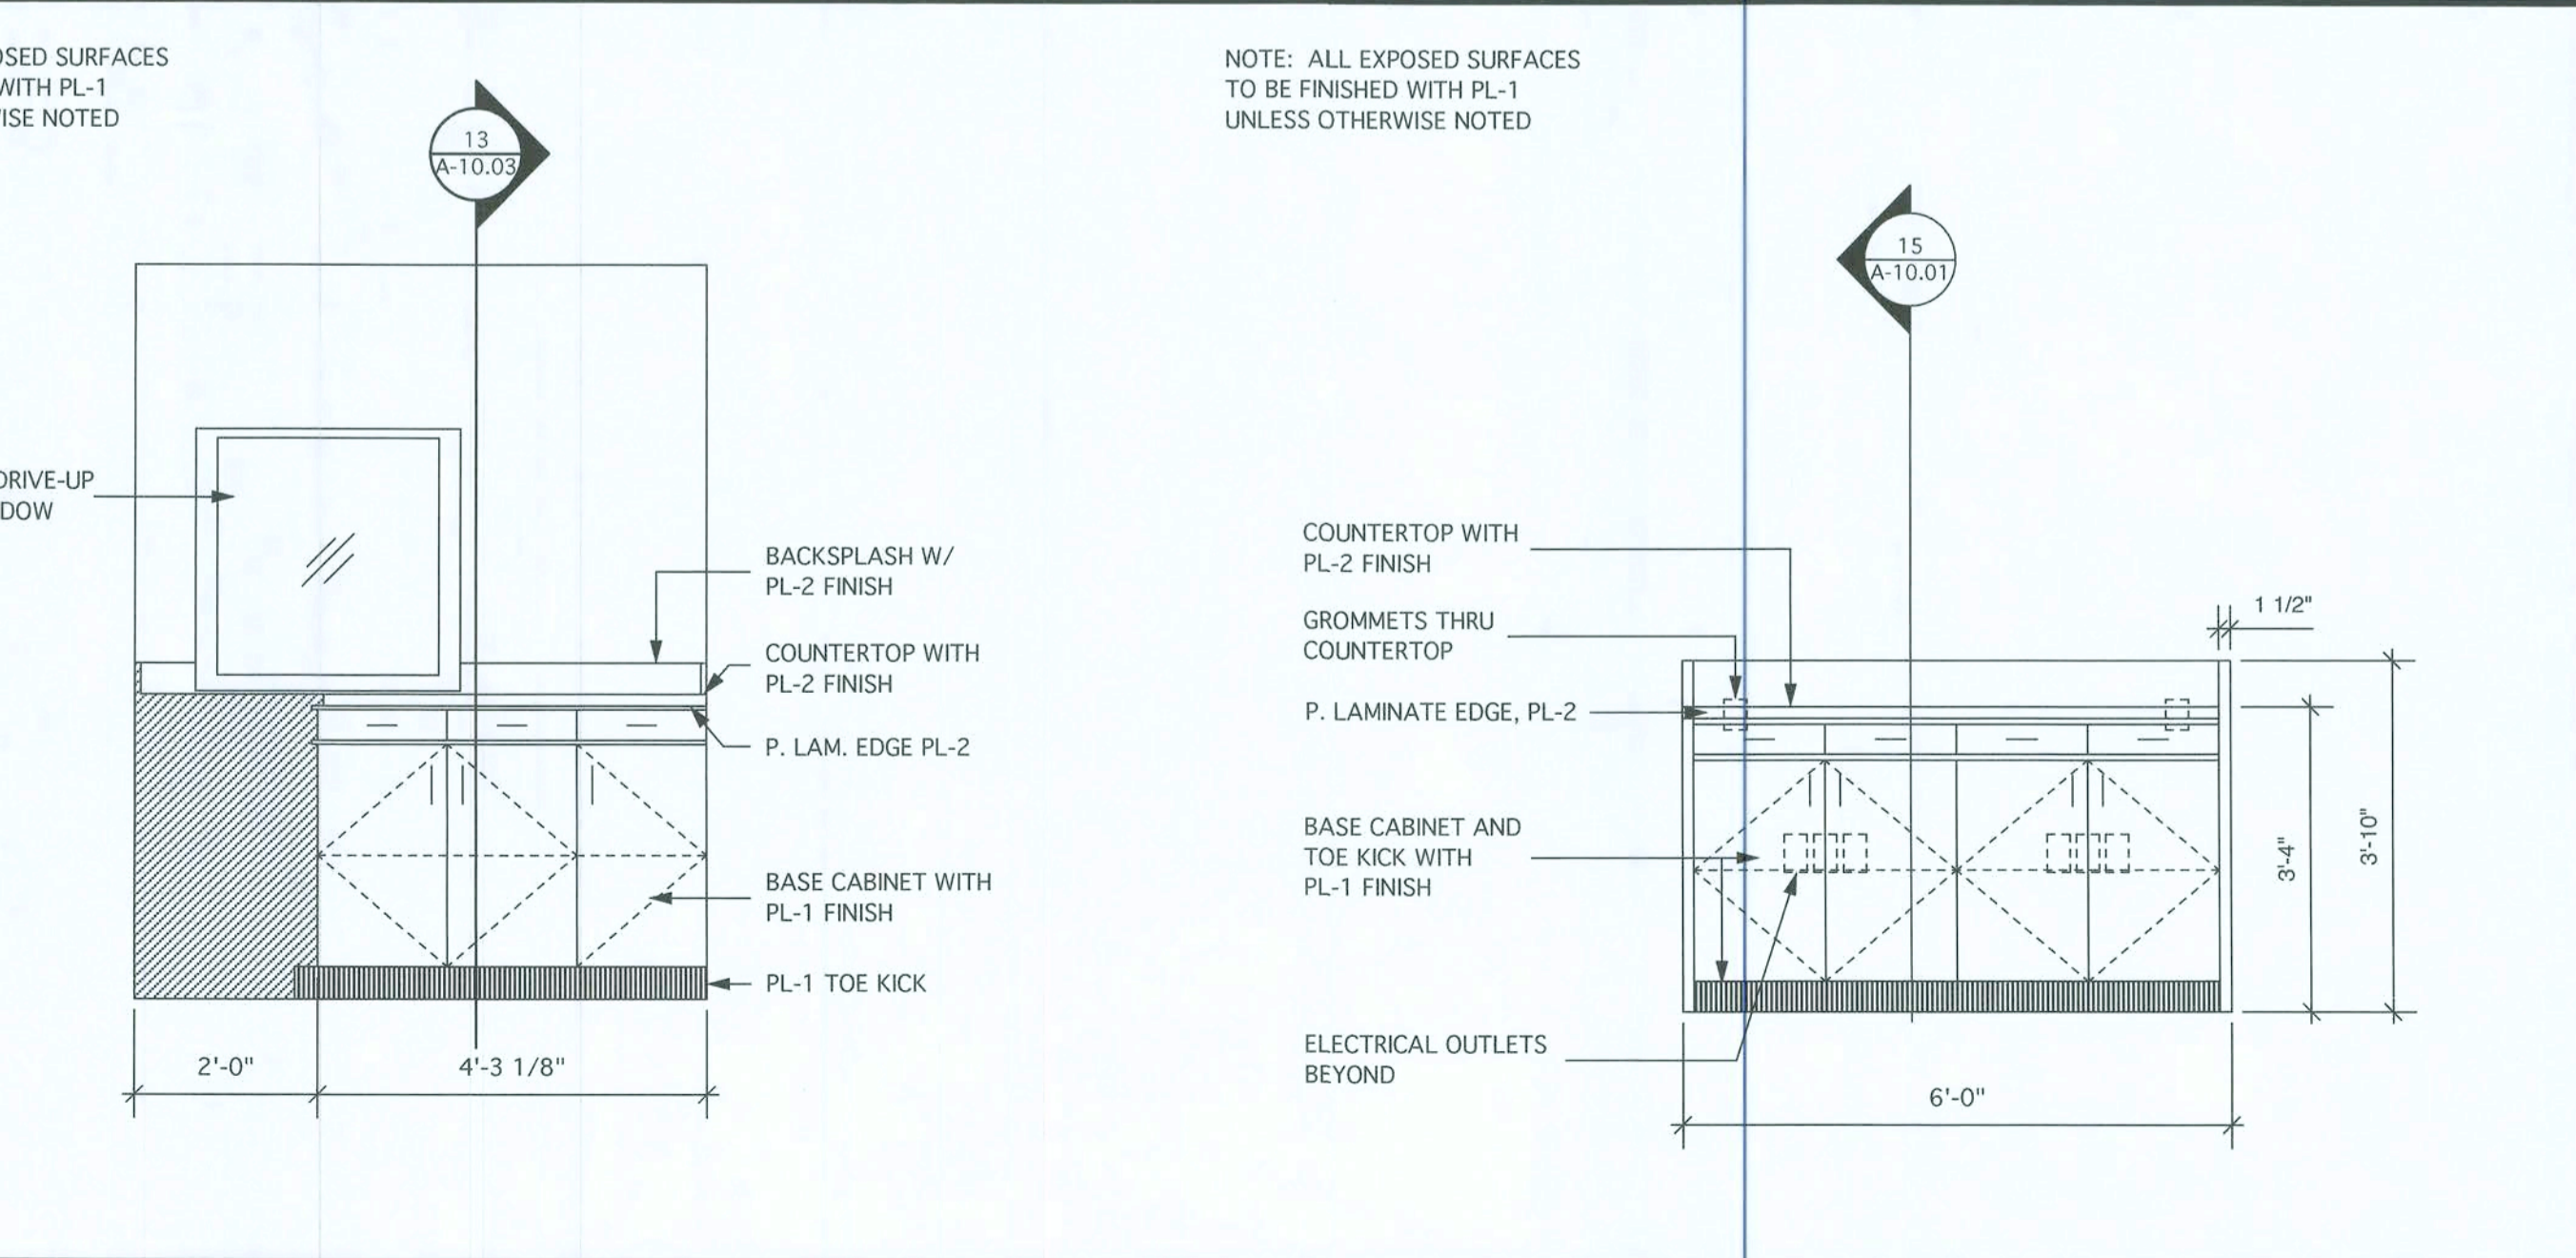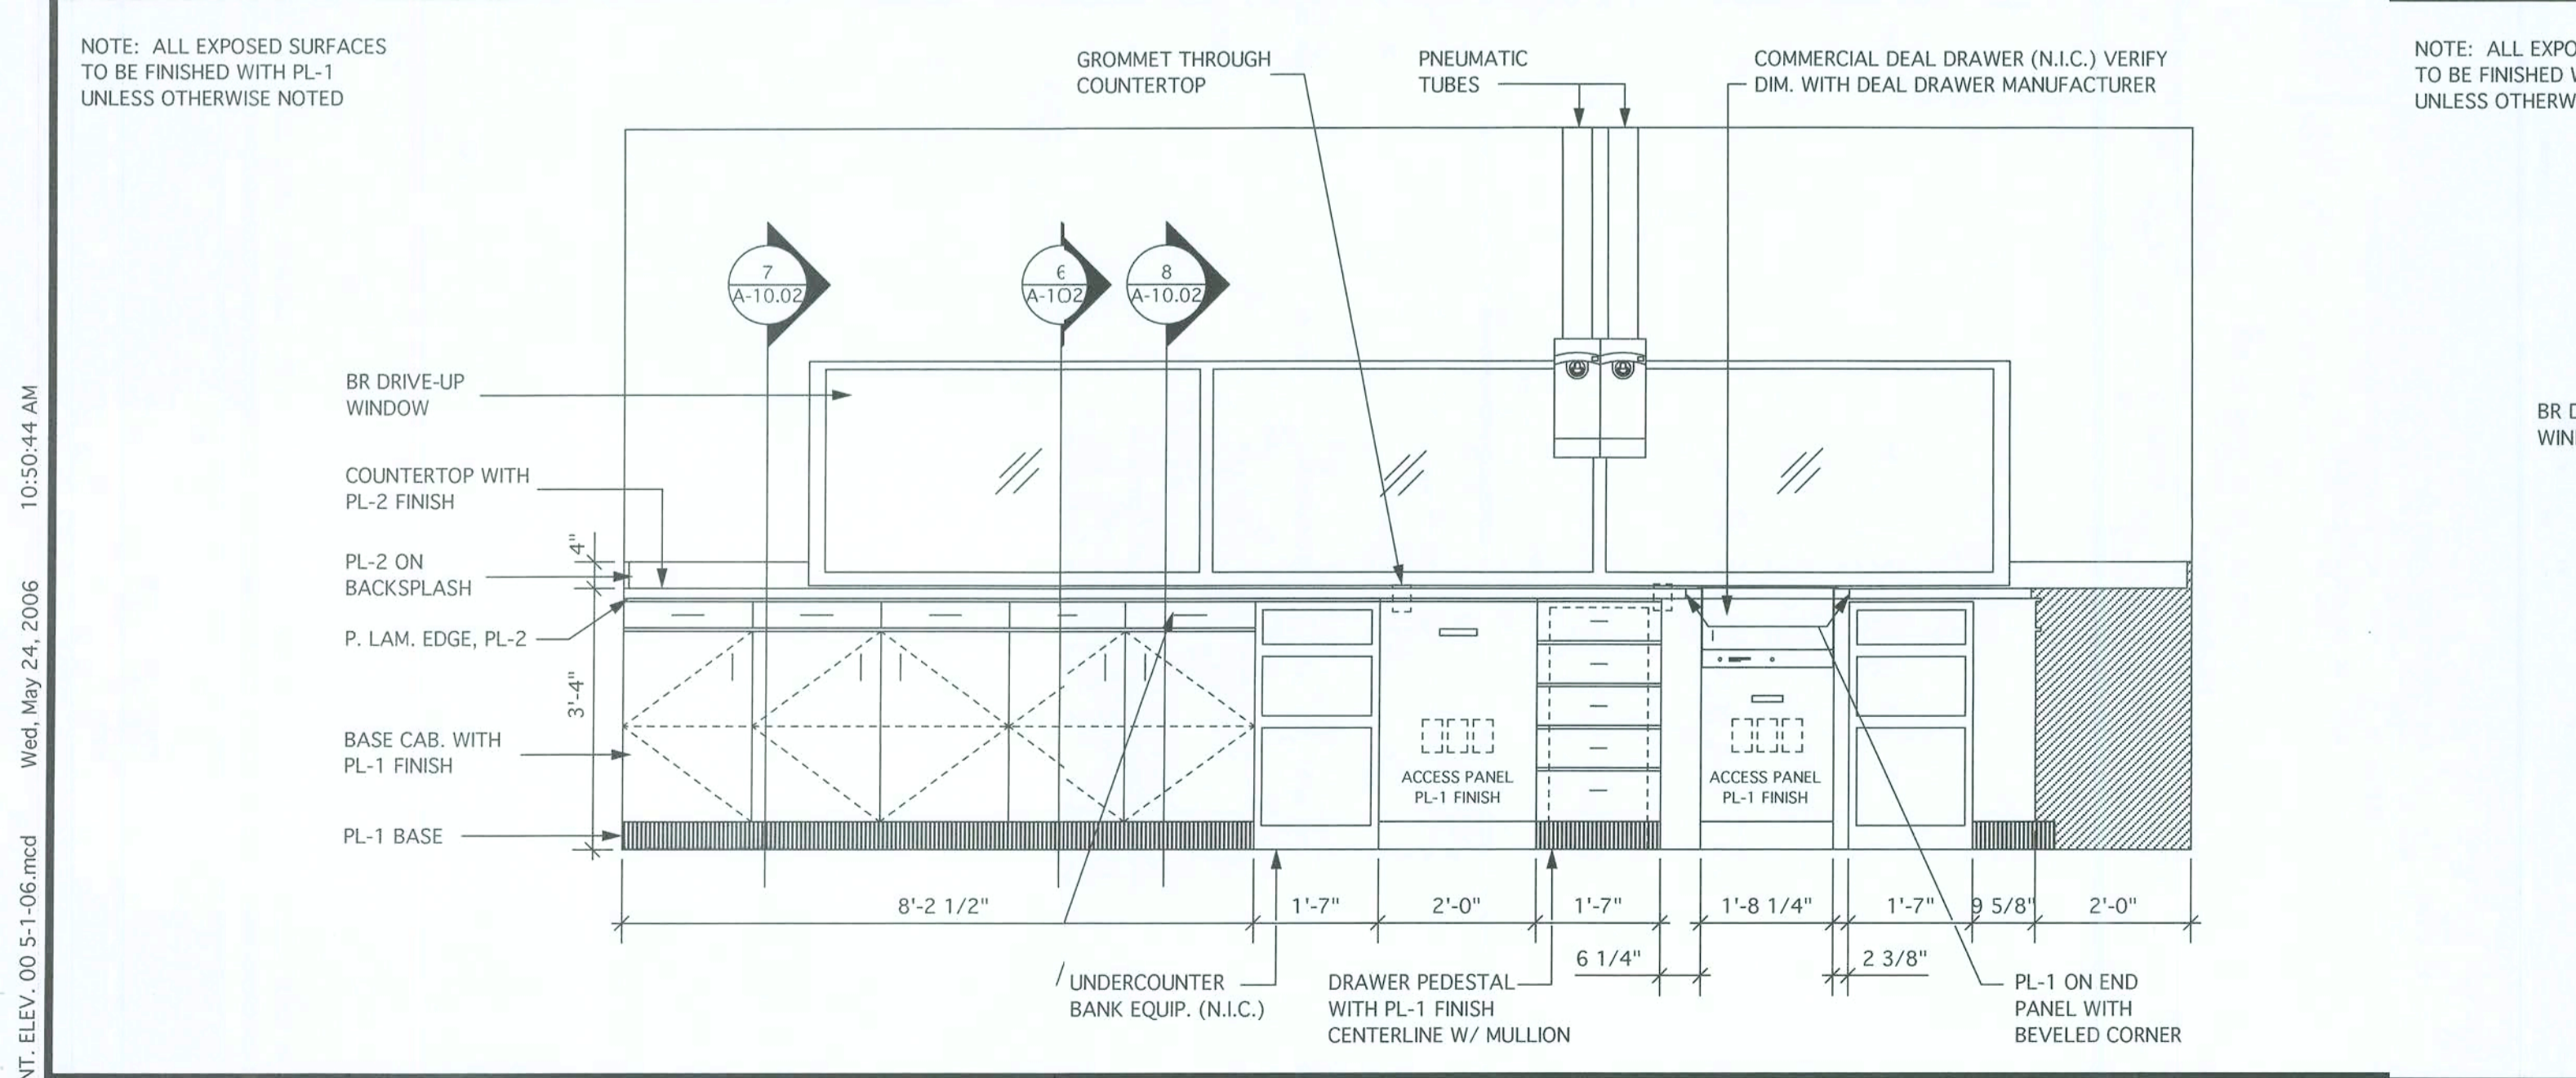1 TELLERLINE #112
1/2" = 1'-0"



4 DRIVE-IN TELLERS #113
1/2" = 1'-0"

3 DRIVE-IN TELLERS #113
1/2" = 1'-0"

DESIGN SERVICES INCORPORATED
1778 N. PARK AVE., SUITE 100, MATLAND, FL 32751
TELEPHONE (407) 629-5755
LICENSE NO. F00061

WEST OFFICE
(NEW BRANCH BANK)
LAKE CITY, FLORIDA

PEOPLES STATE BANK

ARCHITECTURE
INTERIOR DESIGN
GRAPHIC PLANNING

GENRAL NOTES

INTERIOR ELEVATION VIEW

1 ROOM NAME & NUMBER
SCALE

INTERIOR ELEVATION DRAWING TITLE

NOTES:

- CONTRACTOR SHALL VERIFY ALL MILLWORK DIMENSIONS.
- CONTRACTOR TO COORDINATE DIMENSION AND LOCATIONS WITH BANK EQUIPMENT MANUFACTURER.

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1 2 3 4

NORTH
ACTUAL PLAN


MARK	DATE	REVISIONS

COMM. NO. 06003.00	DRAWN: KLP
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FILE: 06003.00INT. ELEV. 00 5-1-06.mcd	


INTERIOR ELEVATIONS

SEAL	ARCHITECT/CONSULTANT
<i>Eddie L. MUSE</i>	EDDIE L. MUSE
	JUN 07 2006
	LICENSE NO. AR-12112
	SHEET NUMBER
	A-9.00

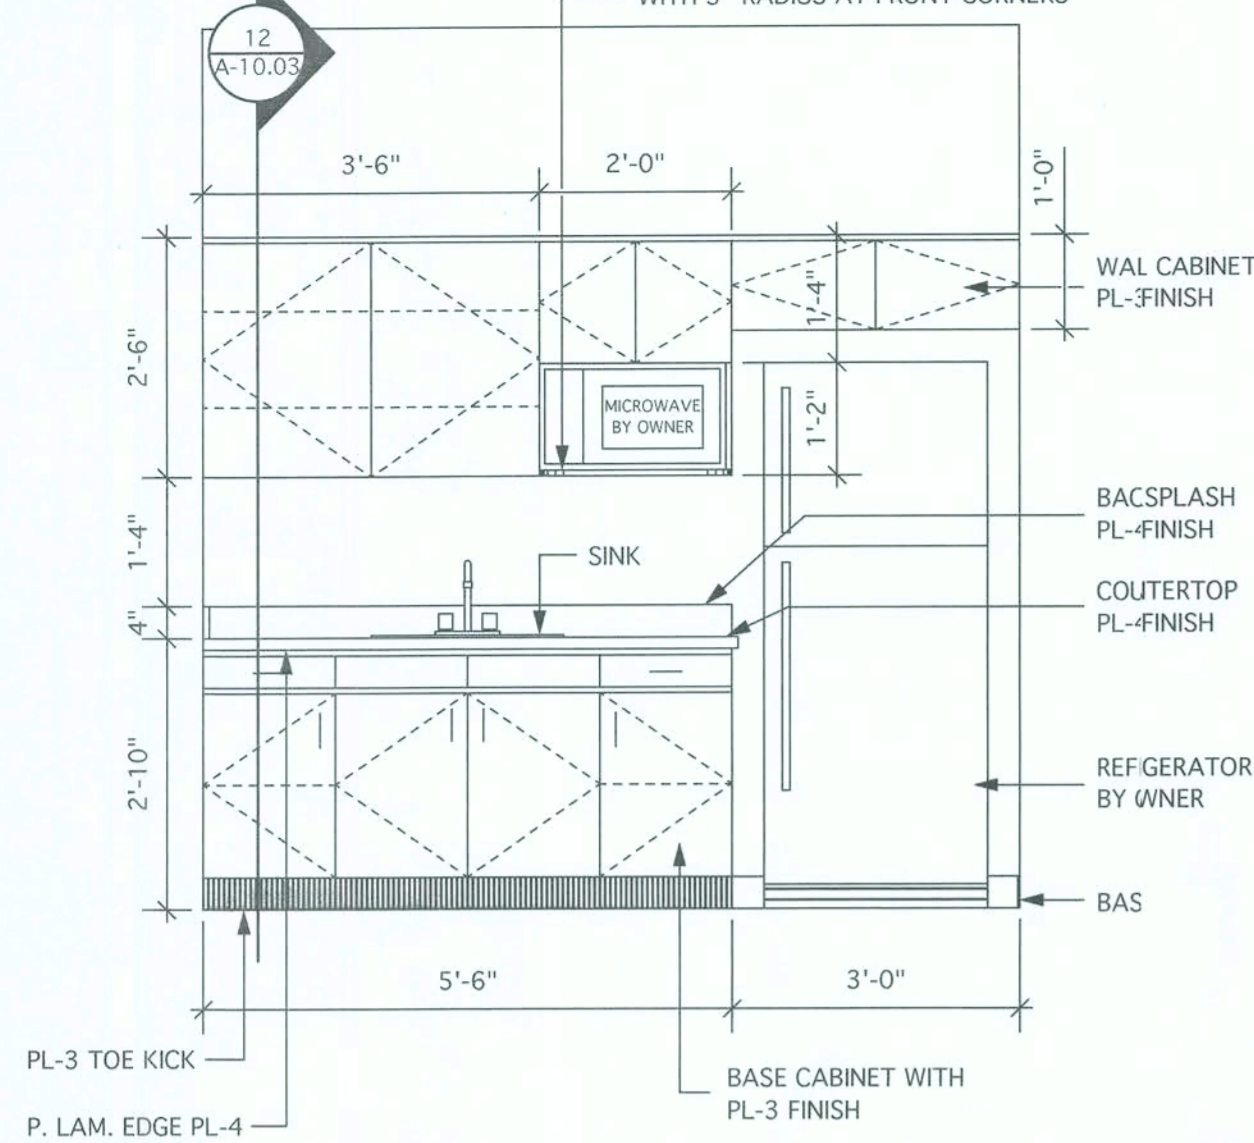
NOTE: ALL EXPOSED SURFACES TO BE FINISHED WITH PL-3 UNLESS OTHERWISE NOTED



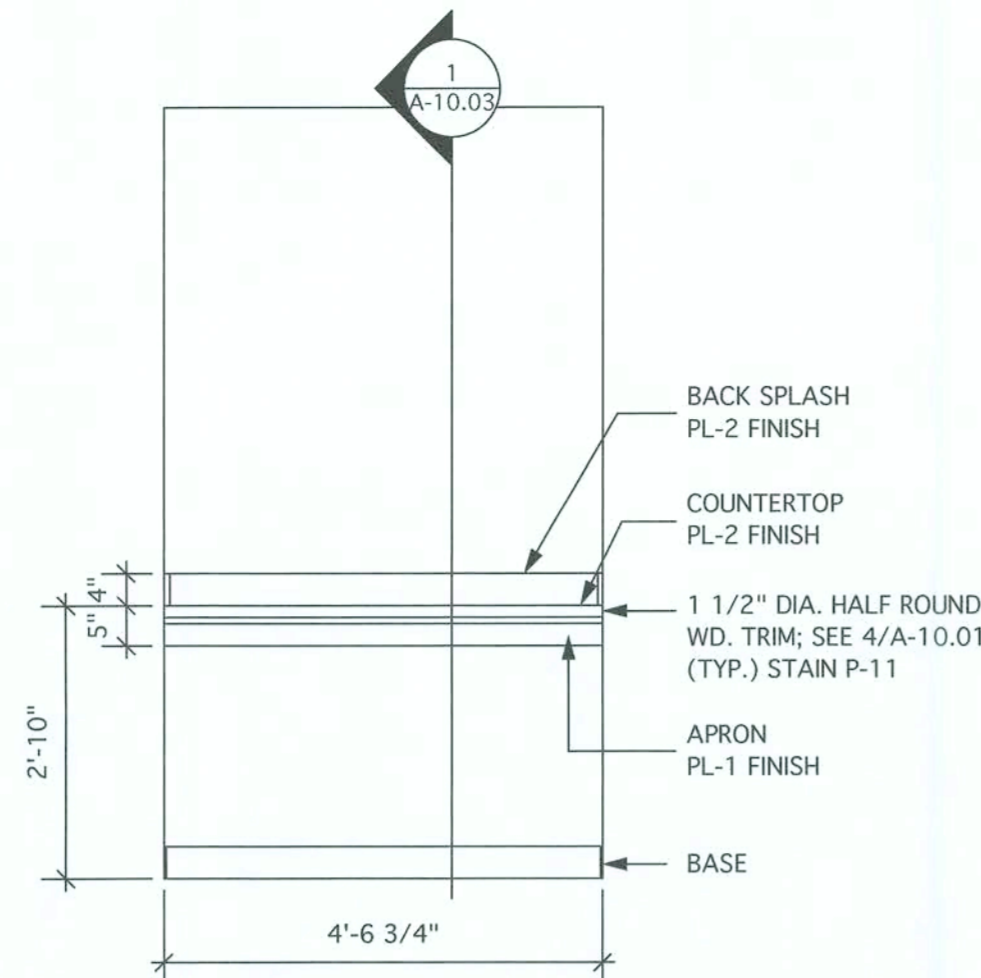
NOTE: ALL EXPOSED SURFACES TO BE FINISHED WITH PL-1 UNLESS OTHERWISE NOTED



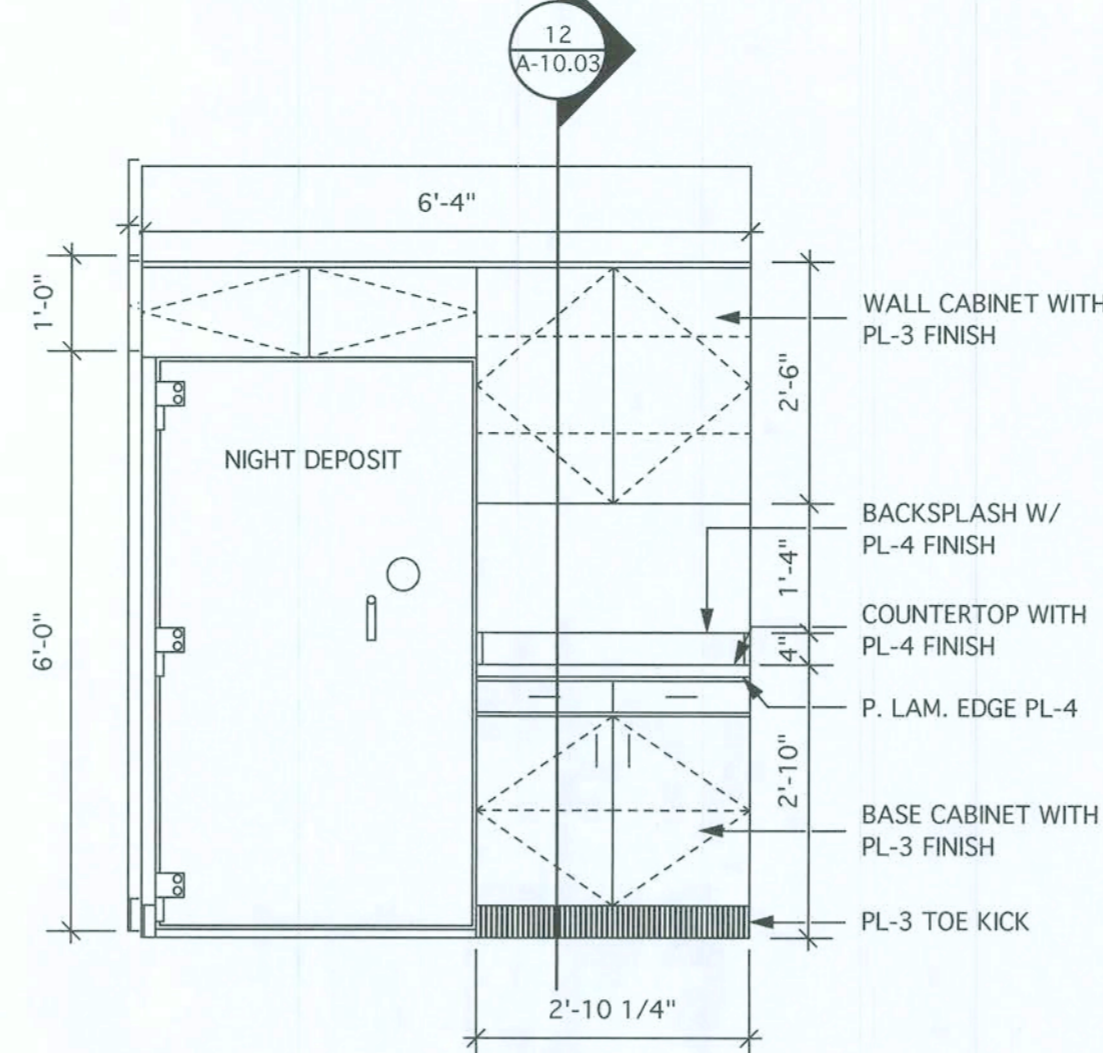NOTE: ALL EXPOSED SURFACES TO BE FINISHED WITH PL-3 UNLESS OTHERWISE NOTED



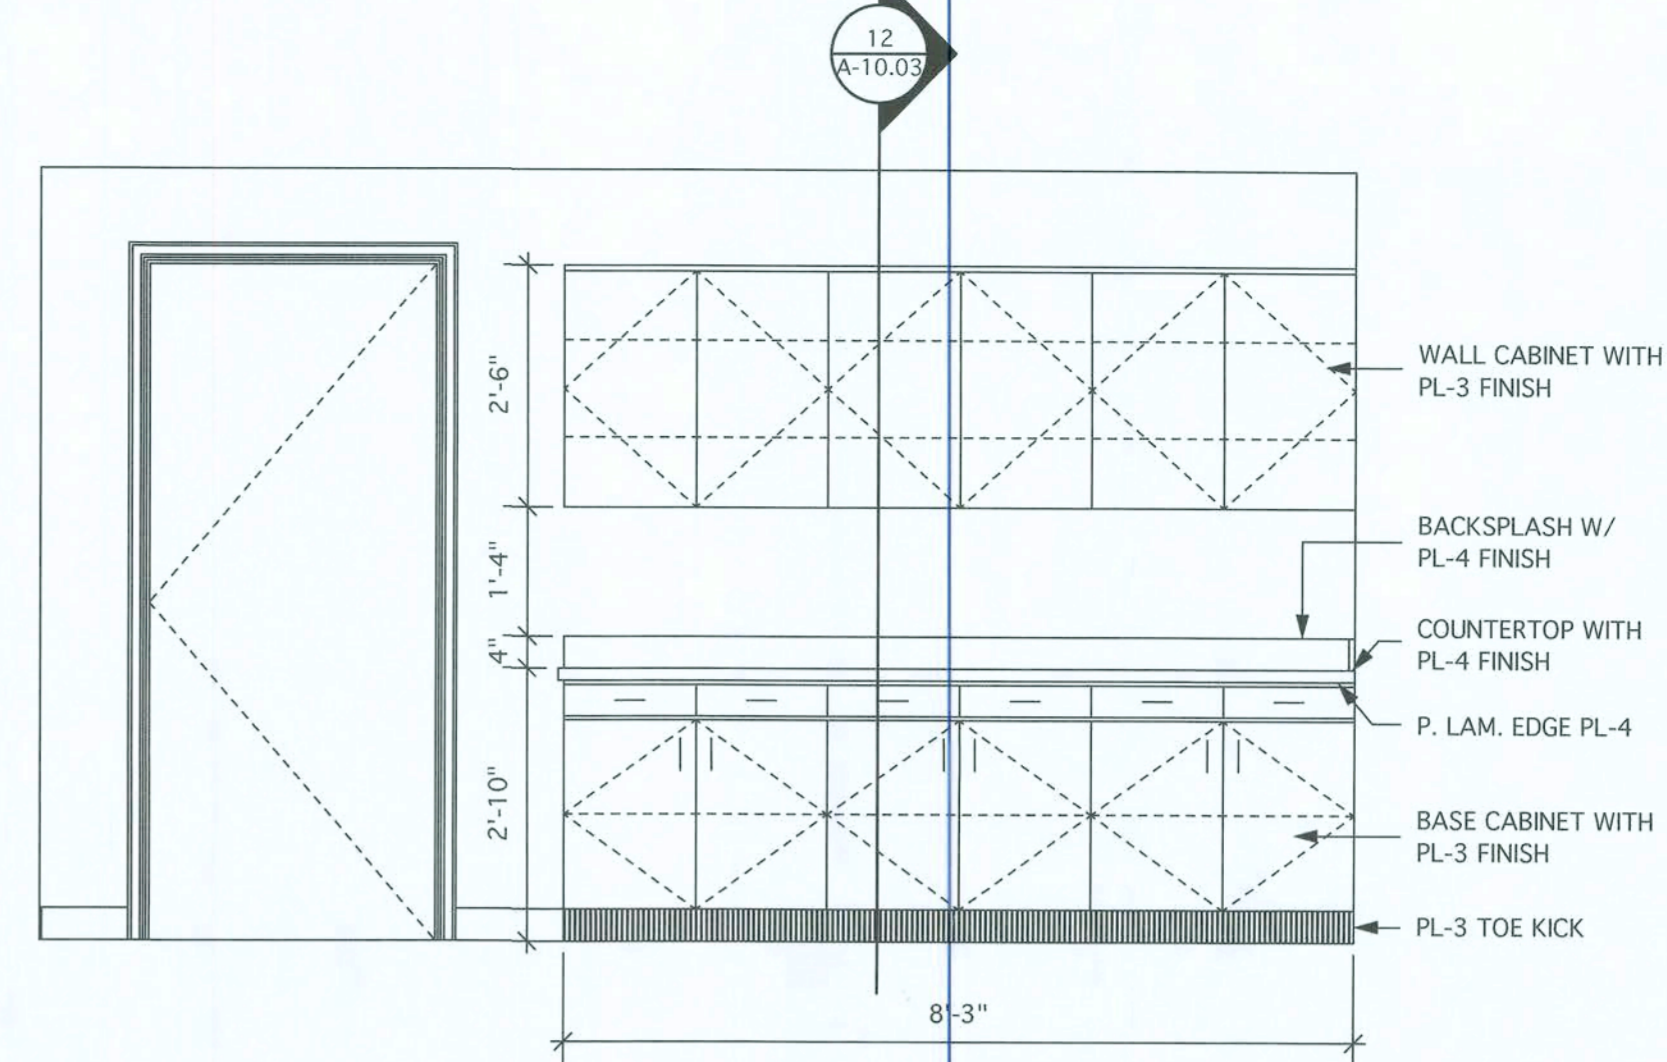NOTE: ALL EXPOSED SURFACES TO BE FINISHED WITH PL-3 UNLESS OTHERWISE NOTED



3 EMPLOYEE LOUNGE #107

1/2" = 1'-0"

3 SAFE KEEPING #109

1/2" = 1'-0"

4 NIGHTDROP #114

1/2" = 1'-0"

2 WORK ROOM #117

1/2" = 1'-0"

DESIGN SERVICES INCORPORATED
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TELEPHONE (407) 629-5755

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WEST OFFICE
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LAKE CITY, FLORIDA

PEOPLES
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GENERAL NOTES


INTERIOR ELEVATION VIEW

1	ROOM NAME & NUMBER
	SCALE

INTERIOR ELEVATION DRAWING TITLE

- NOTES:
- CONTRACTOR SHALL VERIFY ALL MILLWORK DIMENSIONS.
 - CONTRACTOR TO COORDINATE DIMENSION AND LOCATIONS WITH BANK EQUIPMENT MANUFACTURER.

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INTERIOR
ELEVATION
KEY

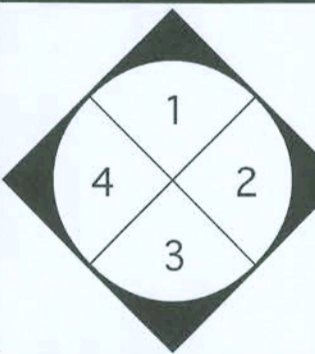NORTH

ACTUAL
PLAN

2 MEN #104

1/2" = 1'-0"

3 MEN #104

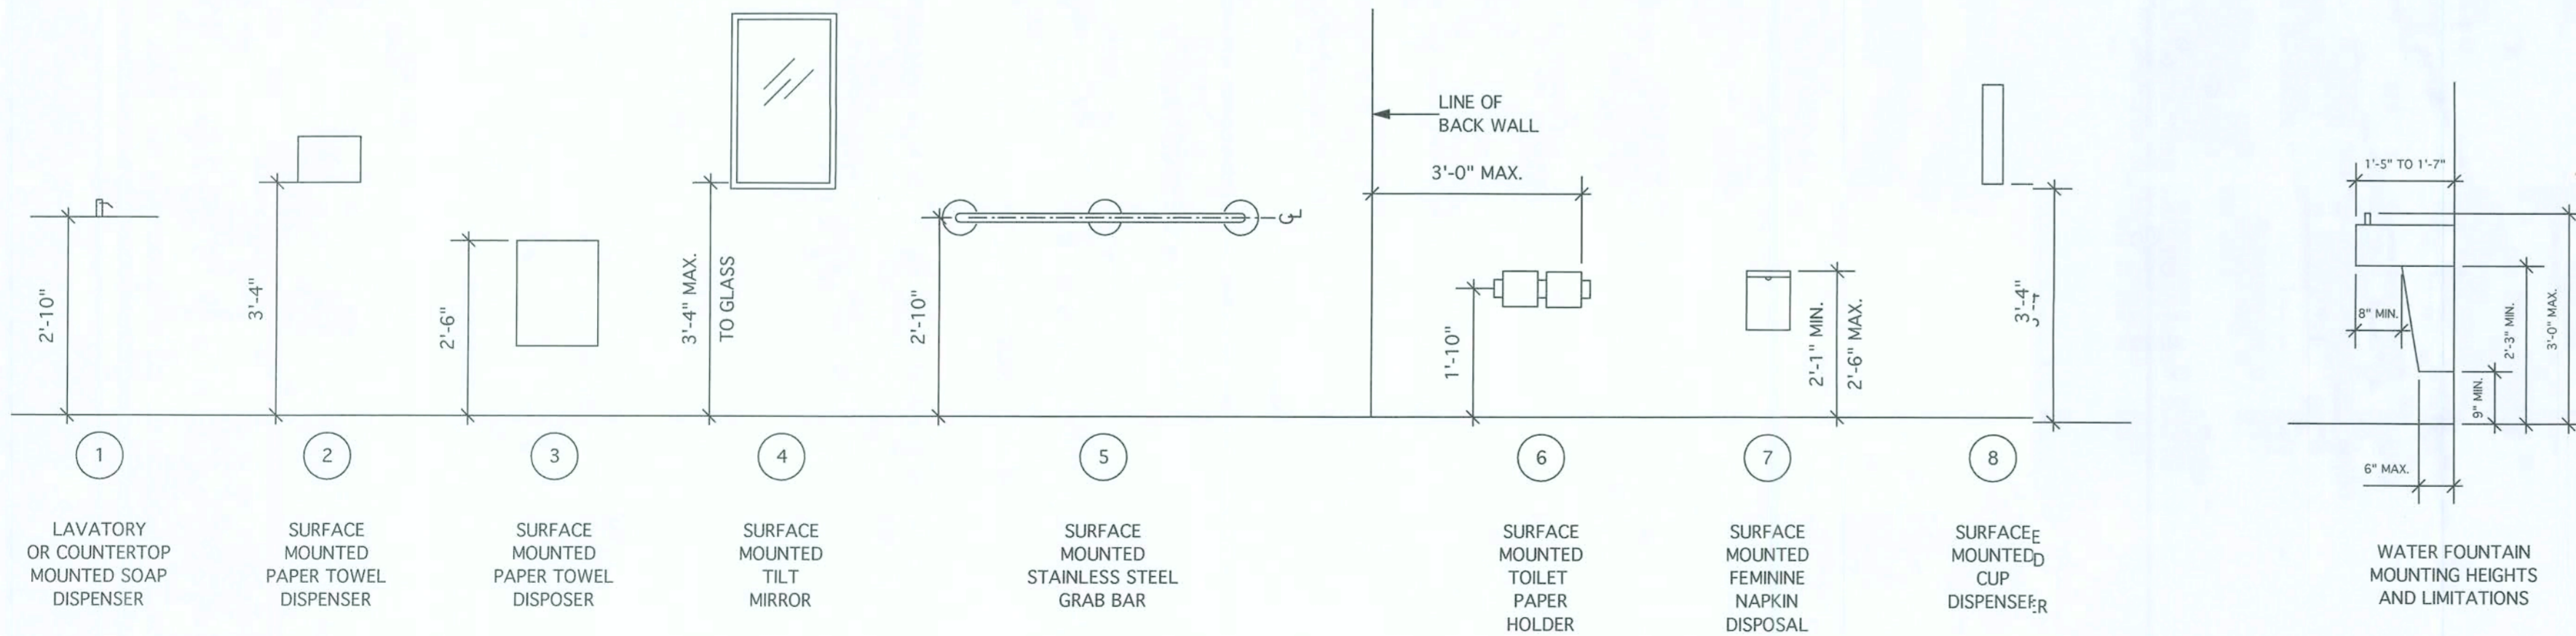
1/2" = 1'-0"

2 WOMEN #105

1/2" = 1'-0"

1 WOMEN #105

1/2" = 1'-0"



PRODUCT DATA				PRODUCT CHARACTERISTICS				INSTALLATION INFORMATION				NOTES
CODE	MANUFACTURER	PRODUCT/MODEL	MFR. NO.	SIZE/WEIGHT	TYPE	FINISH	MFR.	TYPE	METHOD			
1	BOBRICK	SOAP DISPENSER	B-822165	5 7/8" SPOUT	----	POLISHED	----	----	LAV/CTR MOUNTED			1
2	BOBRICK	PAPER TOWEL DISPENSER	B-2621	10 3/4" WIDE 8" HIGH	----	SATIN	----	----	SURFACE MOUNTED			
3	BOBRICK	PAPER TOWEL DISPOSAL	B-279	13" X 18"	----	SATIN	----	----	SURFACE MOUNTED			
4	BOBRICK	TILT MIRROR	B-293-1830	18" W X 30" H	----	SATIN	----	----	SURFACE MOUNTED			
5	BOBRICK	GRAB BAR	B-68137.99	36" X 54"	L-SHAPED	SATIN	----	----	SURFACE MOUNTED			
6	BOBRICK	TOILET PAPER DISP.	B-6867	----	DUEL ROLL	SATIN	----	----	SURFACE MOUNTED			
7	BOBRICK	FEMININE NAPKIN DISPOSAL	B-270	7 1/2" WIDE 10" HIGH	----	SATIN	----	----	SURFACE MOUNTED			
8	BOBRICK	CUP DISPENSER	B-235	----	----	SATIN	----	----	SURFACE MOUNTED			

- NOTES:
- WITH PEENED GRIP

ACCESSORY SCHEDULE

ACCESSORY MOUNTING HEIGHTS


1/2" = 1'-0"

COMM. NO.	06003.00	DRAWN:	KLP
DATE:	02/15/06	CHECKED:	ELM
SCALE:	1/2" = 1'-0"		
FILE:	06003.00-INT. ELEV. 01		

INTERIOR ELEVATIONS


SEAL	ARCHITECT/CONSULTANT
	EDDIE L. MUSE
	JUN 07 2006
	LICENSE NO. AR-12112
	SHEET NUMBER

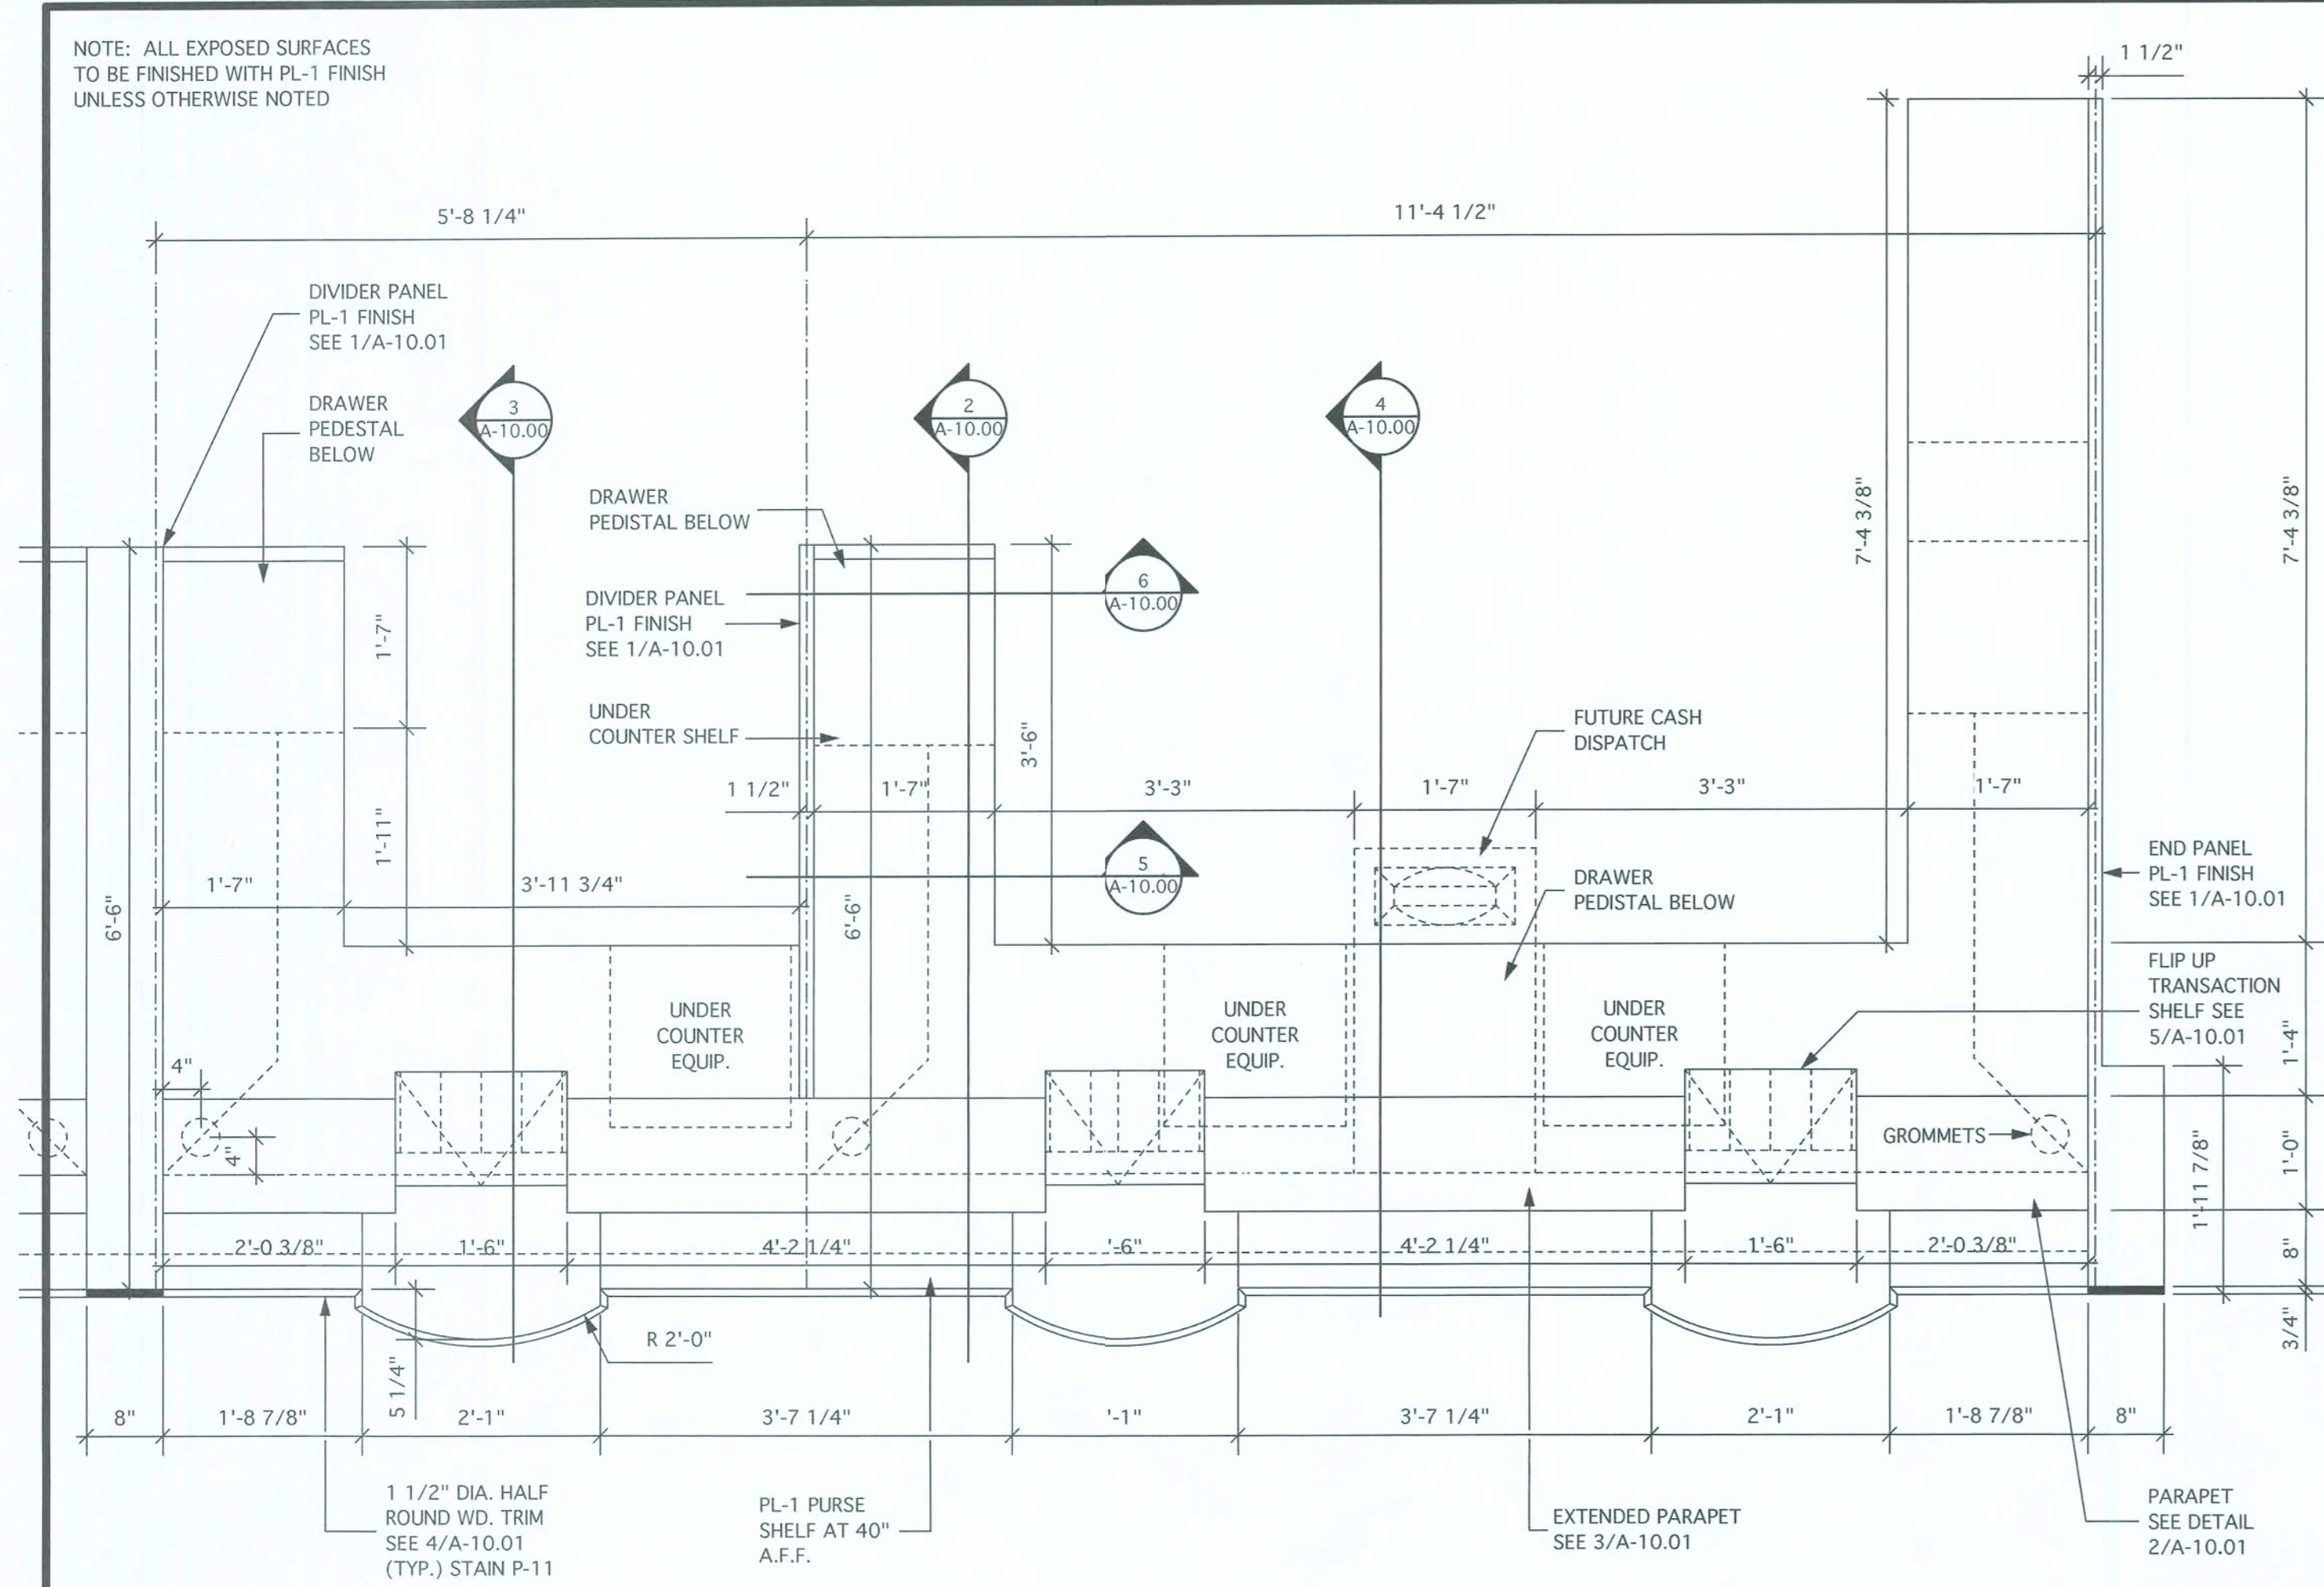A-9.01



1 DETAIL - TELLERLINE PLAN

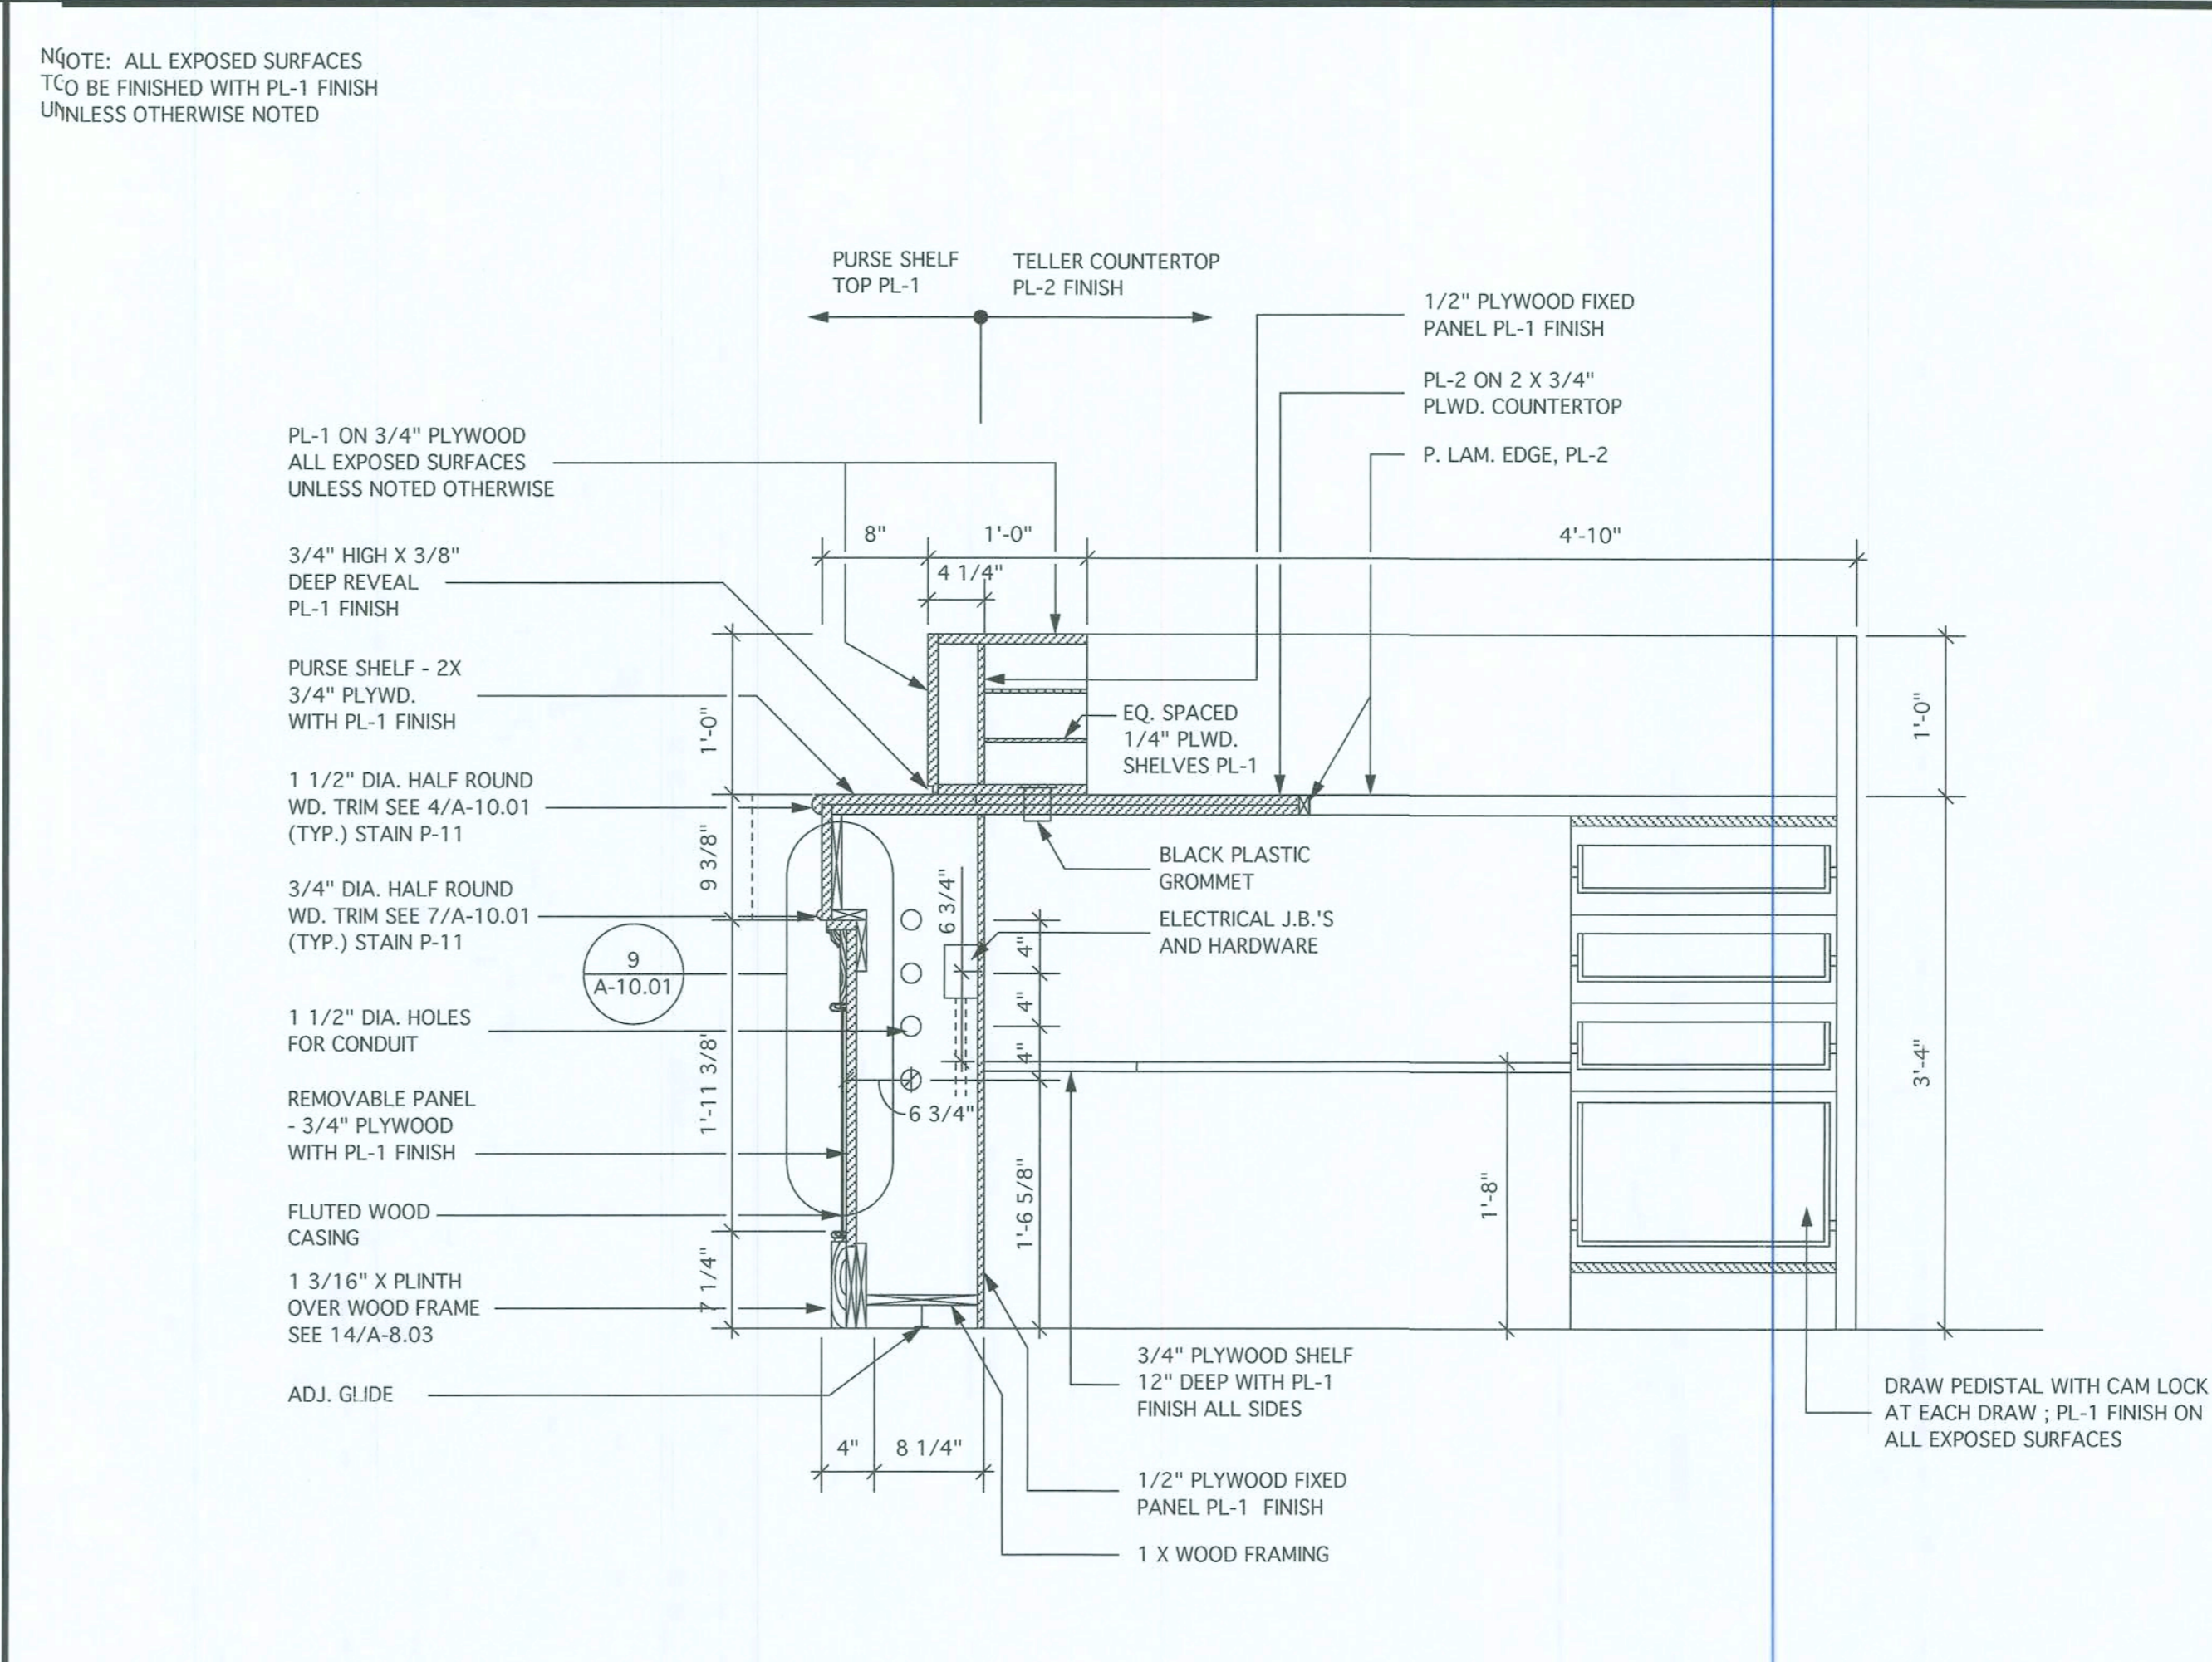
3/4" = 1'-0"



2 DETAIL - TELLERLINE SECTION

1" = 1'-0"

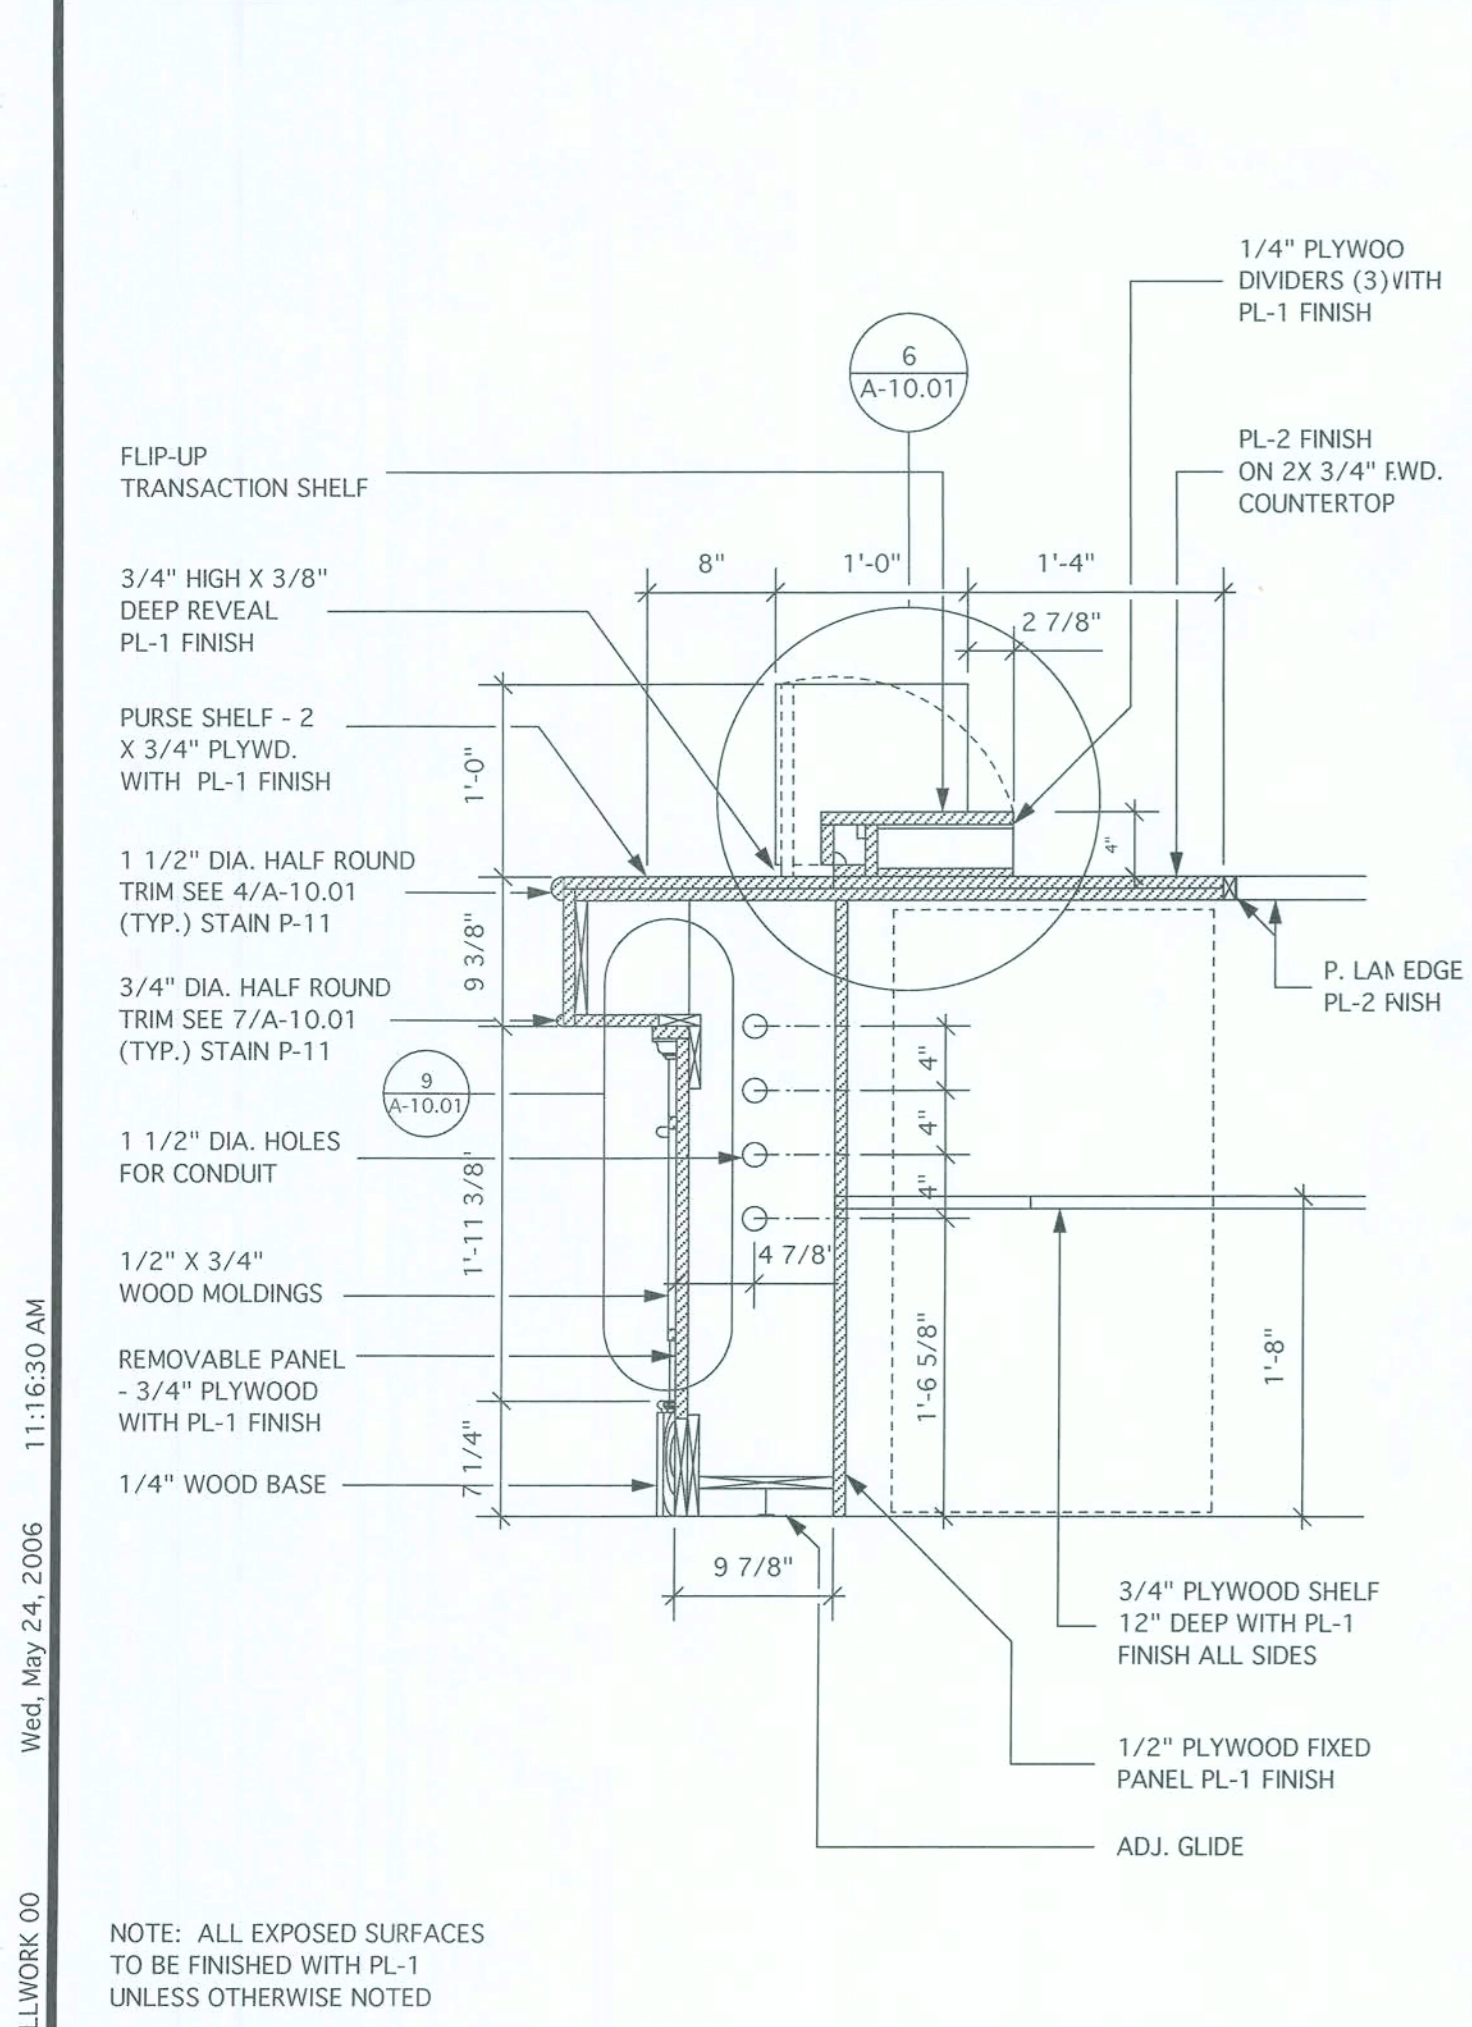
AT PASS-THRU



3 DETAIL - TELLERLINE SECTION


1" = 1'-0"

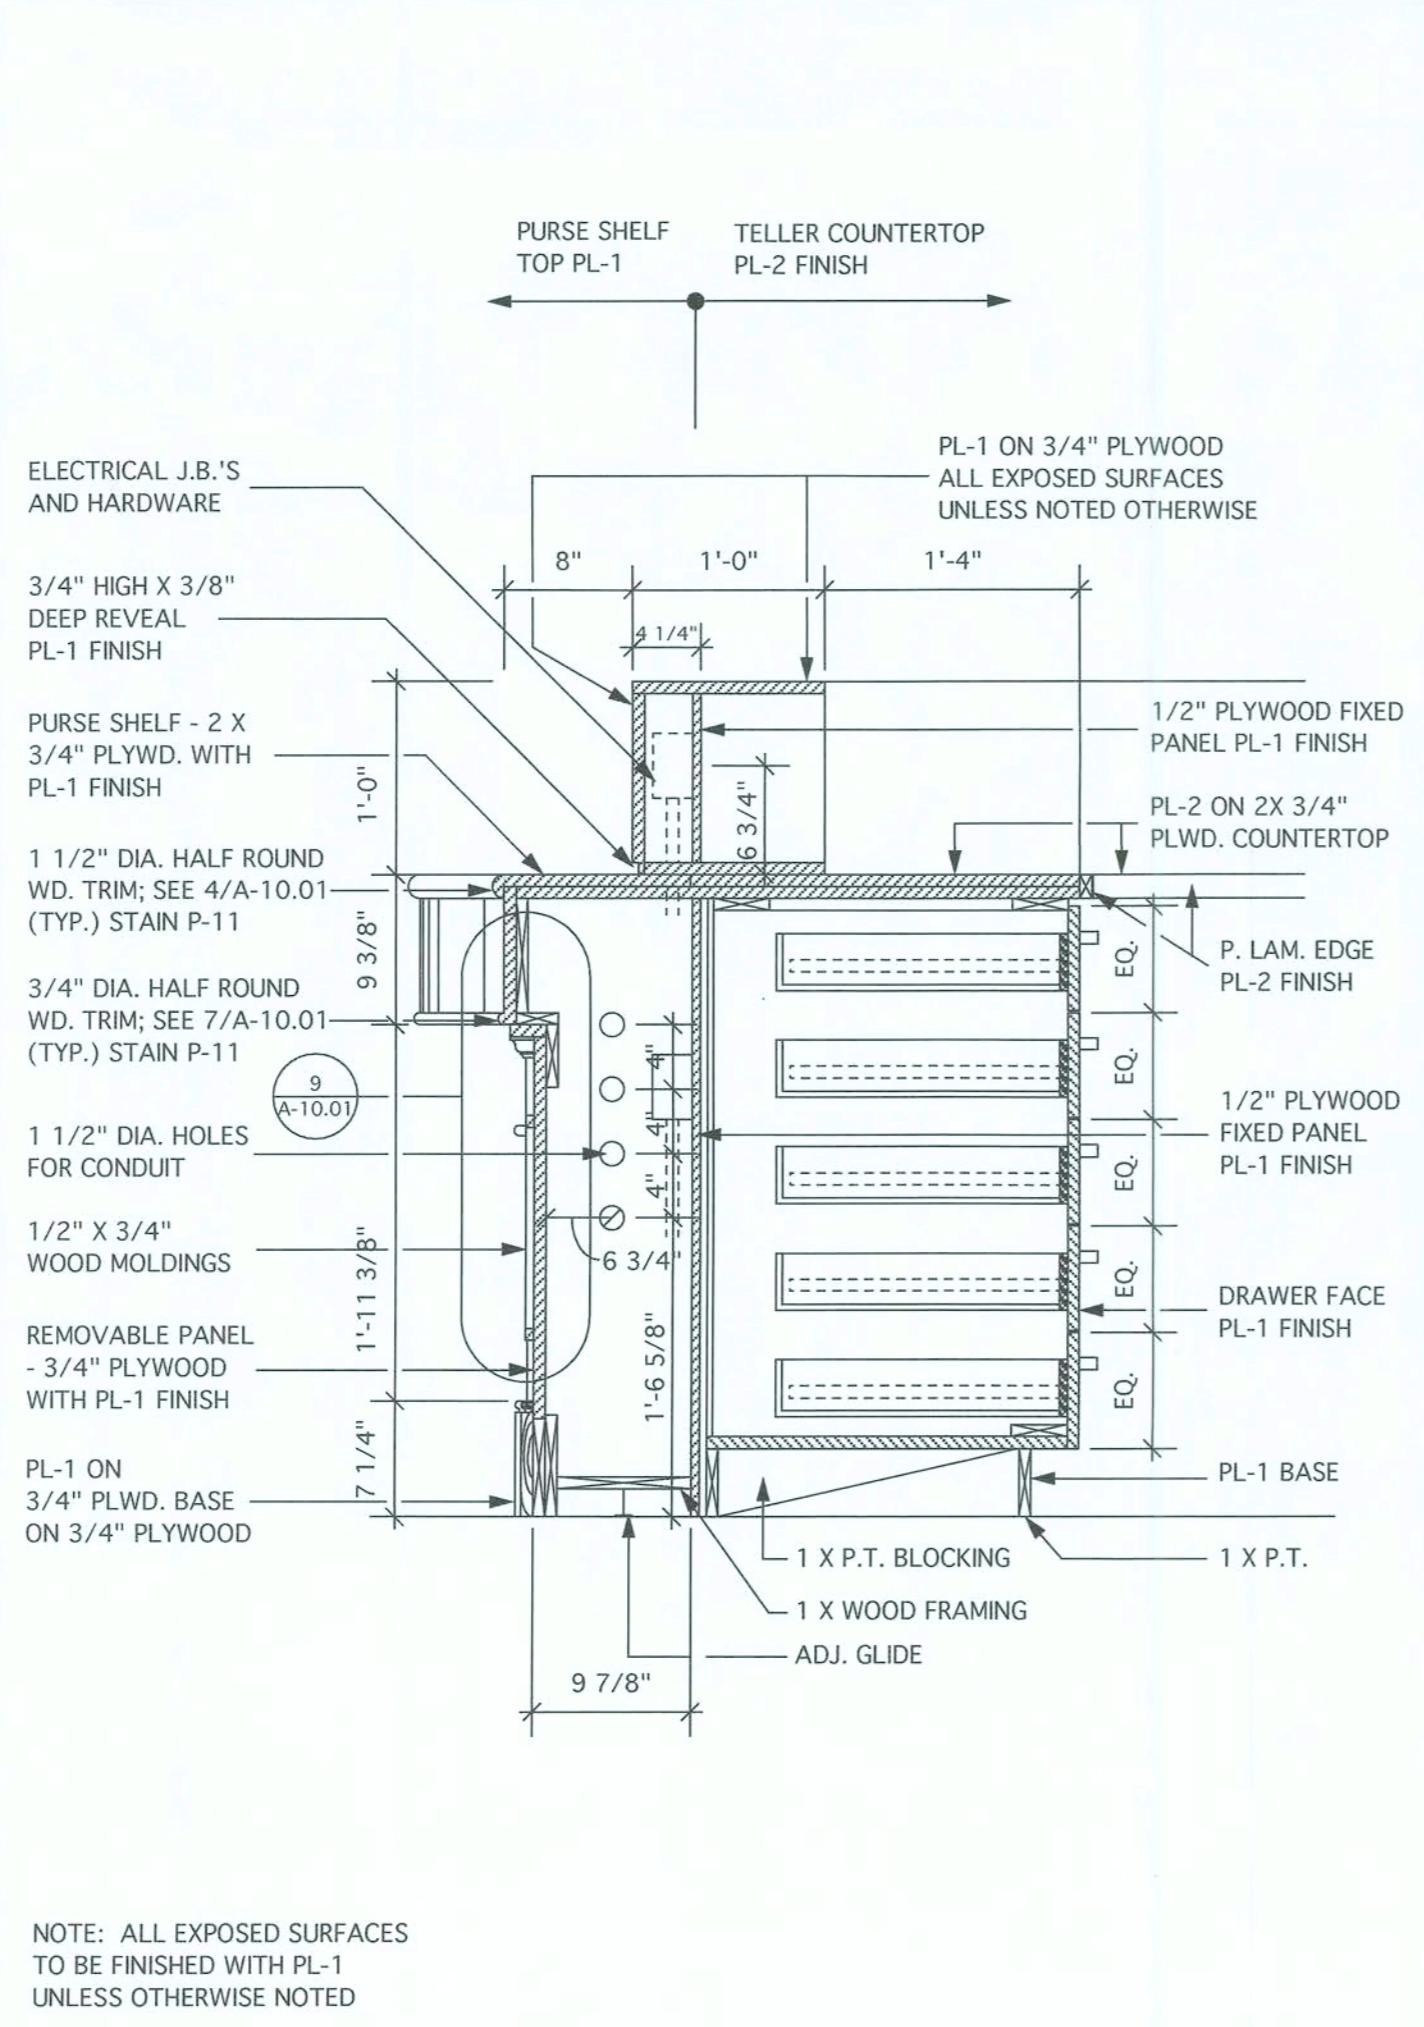AT TRANSACTIO SHELF



4 DETAIL - TELLERLINE SECTION

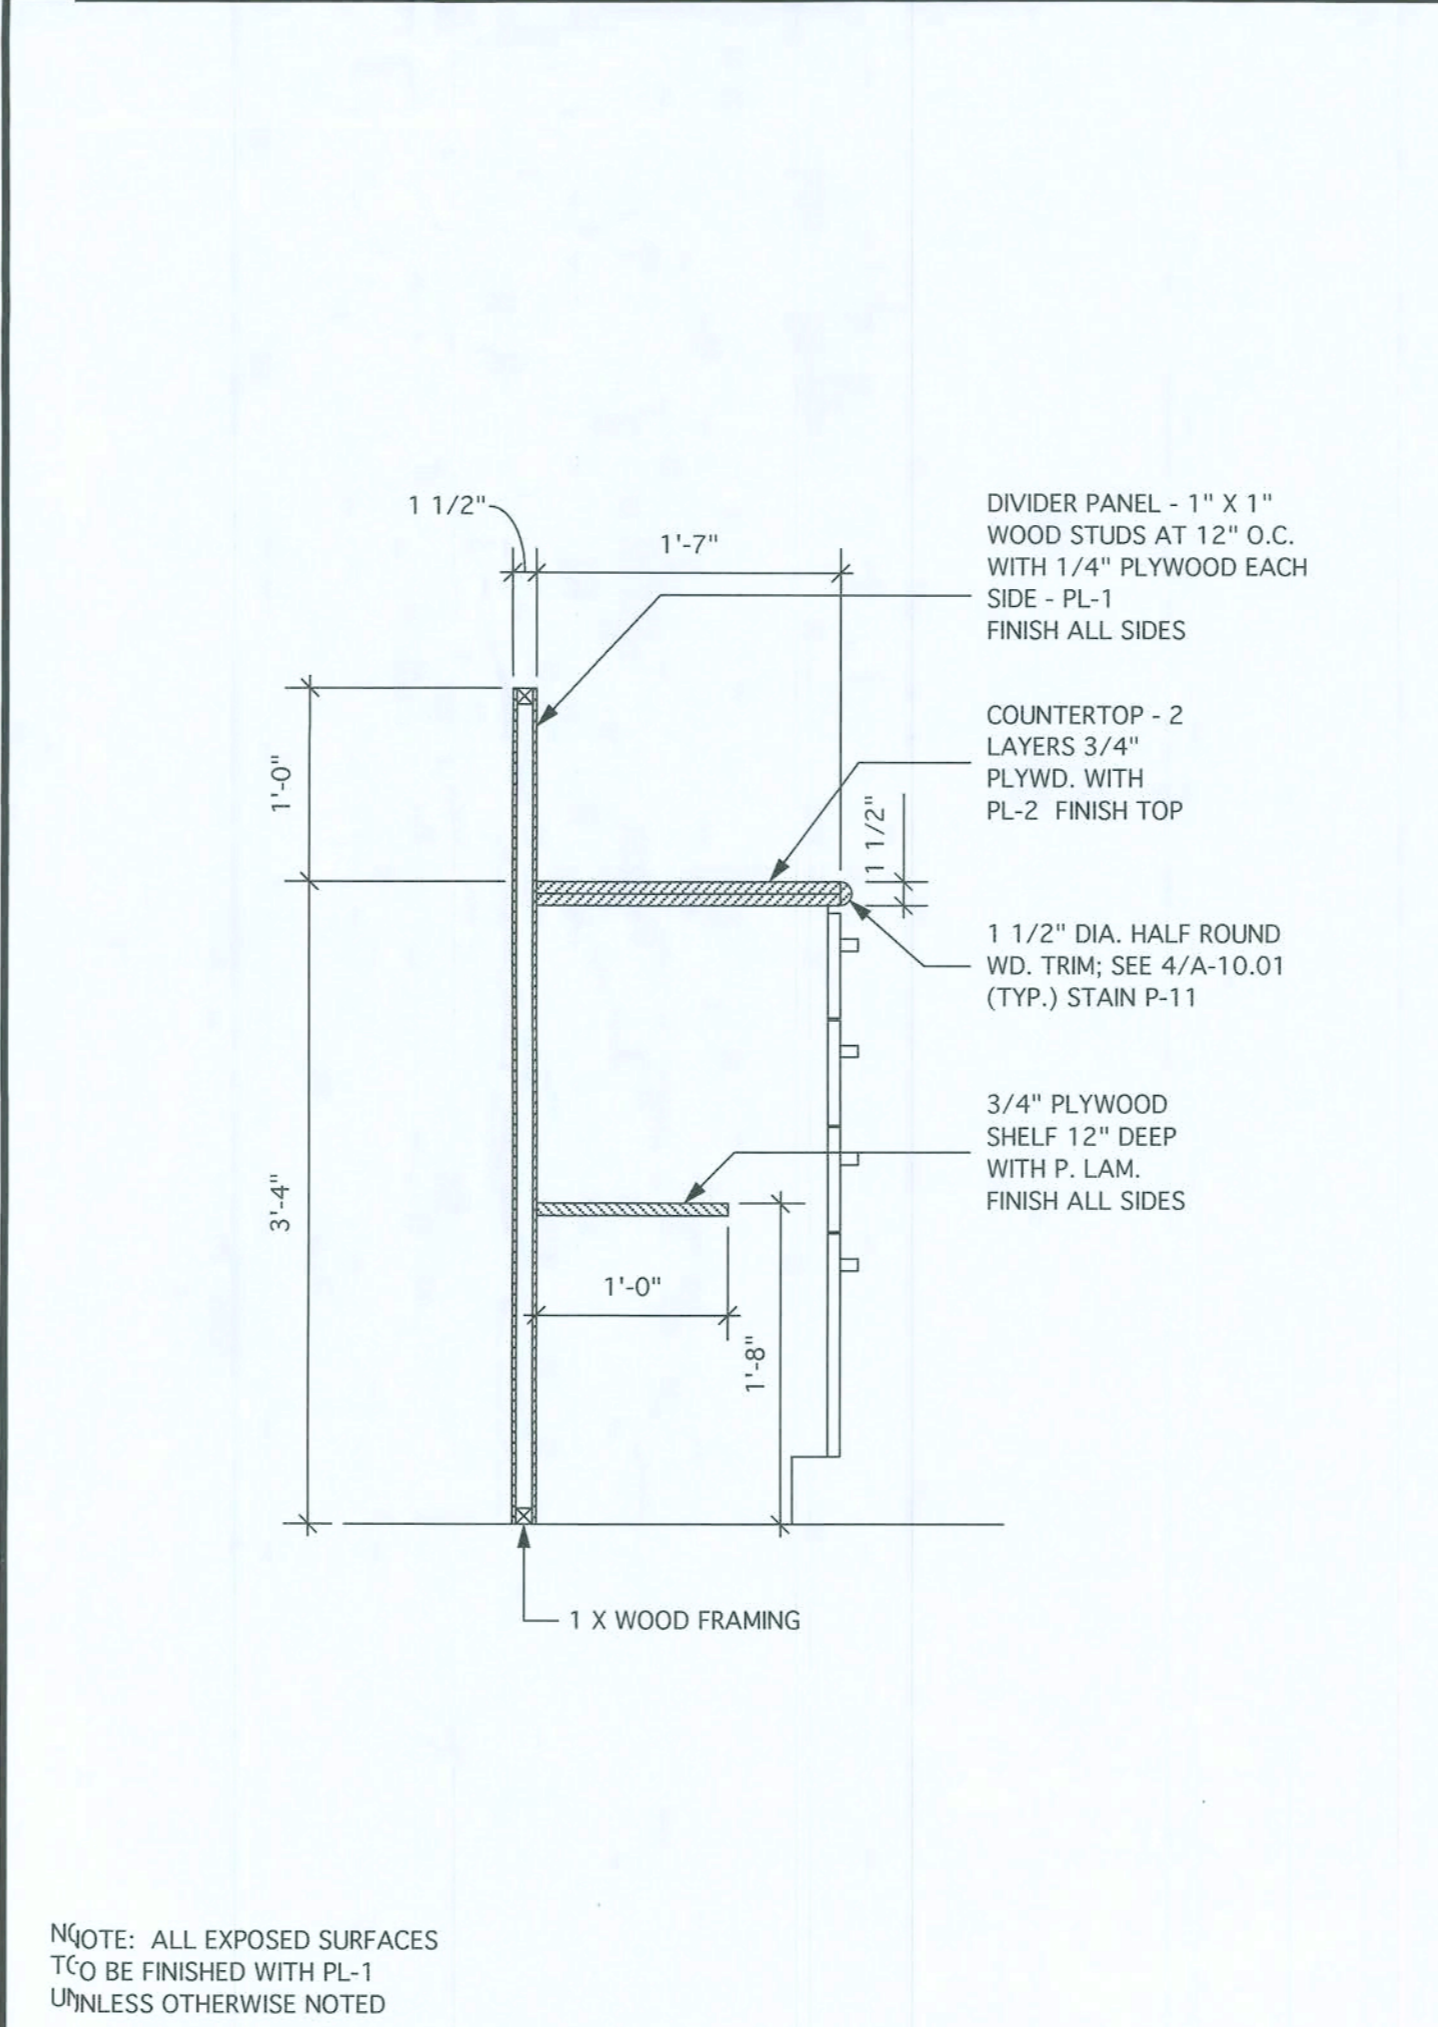
1" = 1'-0"



5 DETAIL - TELLERLINE SECTION

1" = 1'-0"

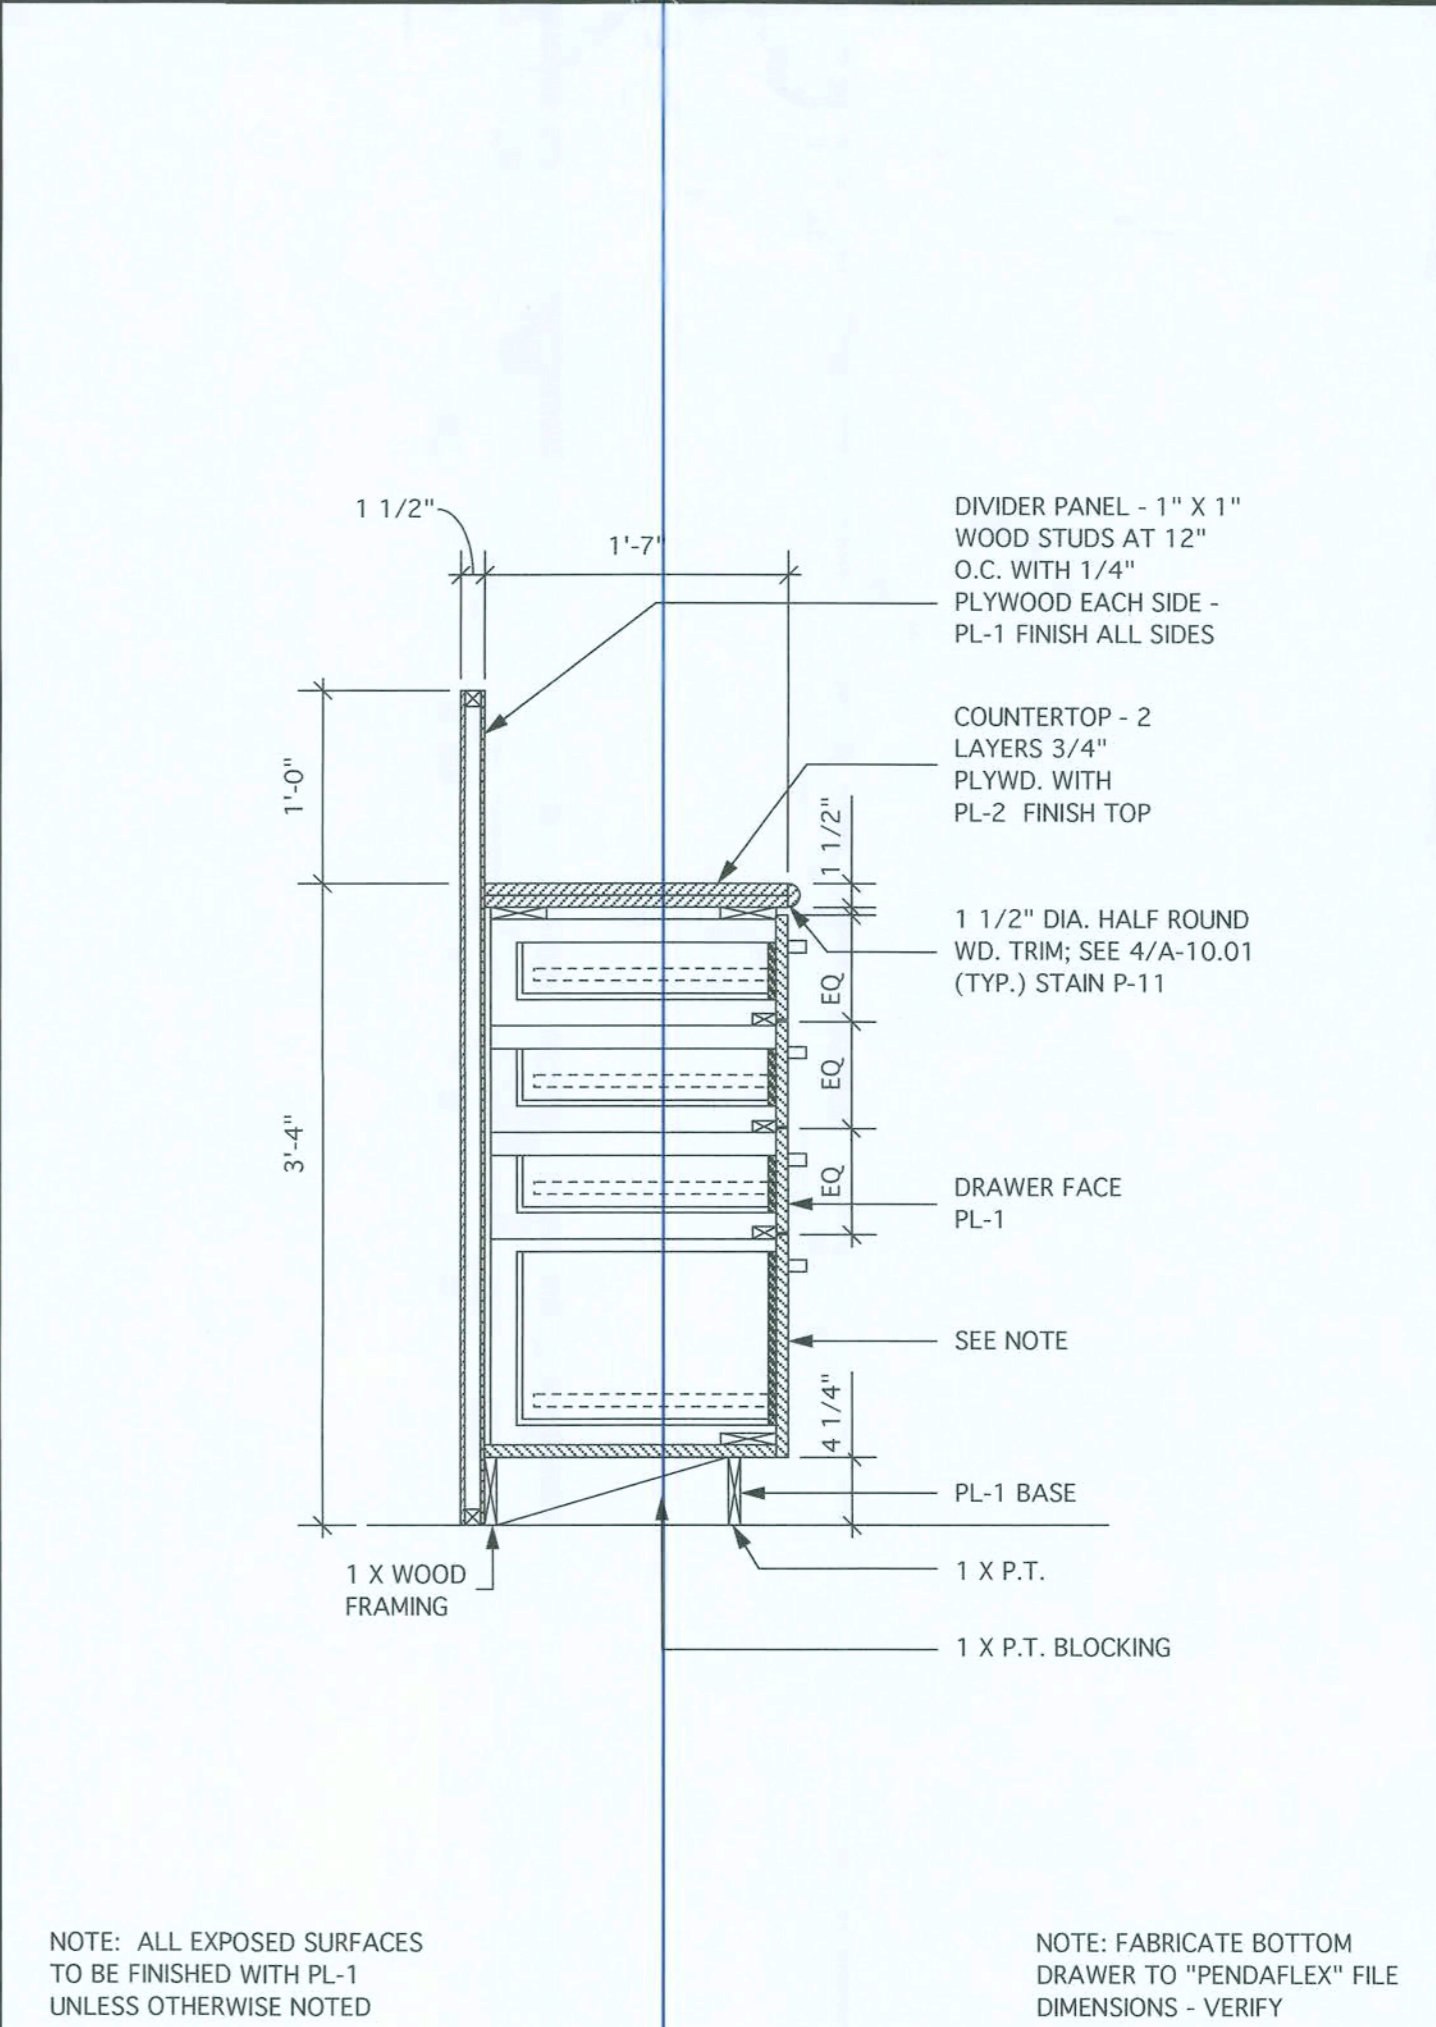AT RETURN



6 DETAIL - TELLERLINE SECTION

1" = 1'-0"

NOTE: FABRICATE BOTTOM DRAWER TO "PENDAFLEX" FILE DIMENSIONS - VERIFY

DESIGN SERVICES INCORPORATED
1778 N. PARK AVENUE, SUITE 100, MAITLAND, FL 32751,
TELEPHONE (407) 629-5755
ARCHITECTURE
INTERIOR DESIGN
SPACE PLANNING

WEST OFFICE
(NEW BRANCH BANK)
LAKE CITY, FLORIDA

PEOPLES
STATE BANK

LICENSE NO. F00061

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1
4
2
3

NORTH
ACTUAL
PLAN

INTERIOR ELEVATION KEY

MARK	DATE	REVISIONS


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DATE:	02/15/06	CHECKED:	ELM
SCALE:	AS NOTED		
FILE:	06003.00-MILLWORK 00		

MILLWORK DETAILS


SEAL	ARCHITECT/CONSULTANT
	EDDIE L. MUSE
	JUN 07 2006
	LICENSE NO. AR-12112
	SHEET NUMBER

A-10.00

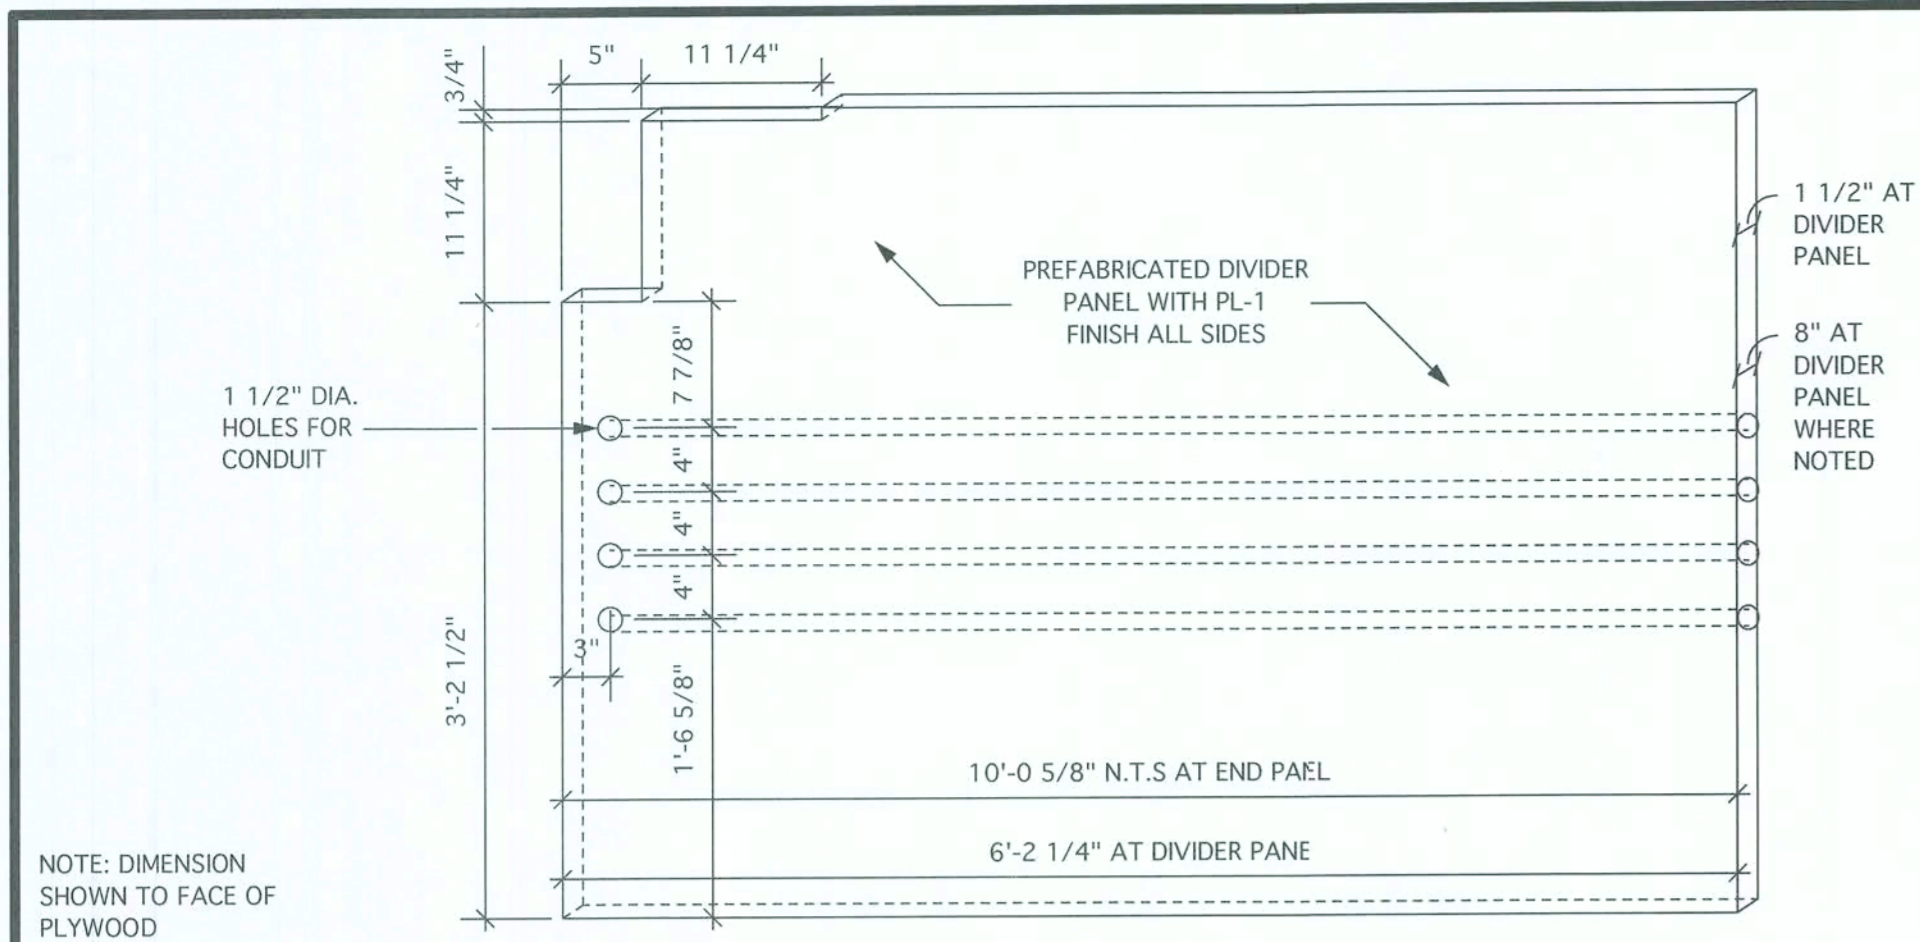
06003.00-MILLWORK 01 Wed, May 24, 2006 11:21:10 AM




1 DETAIL - DIVIDER PANELS
1" = 1'-0"

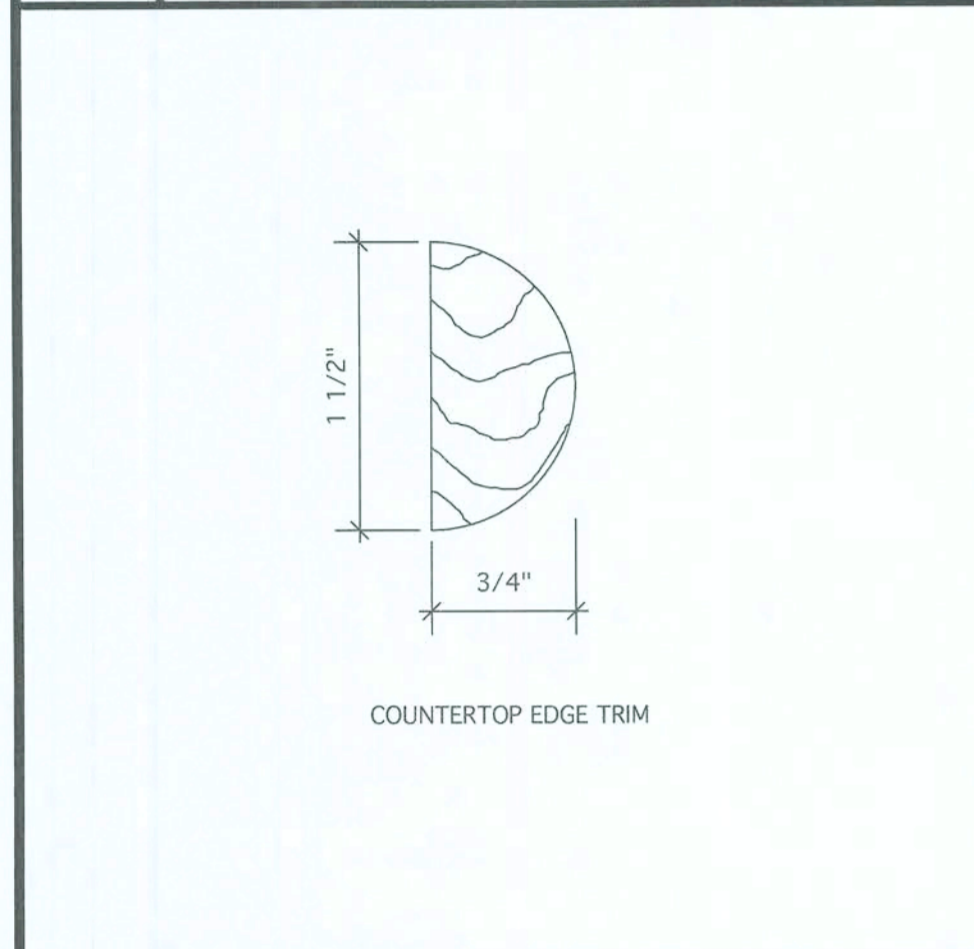


4 SECTION - WOOD TRIM
FULL SCALE

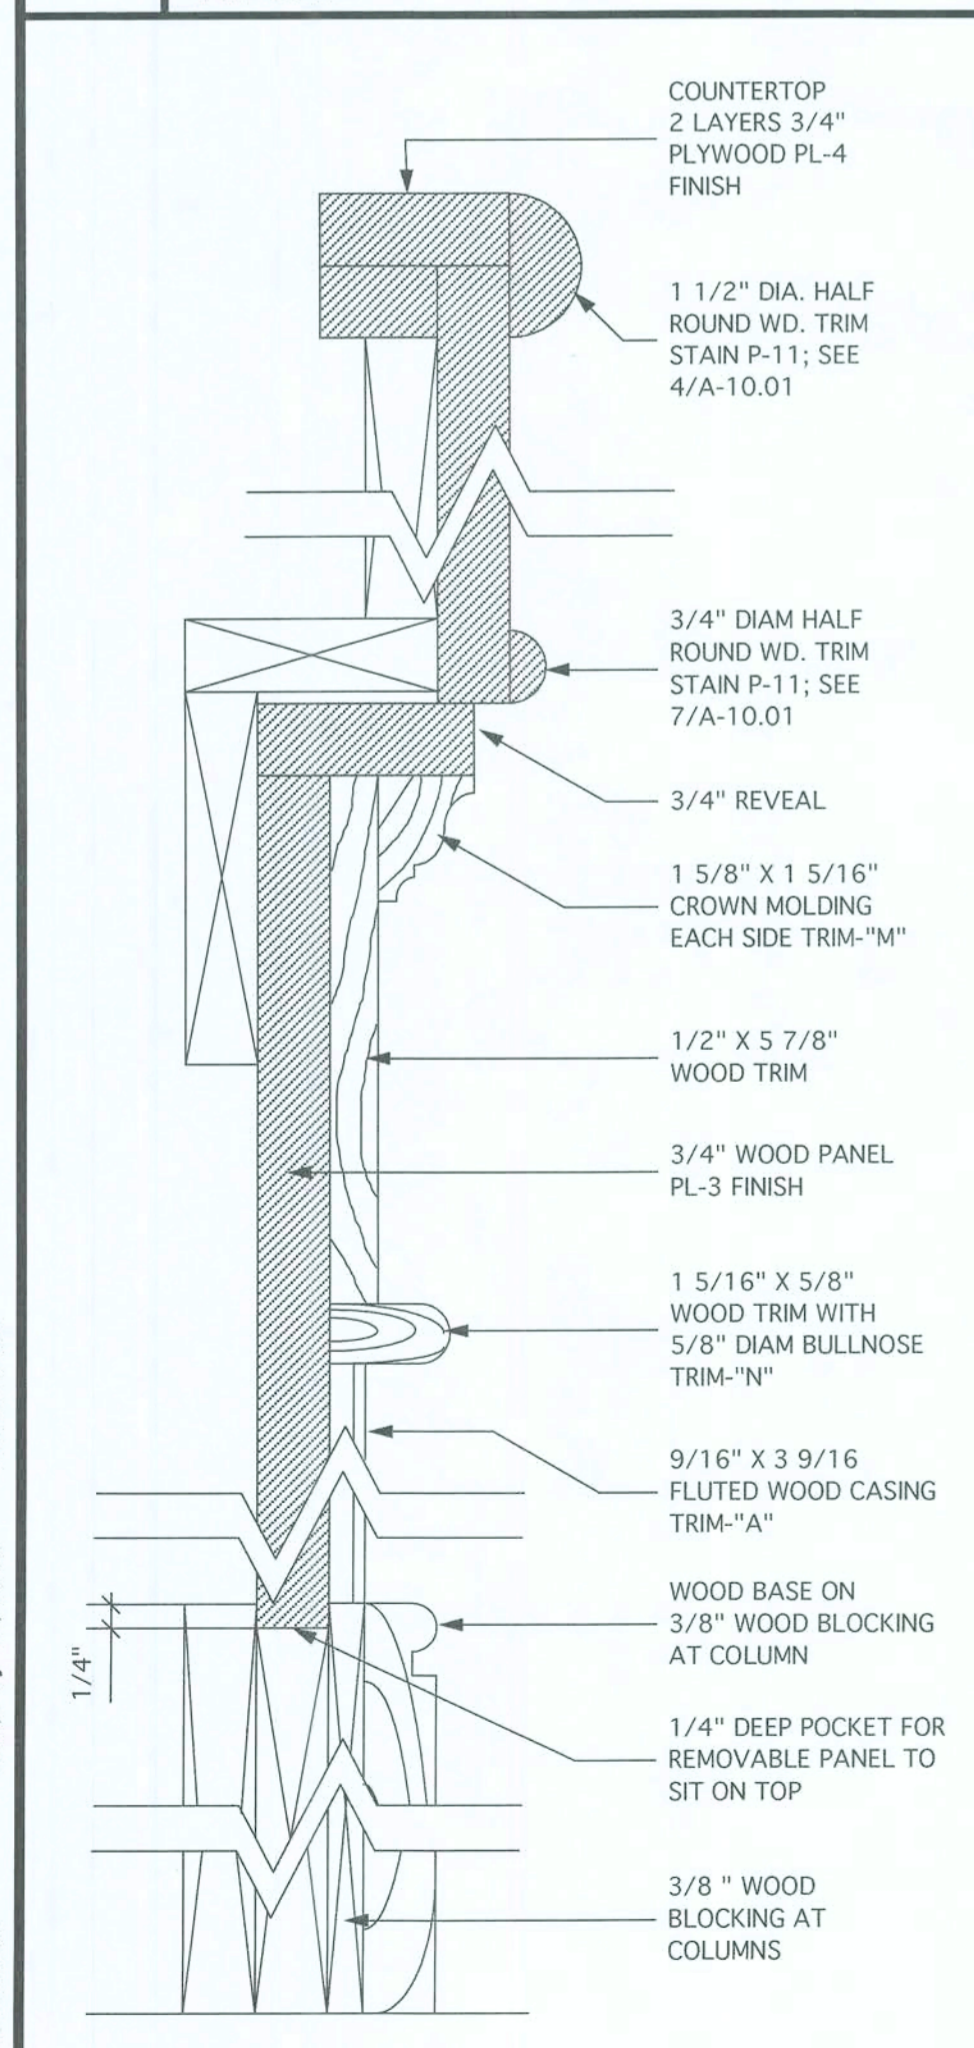

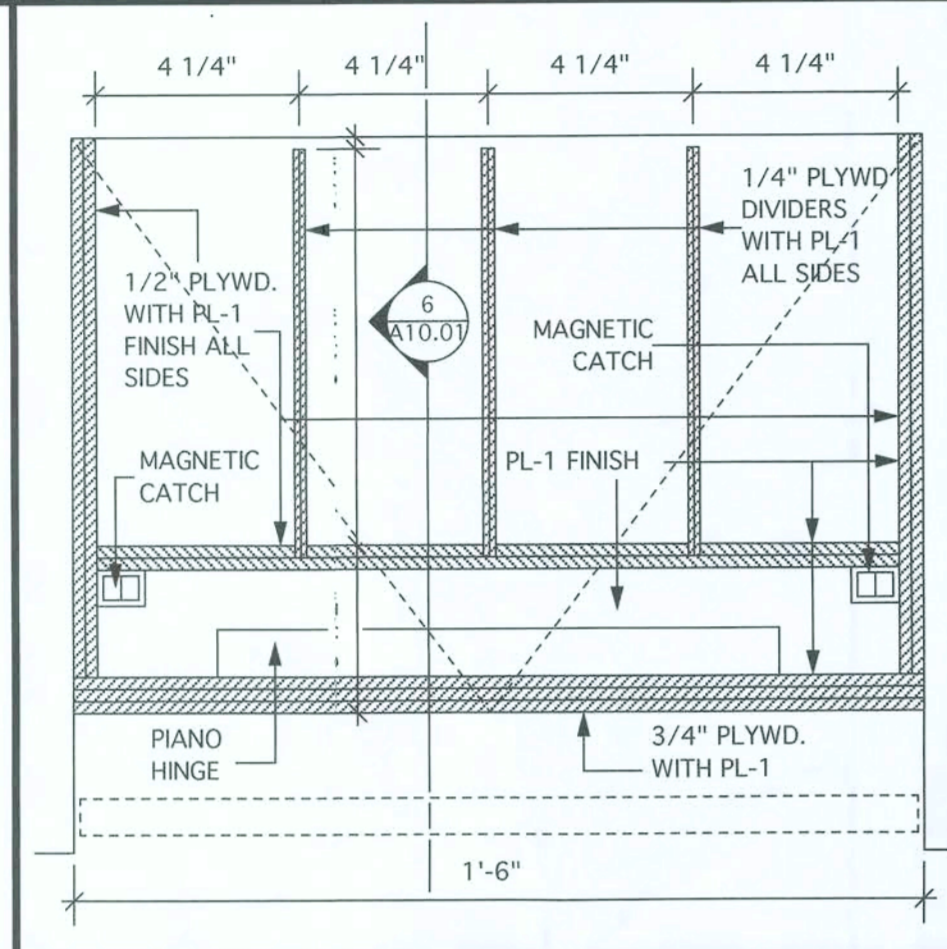
9 DETAIL - REMOVABLE PANEL
1/2 FULL AT TELLERLINE




5 DETAIL - TRANSACTION PLAN
3" = 1'-0"

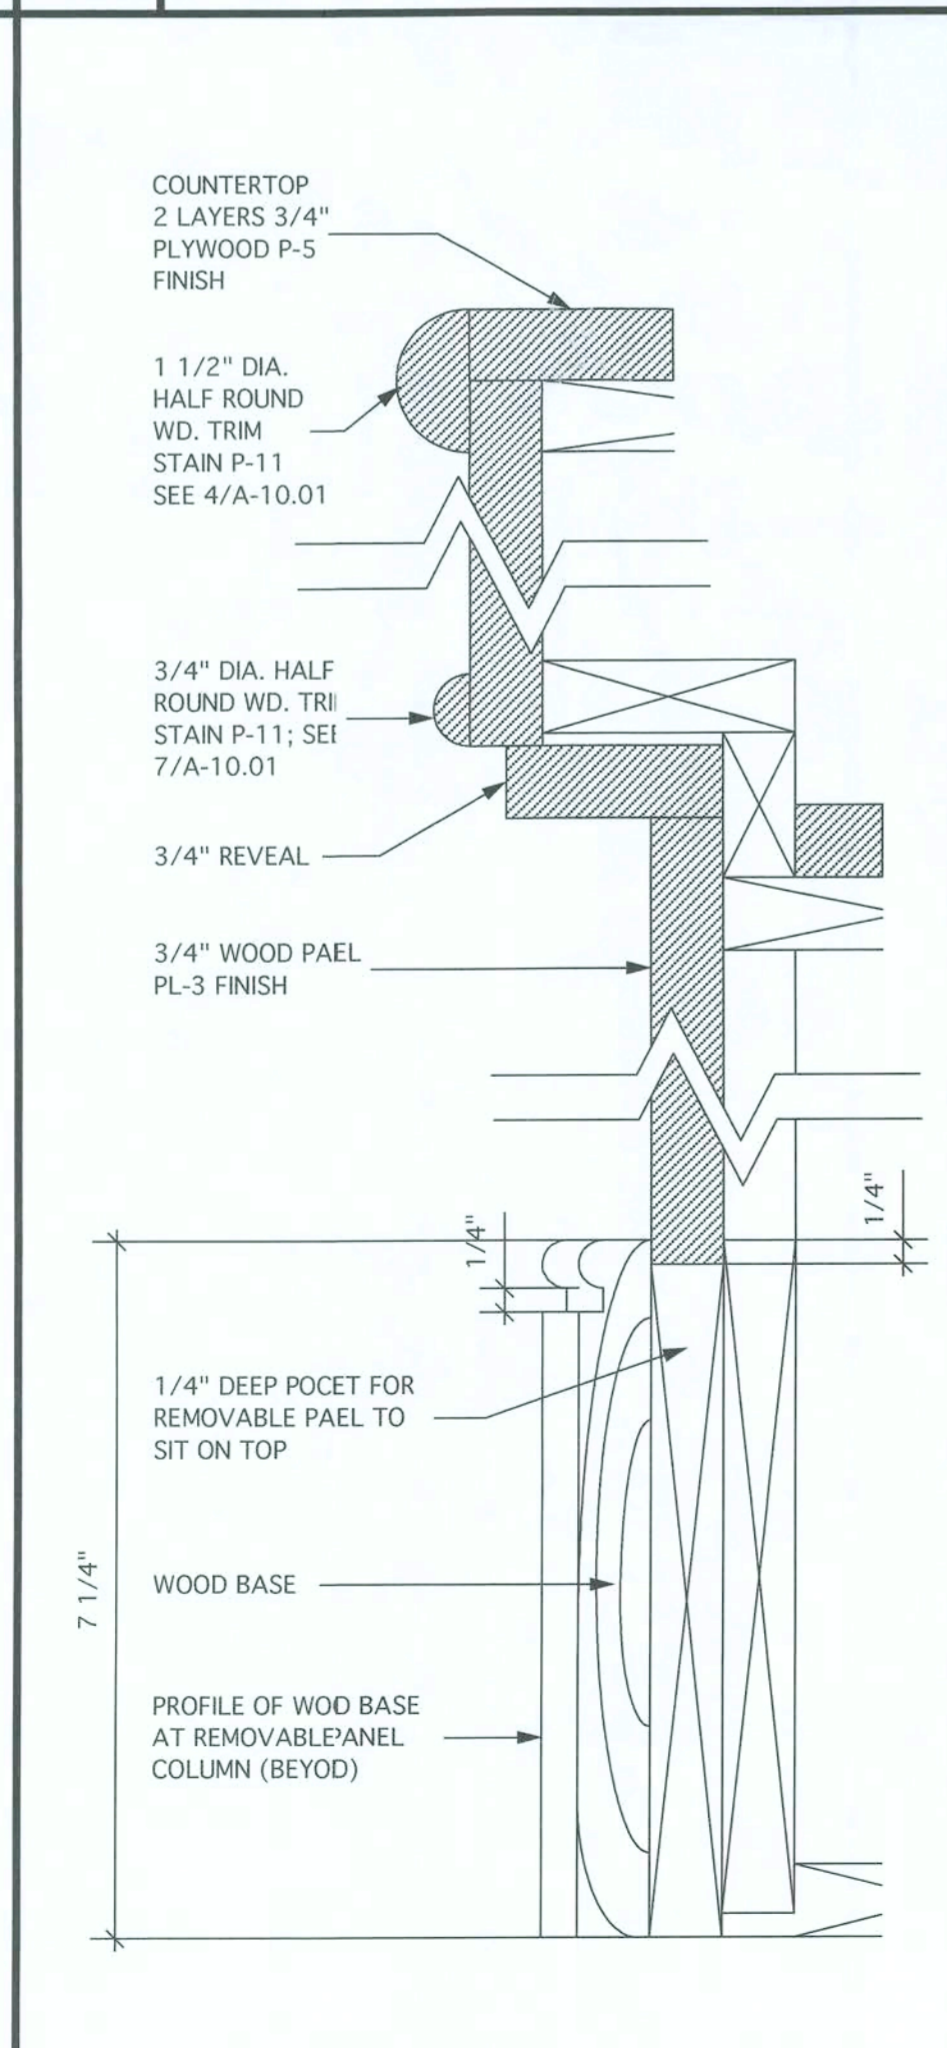

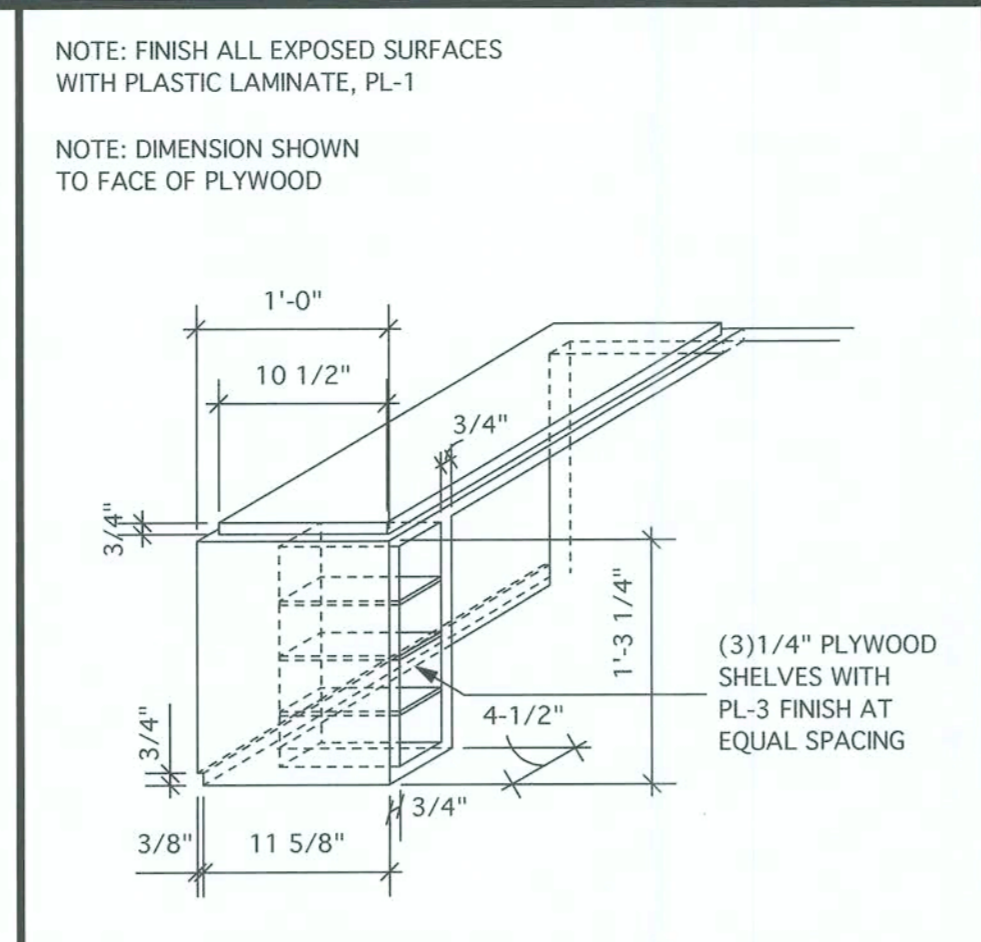
10 DETAIL - REMOVABLE PANEL
1/2 FULL AT NEW ACCOUNTS




2 DETAIL - PARAPET
1" = 1'-0"

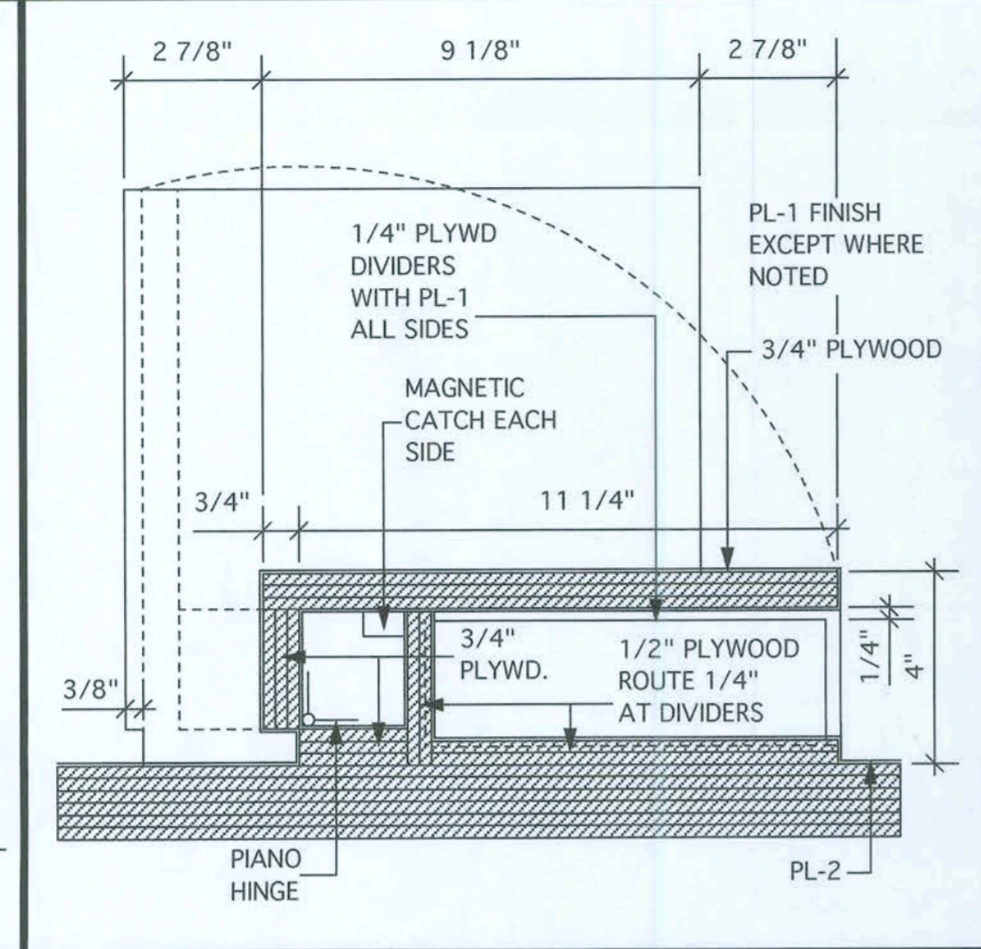


6 DETAIL - TRANSACTION SECT.
3" = 1'-0"

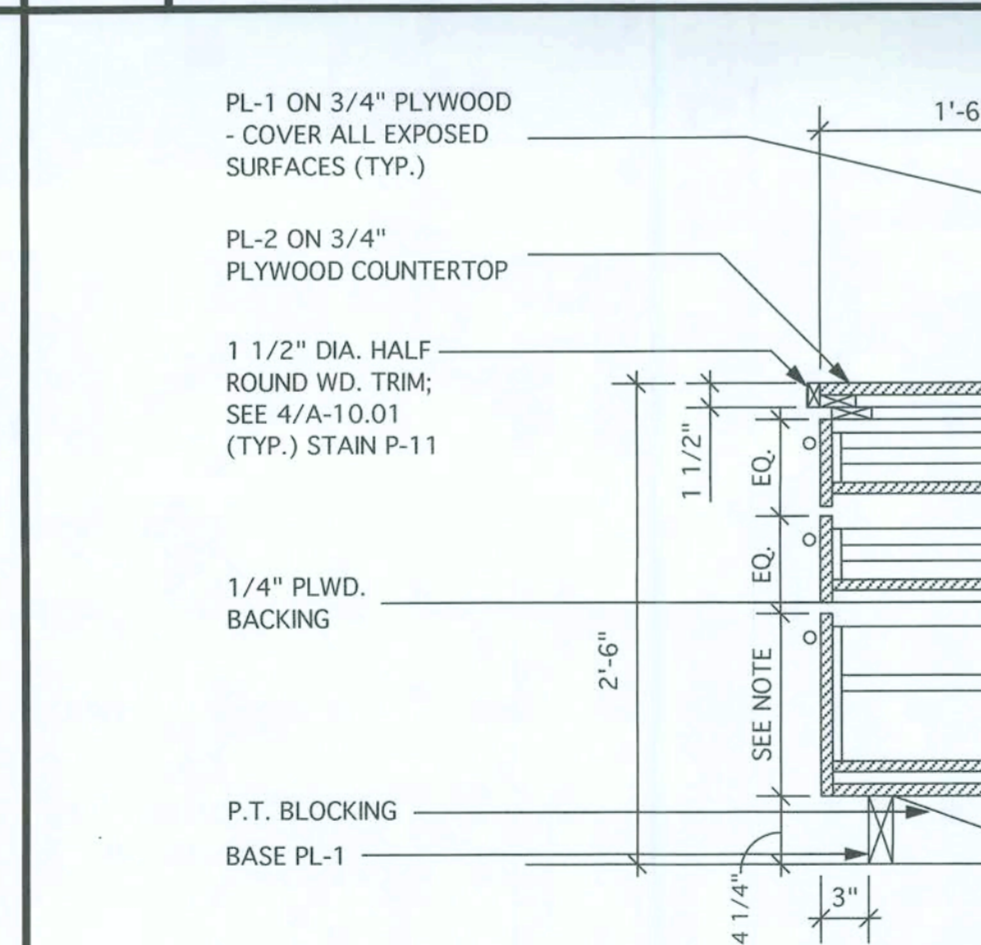

11 SECTION - BASE CABINETS
1" = 1'-0"

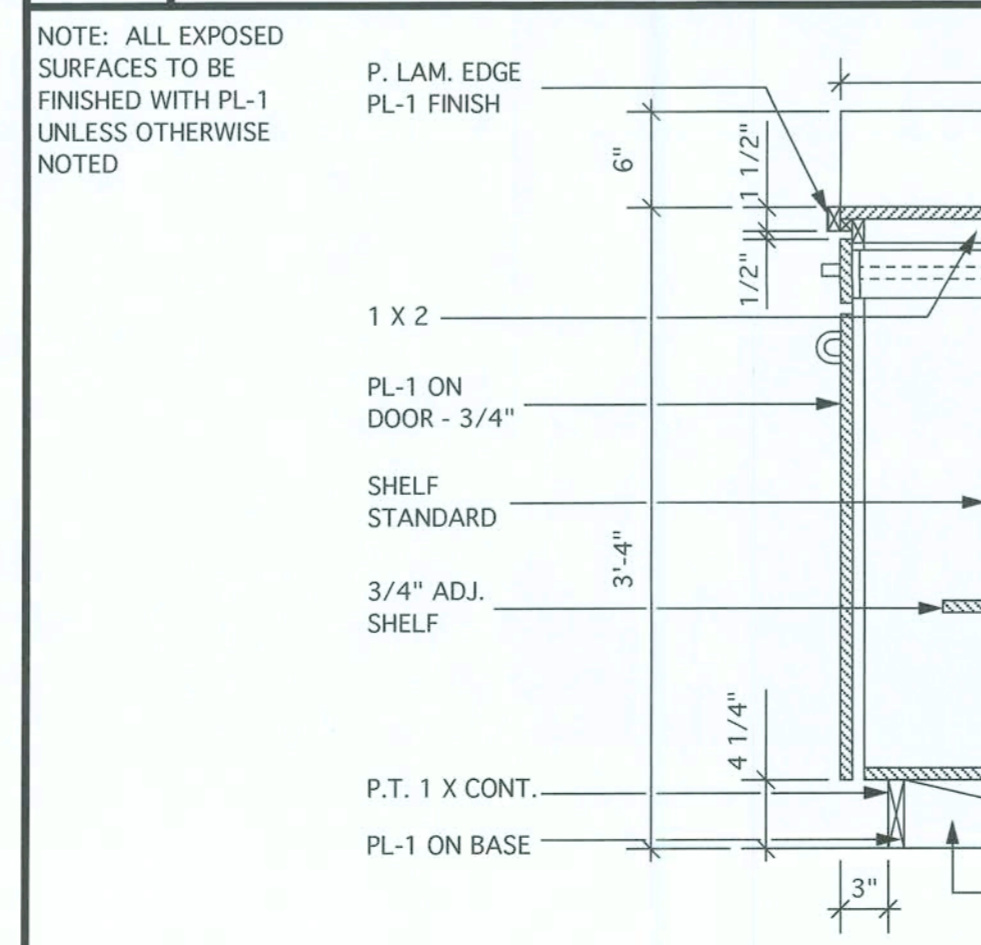


15 SECTION - BASE CABINETS
1" = 1'-0"

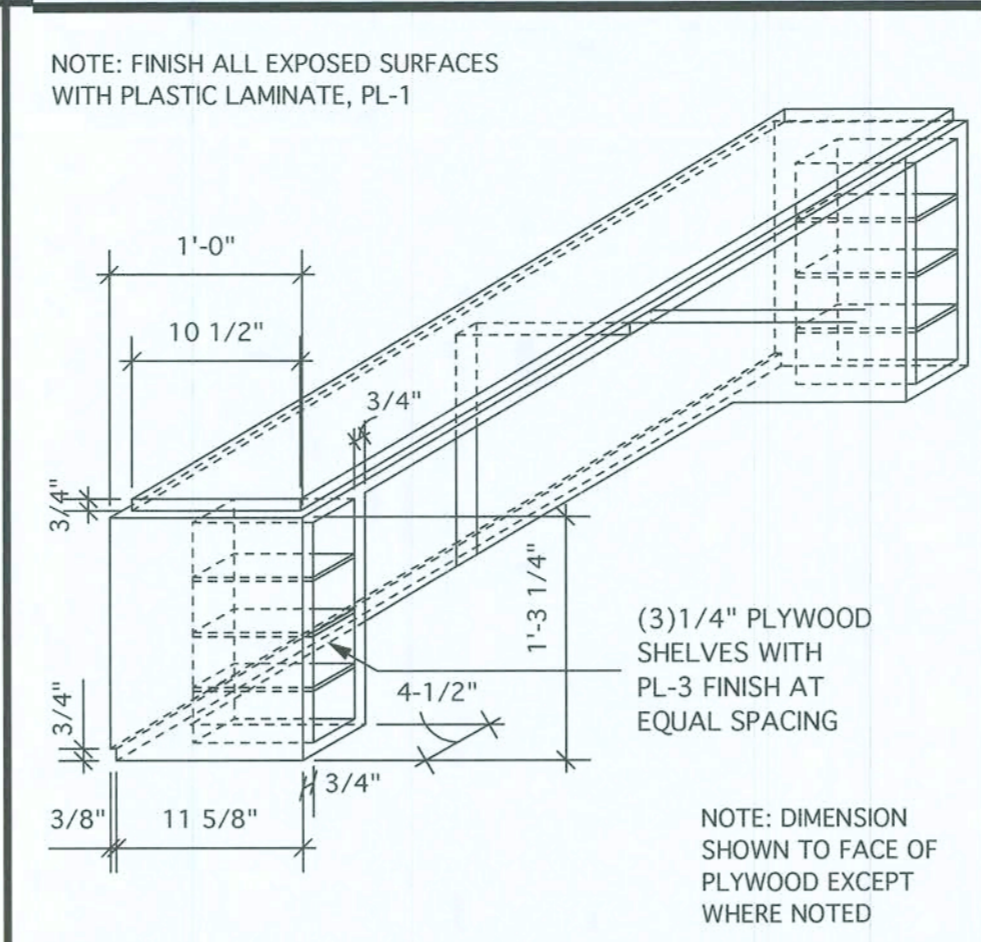


3 DETAIL - EXTENDED PARAPET
1" = 1'-0"



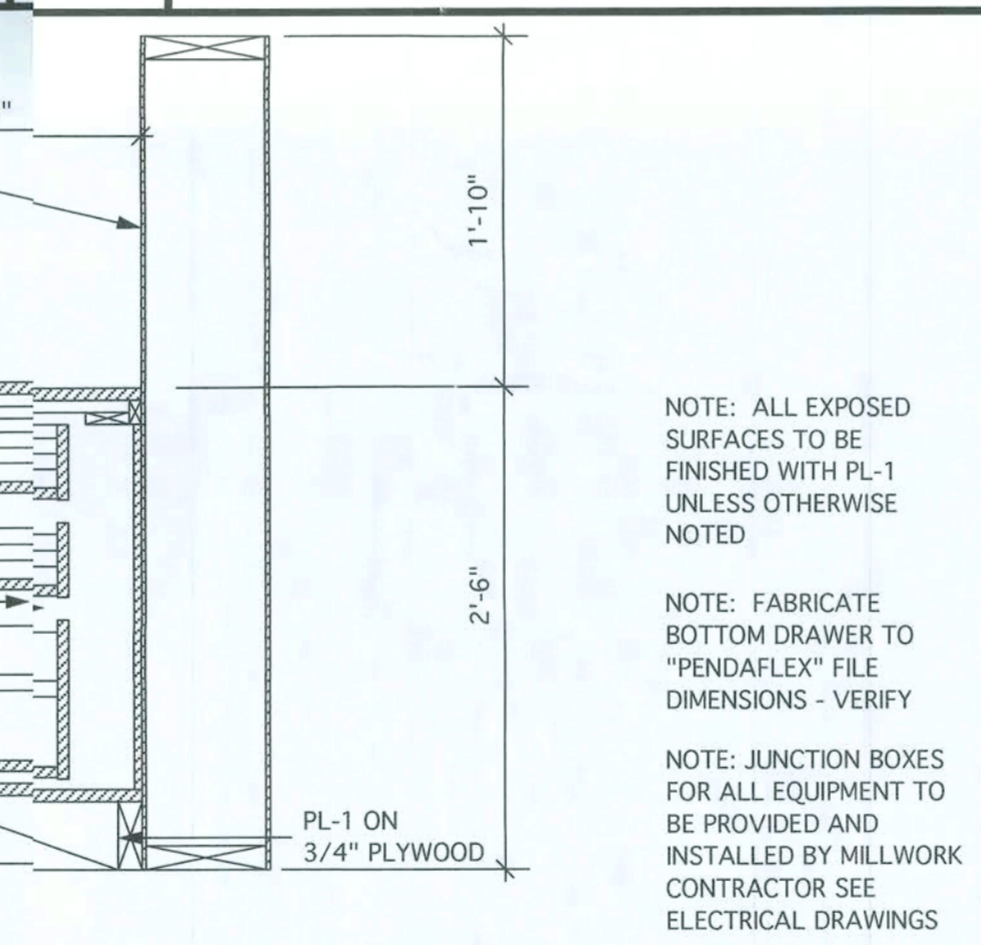
8 DETAIL - NEW ACCOUNTS PLAN
3/4" = 1'-0"




12 SECTION - NEW ACCOUNTS
1" = 1'-0"

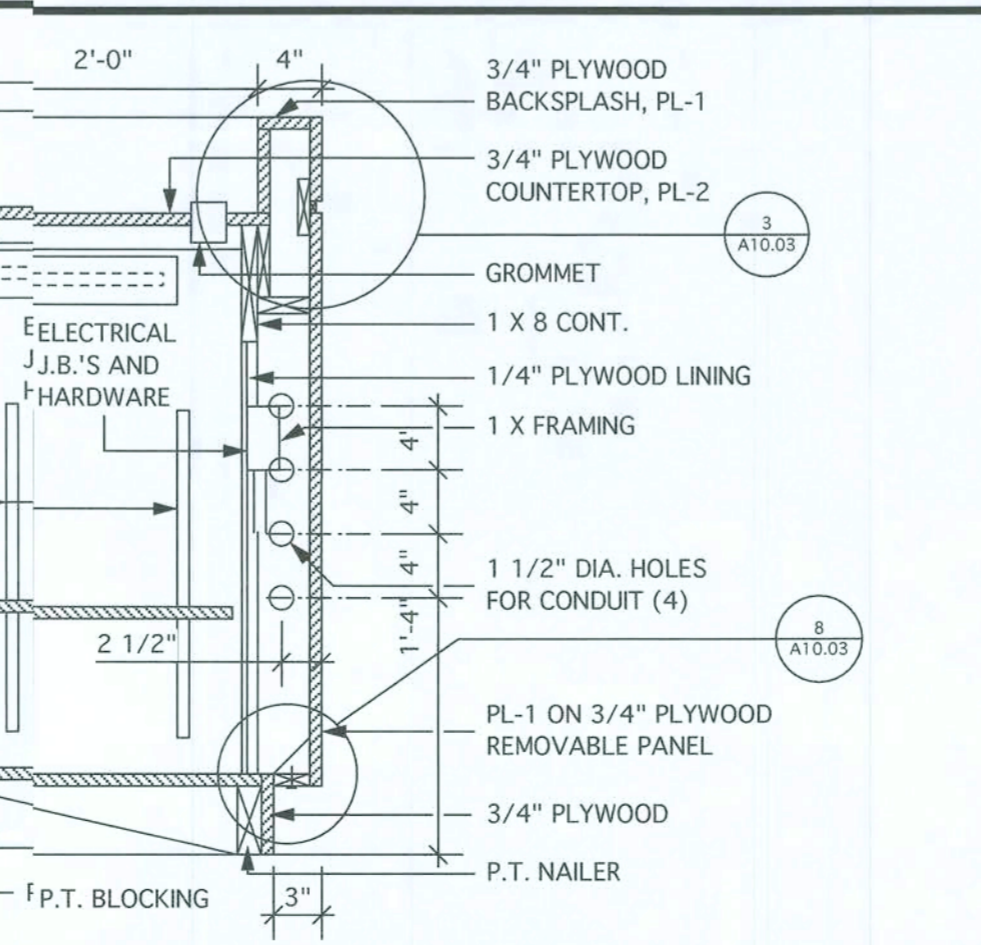


16 SECTION - NEW ACCOUNTS
1" = 1'-0"

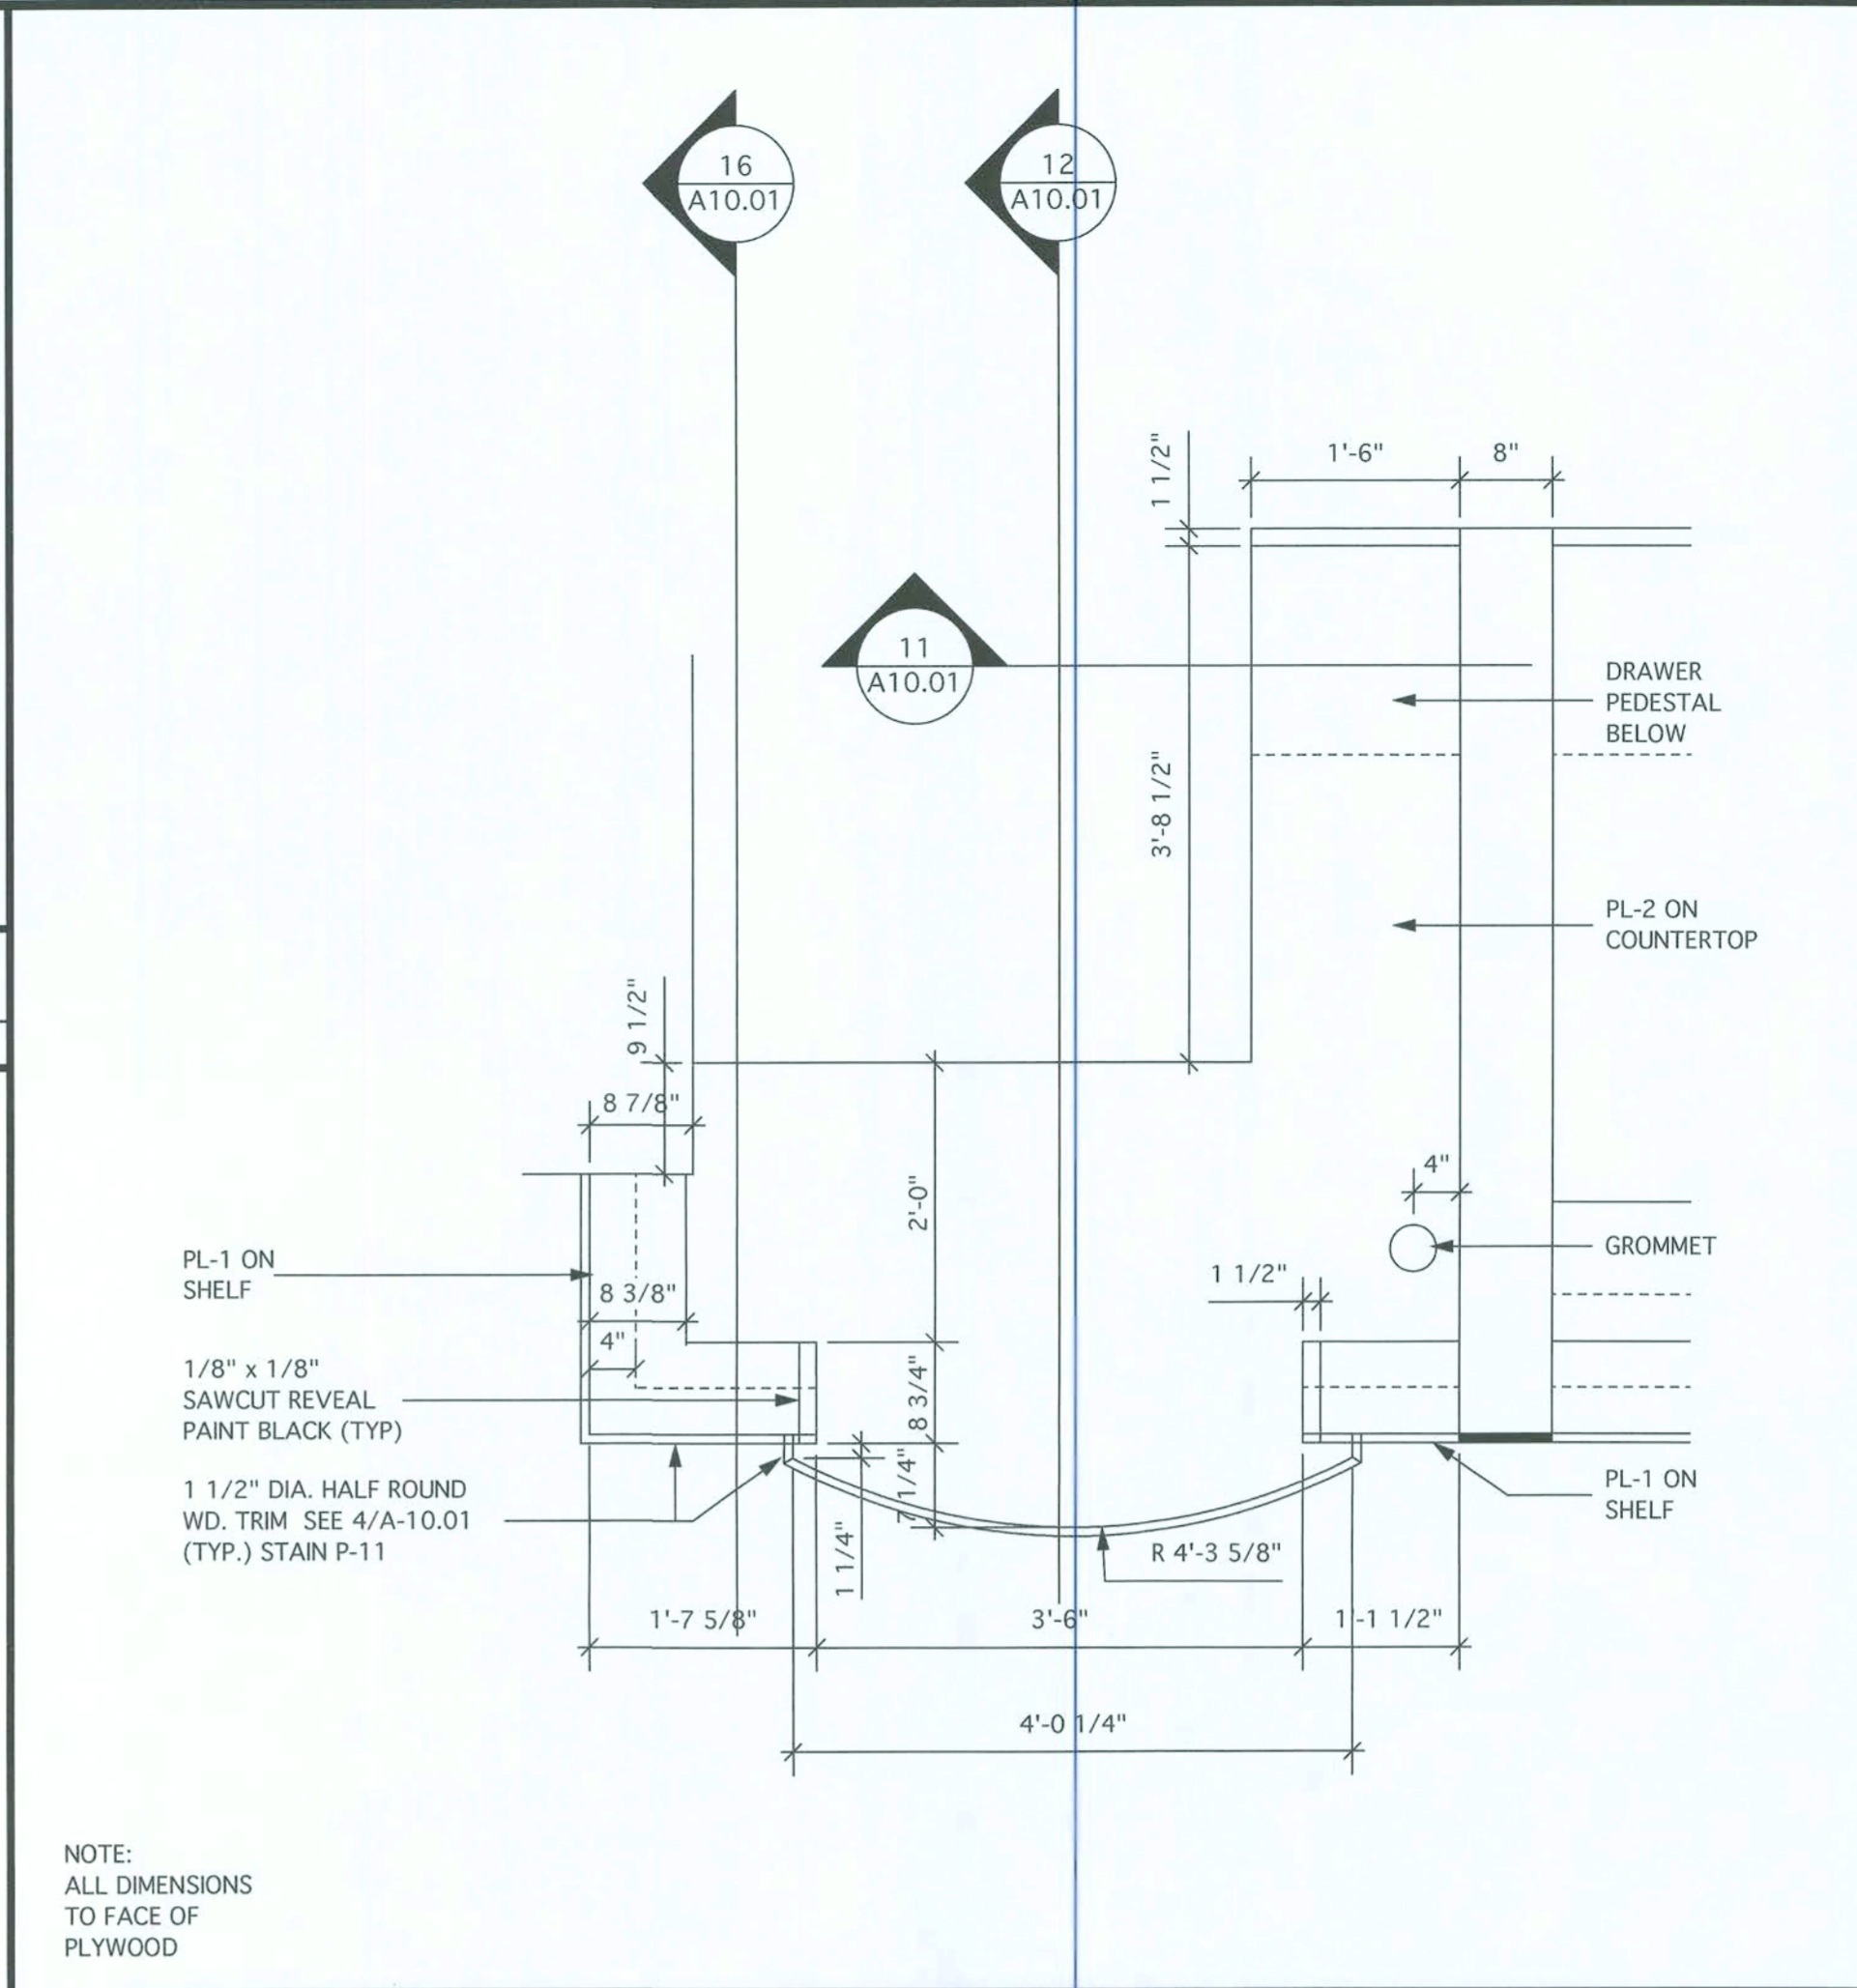

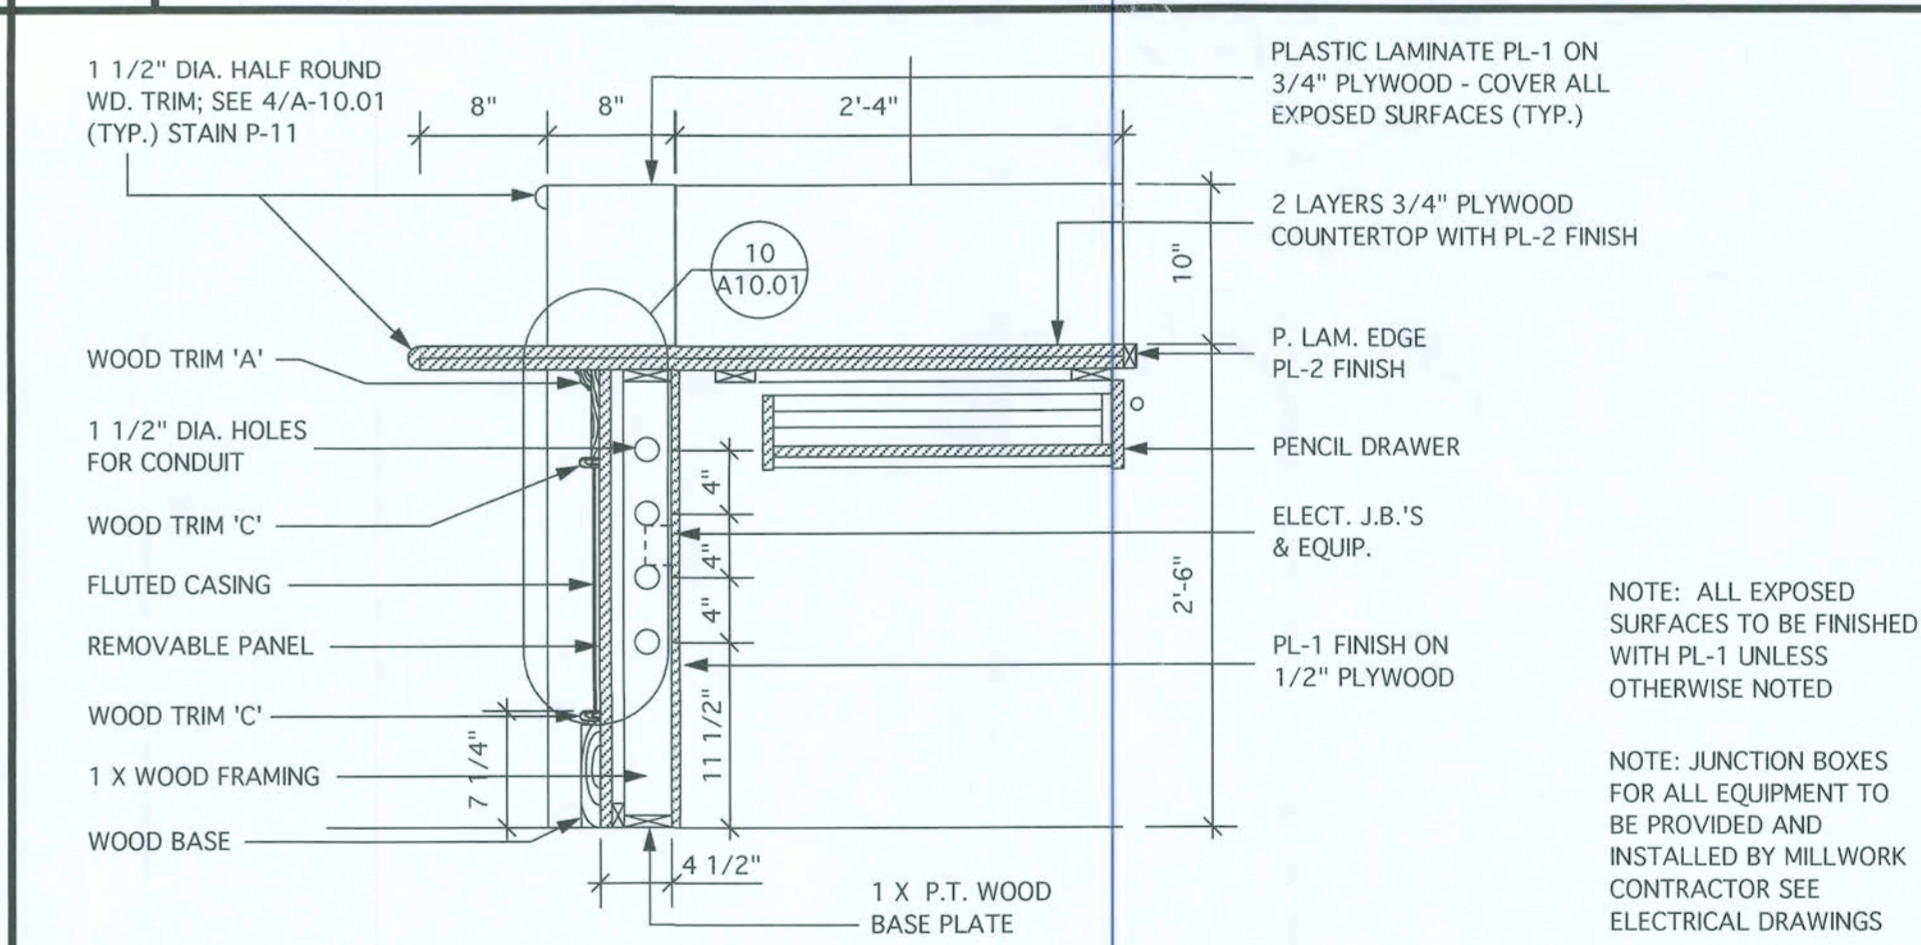8 DETAIL - NEW ACCOUNTS PLAN
3/4" = 1'-0"



12 SECTION - NEW ACCOUNTS
1" = 1'-0"

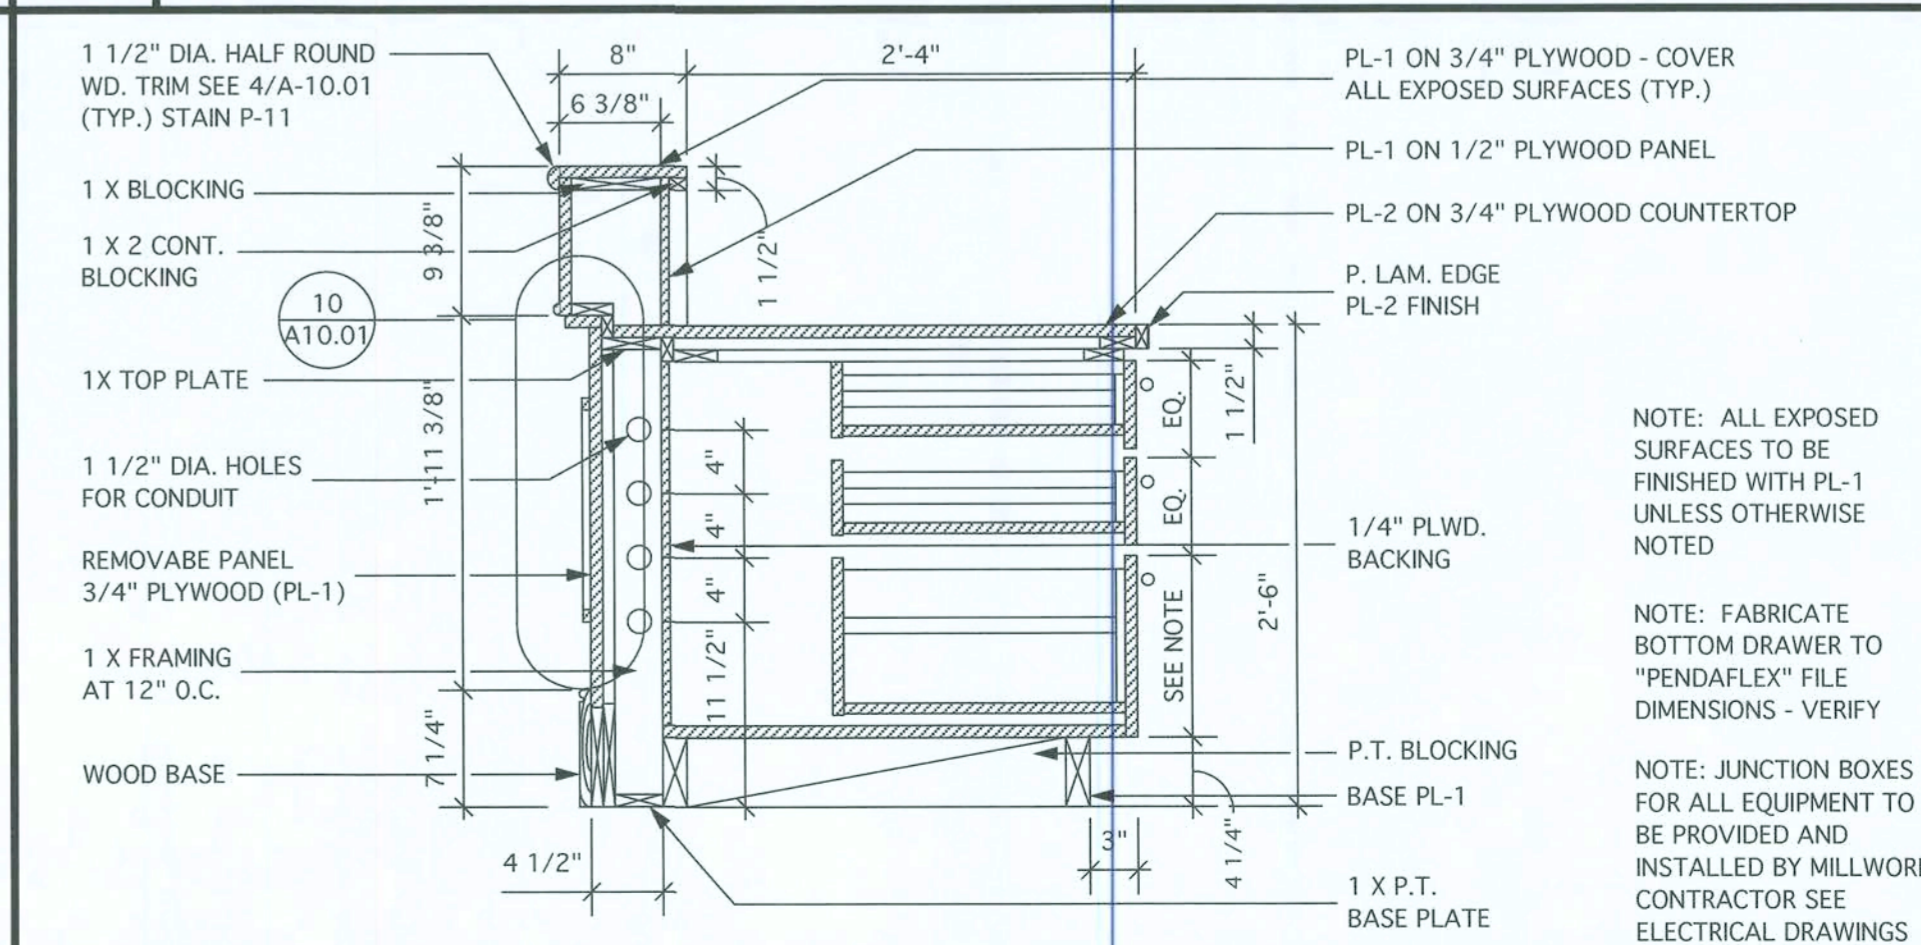

16 SECTION - NEW ACCOUNTS
1" = 1'-0"

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TELEPHONE (407) 629-5755
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1 2 3 4

INTERIOR ELEVATION KEY

NORTH

ACTUAL PLAN

MARK	DATE	REVISIONS


COMM. NO.	06003.00	DRAWN:	KLP
DATE:	02/15/06	CHECKED:	ELM
SCALE:	AS NOTED		
FILE:	06003.00-MILWORK 01		


MILLWORK DETAILS

SEAL

ARCHITECT/CONSULTANT

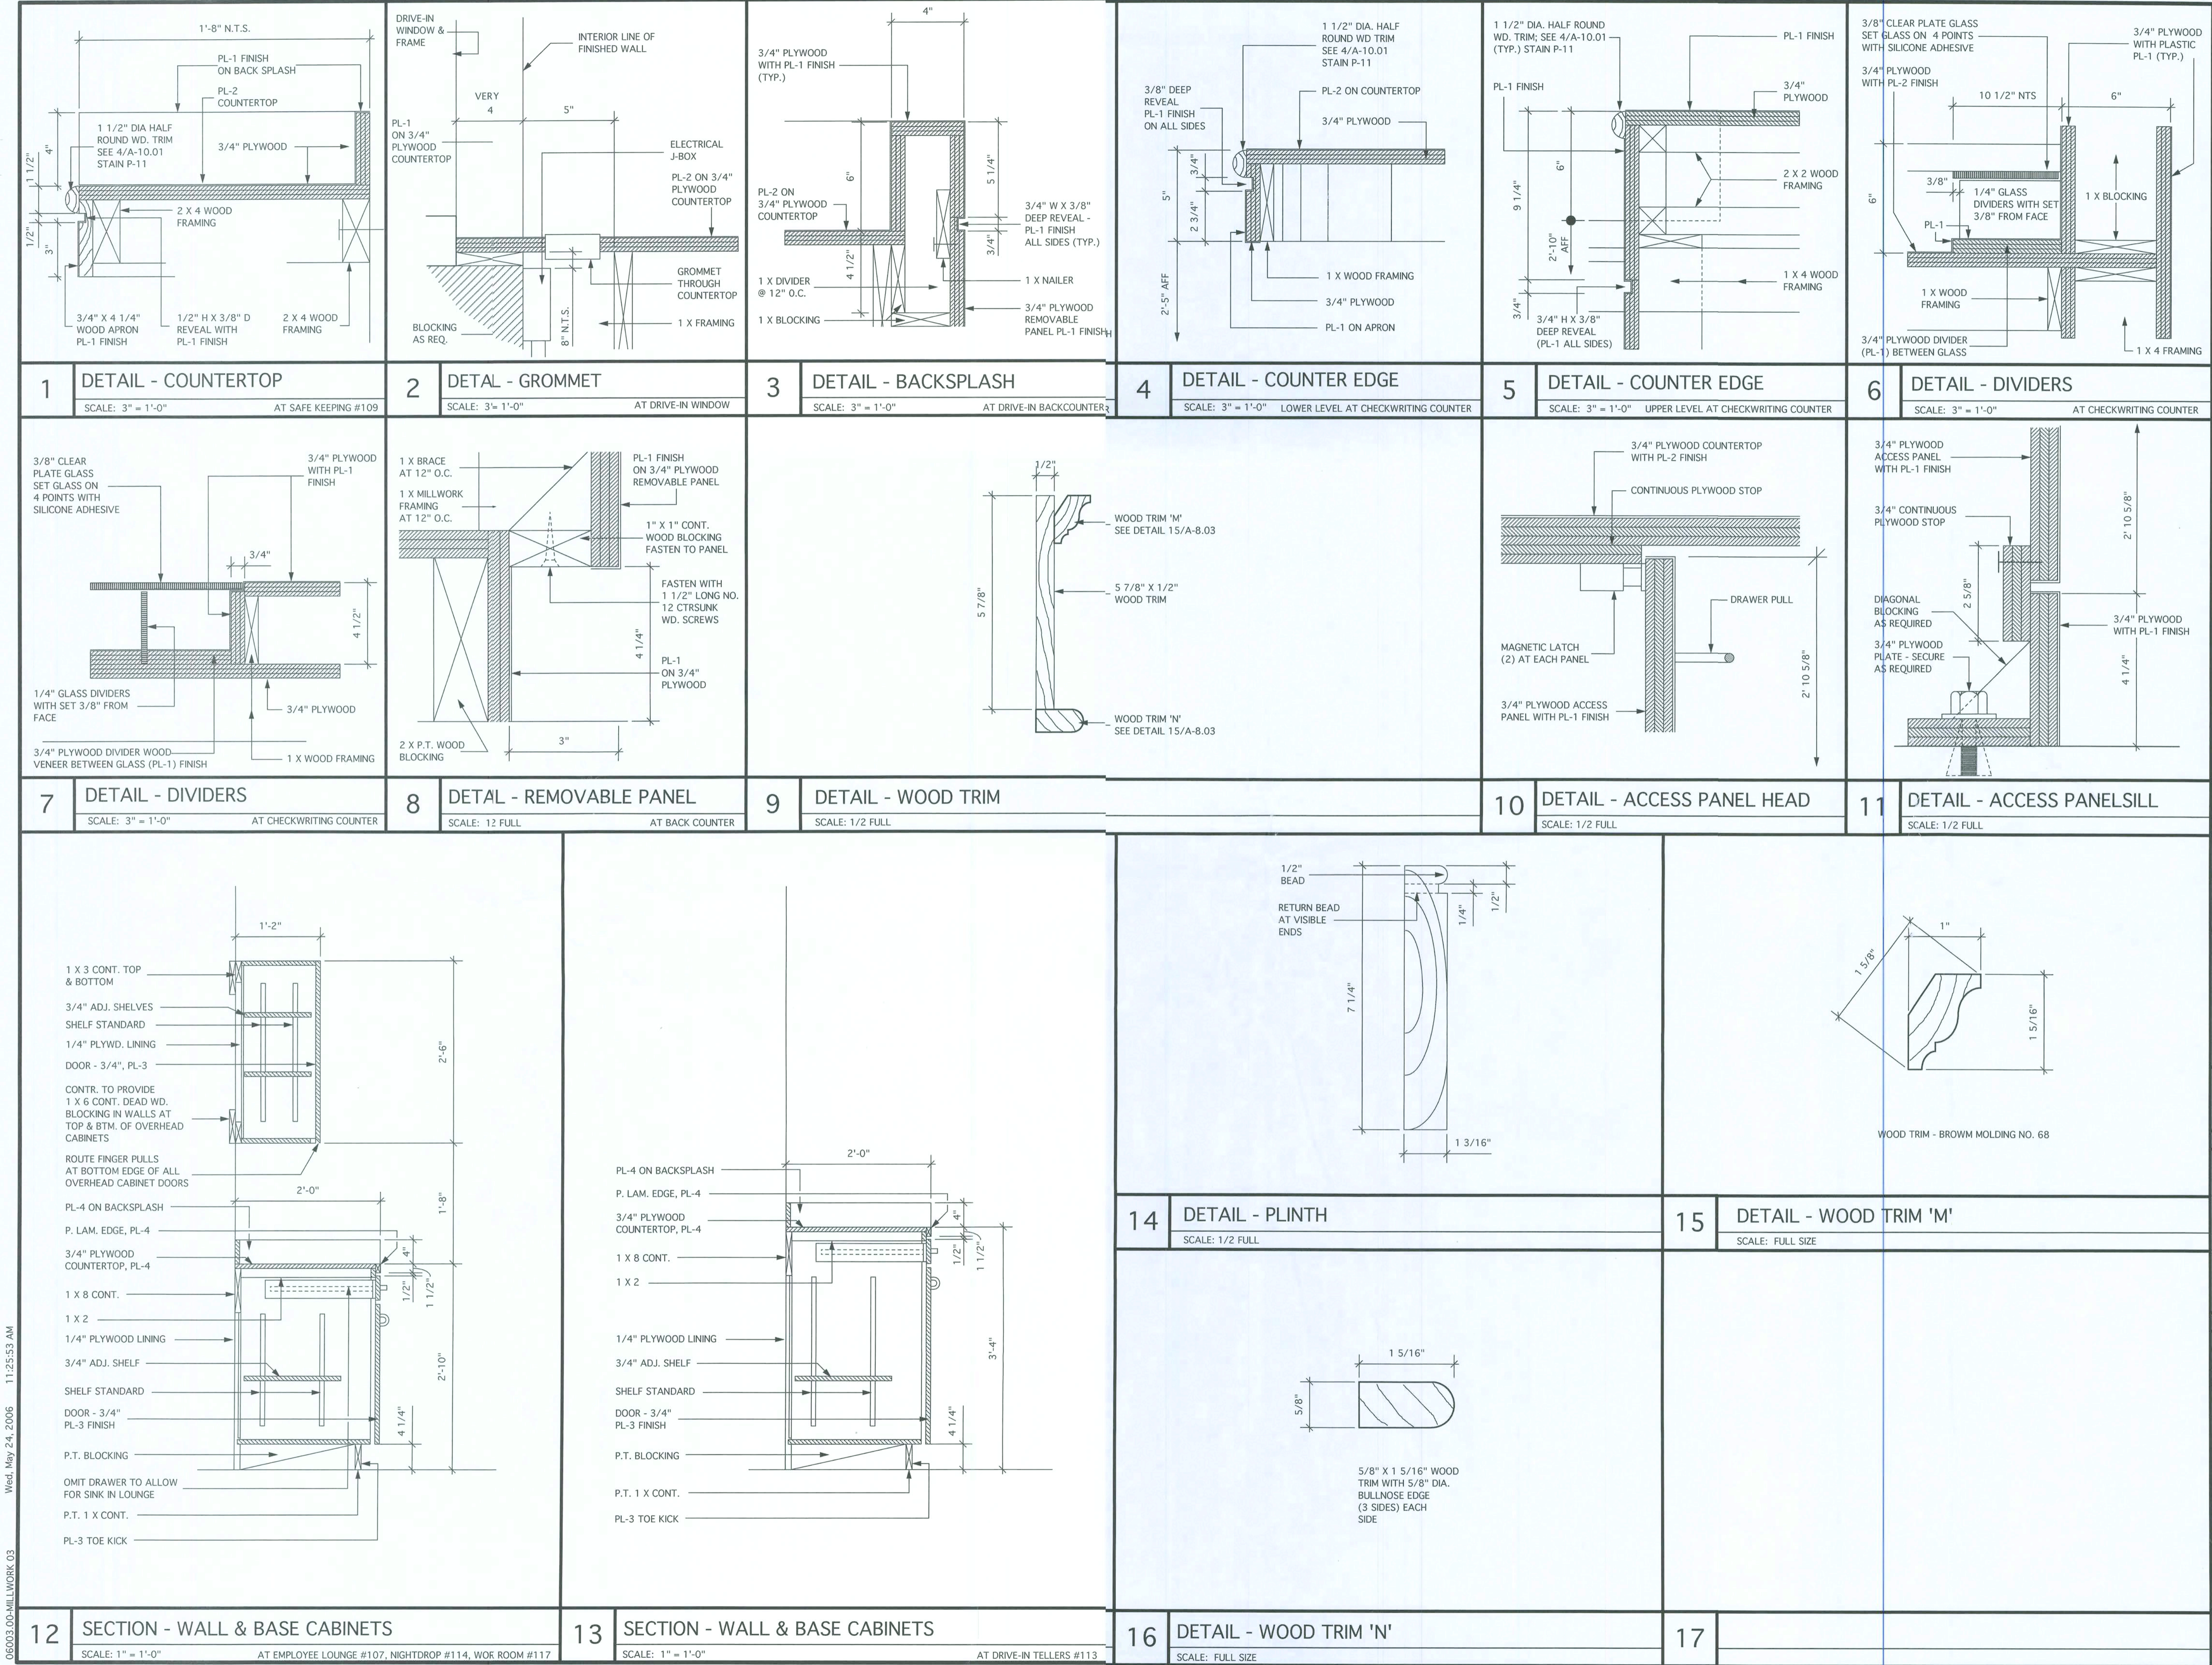EDDIE L. MUSE
JUN 07 2006
LICENSE NO. AR-12112
SHEET NUMBER
A-10.01





DSI
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INTERIOR DESIGN
SPACE PLANNING


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TELEPHONE (407) 629-5755
LICENSE NO. F00061
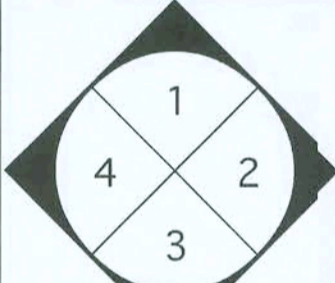
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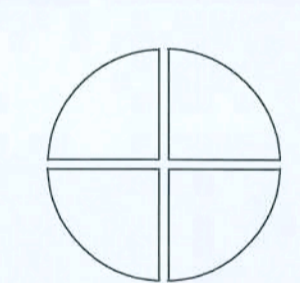
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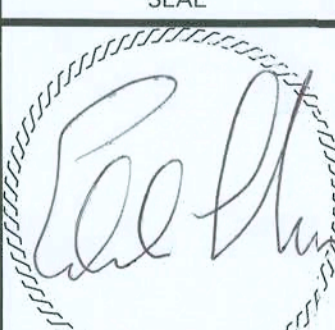





NORTH
ACTUAL
PLAN

MARK	DATE	REVISIONS

COMM. NO:	06003.00	DRAWN:	KLP
DATE:	02/15/06	CHECKED:	ELM
SCALE:	AS NOTED		
FILE:	06003.00-MILLWORK 03		

MILLWORK DETAILS

SEAL	ARCHITECT/CONSULTANT
	EDDIE L. MUSE JUN 07 2006 LICENSE NO. AR-12112 SHEET NUMBER A-10.03

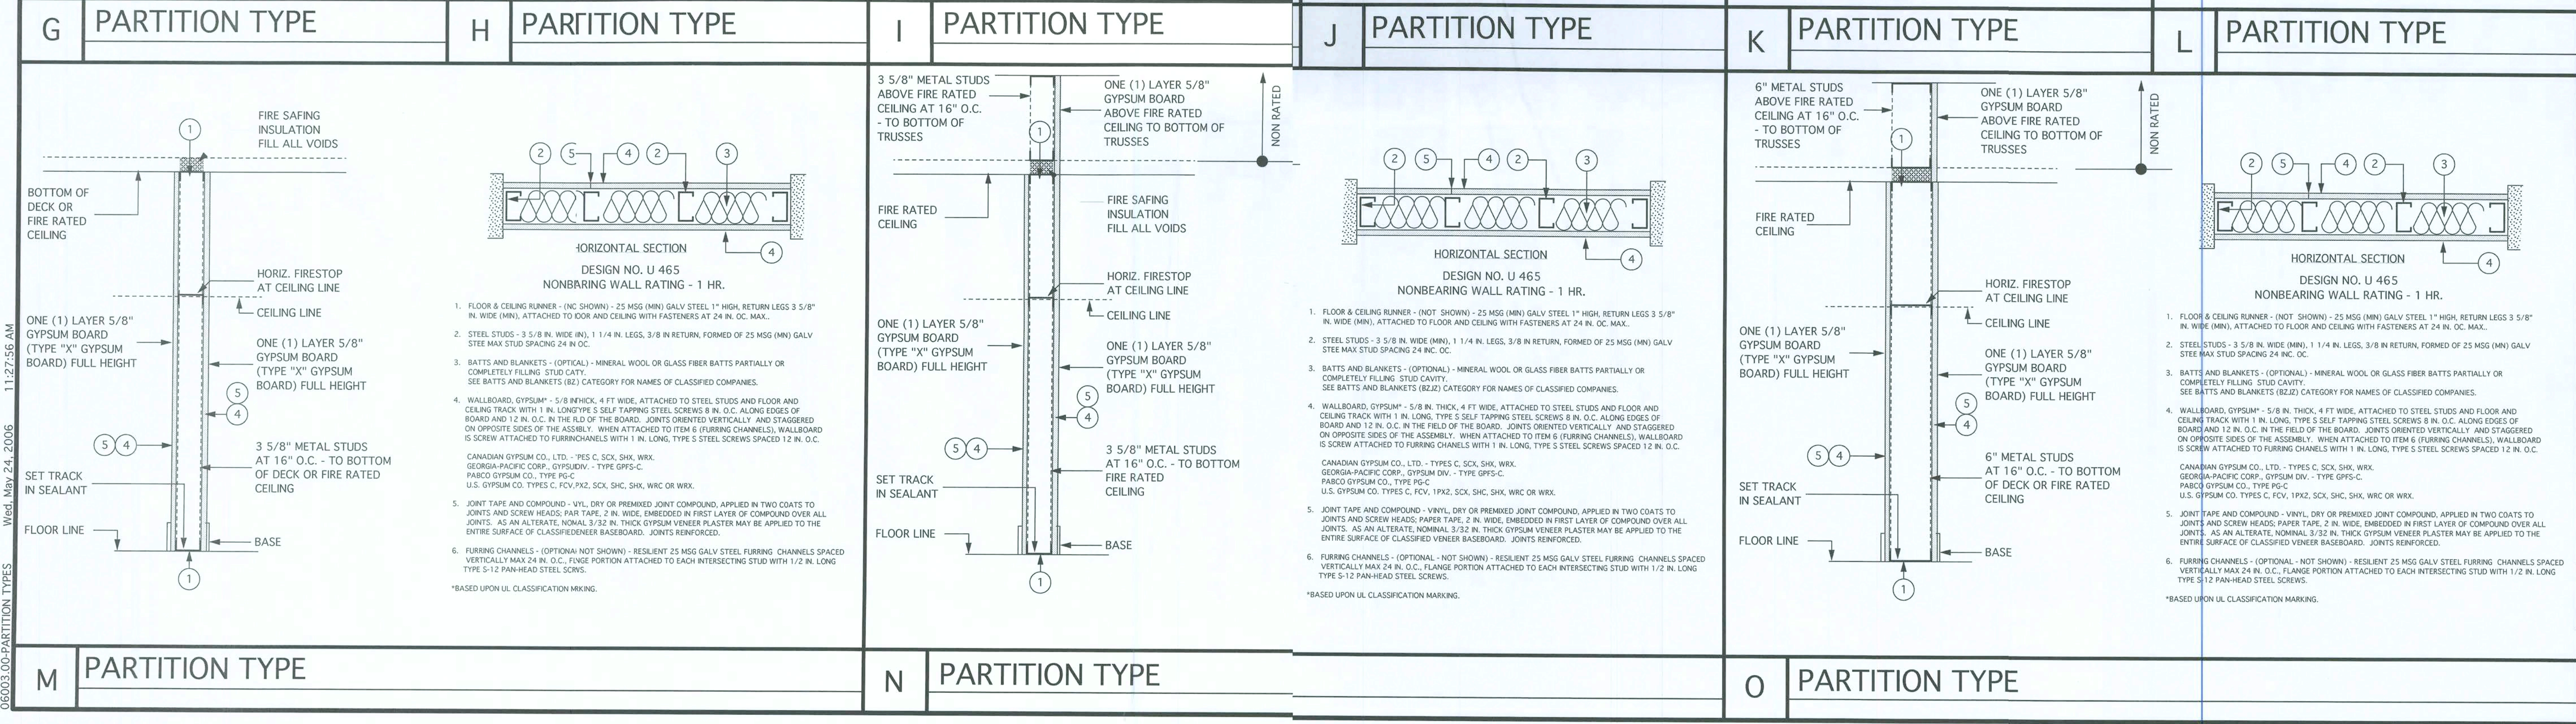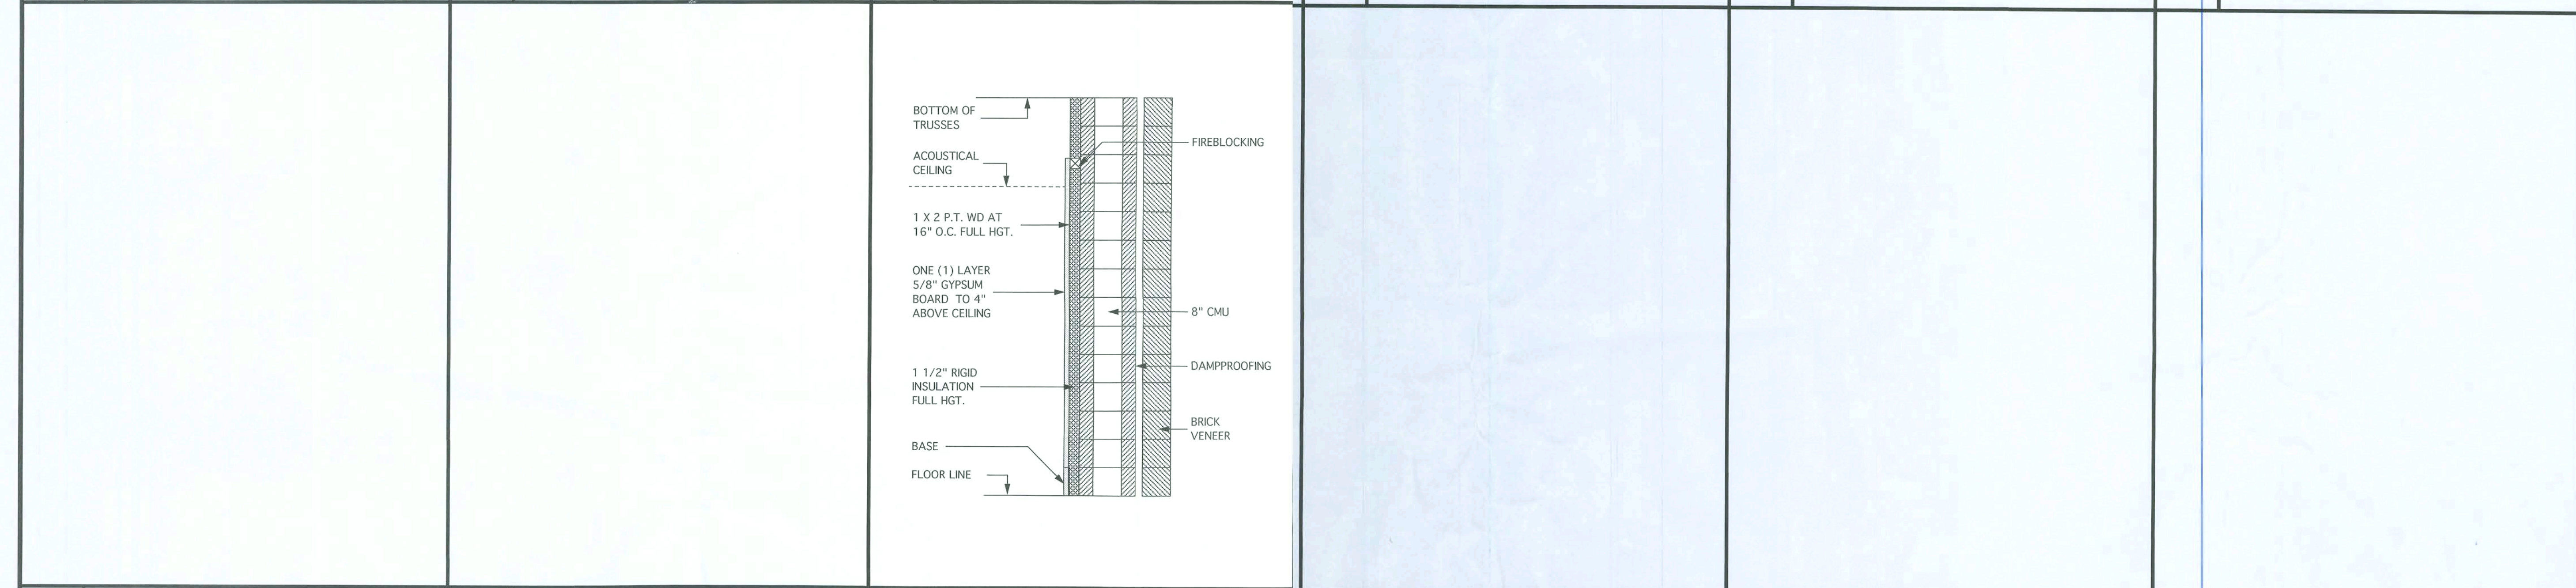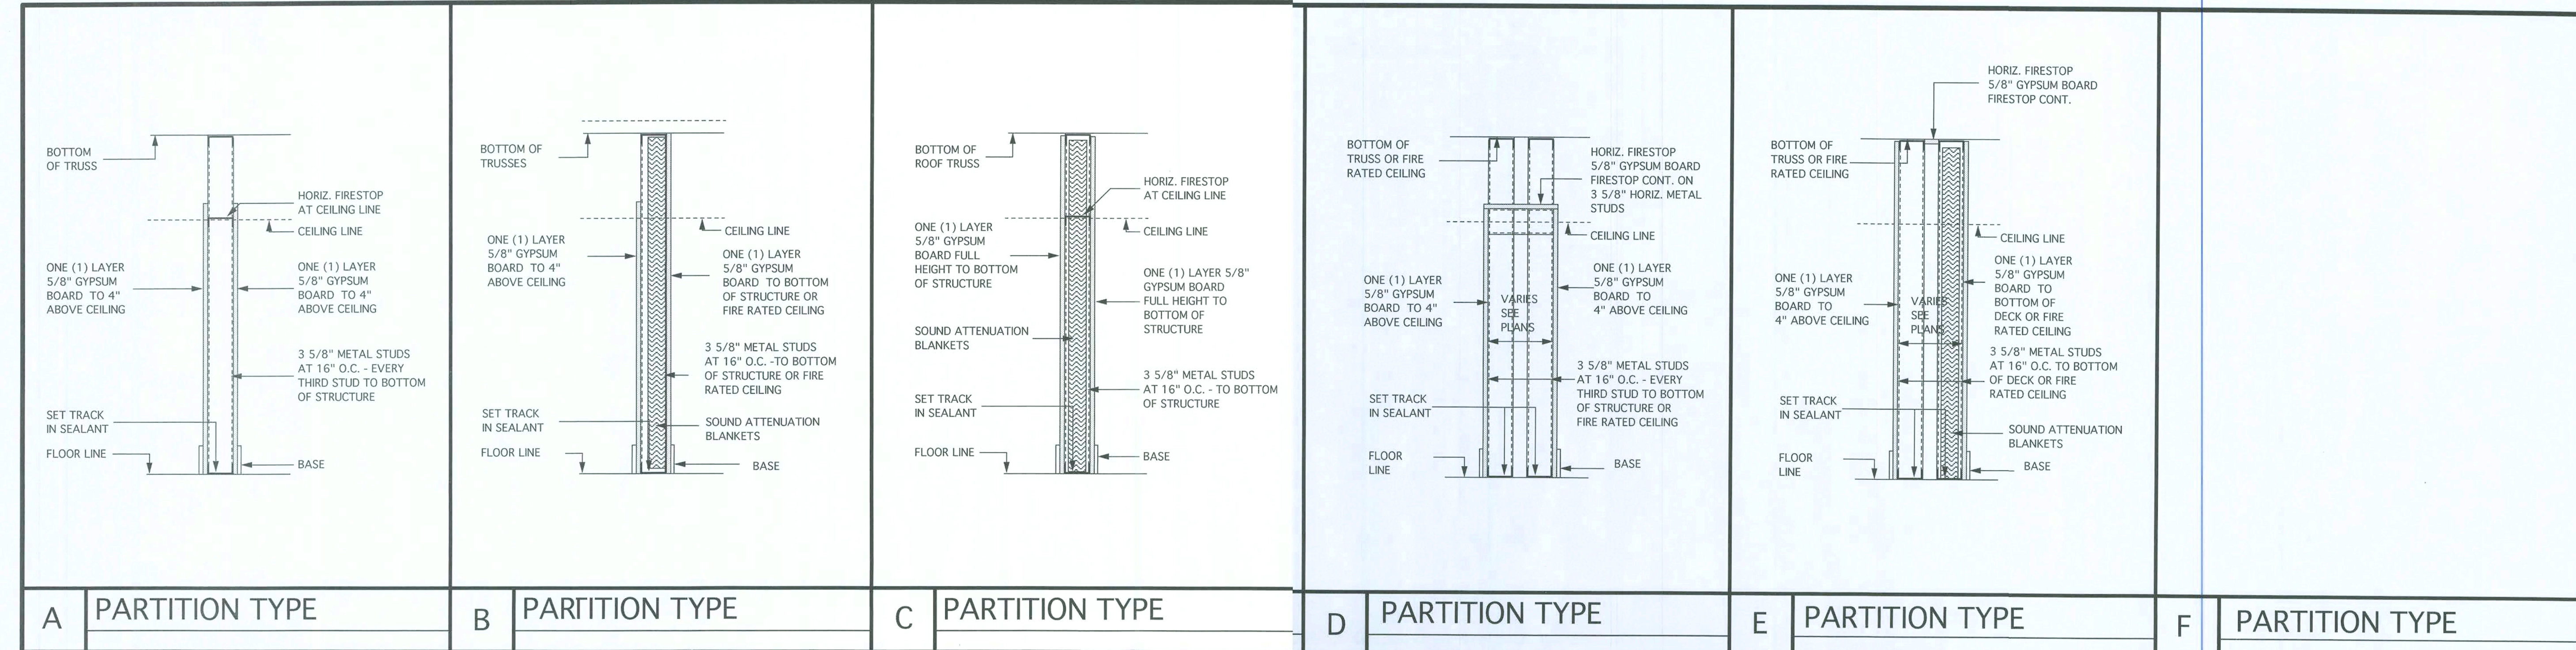

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NORTH
ACTUAL
PLAN

MARK	DATE	REVISIONS


COMM. NO.	06003.00	DRAWN:	KLP
DATE:	02/15/06	CHECKED:	ELM
SCALE:	NO SCALE		
FILE:	06003.00-PARTITION TYPES		

PARTITION TYPES

SEAL	ARCHITECT/CONSULTANT
	EDDIE L. MUSE
	JUN 07 2006
	LICENSE NO. AR-12112
	SHEET NUMBER

A-11.00

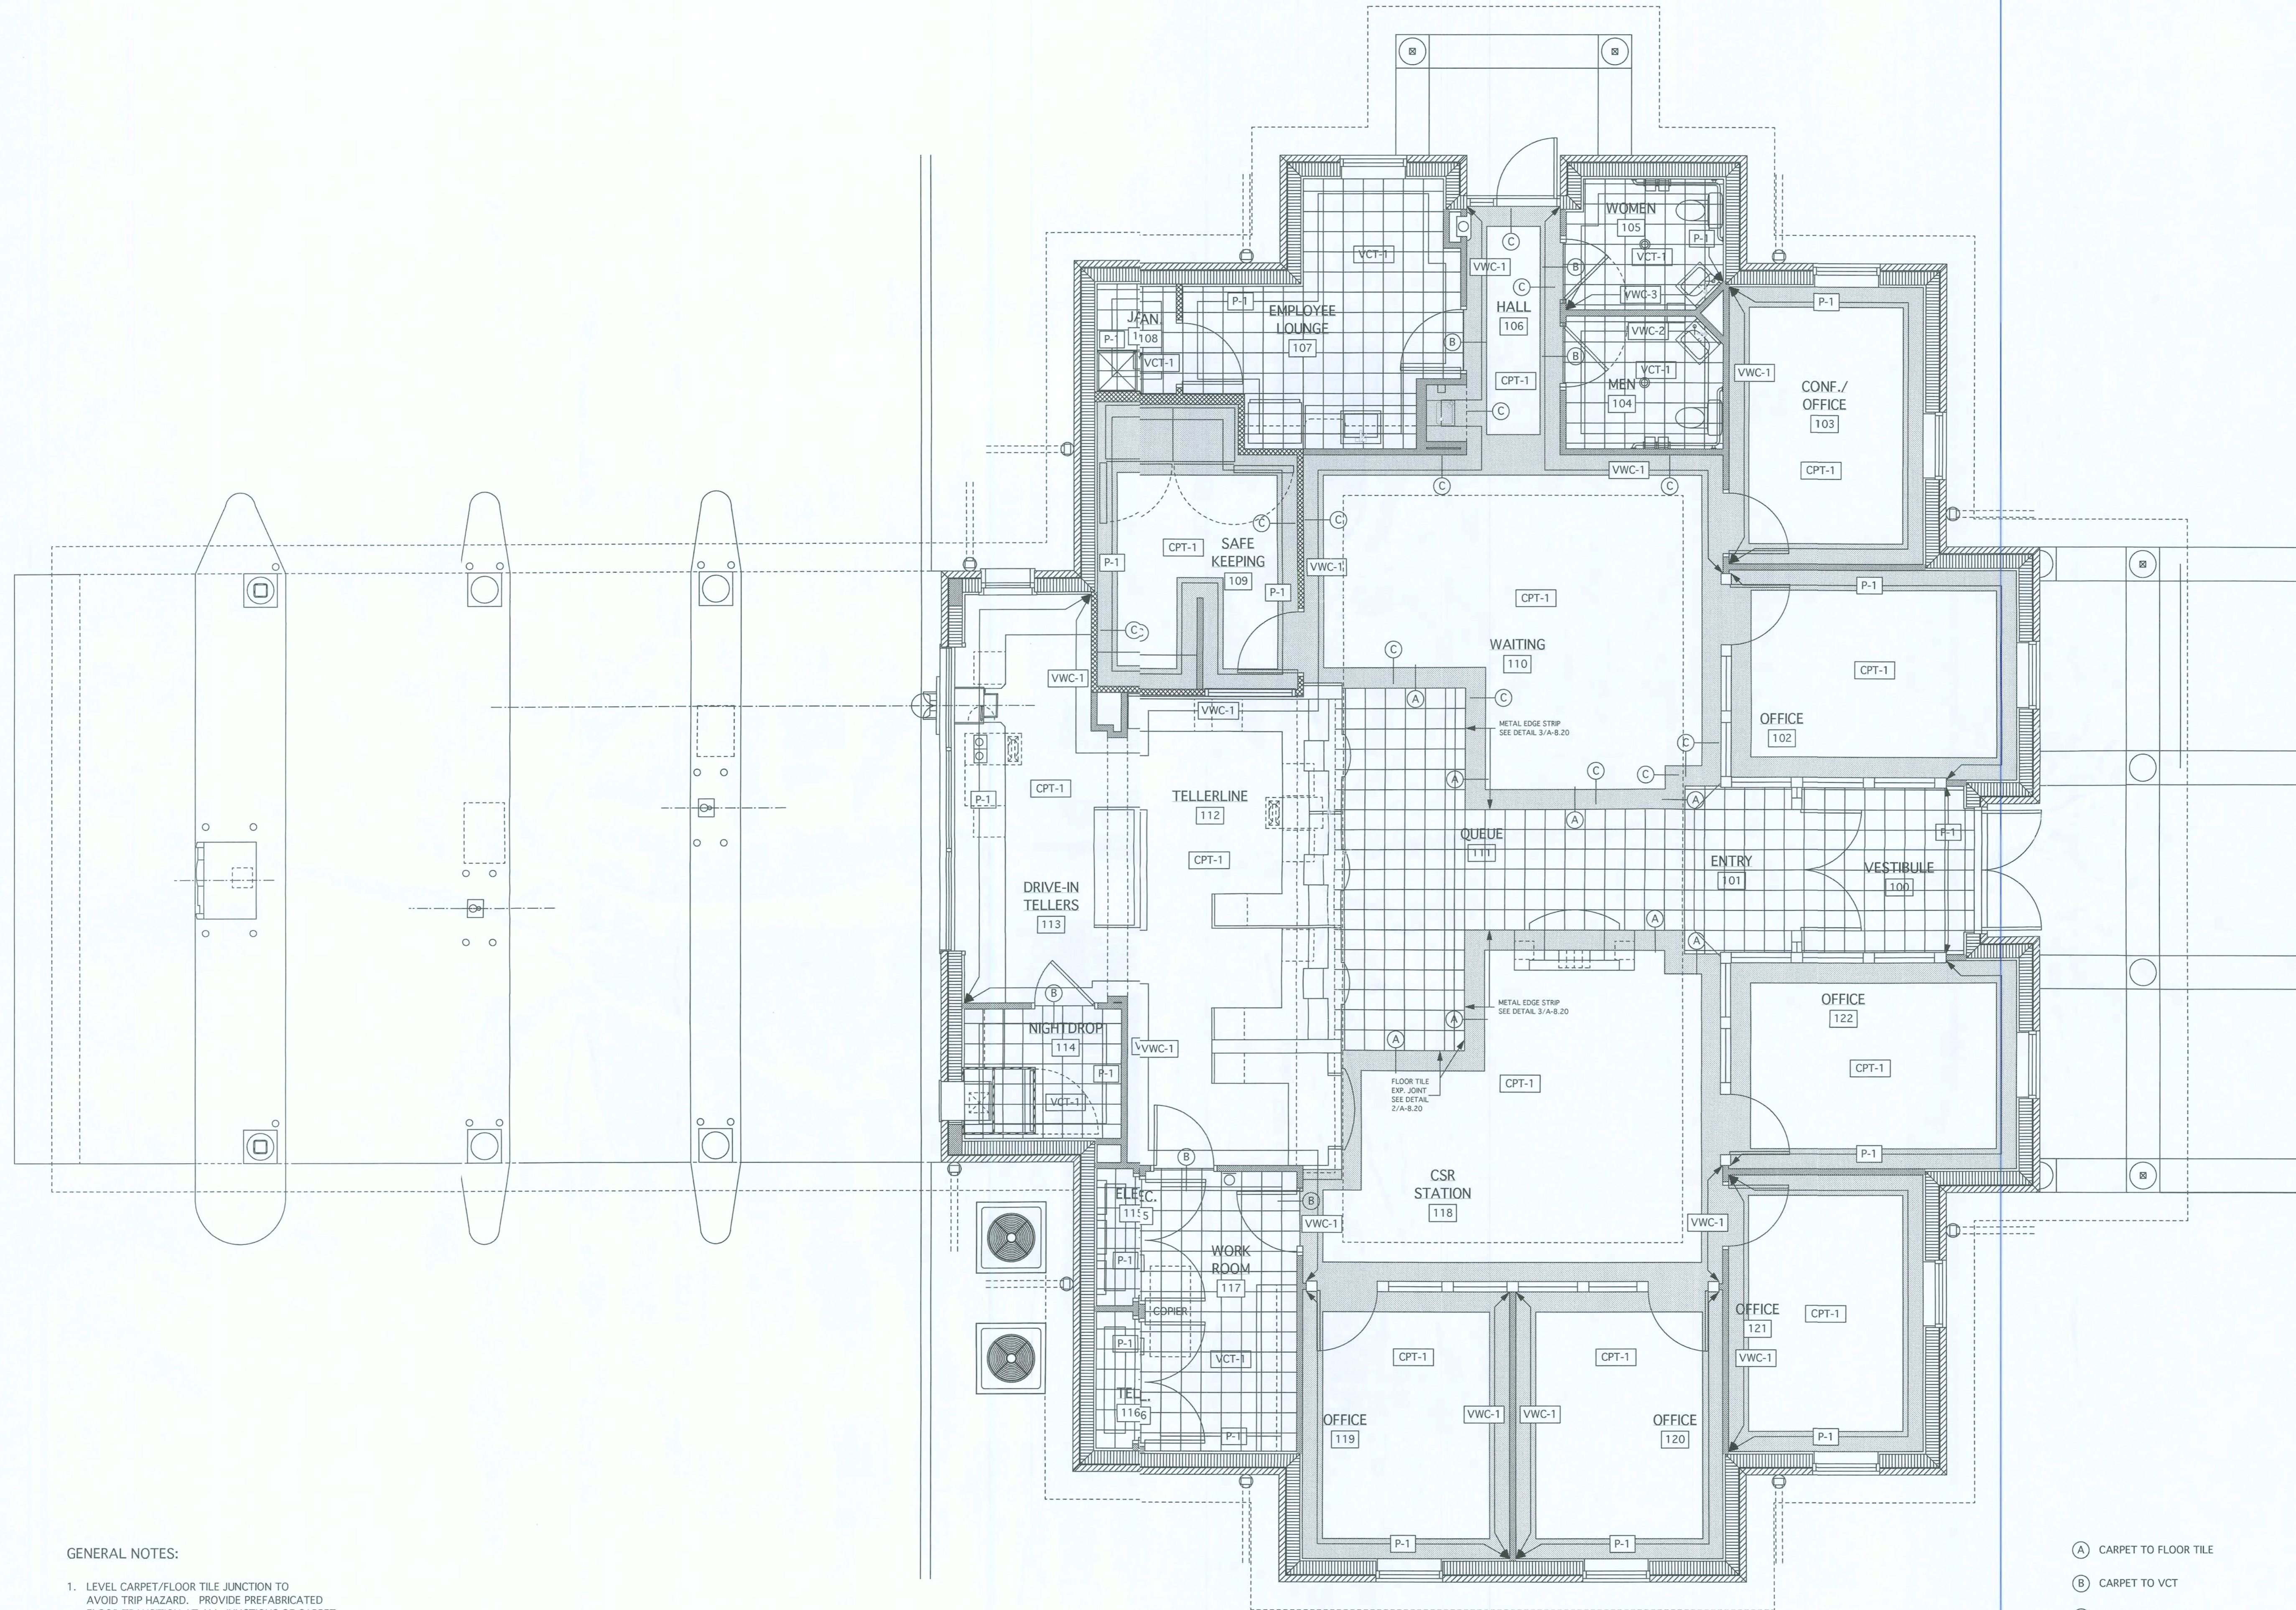06003.00-PARTITION TYPES Wed May 24, 2006 11:27:56 AM



GENERAL NOTES:

1. LEVEL CARPET/FLOOR TILE JUNCTION TO AVOID TRIP HAZARD. PROVIDE PREFABRICATED FLOOR TRANSITION AT ALL JUNCTIONS OF CARPET AND FLOOR TILE.

FINISH PLAN

SCALE: 1/4" = 1'-0"

- (A) CARPET TO FLOOR TILE
- (B) CARPET TO VCT
- (C) CARPET TO CARPET

DSI DESIGN SERVICES INCORPORATED
1778 N. PARK AVE., SUITE 100, MAITLAND, FL 32751,
TELEPHONE (407) 626-5755


ARCHITECTURE
INTERIOR DESIGN
SPACE PLANNING
LICENSE NO. F00061

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LAKE CITY, FLORIDA

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INTERIOR
ELEVATION
KEY


NORTH
— ACTUAL
— PLAN

MARK	DATE	REVISIONS

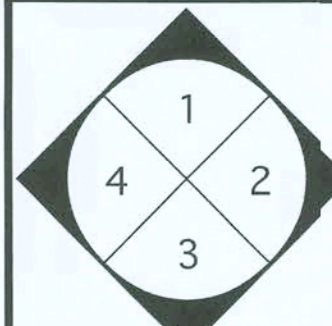COMM. NO:	06003.00	DRAWN:	KLP
DATE:	02/15/06	CHECKED:	ELM
SCALE:	1/4" = 1'-0"	©	2006
FILE:	06003.00FLOOR PLANS 5-1-06.mcd		

FINISH PLAN

SEAL	ARCHITECT/CONSULTANT
	EDDIE L. MUSE
	JUN 07 2006
	LICENSE NO. AR-12112
	SHEET NUMBER
	I-1.10

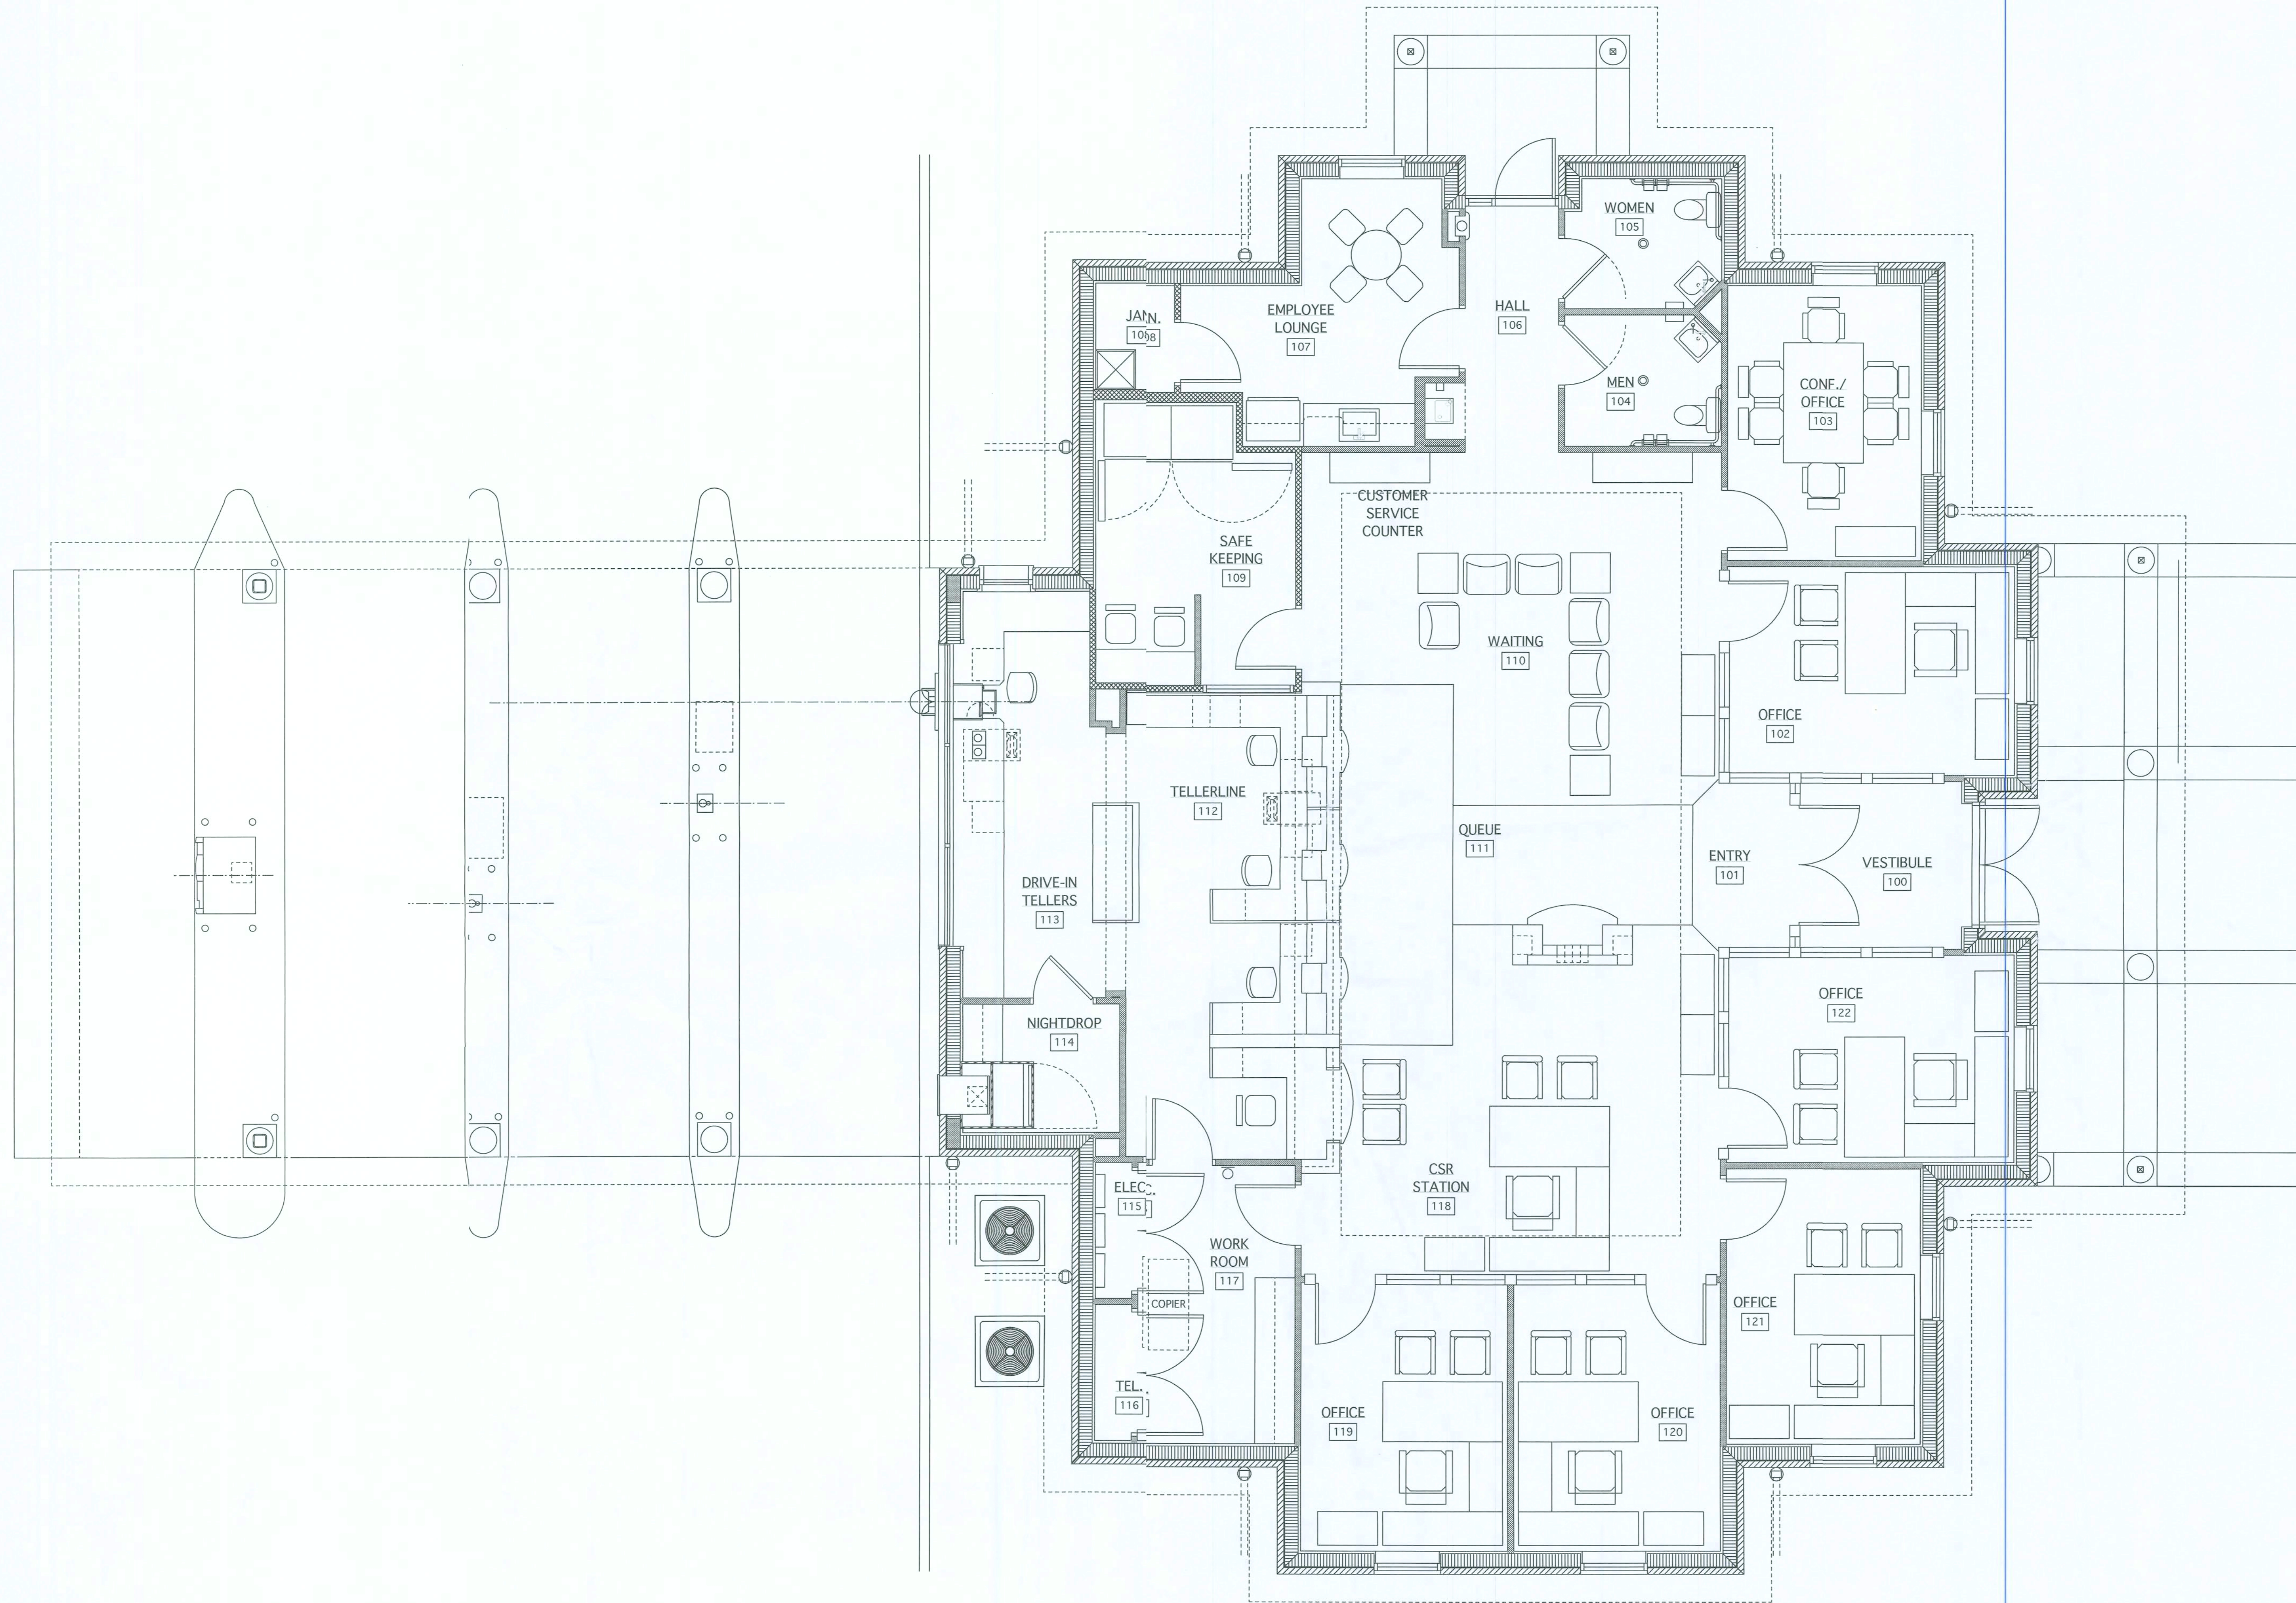

FURNITURE/EQUIPMENT PLAN

SCALE: 1/4" = 1'-0"



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TELEPHONE (407) 626-5755


LICENSE NO. F00061

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INTERIOR
ELEVATION
KEY

NORTH
ACTUAL
PLAN

MARK	DATE	REVISIONS

COMM. NO:	06003.00	DRAWN:	KLP
DATE:	02/15/06	CHECKED:	ELM
SCALE:	1/4" = 1'-0"		© 2006
FILE:	06003.00-FLOOR PLANS S-1-06.mcd		

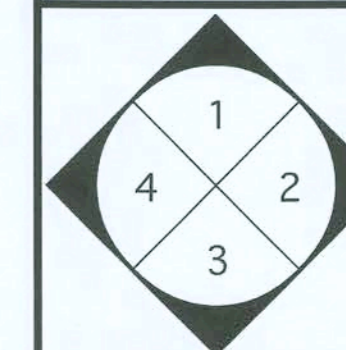FURNITURE/EQUIPMENT
PLAN

SEAL	ARCHITECT/CONSULTANT
	EDDIE L. MUSE
	JUN 07 2006
	LICENSE NO. AR-12112
	SHEET NUMBER
	I-2.10

STRUCTURAL ABBREVIATIONS				STANDARDS				SHALLOW FOUNDATIONS				MASONRY			
AB	ANCHOR BOLT	JST	JOIST	ACI	AMERICAN CONCRETE INSTITUTE	SF-1	SOIL TO BE STRIPPED, COMPACTED AND TESTED IN ACCORDANCE WITH THE RECOMMENDATIONS OF THE SOILS ENGINEER AND PROJECT SPECIFICATIONS.	M-1	MASONRY CONSTRUCTION SHALL CONFORM TO ACI "BUILDING CODE REQUIREMENTS FOR MASONRY STRUCTURES" (ACI/ASCE 530) AND "SPECIFICATIONS FOR MASONRY STRUCTURES" (ASCE 530) EXCEPT AS AMENDED BELOW.						
ACT	ACTUAL	JT	JOINT	AISC	AMERICAN INSTITUTE OF STEEL CONSTRUCTION	SF-2	CENTER ALL FOOTINGS UNDER THEIR RESPECTIVE COLUMNS OR WALLS, UNLESS OTHERWISE SHOWN ON PLANS. MAXIMUM MISPLACEMENT OR ECCENTRICITY - 2". TOLERANCE FOR MISLOCATION OF COLUMN DOWELS OR ANCHOR BOLTS TO BE PER ACI OR AISC STANDARDS.	M-2	STRUCTURE HAS BEEN DESIGNED AS A BEARING WALL STRUCTURE.						
ADDN	ADDITIONAL	k	KIP	AITC	AMERICAN INSTITUTE OF TIMBER CONSTRUCTION	SF-3	HORIZONTAL JOINTS IN FOOTINGS WILL NOT BE PERMITTED.	M-3	USE TYPE "S" MORTAR WITH MINIMUM COMPRESSIVE STRENGTH OF 1800 PSI.						
ADH	ADHESIVE	L-	ANGLE	ANSI	AMERICAN NATIONAL STANDARDS INSTITUTE	SF-4	WHERE VERTICAL CONSTRUCTION JOINTS OCCUR IN CONTINUOUS FOOTINGS, PROVIDE A MINIMUM CONTINUOUS 2x4 KEYWAY ACROSS JOINT FOR EACH 12" OF DEPTH.	M-4	MASONRY UNITS SHALL CONFORM TO ASTM C90 WITH A MINIMUM COMPRESSIVE STRENGTH OF 1900 PSI ON NET SECTION, TO PROVIDE NET AREA COMPRESSIVE STRENGTH OF MASONRY (F'm) OF 1500 PSI.						
ADJ	ADJACENT	LB	POUND	ASTM	AMERICAN SOCIETY OF TESTING AND MATERIALS	SF-5	CONTRACTOR TO NOTIFY ARCHITECT/ENGINEER IF SOIL CONDITIONS ARE UNCOVERED THAT PREVENT THE REQUIRED SOIL BEARING PRESSURE FROM BEING OBTAINED.	M-5	PROVIDE FILLED CELLS AS SHOWN ON PLANS. IN ADDITION, PROVIDE FILLED CELLS ADJACENT TO ALL OPENINGS AND AT ANCHORAGE OF CONNECTIONS.						
AFF	ABOVE FINISHED FLOOR	LG	LONG	AWS	AMERICAN WELDING SOCIETY	SF-6	COORDINATE PLUMBING LINE WITH FOOTING LOCATIONS FOR INTERFERENCE. INDIVIDUAL FOOTINGS SHOULD BE LOWERED WITH THE PRIOR APPROVAL OF THE STRUCTURAL ENGINEER. CONTINUOUS WALL FOOTINGS SHOULD BE STEPPED AS DETAILED ON THE DRAWINGS.	M-6	PROVIDE FULL MORTAR BEDDING AROUND ALL FILLED CELLS WITH VERTICAL REINFORCING.						
AHU	AIR HANDLING UNIT	LL	LIVE LOAD	CRSI	CONCRETE REINFORCING STEEL INSTITUTE	SF-7	EXCAVATING UNDER OR NEAR IN - PLACE FOOTINGS/FOUNDATIONS WHICH DISTURBS THE COMPACTED SOIL BENEATH THE FOOTINGS/ FOUNDATIONS WILL NOT BE PERMITTED.	M-7	REINFORCING FOR FILLED CELLS SHALL CONFORM TO ASTM A615, GRADE 60. PROVIDE THE FOLLOWING LAP SPLICES FOR REINFORCING:						
ALUM	ALUMINUM	LLV	LONG LEG HOIZONTAL	NFPA	NATIONAL FOREST PRODUCTS ASSOCIATION	SF-8	REINFORCING SHALL BE SUPPORTED ON PRECAST PADS. DOWELS FOR COLUMNS AND FILLED CELLS SHALL BE SECURED IN PLACE PRIOR TO POURING CONCRETE. USE TEMPLATES FOR SETTING COLUMN DOWELS AND ANCHOR BOLTS.	M-8	ALL FILLED CELLS AND COLUMNS SHALL BE POURED AT LEAST TWO(2) HOURS PRIOR TO POURING BEAMS AND LINTELS.						
ALT	ALTERNATE	LP	LONG LEG VEITICAL	PCI	PRESTRESSED CONCRETE INSTITUTE			M-9	REINFORCE WALL WITH LADDER TYPE REINFORCEMENT (DUR-O-WALL' OR EQUAL) IN BED JOINTS AT 16" O.C. MEASURED VERTICALLY. LAP SPLICE ALL HORIZONTAL WALL REINFORCING 6'. PROVIDE PREFABRICATED "TEE" OR CORNER SECTIONS AT ALL INTERSECTING WALLS.						
ANCH	ANCHORAGE, ANCHOR	LONG	LONG	PTI	POST TENSIONING INSTITUTE			M-10	REFER TO TYPICAL WALL SECTIONS FOR MAXIMUM CONSTRUCTION HEIGHT OF MASONRY WALLS. PROVIDE CLEAN-OUT HOLES AT BASE OF FILLED CELL WHEN THE CONCRETE POUR EXCEEDS 5 FEET IN HEIGHT.						
APPD	APPROVED	LP	LOW POINT	UL	UNDERWRITER'S LABORATORY			M-11	CONCRETE FOR FILLED CELLS SHALL BE VIBRATED DURING PLACEMENT USING A "PENCIL" TYPE VIBRATOR.						
ARCH	ARCHITECT,(URAL)	LSL	LONG SLOTTET HOLES					M-12	UNLESS NOTED OTHERWISE, PROVIDE THE FOLLOWING LINTELS OVER ALL MASONRY WALL OPENINGS:						
		LT	LIGHT												
B-	CONC. BEAM	LTWT	LIGHTWEIGHT												
B/	BOTTOM OF														
B/B	BACK TO BACK	MAS	MASONRY												
BIT	BITUMINOUS, BITUMASTIC	MAX	MAXIMUM												
BLDG	BUILDING	MB	MACHINE BOL												
BM	BEAM	MECH	MECHANICAL												
BOT	BOTTOM	MET	METAL												
BRDG	BRIDGING	MEZZ	MEZZANINE												
BRG	BEARING	MFR	MANUFACTURR												
BLK	BLOCK	MID	MIDDLE												
BTWN	BETWEEN	MIN	MINIMUM												
BSMT	BASEMENT	MISC	MISCELLANEOIS												
		MJ	MASONRY JOIIT												
		MO	MASONRY OPNING												
C	CHANNEL	N	NORTH												
CANT	CANTILEVER	NIC	NOT IN CONTACT												
CEN	CENTER, ED	NO	NUMBER												
C/C	CENTER TO CENTER	NS	NEAR SIDE												
CHAM	CHAMFER	NTS	NOT TO SCAL												
CIRC	CIRCULAR	O/O	OUT TO OUT												
CJ	CONTROL JOINT	OC	ON CENTER												
CLR	CLEAR	OD	OUTSIDE DIAMTER												
CMU	CONCRETE MASONRY UNITS	OF	OUTSIDE FACE												
COL	COLUMN	OPNG	OPENING												
CONC	CONCRETE	OPP	OPPOSITE												
CONN	CONNECTION	OSL	OUTSTANDINGLEG												
CONST	CONSTRUCTION	OVS	OVERSIZE HOES												
CONT	CONTINUOUS, ATION	PAF	POWDER ACTIATED FASTENER												
CONTR	CONTRACTOR	PL	PLATE												
COORD	COORDINATE, TION	PLF	POUNDS PER INEAL FOOT												
CTRD	CENTERED	PROJ	PROJECTION												
		PSF	POUNDS PER SQUARE FOOT												
		PSI	POUNDS PER SQUARE INCH												
		PT	PRESSURE TRATED												
		PVC	POLYVINYL CHLORIDE												
		R/W	REINFORCED WITH												
		DOWN	RADIUS												
		REF	REFERENCE												
		REINF	REINFORCE, MNT												
		REQ	REQUIRE, D, IENT												
		RET	RETURN												
		REV	REVISION												
		RP	RADIUS POINT												
		RT	RIGHT												
		RTU	ROOF TOP UNT												
		S	SOUTH												
		SA	SLAB BOLSTE												
		SB	SLEEVE ANCHR												
		SCHD	SCHEDULE												
		SECT	SECTION												
		SF-	STEP FOOTING												
		SIM	SIMILAR												
		SPEC	SPECIFICATIONS												
		SP	SPACINGS												
		SQ	SQUARE												
		SSL	SHORT SLOTTD HOLES												
		SS	STAINLESS STEEL												
		STD	STANDARD												
		STIFF	STIFFENERS												
		STL	STEEL												
		STRL	STRUCTURAL												
		SYMM	SYMMETRICAL												
		T	TIES												
		t	THICKNESS												
		T/	TOP OF												
		TB-	TIE BEAM												
		TC	TIE COLUMN												
		T&B	TOP AND BOTOM												
		TEMP	TEMPORARY, EMPERATURE												
		TERM	TERMINATE												
		TOL	TOLERANCE												
		TRAN	TRANSVERSE												
		TS	TUBE STEEL												
		TYP	TYPICAL												
		UNO	UNLESS NOTE OTHERWISE												
		U/S	UNDERSIDE												
		VERT	VERTICAL												
		W	WIDTH, WEST, WDE FLANGE												
		W/	WITH												
		W/O	WITHOUT												
		WF-	WALL FOOTING												
		WP	WORKING POIN												
		WS	WATERSTOP												
		WT	WEIGHT												
		WWF	WELDED WIRE ABRIC												

STANDARDS			
ACI	AMERICAN CONCRETE INSTITUTE		
AISC	AMERICAN INSTITUTE OF STEEL CONSTRUCTION		
AITC	AMERICAN INSTITUTE OF TIMBER CONSTRUCTION		
ANSI	AMERICAN NATIONAL STANDARDS INSTITUTE		
ASTM	AMERICAN SOCIETY OF TESTING AND MATERIALS		
AWS	AMERICAN WELDING SOCIETY		
CRSI	CONCRETE REINFORCING STEEL INSTITUTE		
NFPA	NATIONAL FOREST PRODUCTS ASSOCIATION		
PCI	PRESTRESSED CONCRETE INSTITUTE		
PTI	POST TENSIONING INSTITUTE		
UL	UNDERWRITER'S LABORATORY		

SYMBOLS			
&	AND		
@	AT		
o	CENTERLINE		
o	DIAMETER		
o	ELEVATION		
o	NUMBER, POUNDS		
o	CONSTRUCTION JT.		
o	SAW CUT JOINT		
o	PLATE		

STRUCTURAL DESIGN CRITERIA			
D-1	CODE	-	FLORIDA BUILDING CODE 2004 EDITION.
D-2	DESIGN LIVE LOADS:		
		ROOF	20 PSF
D-3	DESIGN WIND SPEED:	110 MPH	
	IMPORTANCE FACTOR:	1.0	
	BUILDING CATEGORY:	III	
	EXPOSURE:	B	
	INTERNAL PRESURE COEFICIENT:	(+/-) .18	
	COMPONENTS AND CLADDING PRESSURE:	(SEE SHT. S-0.01)	
D-4	SEISMIC:	ZONE 0	
D-5	ALLOWABLE SOIL BEARING PRESSURE 3000 PSF PER REPORT BY:	"CAL-TECH TESTING", DATED APRIL 26, 2006	

GENERAL NOTES			
G-1	THE GENERAL CONTRACTOR SHALL REVIEW ALL PROJECT DOCUMENTS, PRIOR TO FABRICATION AND START OF CONSTRUCTION. REPORT ANY DISCREPANCIES TO ARCHITECT OR STRUCTURAL ENGINEER PRIOR TO PROCEEDING WITH WORK.		
G-2	THE GENERAL CONTRACTOR SHALL PROVIDE ALL MEASURES NECESSARY TO PROTECT THE STRUCTURE AND WORKERS DURING CONSTRUCTION, INCLUDING ADEQUATE BRACING OF STRUCTURAL MEMBERS, WALLS AND OTHER NON-STRUCTURAL ELEMENTS TO WITHSTAND CONSTRUCTION LOADS INCLUDING WIND.		
G-3	GENERAL CONTRACTOR SHALL PROTECT EXISTING FACILITIES, STRUCTURES AND UTILITY LINES FROM ALL DAMAGE DURING CONSTRUCTION.		
G-4	NO STRUCTURAL MEMBER SHALL BE CUT, NOTCHED OR OTHERWISE REDUCED IN SIZE OR STRENGTH WITHOUT PRIOR APPROVAL IN WRITING FROM THE STRUCTURAL ENGINEER.		
G-5	THE GENERAL CONTRACTOR SHALL COORDINATE STRUCTURAL AND) OTHER DRAWINGS WHICH ARE PART OF THE CONTRACT DOCUMENTS FOR ANCHORED, EMBEDDED OR SUPPORTED ITEMS WHICH MAY AFFECT THE STRUCTURAL DRAWINGS.		
G-6	ALL DETAILS AND SECTIONS ON THE DRAWINGS ARE INTENDED TO BE TYPICAL AND SHALL BE CONSTRUED TO APPLY TO ANY SIMILAR SITUATION ELSEWHERE ON THE PROJECT EXCEPT WHERE A SEPARATE DETAIL IS SHOWN.		
G-7	THE INTENTION OF THE PLANS AND SPECIFICATIONS IS TO PROVIDE ALL NECESSARY DETAILS TO CONSTRUCT A COMPLETE STRUCTURE. WHEN SPECIFIC INFORMATION IS MISSING OR IS IN CONFLICT, THE CONTRACTOR SHALL USE A SIMILAR DETAIL AND/OR THE MORE COSTLY ITEM OF CONFLICT. THE CONFLICTS SHALL BE BROUGHT TO THE ATTENTION OF THE ARCHITECT/ENGINEER.		
G-8	REPRODUCTION OF THE CONTRACT DOCUMENTS USED FOR THE PREPARATION AND SUBMITTAL OF SHOP DRAWINGS WILL NOT BE PERMITTED. REPRODUCED DRAWINGS WILL BE RETURNED UNCHECKED FOR RESUBMITTAL.		
G-9	THE GENERAL CONTRACTOR SHALL REVIEW ALL SHOP DRAWINGS FOR CONFORMANCE WITH THE CONTRACT DOCUMENTS, COMPLETENESS AND SHALL ANSWER ALL CONTRACTOR RELATED QUESTIONS. GENERAL CONTRACTOR SHALL STAMP AND INITIAL ALL SHEETS PRIOR TO SUBMITTING SHOP DRAWINGS TO ARCHITECT/ENGINEER FOR REVIEW. NON-COMPLIANCE WITH THIS REQUIREMENT WILL RESULT IN REJECTION OF SUBMITTAL.		
G-10	ALL SHOP DRAWINGS SHALL CONSIST OF 4 BLUE LINES, ALL OTHER SETS OF BLUE LINES WILL BE DISCARDED.		

REINFORCED CONCRETE			
RC-1	ALL CONCRETE DESIGN AND PLACEMENT SHALL BE IN STRICT ACCORDANCE WITH THE ACI "BUILDING CODE REQUIREMENTS FOR REINFORCED CONCRETE", ACI 318.		
RC-2	STRUCTURAL CONCRETE SHALL CONFORM TO ACI 301 SPECIFICATIONS AND SHALL DEVELOP A MINIMUM COMPRESSIVE STRENGTH OF 3000 PSI AT 28 DAYS.		
RC-3	USE REGULAR WEIGHT CONCRETE.		
RC-4	STRUCTURAL CONCRETE SHALL CONFORM TO ACI 301 AND HAVE THE FOLLOWING SLUMPS & AGGREGATE REQUIREMENTS:		
	LOCATION	SLUMP	MAX. AGGREGATE
	FOOTINGS	4' ± 1'	ASTM #57
	COLUMNS	5' ± 1'	ASTM #57
	BEAMS AND SLABS	5' ± 1'	ASTM #57
	FILLED CELLS	8' ± 1'	ASTM #89 PEAROCK
	FLYASH MAYBE SUBSTITUTED FOR CEMENT AT A MAXIMUM OF 20% (PERCENT) OF THE TOTAL CEMENT CONTENT. DO NOT USE FLYASH IN FILLED CELL CONCRETE.		
RC-5	THE USE OF JITTERBUGS TO CONSOLIDATE CONCRETE WILL NOT BE PERMITTED.		
RC-6	ALL PUMPED CONCRETE WITH #57 AGGREGATE IS TO CONTAIN A HIGH RANGE WATER REDUCING AGENT. MINIMUM SIZE OF DISCHARGE TO BE 4" I.D. SEE SPECIFICATIONS FOR REQUIRED MIX DESIGN. A 2" I.D. DISCHARGE MAY BE USED WITH #89 AGGREGATE.		
RC-7	ALL REINFORCING STEEL SHALL BE DETAILED, FABRICATED AND INSTALLED IN ACCORDANCE WITH ACI 318 AND ACI DETAILING MANUAL, ACI-315 LATEST EDITION.		
RC-8	REINFORCING STEEL SHALL BE NEW DEFORMED BARS, FREE FROM RUST, SCALE AND OIL, CONFORMING TO ASTM A-615, GRADE 60, WITH MINIMUM YIELD STRENGTH = 60,000 PSI.		
RC-9	ALL SLABS ON GRADE SHALL BE REINFORCED WITH POLYPROPYLENE FIBERS IN ACCORDANCE WITH MANUFACTURER'S WRITTEN RECOMMENDATIONS AND SPECIFICATIONS.		
RC-10	PROVIDE THE FOLLOWING CONCRETE COVERAGES OVER REINFORCING:		
	FOOTINGS	BOTTOMS & UNFORMED EDGES	3' CLR
	BEAMS & COLS.	TIES	1-1/2' CLR
RC-11	SHOP DRAWINGS FOR PLACEMENT SHALL BE SUBMITTED FOR REVIEW PRIOR TO REBAR FABRICATION.		
RC-12	NO REINFORCING BARS SHALL BE CUT TO ACCOMMODATE THE INSTALLATION OF ANCHORS, EMBEDS OR OTHER ITEMS.		
RC-13	USE THE STRUCTURAL DRAWINGS(INCLUDING REVISIONS AND ADDENDA) IN CONJUNCTION WITH REVIEWED SHOP DRAWINGS FOR PLACEMENT OF REINFORCING.		
RC-14	AT CHANGES IN DIRECTION OF BLOCK BEAMS & STRIP FOOTINGS, PROVIDE CORNER BARS OF SAME SIZE AND QUANTITY(U.N.D.) AS HORIZONTAL STEEL. REFER TO TYPICAL DETAIL.		
RC-15	ALL EMBEDDED ITEMS SHALL BE SECURELY TIED IN PLACE PRIOR TO CONCRETE PLACEMENT.		
RC-16	EXPANSION BOLTS SHALL BE HILTI KWIK BOLTS OR APPROVED EQUIVALENT, INSTALLED IN ACCORDANCE WITH MANUFACTURER'S RECOMMENDATIONS.		

MASONRY			
M-1	MASONRY CONSTRUCTION SHALL CONFORM TO ACI "BUILDING CODE REQUIREMENTS FOR MASONRY STRUCTURES" (ACI/ASCE 530) AND "SPECIFICATIONS FOR MASONRY STRUCTURES" (ASCE 530) EXCEPT AS AMENDED BELOW.		
M-2	STRUCTURE HAS BEEN DESIGNED AS A BEARING WALL STRUCTURE.		
M-3	USE TYPE "S" MORTAR WITH MINIMUM COMPRESSIVE STRENGTH OF 1800 PSI.		
M-4	MASONRY UNITS SHALL CONFORM TO ASTM C90 WITH A MINIMUM COMPRESSIVE STRENGTH OF 1900 PSI ON NET SECTION, TO PROVIDE NET AREA COMPRESSIVE STRENGTH OF MASONRY (F'm) OF 1500 PSI.		
M-5	PROVIDE FILLED CELLS AS SHOWN ON PLANS. IN ADDITION, PROVIDE FILLED CELLS ADJACENT TO ALL OPENINGS AND AT ANCHORAGE OF CONNECTIONS.		
M-6	PROVIDE FULL MORTAR BEDDING AROUND ALL FILLED CELLS WITH VERTICAL REINFORCING.		
M-7	REINFORCING FOR FILLED CELLS SHALL CONFORM TO ASTM A615, GRADE 60. PROVIDE THE FOLLOWING LAP SPLICES FOR REINFORCING:		
	#5 BARS	32'	
M-8	ALL FILLED CELLS AND COLUMNS SHALL BE POURED AT LEAST TWO(2) HOURS PRIOR TO POURING BEAMS AND LINTELS.		
M-9	REINFORCE WALL WITH LADDER TYPE REINFORCEMENT (DUR-O-WALL' OR EQUAL) IN BED JOINTS AT 16" O.C. MEASURED VERTICALLY. LAP SPLICE ALL HORIZONTAL WALL REINFORCING 6'. PROVIDE PREFABRICATED "TEE" OR CORNER SECTIONS AT ALL INTERSECTING WALLS.		
M-10	REFER TO TYPICAL WALL SECTIONS FOR MAXIMUM CONSTRUCTION HEIGHT OF MASONRY WALLS. PROVIDE CLEAN-OUT HOLES AT BASE OF FILLED CELL WHEN THE CONCRETE POUR EXCEEDS 5 FEET IN HEIGHT.		
M-11	CONCRETE FOR FILLED CELLS SHALL BE VIBRATED DURING PLACEMENT USING A "PENCIL" TYPE VIBRATOR.		
M-12	UNLESS NOTED OTHERWISE, PROVIDE THE FOLLOWING LINTELS OVER ALL MASONRY WALL OPENINGS:		
	1. OPENING LESS THAN OR EQUAL TO 6'-0": 8" PRECAST CONCRETE "U" LINTEL R/W 2-#5 FILLED SOLID WITH CONCRETE. EXTEND REINFORCING 8" PAST OPENING FACE.		
	2. OPENING GREATER THAN 6'-0" & LESS THAN 10'-0": 8" PRECAST CONC. "U" LINTEL & 8" KNOCK-OUT COURSE R/W 2-#5 EA. COURSE FILLED SOLID W/CONCRETE. EXTEND REINFORCING 8" PAST OPENING.		

STRUCTURAL STEEL

- S-1 FABRICATION AND ERECTION IF STRUCTURAL STEEL SHALL CONFORM TO THE AISC "MANUAL OF STEEL CONSTRUCTION", NINTH EDITION AND THE AISC "SPECIFICATION FOR STRUCTURAL STEEL BUILDINGS", 1989 EDITION.
- S-2 ALL STRUCTURAL STEEL TO CONFORM TO ASTM A-572 WITH MINIMUM YIELD STRENGTH OF 50 KSI. MISCELLANEOUS STEEL SHALL ONFORM TO ASTM A-36 WITH A MINIMUM YIELD STRENGTH OF 36 KSI.
- S-3 STRUCTURAL TUBES SHALL CONFORM TO ASTM A-441 WITH MINMUM YIELD STRNGTH OF 46 KSI.
- S-4 ALL HIGH-STRENGTH BOLTS SHALL MEET THE REQUIREMENTS O THE "SPECIFICATION FOR STRUCTURAL JOINTS USING ASTM A325 IR A490 BOLTS".
- S-5 UNLESS NOTED OTHERWISE, ALL BOLTS SHALL BE 3/4" DIAMEER A325 AND SHALL BE BEARING TYPE CONNECTIONS.
- S-6 ALL BOLTS CAST IN CONCRETE SHALL CONFORM TO ASTM A-36OR A-307.
- S-7 ALL SHOP AND FIELD WELDING SHALL BE DONE BY CURRENTLY CERTIFIED WELDERS IN ACCORDANCE WITH AWS D1.1 "STRUCTURAL WELDING CODE" LATEST EDITION.
- S-8 USE E70XX ELECTRODES FOR ALL WELDING, UNLESS NOTED OTHERWISE. (GRIND SMOOTH ALL EXPOSED WELDS.)
- S-9 SUBMIT STRUCTURAL STEEL SHOP DRAWINGS FOR REVIEW PRIOR TO FABRICATION. CLEARLY SHOW ALL PICE MARKS, CONNECTIONS, AND ERECTION DRAWINGS. ANY SPLICES NOT SHOWN ON CONTRACT DRAWINGS ARE TO BE CLEARLY NOTED FOR APPROVAL.

PRE-ENGINEERED WOOD TRUSSES

- WT-1 DESIGN OF METAL CONNECTED ROOF TRUSSES TO COMPLY WITH APPLICABLE BUILDING CODE (SEE NOTE D-1/SO.00)
- NFPA'S "NATIONAL DESIGN SPECIFICATION FOR STRSS GRADED LUMBER AND ITS FASTENINGS".
- TRUSS PLATE INSTITUTE'S "DESIGN SPECIFICATION FOR LIGHT METAL PLATE CONNECTED FLOOR TRUSSES".
- WT-2 PRE-ENGINEERED PRE-FABRICATED WOOD TRUSSES AND THEIR CONNECTIONS TO EACH OTHER SHALL BE DESIGNED FOR THE LIADS INDICATED IN NOTE WT-8 BY A PROFESSIONAL ENGINEER REGISTERED IN THE STATE OF FLORIDA.
- WT-3 SIGNED AND SEALED SHOP DRAWINGS SHOWING TRUSS CONFIGUATION WITH MEMBER SIZES AND CONNECTIONS, TRUSS LAYOUT WITH PICE MARKS, REQUIRED TRUSS TO TRUSS CONNECTIONS, DESIGN LOADS, DURATION FACTORS AND ERECTION DETAILS MUST BE SUBMITTED FOR REVIEW PRIOR TO FABRICATION. IF REQ., SUBMIT COPIES O THE BUILDING DEPARTMENT AT TIME OF PERMITTING.
- WT-4 PRE-FABRICATED WOOD TRUSSES SHALL BE FABRICATED FROM SOUTHERN PINE(SPIB) KILN DRIED #2 OR BETTER FOR CHORD AND #3 GRADE OR BETTER FOR WEBS.
- WT-5 NO WANE, SKIPS OR OTHER DEFECTS SHALL OCCUR IN THE PLATE CONTACT AREA OR SCARFED AREA OF WEB MEMBERS. PLATES SHALL BE CONNECTED WITH ONE REQUIRED EACH SIDE OF TRUSS.
- WT-6 NUMBER OF PANELS AND DIRECTION OF WEB MEMBERS TO SUIT CONTINUOUS OR SIMPLE SPAN TRUSS DESIGN REQUIREMENTS. SEE STRUCTURAL AND ARCHITECTURAL DRAWINGS FOR OUTLINE SHAPE AND ANY SPECIAL CONDITIONS/LOCATIONS OF PANEL POINTS.
- WT-7 PERMANENT TRUSS BRACING OR BRIDGING MEMBERS SHALL BE 2x4 MINIMUM SOUTHERN PINE WITH MINIMUM LOCATIONS AS NOTED IN WT-10. ADDITIONAL BRACING REQUIRED TO STRENGTHEN TRUS COMPONENTS SHOULD BE NOTED ON THE ERECTION DRAWINGS I ACCORDANCE WITH TRUSS MANUFACTURER'S RECOMMENDATIONS.
- WT-8 TRUSS DESIGN LOADS AS FOLLOWS:

SLOPED TOP CHORD TRUSSES, (COORD. W/ARCH'L: 12

TOP CHORD	DEAD LOAD	24 PS
	LIVE LOAD	16 PS
BOTTOM CHORD	DEAD LOAD	10 PS
TOTAL LOAD-DURATION FACTOR		1.25

MECHANICAL UNITS-SEE PLANS FOR LOCATION AND LIADS

FABRICATOR TO DESIGN TRUSSES AND SUPPLY ADDITONAL BRIDGING AS REQUIRED TO RESIST NET UPLIFT FORES AS SHOWN ON WIND PRESSURE DIAGRAM

PROVIDE DESIGN CALCULATIONS, SIGNED AND BEARIIG THE EMBOSSED SEAL OF AN ENGINEER REGISTERED IN TH STATE OF FLORIDA, VERIFYING DESIGN FOR UPLIFT STRESSES.

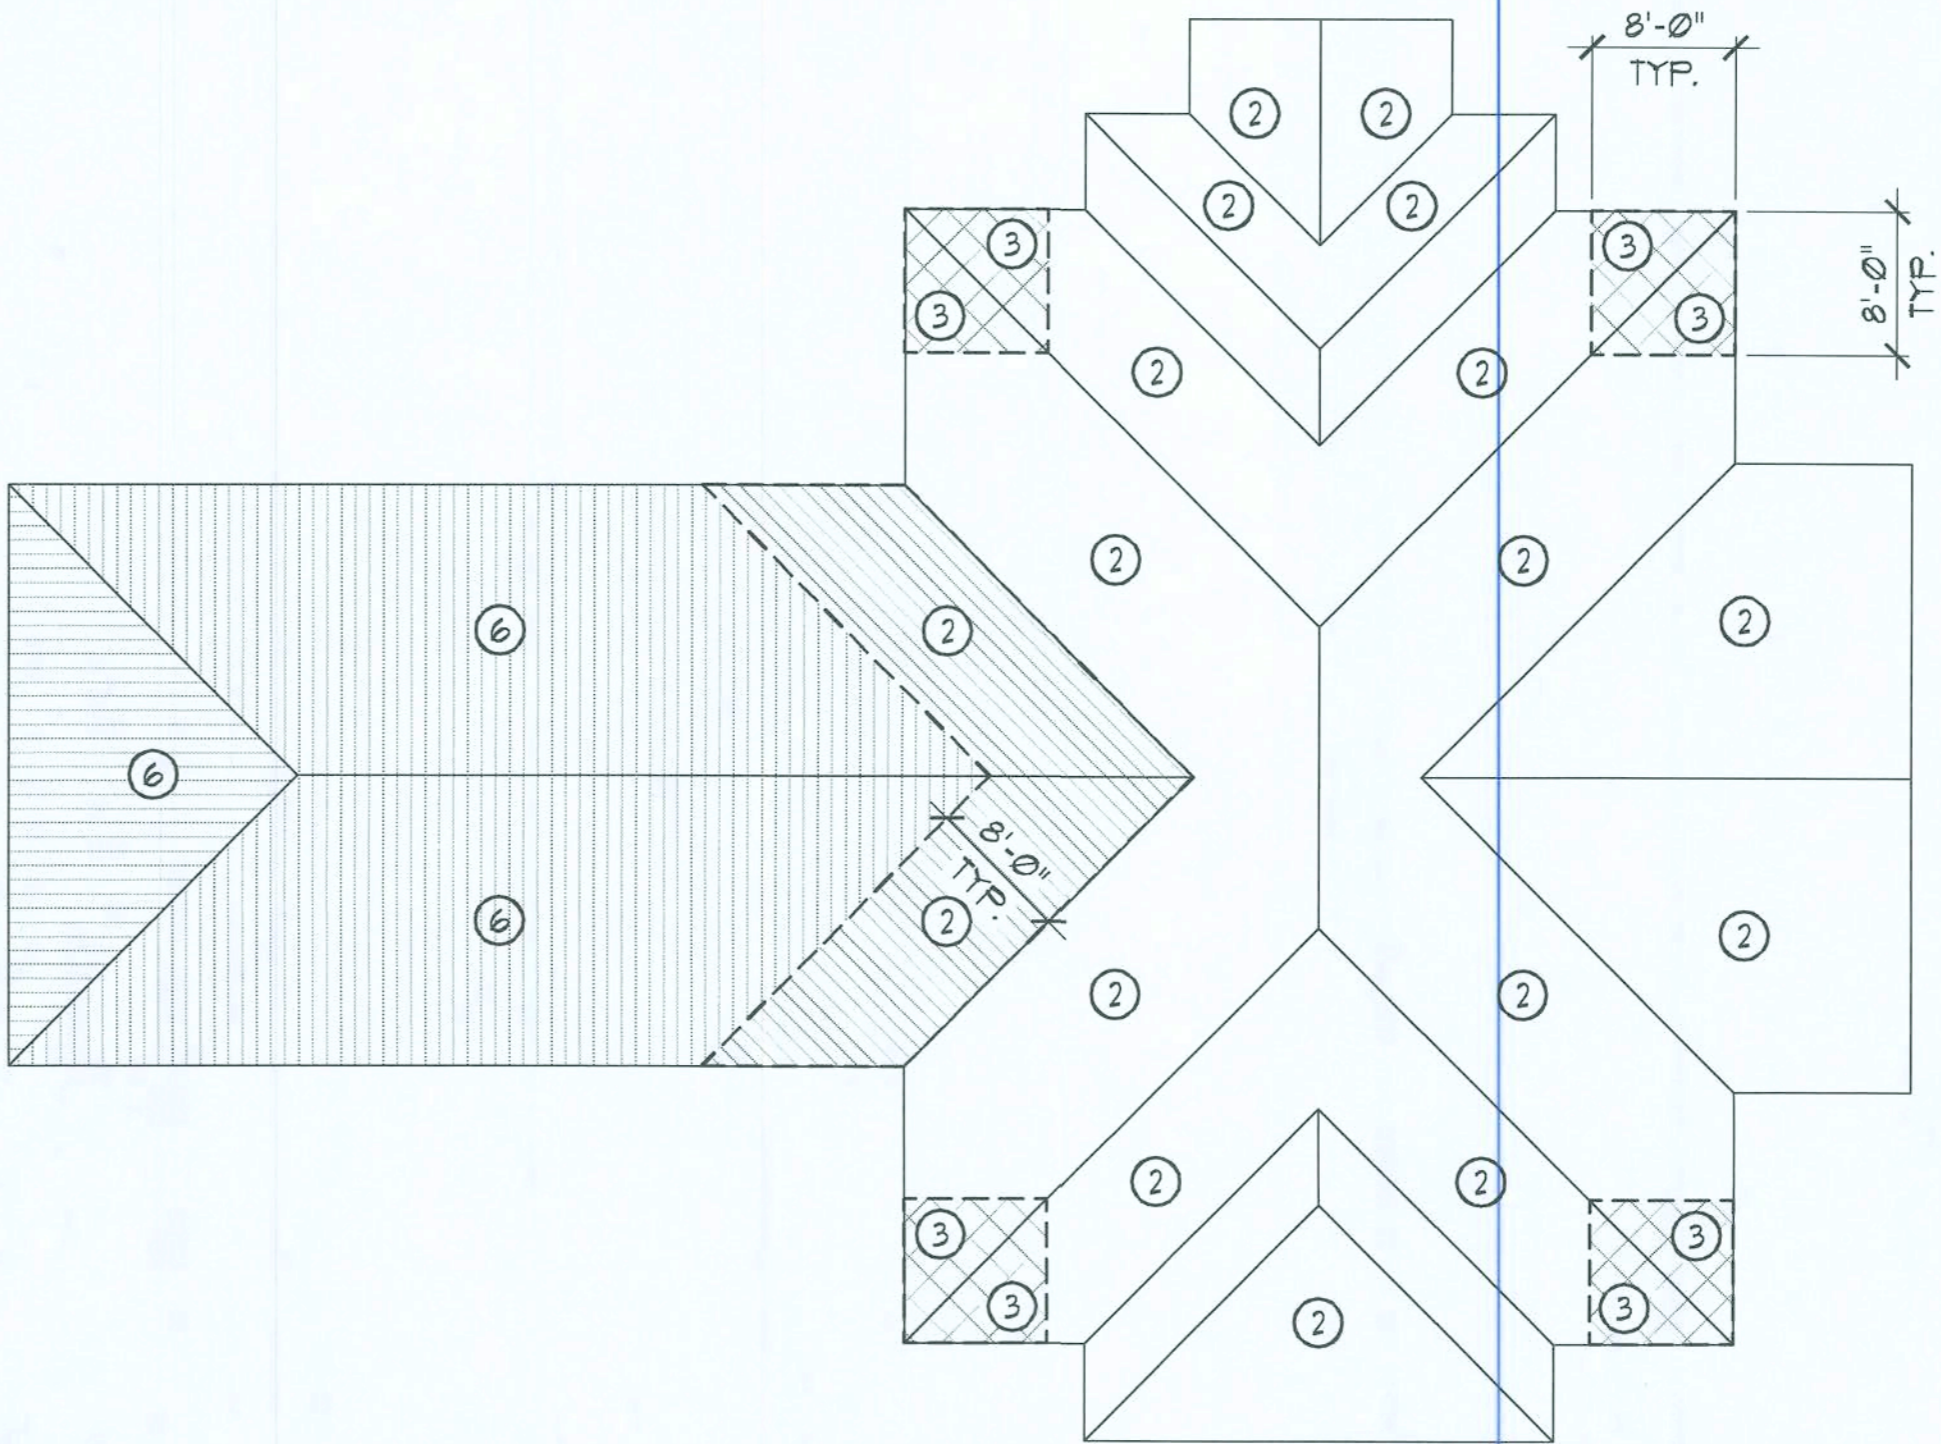
- WT-9 HANDLING, ERECTION AND BRACING OF WOOD TRUSSES SHALL BE IN ACCORDANCE WITH "HANDLING AND ERECTING WOOD TRUSSES" (HET-80) AND "BRACING WOOD TRUSSES: COMMENTARY AND RECOMMENDATIONS" BY THE TRUSS PLATE INSTITUTE, LATEST EDITIONS.
- WT-10 MINIMUM PERMANENT BRIDGING CRITERIA FOR PRE-ENGINEERED TRUSSES:

PROVIDE 2x4 CONTINUOUS HORIZONTAL BRIDGING AT TOP AND BOTTOM CHORDS AND INTERMITTENT CROSS BRIDGING AT 10' SPACING AT THE FOLLOWING MINIMUM LOCATIONS

- A. AT RIDGES
B. AT 10'-10" O.C. HORIZONTALLY-AT PANEL POINT LOCATIONS;
C. AT ALL DEEP(>18") BEARING ENDS

PROVIDE CONTINUOUS 2x4 @ 48" O.C. PERPENDICULAR TO TRUSSES AT TOP CHORD WHERE ROOF PLYWOOD IS NOT RIGIDLY ATTACHED TO TOP CHORD OF TRUSS


PROVIDE CONTINUOUS 2x4 @ 48" O.C. AT BOTTOM CHORD WHERE A RIGID CEILING IS NOT FIRMLY ATTACHED TO THE BOTTOM CHORD.2



NET ROOF UPLIFT				
TRIBUTARY AREA (ft ²)	INTERIOR ZONE ① (psf)	EDGE ZONE ② (psf)	CORNER ZONE ③ (psf)	CANOPY ZONE ⑥ (psf)
10	-20	-42.1	-42.1	-40.6
20	-19.4	-38.2	-38.2	-40.6
50	-18.6	-33	-33	-40.6
≥100	-18.1	-29.1	-29.1	-40.6

NET OVERHANG UPLIFT		
TRIBUTARY AREA (ft ²)	EDGE ZONE ② (psf)	CORNER ZONE ③ (psf)
10	-40.6	-68.3
20	-40.6	-60.5
50	-40.6	-50.2
≥100	-40.6	-42.4

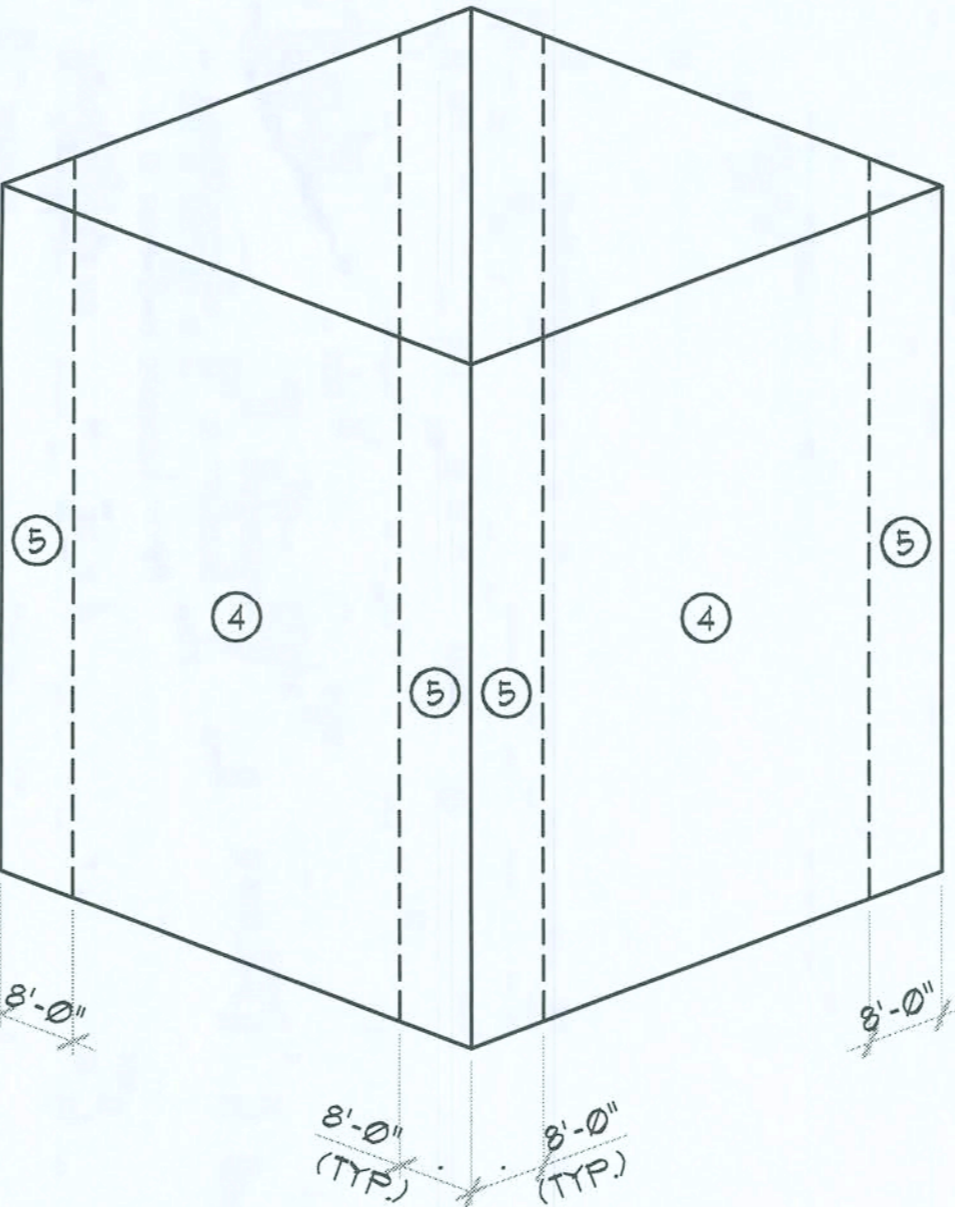1 ROOF WIND PRESSURE DIAGRAM



WALL PRESSURE (PSF) COMPONENTS AND CLADDING				
TRIBUTARY AREA (ft ²)	INTERIOR ZONE ④ (psf)		CORNER ZONE ⑤ (psf)	
	POSITIVE	NEGATIVE	POSITIVE	NEGATIVE
10	22	-23.6	22	-29.1
20	21	-22.6	21	-27.2
50	20	-21.3	20	-24.6
>100	19	-20.4	19	-22.6

2 WALL PRESSURE / COMPONENTS AND CLADDING DIAGRAM

NOT TO SCALE



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1778 N. PARK AVE., SUITE 100, MAITLAND, FL 32751,
TELEPHONE (407) 629-8755

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LAKE CITY, FLORIDA

PEOPLES
STATE BANK

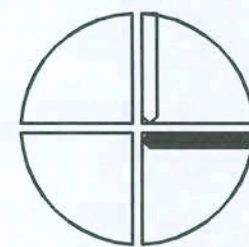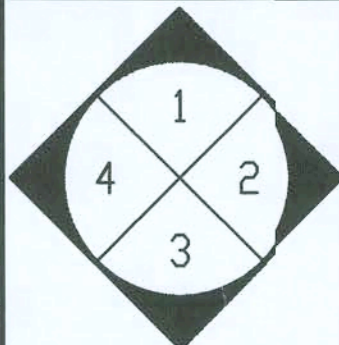GENERAL NOTES



INTERIOR
ELEVATION
KEY

NORTH
ACTUAL
PLAN


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SCALE:	AS NOTED		
FILE:	1006015-001		

STRUCTURAL
GENERAL
NOTES

SEAL	ARCHITECT/CONSULTANT
	MITZO ENGINEERING, LLC STRUCTURAL CONSULTANTS 870 NORTH ORLANDO AVE., SUITE 100A MAITLAND, FLORIDA 32751 PHONE: (407) 844-1500 FAX: (407) 844-1827

SHEET NUMBER

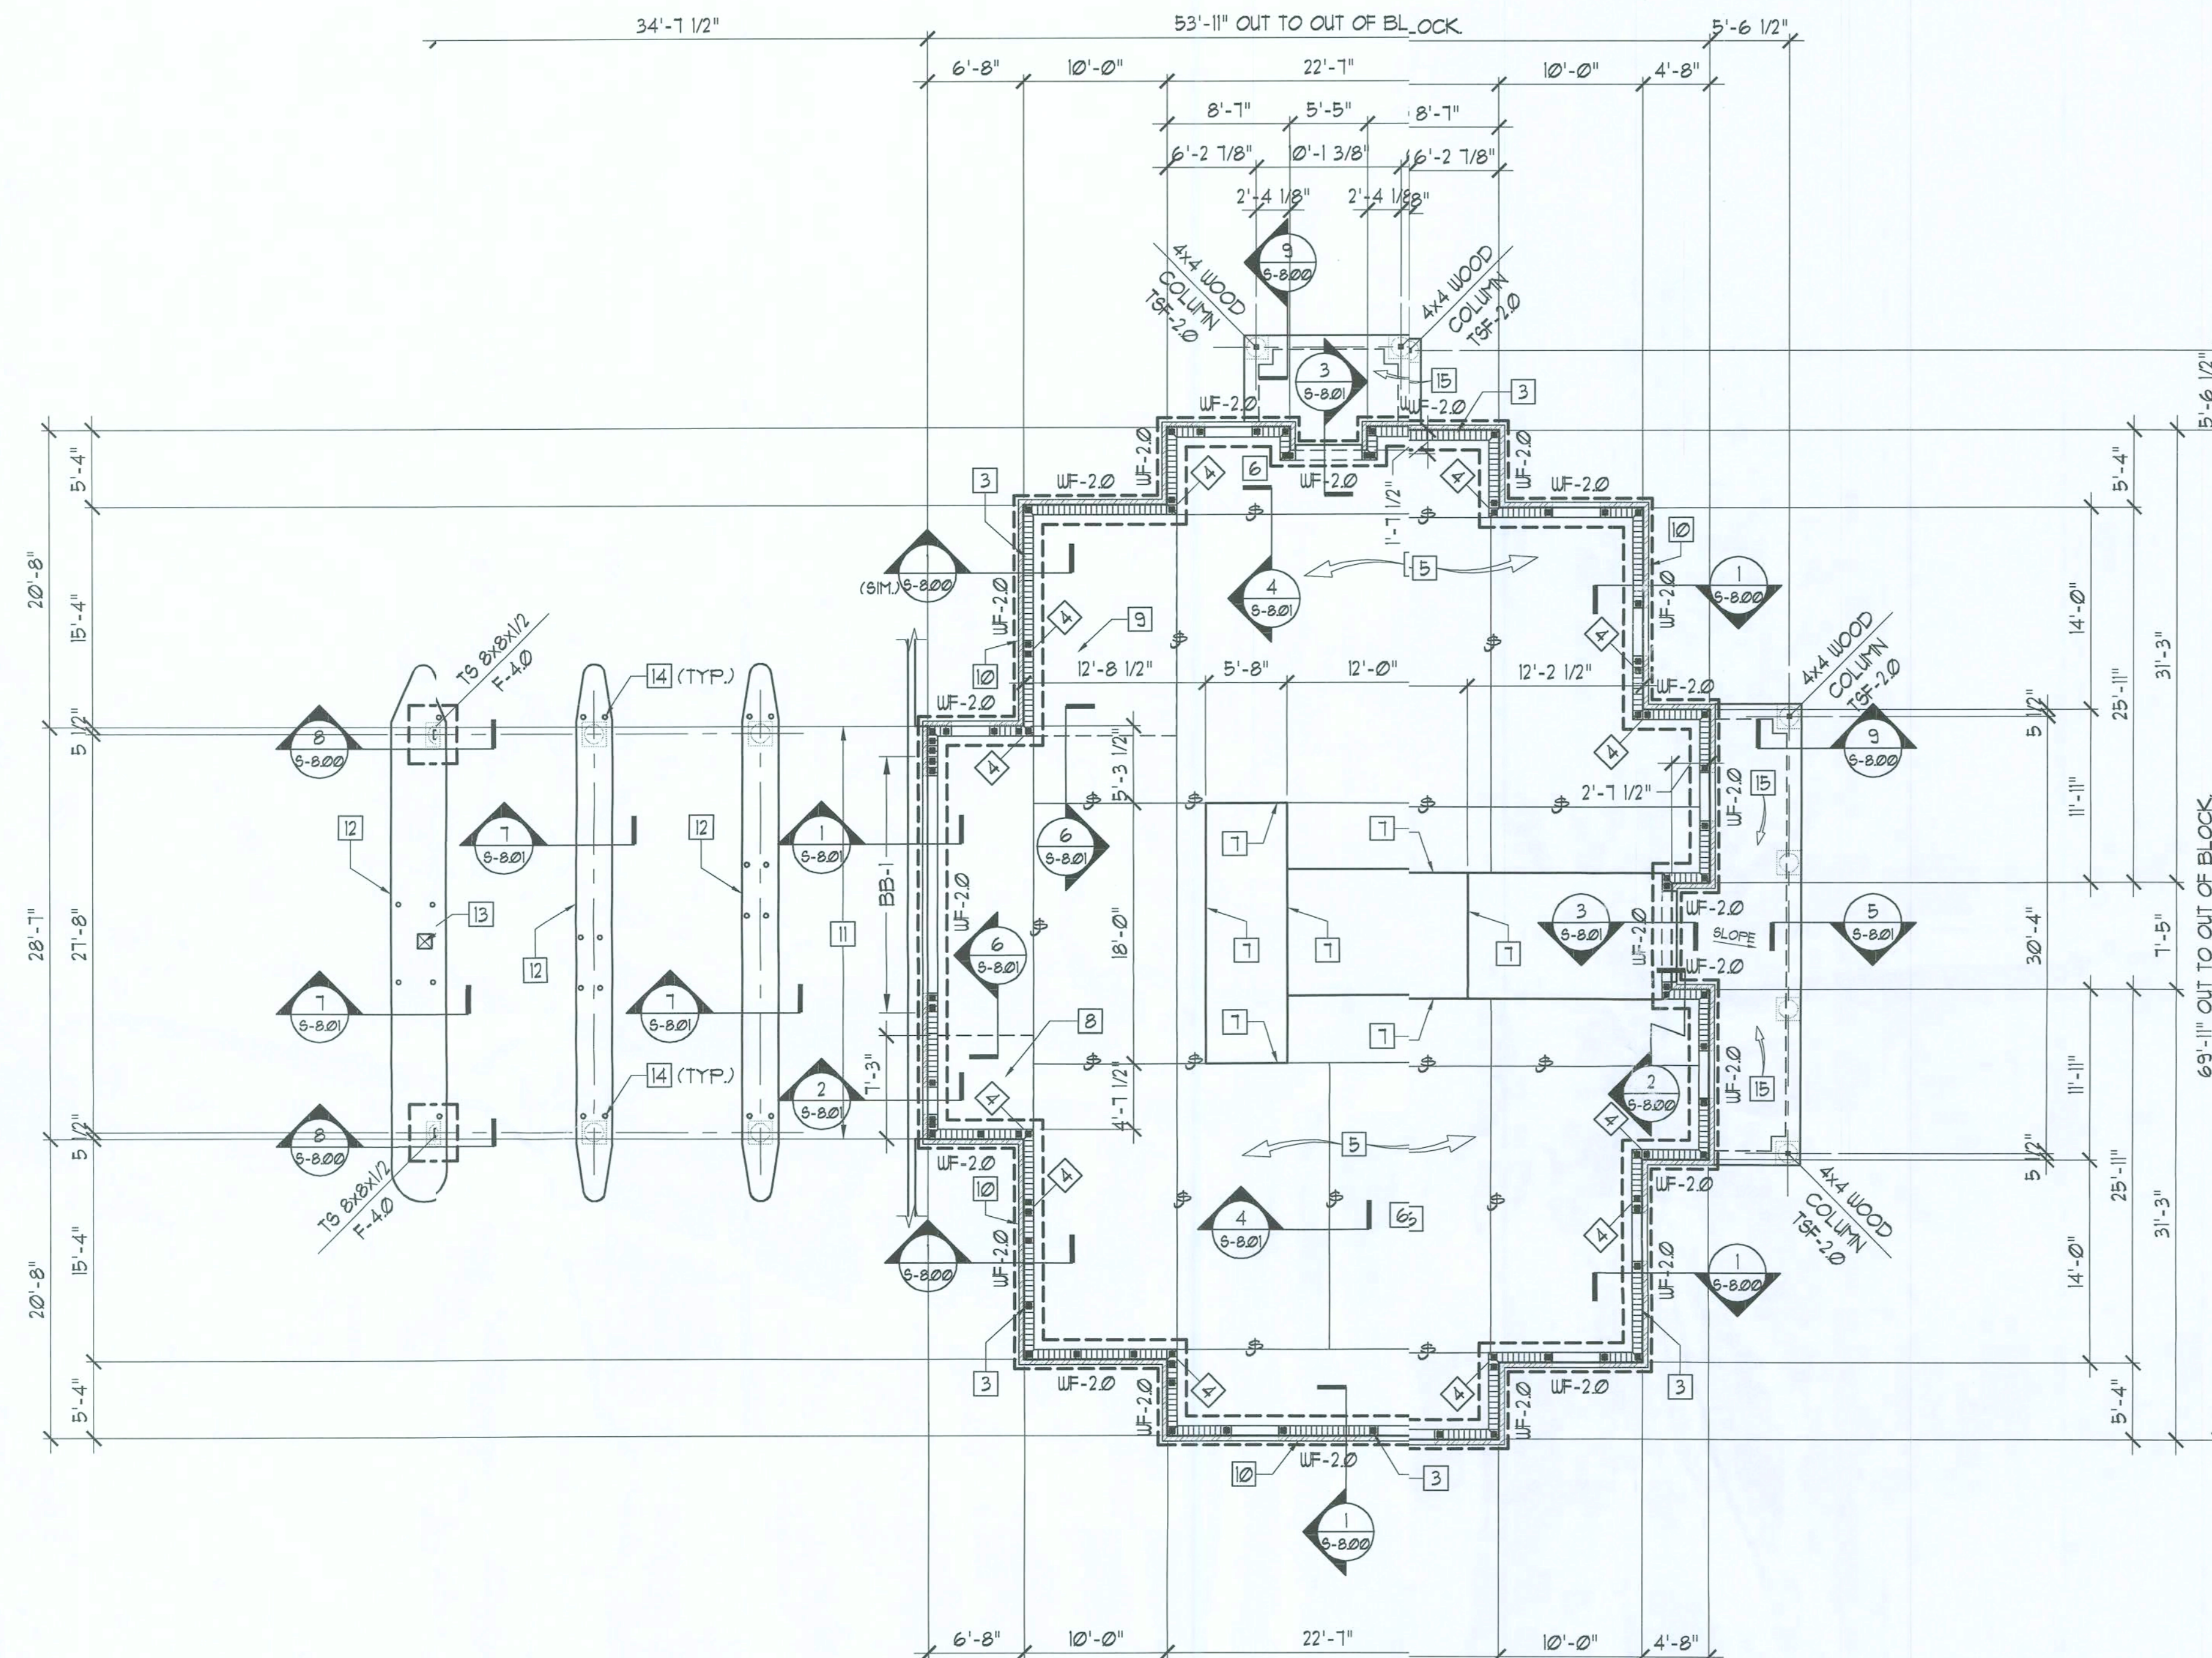S-0.01



FOUNDATION AND SLAB ON GRADE PLAN

1/8"=1'-0"

- 0'-0" (REF.)
- T/SLAB (TYP. UNO.)
- 1'-4" (REF.)
- T/FTG (TYP. UNO.)

- STEP FOOTINGS (AS REQUIRED) SEE DETAIL 1/8-8.00 FOR ADDITIONAL INFORMATION. GENERAL CONTRACTOR TO COORDINATE STEP FOOTING LOCATIONS.
- PROVIDE CORNER BARS WHERE ALL FOOTINGS CHANGE DIRECTION AND AT FOOTING INTERSECTIONS. SEE SECTION 6/8-8.00 FOR FURTHER INFORMATION.
- INDICATES 8" MASONRY BEARING WALLS REINFORCED W/11-#5 (VERT.) BAR AND MATCHING DOUEL AT FOOTING, IN SOLID GROUT FILLED CELLS AT ALL CORNERS, INTERSECTIONS, AND ADJACENT MASONRY OPENINGS (COORD. SIZE, LOCATIONS AND ELEVATIONS THERE OF WITH ARCH'L. DRAWINGS). ENDS OF WALLS AND BETWEEN AT 48" O.C. (MAX.) SEE PLAN FOR ADDITIONAL LOCATIONS. EXTEND VERTICAL REINFG. BARS THRU TO UPPER MOST MASONRY BOND BEAM (SPLICE / LAP AS REQUIRED) - SEE SHEET 8-3.00 AND TERMINATE BARS WITH STANDARD 90° HOOK (SEE SEC. 2/8-8.02 FOR FURTHER INFORMATION)
- PROVIDE DOUBLE FILLED CELLS REINFORCED WITH (11-#5 (VERT.) BAR AND MATCHING DOUEL AT FOOTING, IN SOLID GROUT FILLED CELLS, (TYP. EACH CELL) LOCATE SUCH THAT DOUBLE FILLED CELLS ALIGN WITH PRE-ENGINEERED WOOD GIRDER TRUSS ABOVE. (SEE SHEET 8-3.00 AND COORDINATE EXACT LOCATIONS WITH PRE-ENGINEERED WOOD TRUSS MANUFACTURER / SUPPLIER'S APPROVED SHOP DRAWINGS)
- SLAB ON GRADE CONSTRUCTION: 4" POLYPROPYLENE FIBER REINFORCED CONCRETE SLAB ON GRADE ON VAPOR BARRIER (SEE ARCH'L. DRAWINGS) OVER COMPACTED SUBGRADE. COORD. ANY AND ALL SLAB SLOPES, DEPRESSIONS AND LIMITS THERE OF WITH ARCH'L. DRAWINGS. (FOR ACTUAL TOP OF SLAB ELEVATIONS SEE ARCH'L. AND / OR CIVIL DRAWINGS)
- SLAB CONTROL JOINTS (SEE PLAN FOR SPACING) AND CONTROL JOINT DETAIL 4/8-8.01 FOR FURTHER INFORMATION AND COORD. W/ARCH'L. DRAWINGS FOR ADDITIONAL LOCATIONS.
- PROVIDE 1/4" (DEEP) SLAB CUT / JOINTS.
- 8" CONCRETE SLAB (SEE SEC. 6/8-8.01 FOR REINFORCING) UNDER "ATM" MACHINE. GENERAL CONTRACTOR TO COORDINATE EXTENT / LIMITS THERE OF WITH ARCH'L. DRAWINGS.
- 8" CONCRETE SLAB (SEE SEC. 6/8-8.01 FOR REINFORCING) UNDER "SAFE KEEPING ROOM". GENERAL CONTRACTOR TO COORDINATE EXTENT / LIMITS THERE OF WITH ARCH'L. DRAWINGS.
- EXTERIOR VENEER: COORDINATE LIMITS / EXTENTS WITH ARCH'L. DRAWINGS.
- PROVIDE 12" (WIDE) X 1'-4" (DEEP - MIN.) CONCRETE CURB. SEE SEC. 1/8-8.01 FOR FURTHER INFORMATION. COORD. EXTENT / LIMITS OF CURB WITH ARCH'L. AND / OR CIVIL DRAWINGS.
- GENERAL CONTRACTOR TO COORDINATE EXTENT / LIMITS OF DRIVE THRU ISLANDS WITH ARCH'L. AND / OR CIVIL DRAWINGS.
- CUTOUT FOR CONDUIT IN DRIVE THRU ISLAND, COORDINATE EXACT SIZE AND LOCATION WITH ARCH'L. DRAWINGS.
- BOLLARD: SEE ARCH'L. DRAWINGS FOR TYPICAL INFORMATION AND LOCATION. (TYP.)
- EXTERIOR SLAB ON GRADE: 4" POLYPROPYLENE FIBER REINFORCED CONCRETE SLAB ON GRADE ON VAPOR BARRIER (SEE ARCH'L. DRAWINGS) OVER COMPACTED SUBGRADE. COORD. LIMITS / EXTENTS THERE OF, AND TOP OF SLAB SLOPES WITH ARCH'L. DRAWINGS. (FOR ACTUAL TOP OF SLAB ELEVATIONS SEE ARCH'L. AND / OR CIVIL DRAWINGS)

FOOTING SCHEDULE

MARK	SIZE WIDTH x LENGTH x DEPTH	REINFORCEMENT BOTTOM	REINFORCEMENT TOP
F-4.0	4'-0"x4'-0"x12"	(5)-#5'S EACH WAY	-
T&F-2.0	2'-0"x2'-0"x12"	(3)-#5'S EACH WAY	-
WF-2.0	2'-0"xCONT.x12"	(3)-#5'S CONT. #5'S @ 24" O.C. TRAVERSE	-


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1778 N. PARK AVE., SUITE 100, MAITLAND, FL 32751,
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LICENSE NO. F00061


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EOPLES
STATE BANK

GENERAL NOTES



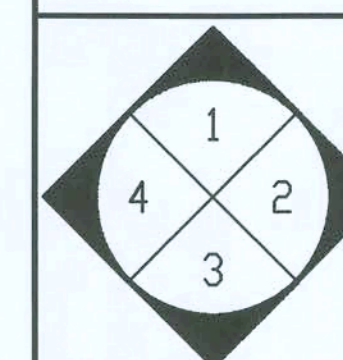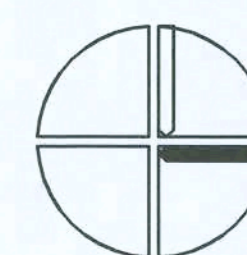INTERIOR
ELEVATION
KEY



NORTH
ACTUAL
PLAN

MARK	DATE	REVISIONS


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SCALE:	AS NOTED		
FILE:	200607611		

FOUNDATION AND SLAB ON GRADE PLAN

SEAL	ARCHITECT/CONSULTANT
<i>William E. Mitzo</i> 6/6/06	MITZO ENGINEERING, LLC STRUCTURAL CONSULTANTS 870 NORTH ORLANDO AVE., SUITE 100A MAITLAND, FLORIDA 32751 PHONE: (407) 844-1500 FAX: (407) 844-1502
	SHEET NUMBER

WILLIAM E. MITZO, PROFESSIONAL ENGINEER
FLORIDA REGISTRATION NUMBER: 2168

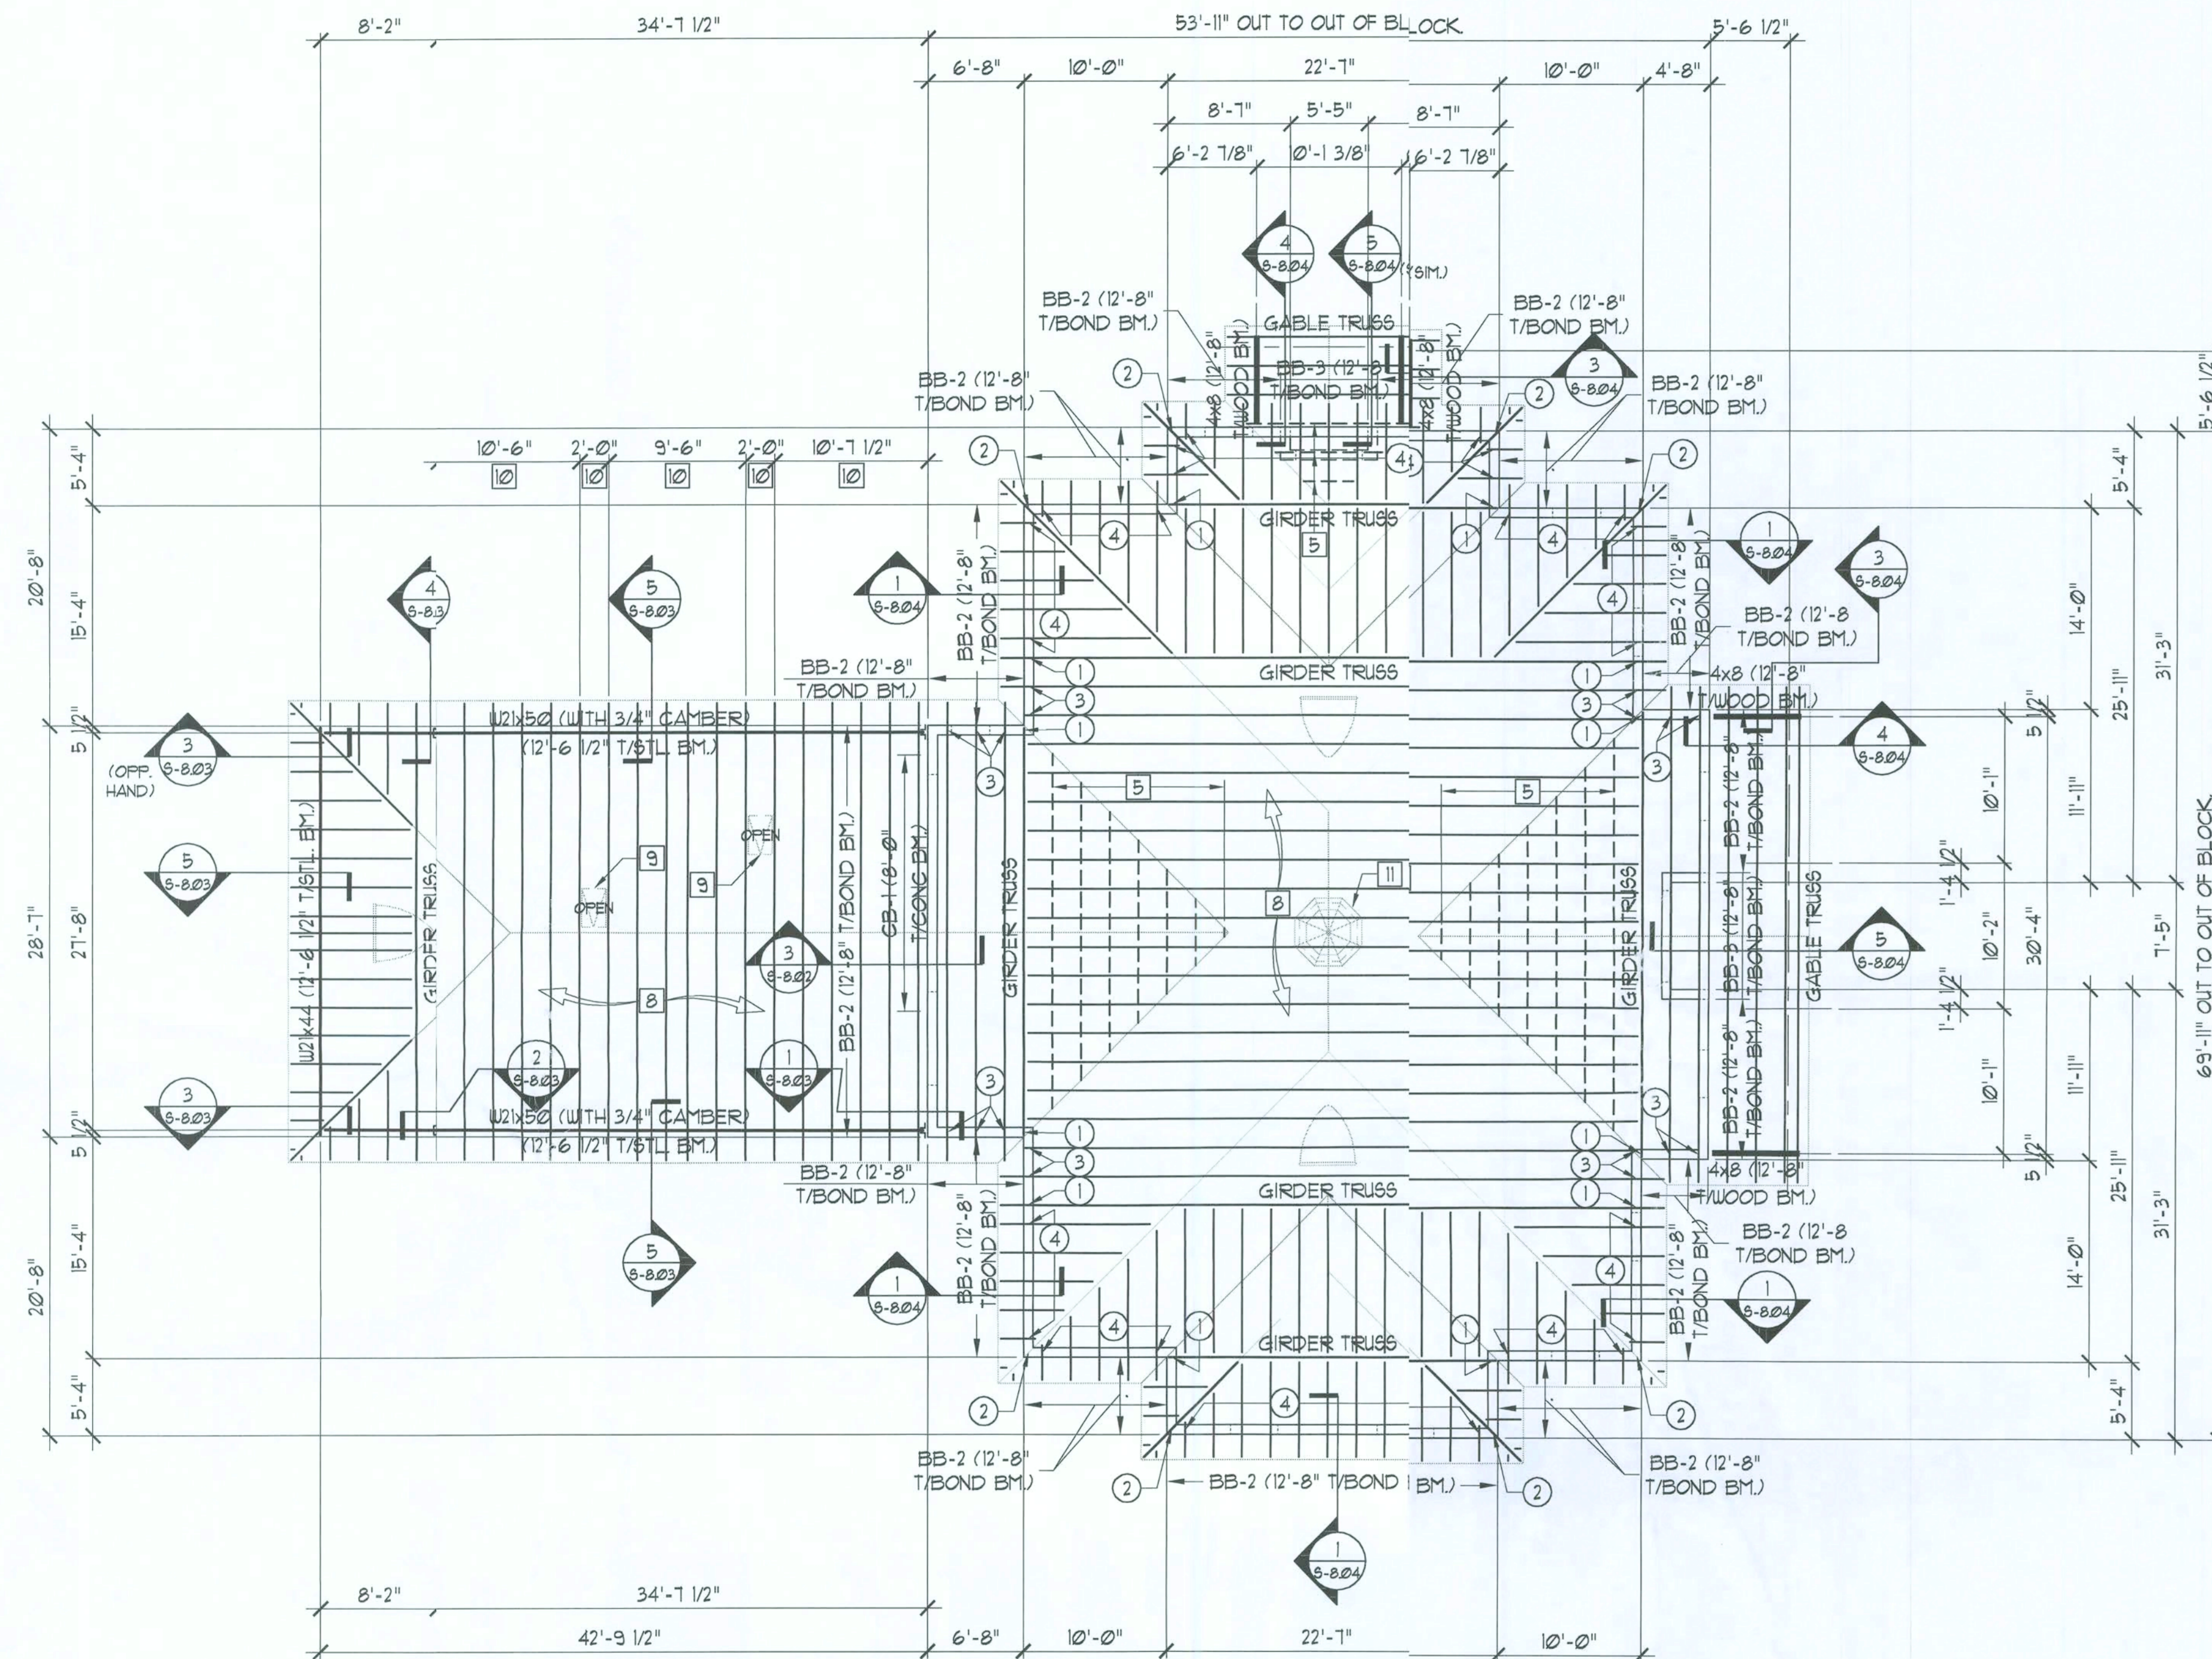6-1.11



ROOF FRAMING PLAN

1/8"=1'-0"

- 1 PROVIDE MASONRY LINTEL OVER ALL OPENINGS IN MASONRY WALLS (COORDINATE EXACT SIZE, LOCATIONS AND ELEVATIONS WITH ARCH'L. DRAWINGS) SEE GENERAL NOTES FOR LINTEL TYPE SIZES AND REINFORCING. PROVIDE TEMPORARY SHORING DURING CONSTRUCTION IF LINTEL SPAN IS GREATER THAN 6'-0" (SIX FEET).
- 2 PROVIDE CORNER BARS WHERE ALL BOND BEAMS (BB-) CHANGE DIRECTION AND AT ALL BOND BEAM (BB-) INTERSECTIONS. SEE SEC. 6/5-800 (S1M.) FOR FURTHER INFORMATION.
- 3 ALL PRE-ENGINEERED WOOD TRUSSES AND MISCELLANEOUS 2x FRAMING SPACED AT 24"O.C. (MAX.) COORD. EXACT LOCATIONS WITH PRE-ENGINEERED WOOD MANUFACTURER / SUPPLIER'S APPROVED SHOP DRAWINGS.
- 4 PROVIDE 2x (TALL) WOOD BLOCKING BETWEEN EACH TRUSS WHERE PLYWOOD ROOF SHEATHING CHANGES DIRECTION (RIDGE LINES, ROOF EDGE, HIPS AND VALLIES, ETC.)
- 5 OVER BUILT FRAMING: PRE-ENGINEERED WOOD TRUSSES OR 2x FRAMING SPACED AT 24"O.C. (MAX.) COORD. EXACT LOCATIONS WITH PRE-ENGINEERED WOOD MANUFACTURER / SUPPLIER'S APPROVED SHOP DRAWINGS.
- 6 SEE GENERAL NOTES: (SHT. 6-201) FOR CONNECTION INFORMATION OF PRE-ENGINEERED WOOD TRUSSES, GIRDER TRUSSES AND MISCELLANEOUS 2x FRAMING, ETC.
- 7 PROVIDE HEAVY GIRDER TIEDOWN: HGT-2 (FOR 2 PLY) - (IF ONE PLY - PROVIDE 3/4" (WOOD) SHIM ON EACH SIDE) OR HGT-3 (FOR 3 PLY) WITH ANCHOR BOLTS AS RECOMMENDED BY SIMPSON COMP. AT EACH PRE-ENGINEERED WOOD GIRDER TRUSS (OR AN APPROVED EQUAL SUBSTITUTE) COORDINATE SIZE (NUMBER OF PLY'S) WITH PRE-ENGINEERED WOOD TRUSS MANUFACTURER / SUPPLIER'S APPROVED SHOP DRAWINGS.
- 8 ROOF CONSTRUCTION: (ROOFING FINISH - SEE ARCH'L. DRAWINGS) OVER 5/8" CDX EXTERIOR GRADE PLYWOOD SHEATHING NAILED WITH 10d NAILS AT 6"O.C. (MAX.) AT SUPPORTED EDGES, AND 10d NAILS AT 12"O.C. (MAX.) AT INTEREDIATE SUPPORTS (FIELD). PROVIDE ONE PLYWOOD CLIP PER SPAN BETWEEN SHEET EDGES. ON PRE-ENGINEERED WOOD TRUSSES.
- 9 ACCESS HATCH: COORDINATE EXACT SIZE AND LOCATION WITH ARCH'L. DRAWINGS.
- 10 HOLD TRUSS LOCATION DIMENSIONS (AS SHOWN) FOR LOCATION OF ACCESS HATCH.
- 11 "COPULA" SEE ARCH'L. DRAWINGS FOR SIZE AND LOCATION. (SEE SEC. 6/5-803 FOR ANCHOR / ATTACHMENT INFORMATION.)

FRAMING ANCHOR SCHEDULE (AT MASONRY ONLY)

MARK	TRUSS TYPES	HANGER TYPE		MANUF.	DESCRIPTION	REMARKS
		TOP	BOTTOM			
①	GIRDER TRUSSES	-	HGT-2	SIMPSON	HEAVY GIRDER TIE DOWN	SEE NOTE 1
②	HIP TRUSSES	-	HET420	SIMPSON	EMBEDDED TRUSS ANCHOR	
③	FULL TRUSSES	-	HET420	SIMPSON	EMBEDDED TRUSS ANCHOR	
④	JACK TRUSSES	-	HET420	SIMPSON	EMBEDDED TRUSS ANCHOR	

NOTE:

- 1 SEE SECTIONS FOR ADDITIONAL CONNECTOR CALLOUTS AND COORDINATE / VERIFY WITH APPROVED SHOP DRAWINGS.
- 2 ALL "SIMPSON COMPANY" HANGERS, ETC. (OR APPROVED EQUAL) SHALL BE USED / INSTALLED AS RECOMMENDED BY THE MANUFACTURER'S REQUIREMENTS.


DSI
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TELEPHONE(407) 629-5755

LICENSE NO. F00061

GENERAL NOTES

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EOPLES
STATE BANK

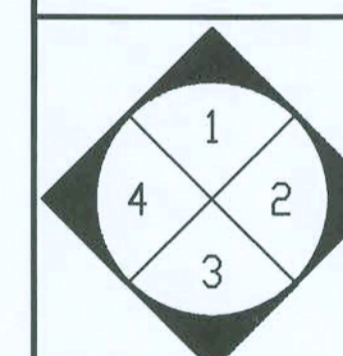

INTERIOR
ELEVATION
KEY

NORTH
ACTUAL
PLAN


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DATE:	02/15/06	CHECKED	WJM
SCALE:	AS NOTED		
FILE:	2006075-310		


ROOF FRAMING PLAN

SEAL
ARCHITECT/CONSULTANT
MITZO
ENGINEERING, LLC
STRUCTURAL CONSULTANTS
670 NORTH ORLANDO AVE., SUITE 100A
MAITLAND, FLORIDA 32751
PHONE: (407) 844-1000
FAX: (407) 844-1002
SHEET NUMBER
6-3.00

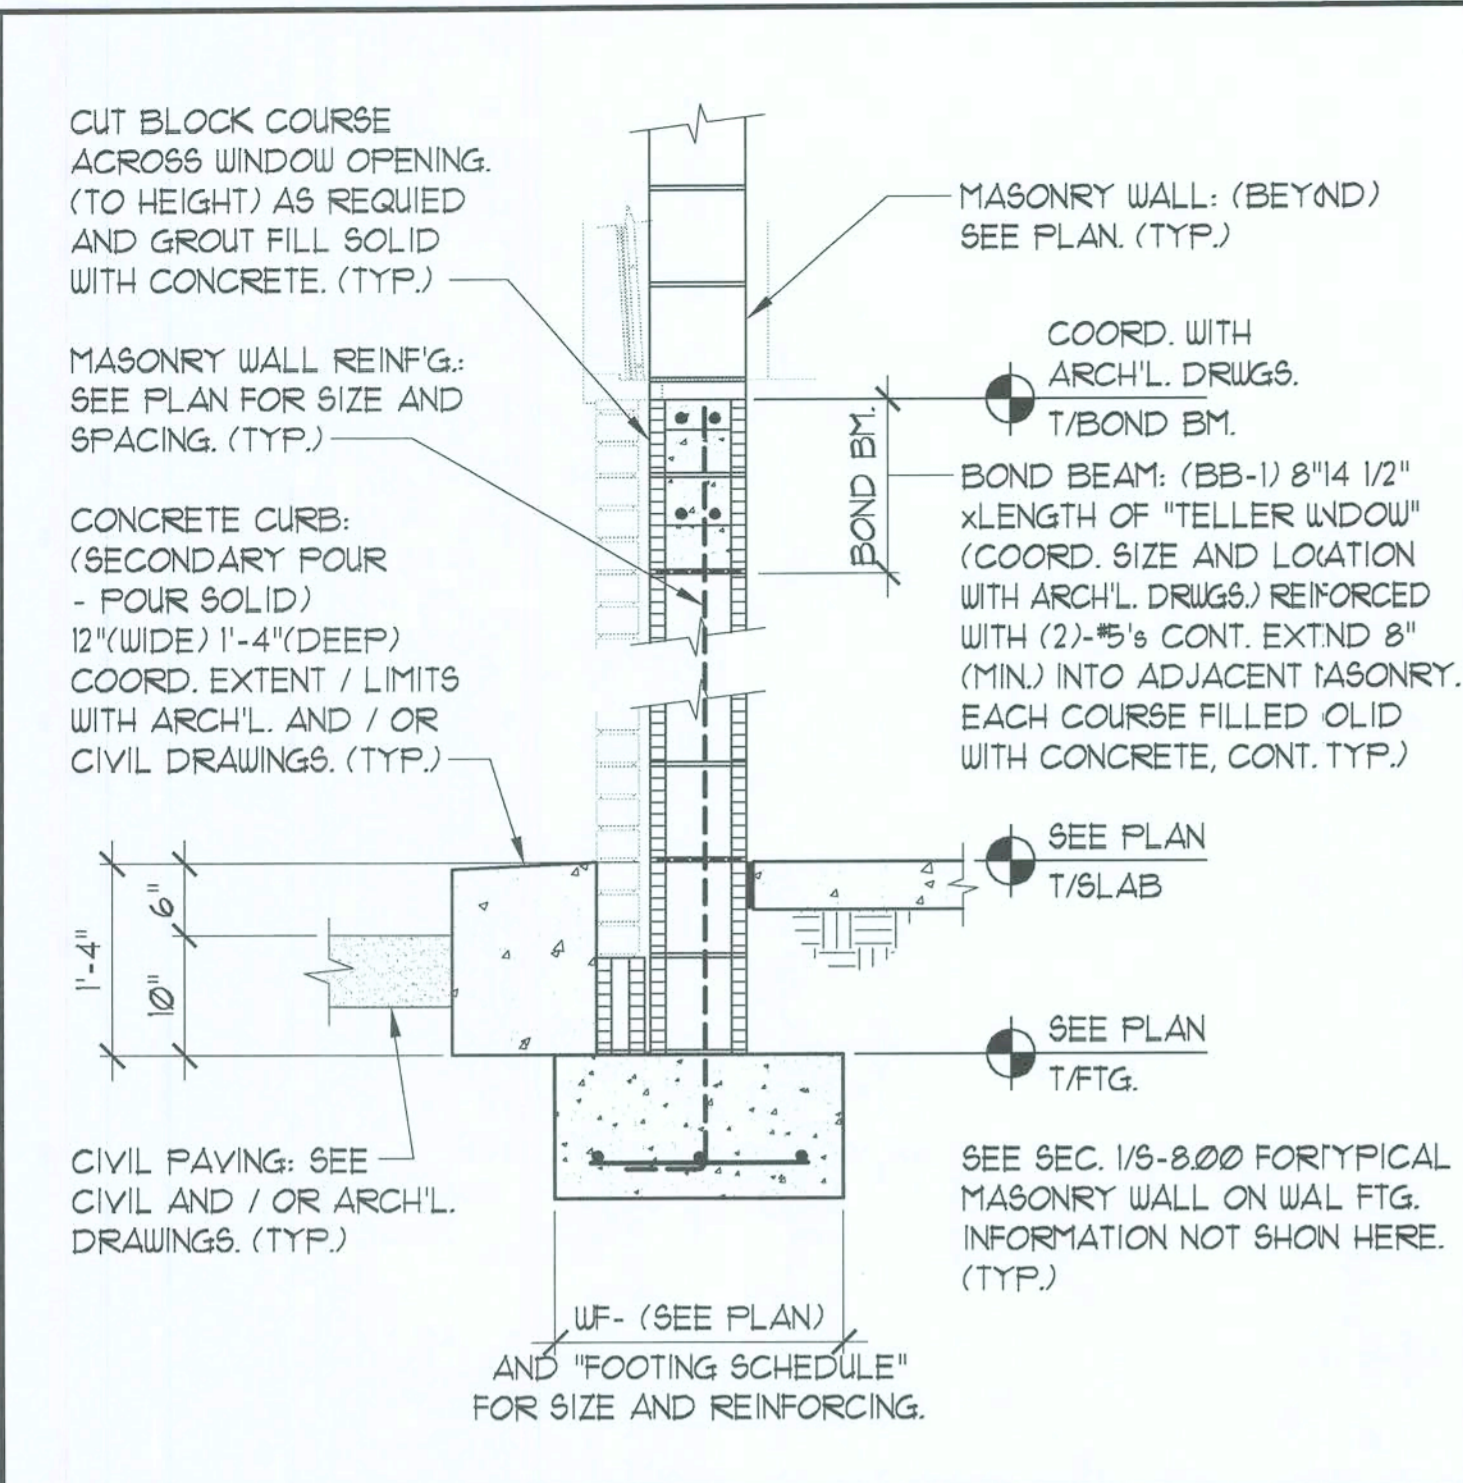
WILLIAM E. MITZO PROFESSIONAL ENGINEER
FLORIDA REGISTRATION NUMBER: 2188




1 CONCRETE CURB AT WALL
3/4" = 1'-0"

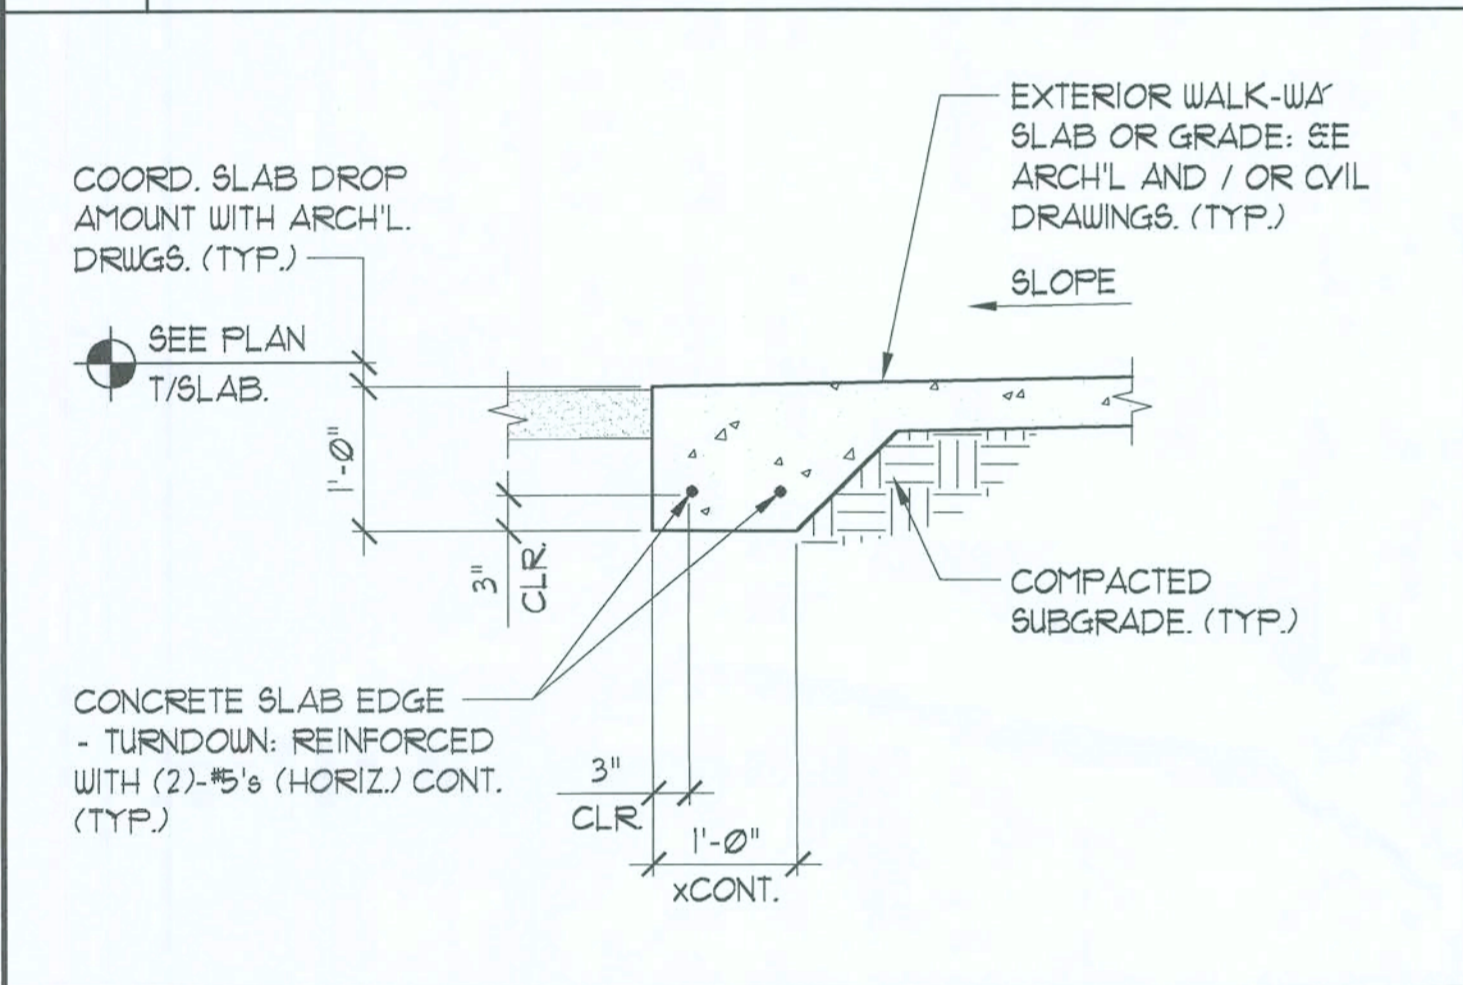

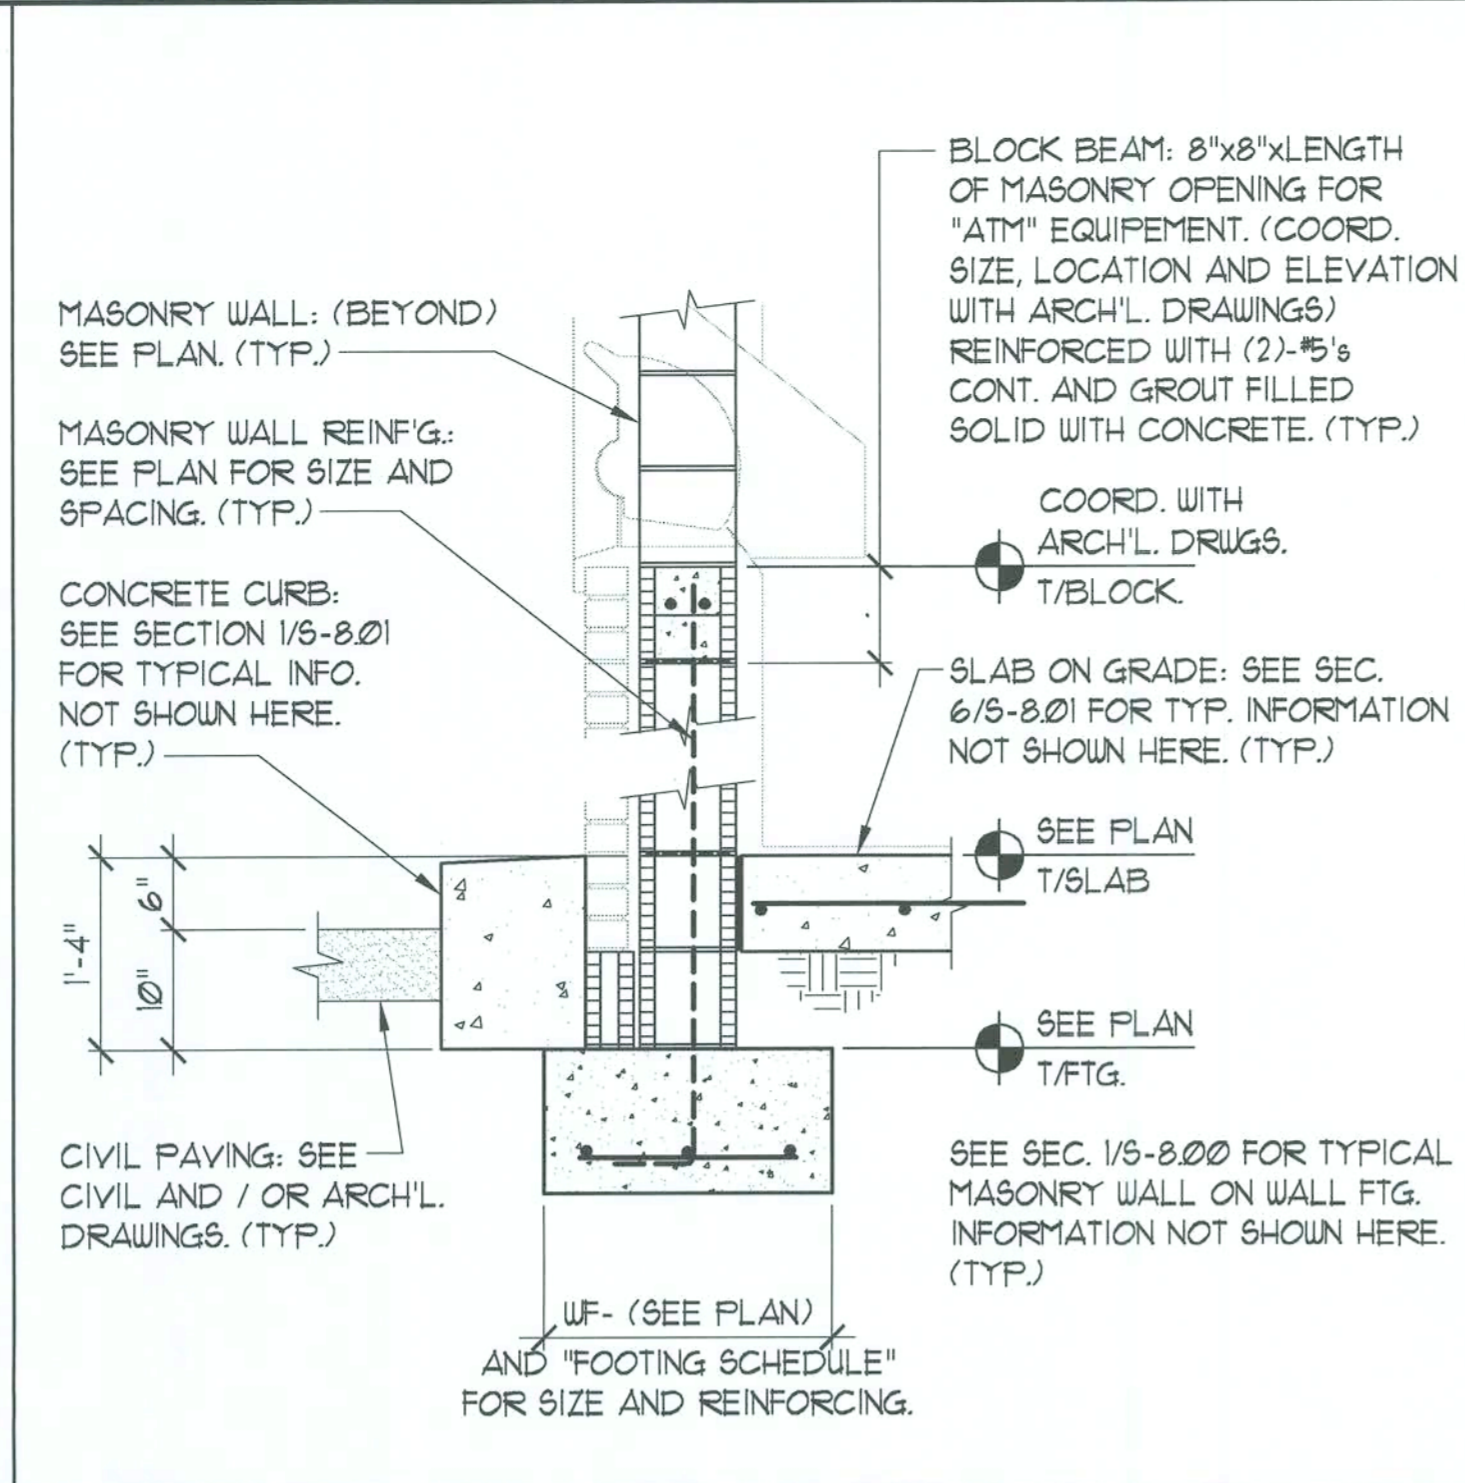
5 TURNDOWN SLAB EDGE DETAIL
3/4" = 1'-0"




2 CONCRETE CURB AT WALL
3/4" = 1'-0"

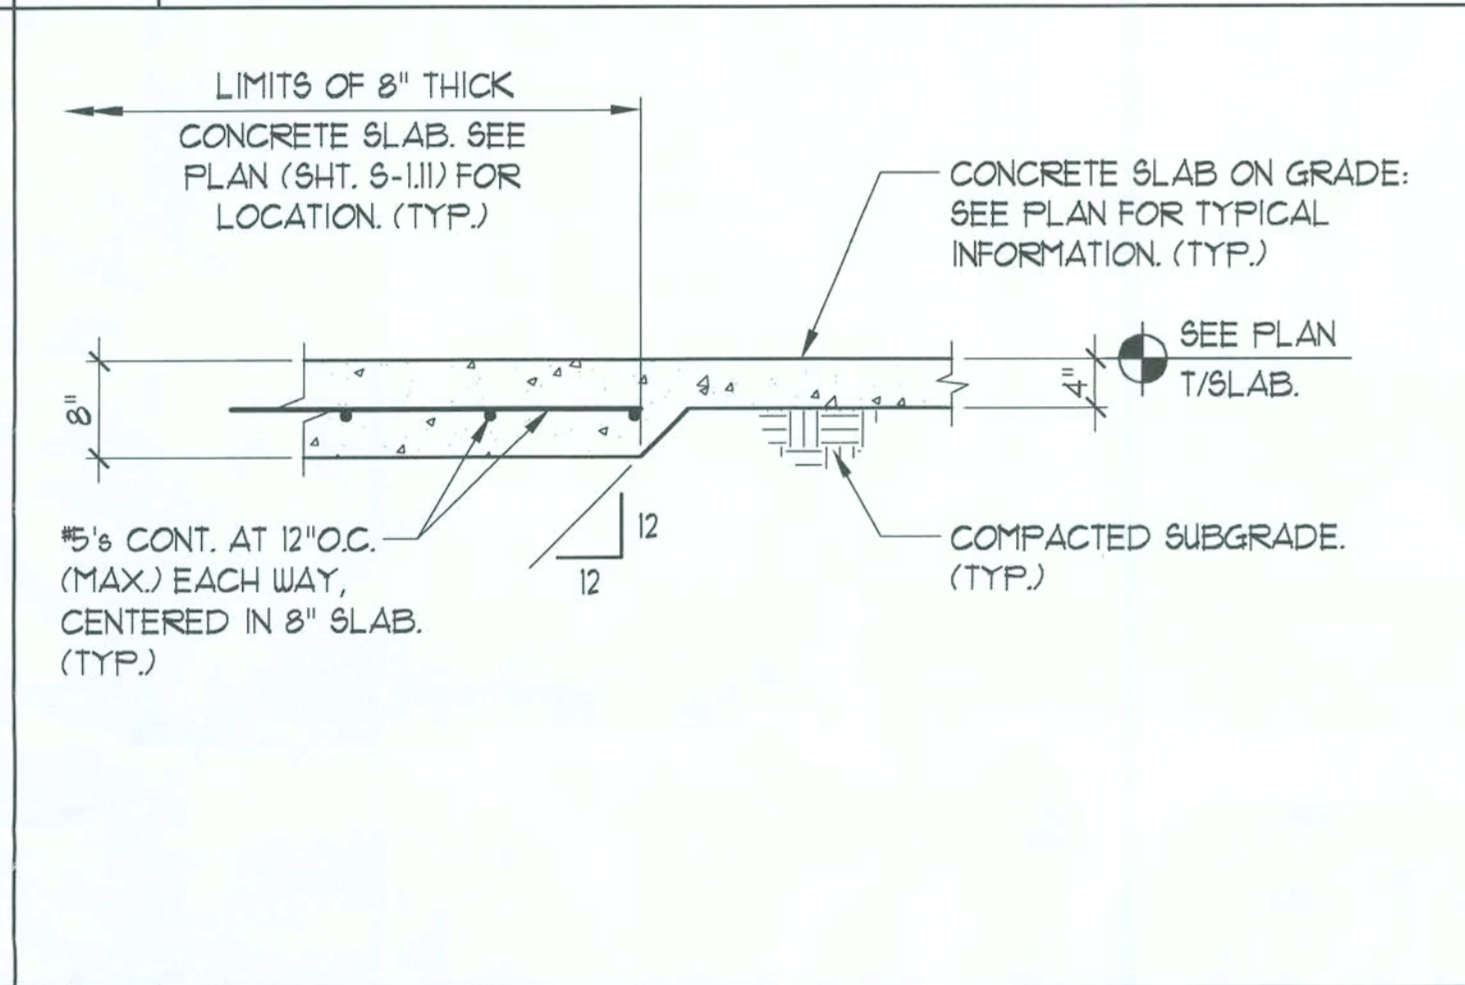


6 THICKENED SLAB DETAIL
3/4" = 1'-0"

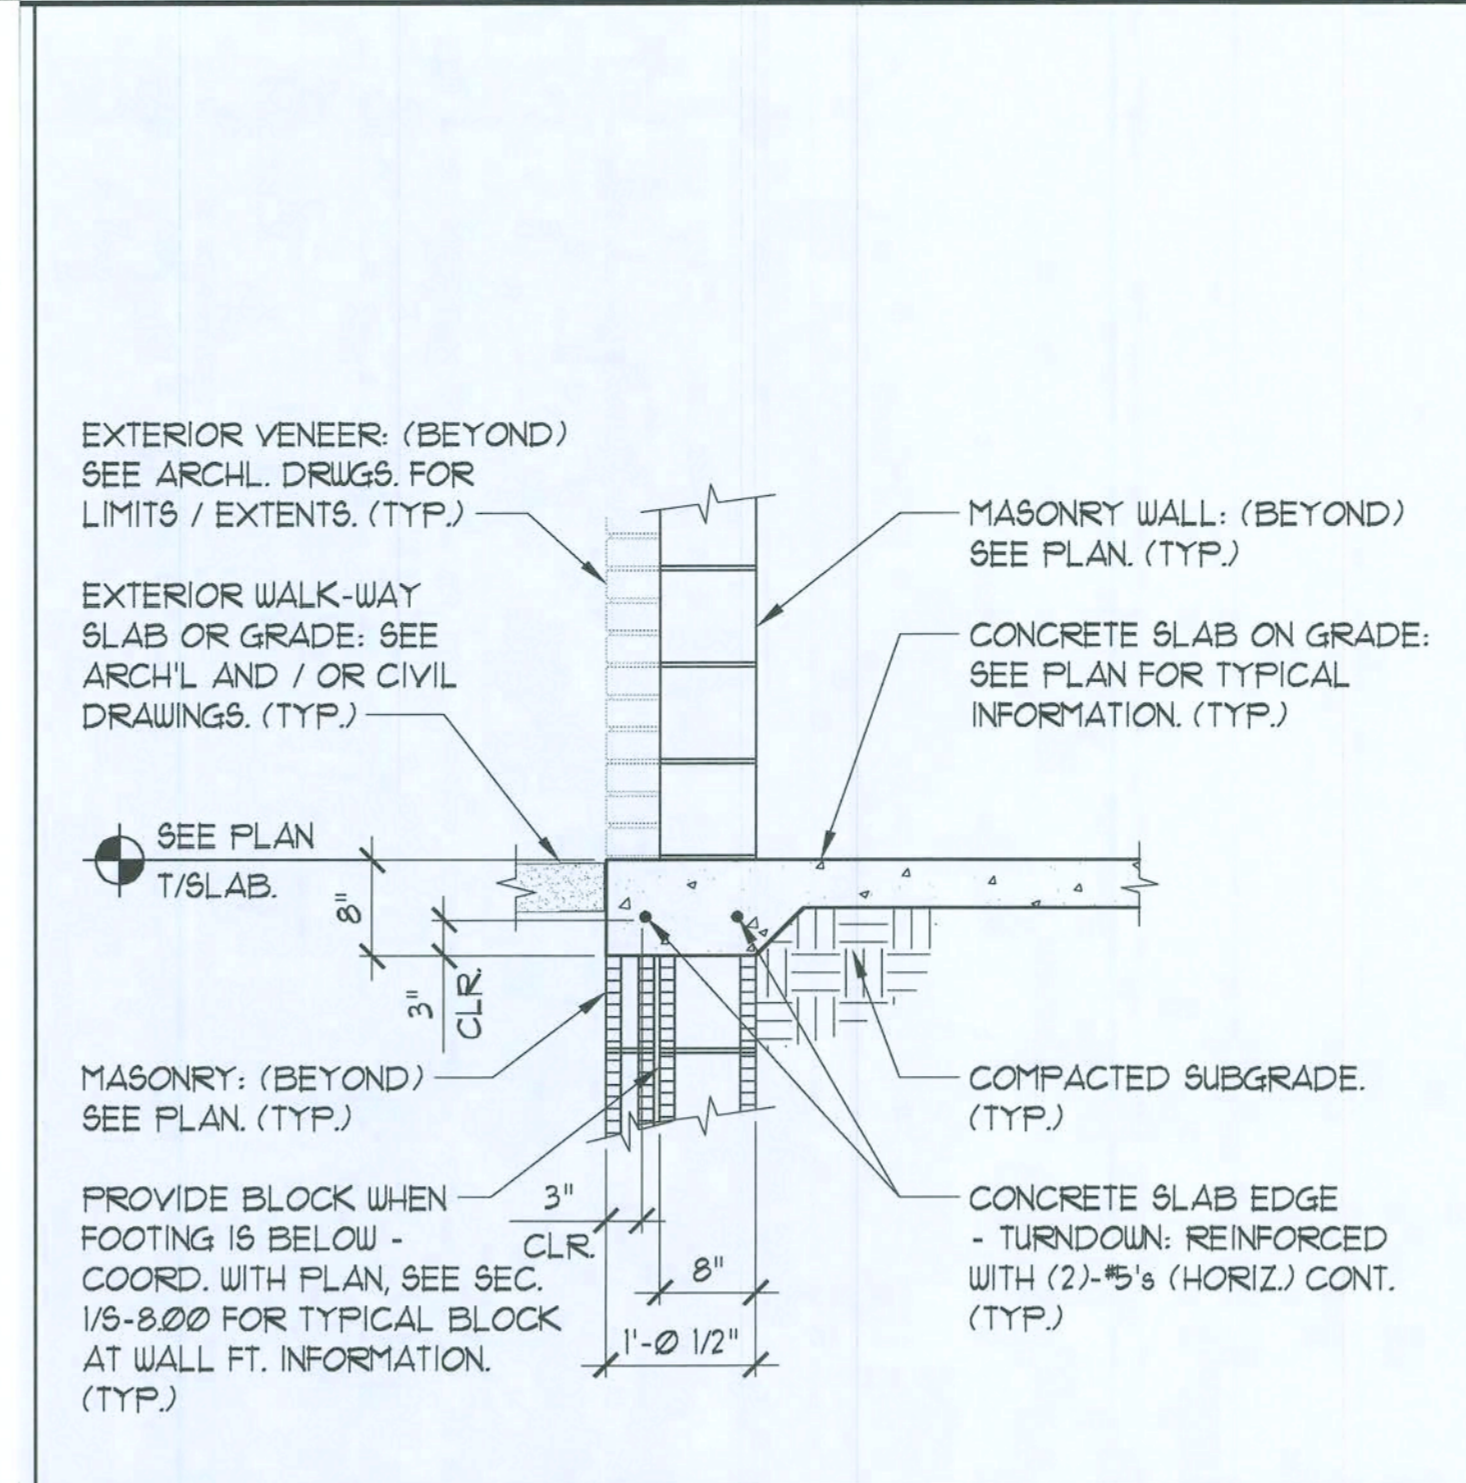

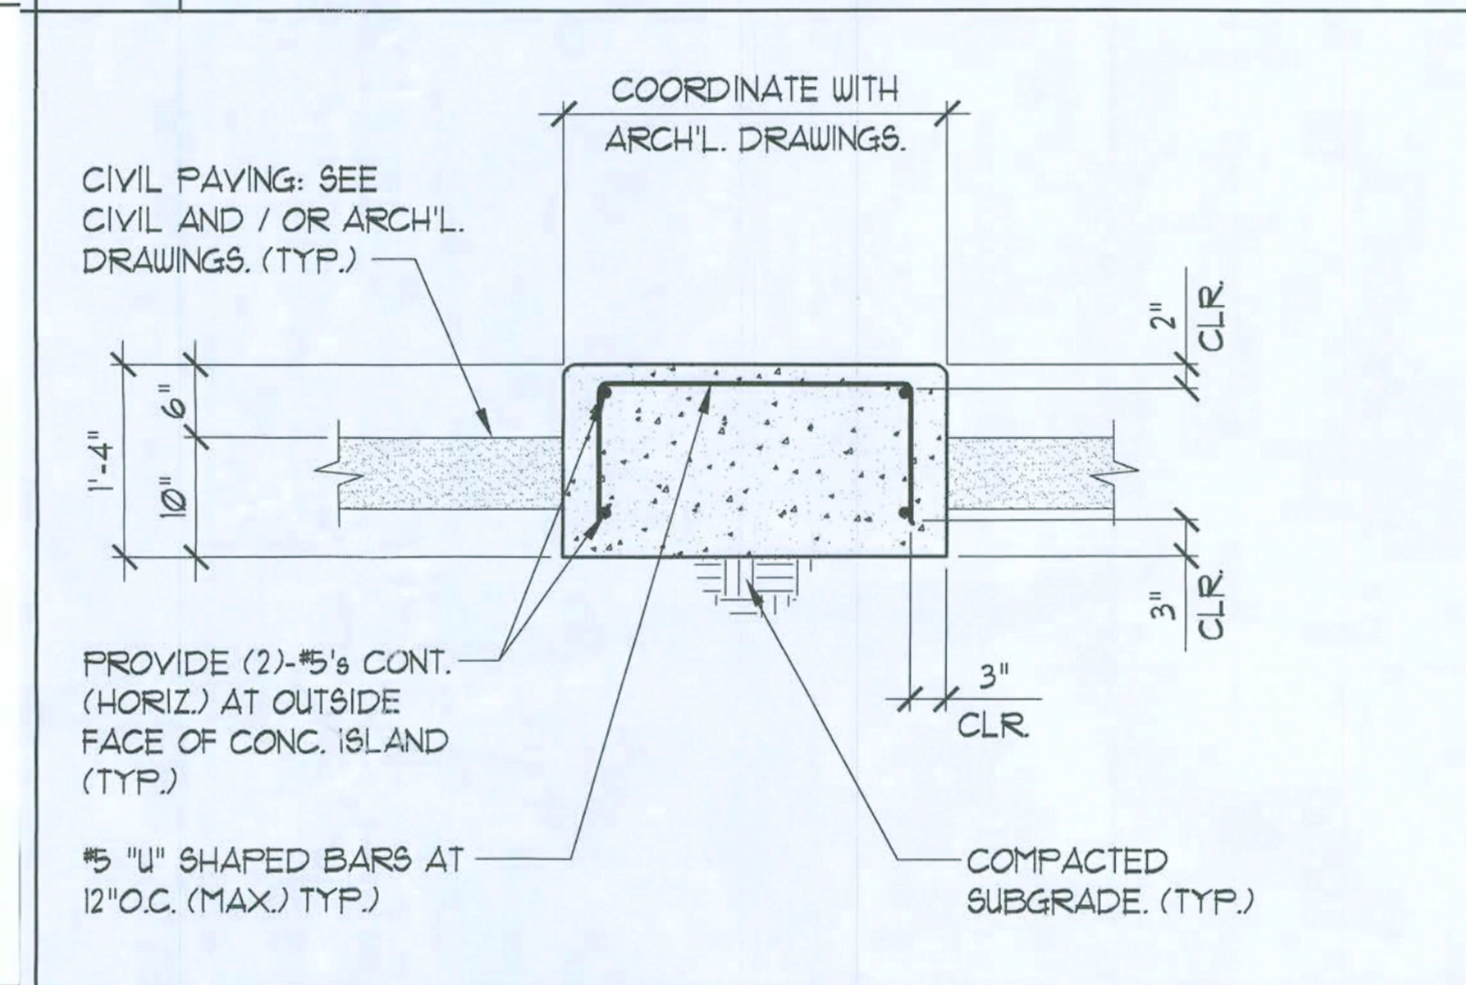3 THICKENED SLAB EDGE DETAIL
3/4" = 1'-0"




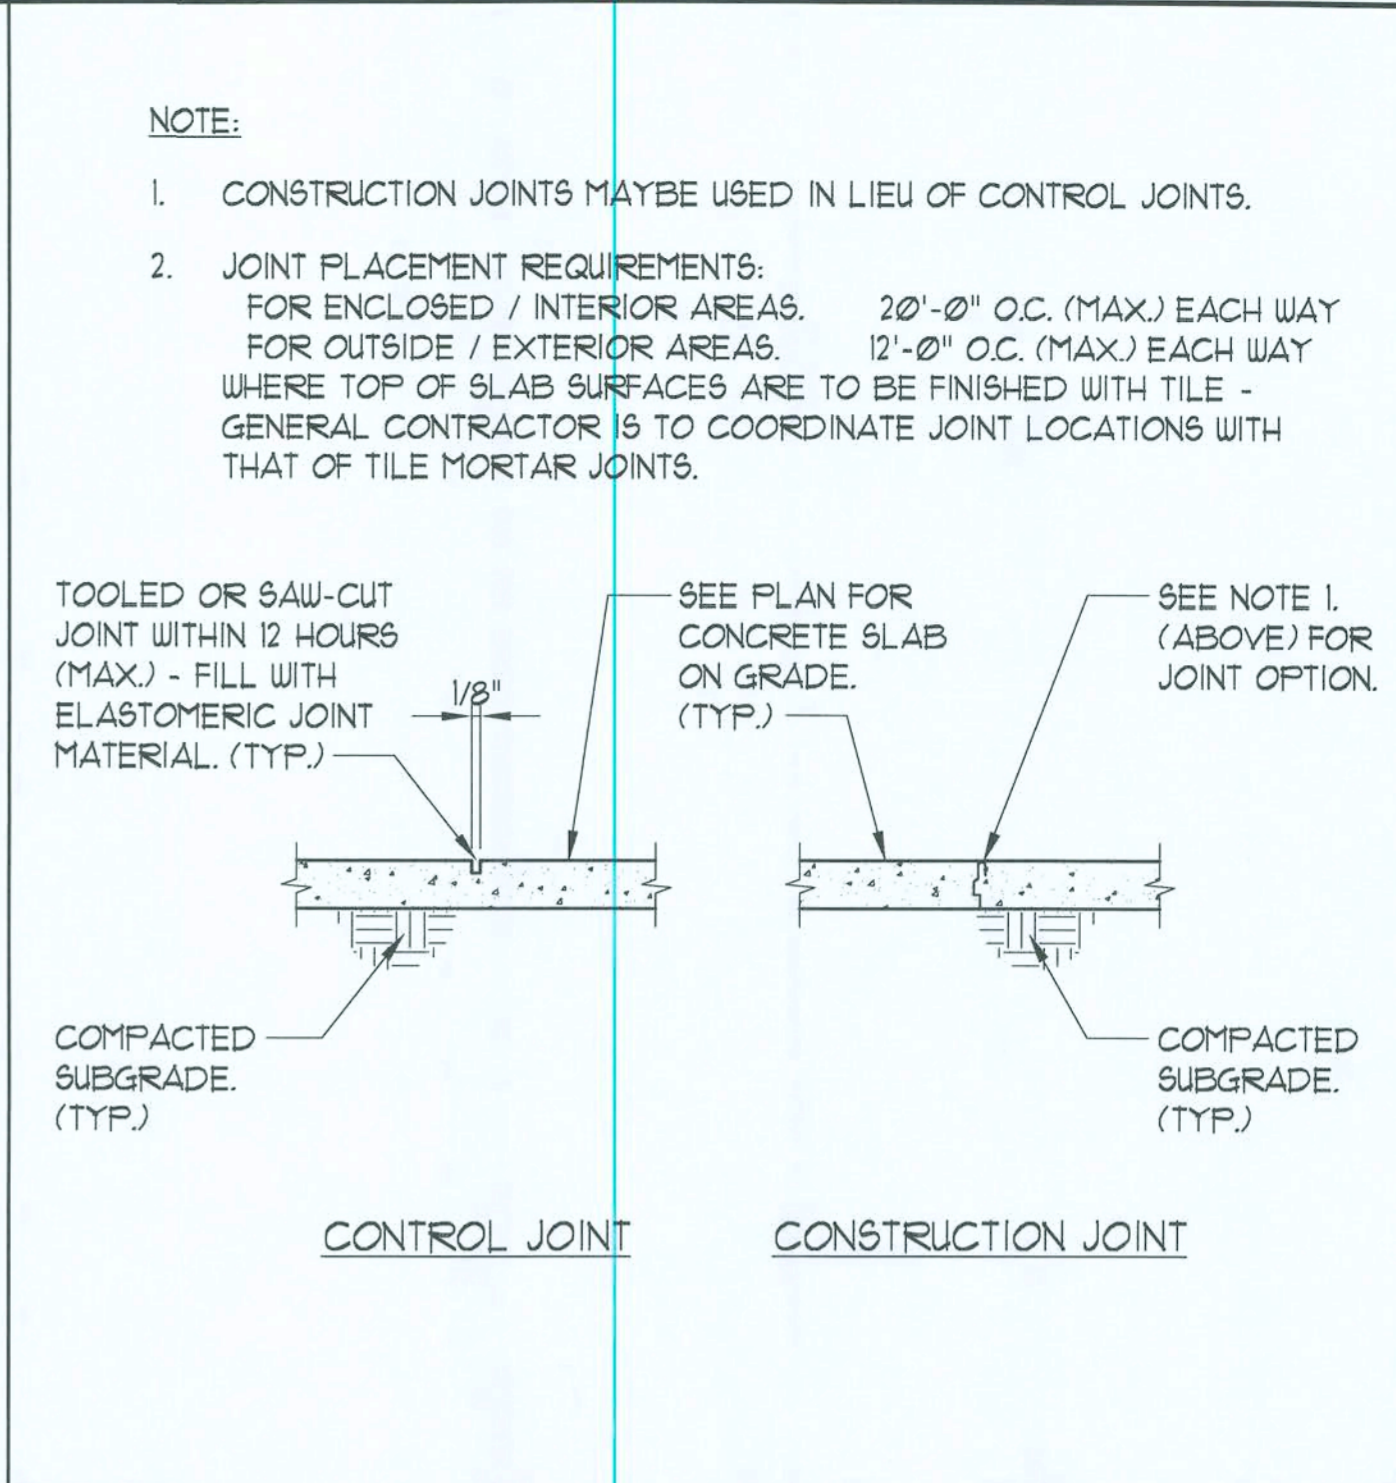7 CONCRETE "DRIVE THRU" ISLAND
3/4" = 1'-0"



4 SLAB CONSTR / CONTROL JOINTS
3/4" = 1'-0"

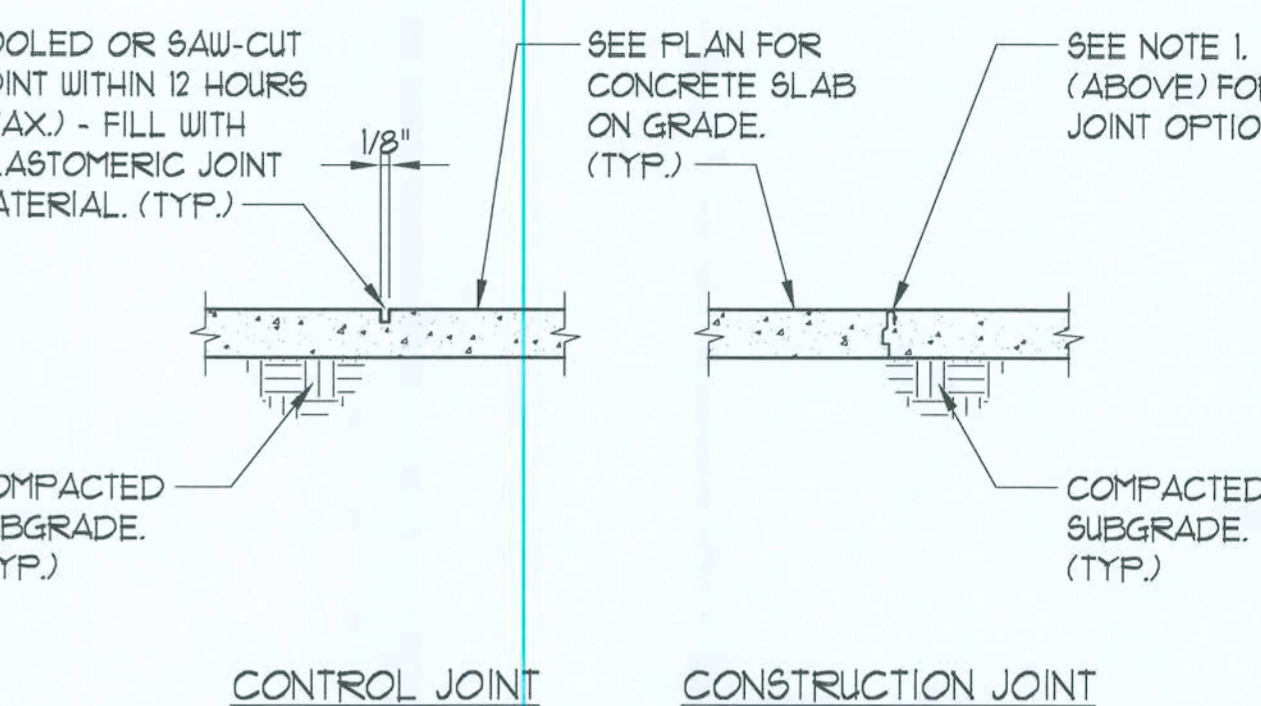NOTE:
1. CONSTRUCTION JOINTS MAYBE USED IN LIEU OF CONTROL JOINTS.
2. JOINT PLACEMENT REQUIREMENTS:
FOR ENCLOSED / INTERIOR AREAS. 20'-0" O.C. (MAX.) EACH WAY
FOR OUTSIDE / EXTERIOR AREAS. 12'-0" O.C. (MAX.) EACH WAY
WHERE TOP OF SLAB SURFACES ARE TO BE FINISHED WITH TILE -
GENERAL CONTRACTOR IS TO COORDINATE JOINT LOCATIONS WITH
THAT OF TILE MORTAR JOINTS.



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LAKE CITY, FLORIDA

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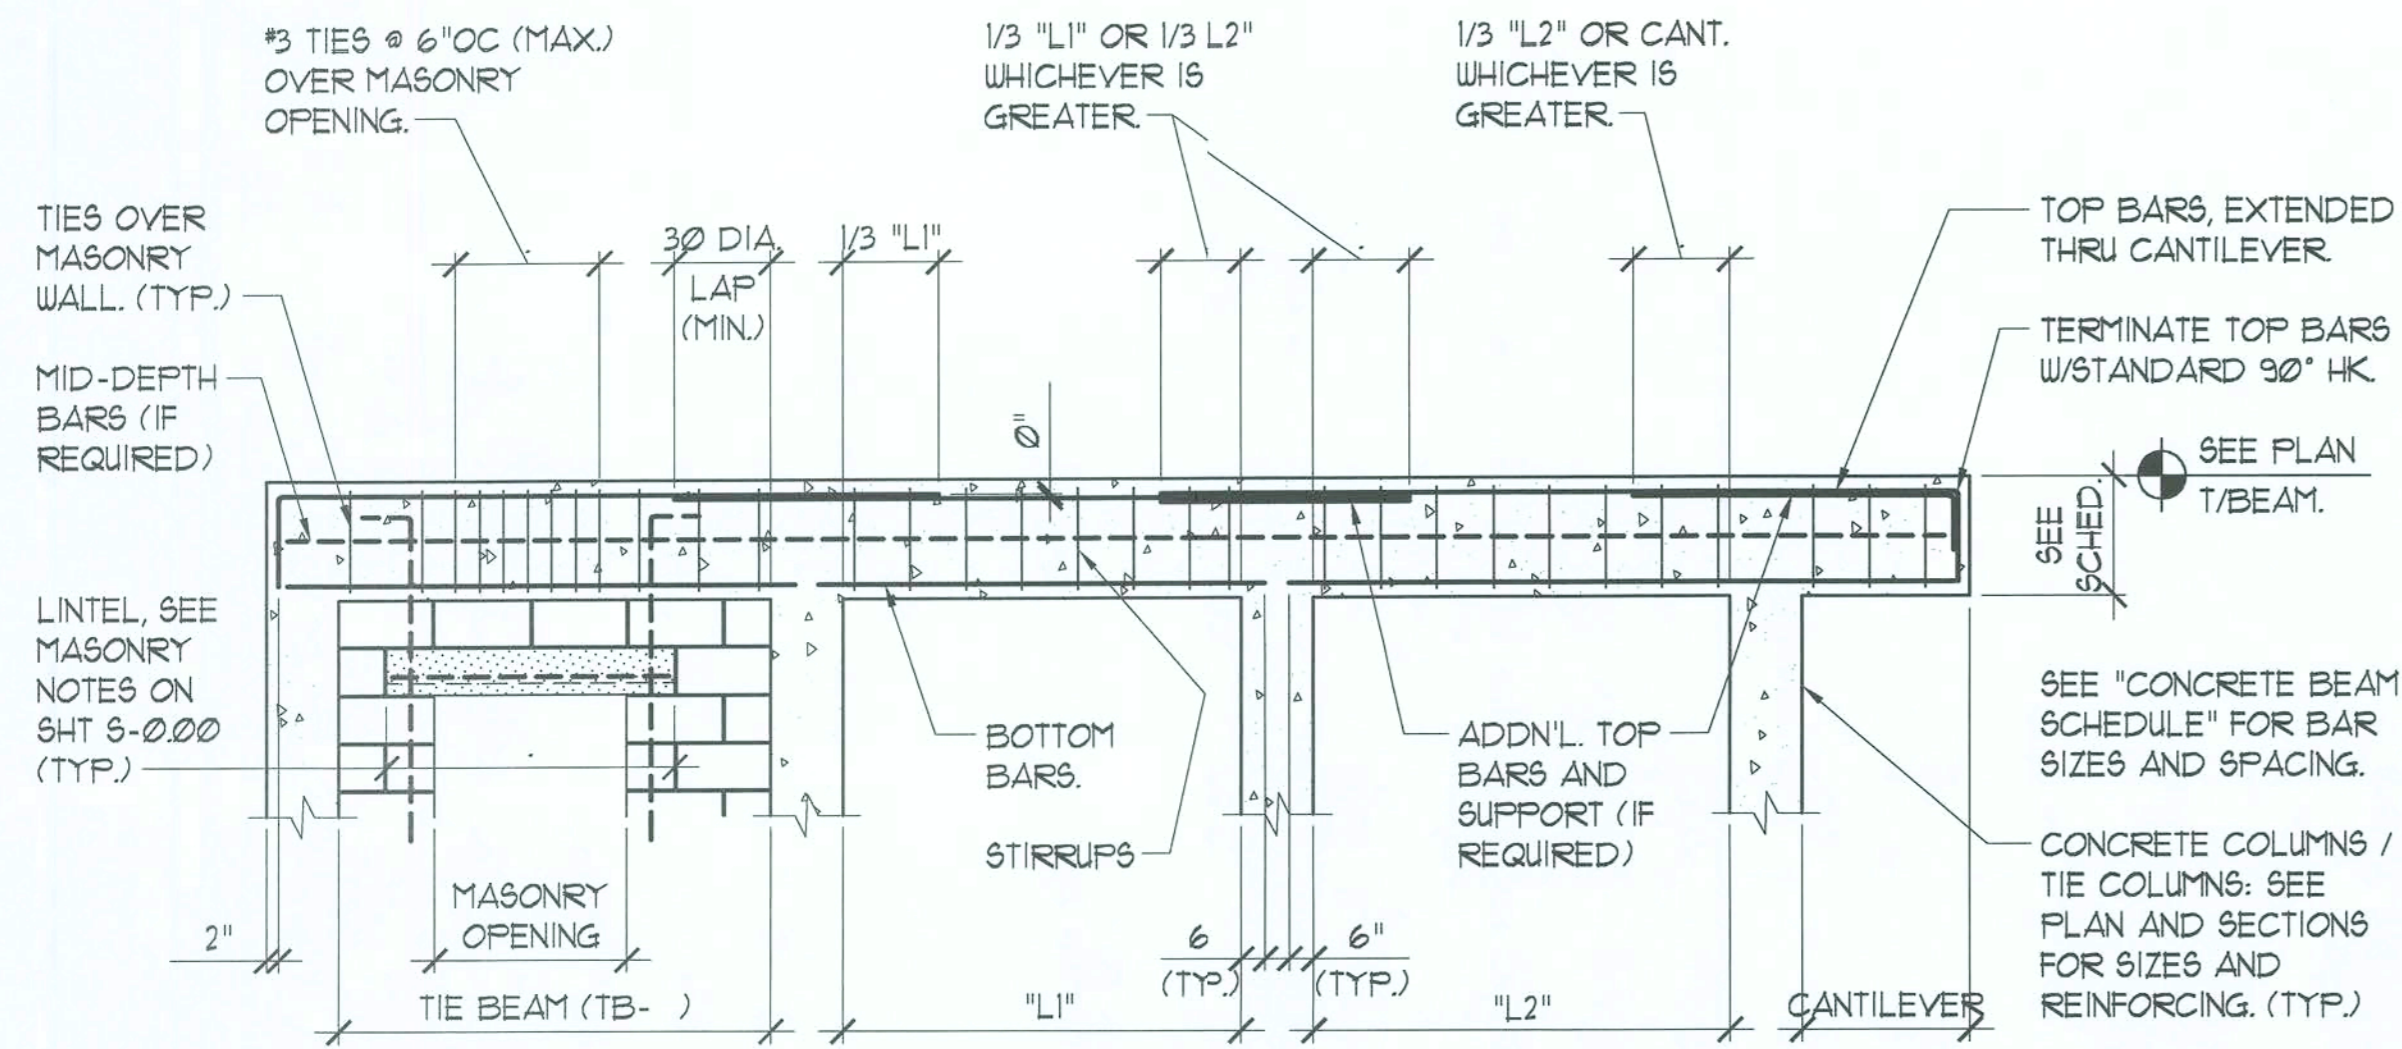
INTERIOR ELEVATION KEY

MARK DATE REVISIONS

COMM. N.L. 06/03/00 IRWIN S.L.
DATE: 02/15/06 CHECKED: V.M.M.
SCALE: AS NOTED
FILE: 10060758.01

SECTIONS AND DETAILS

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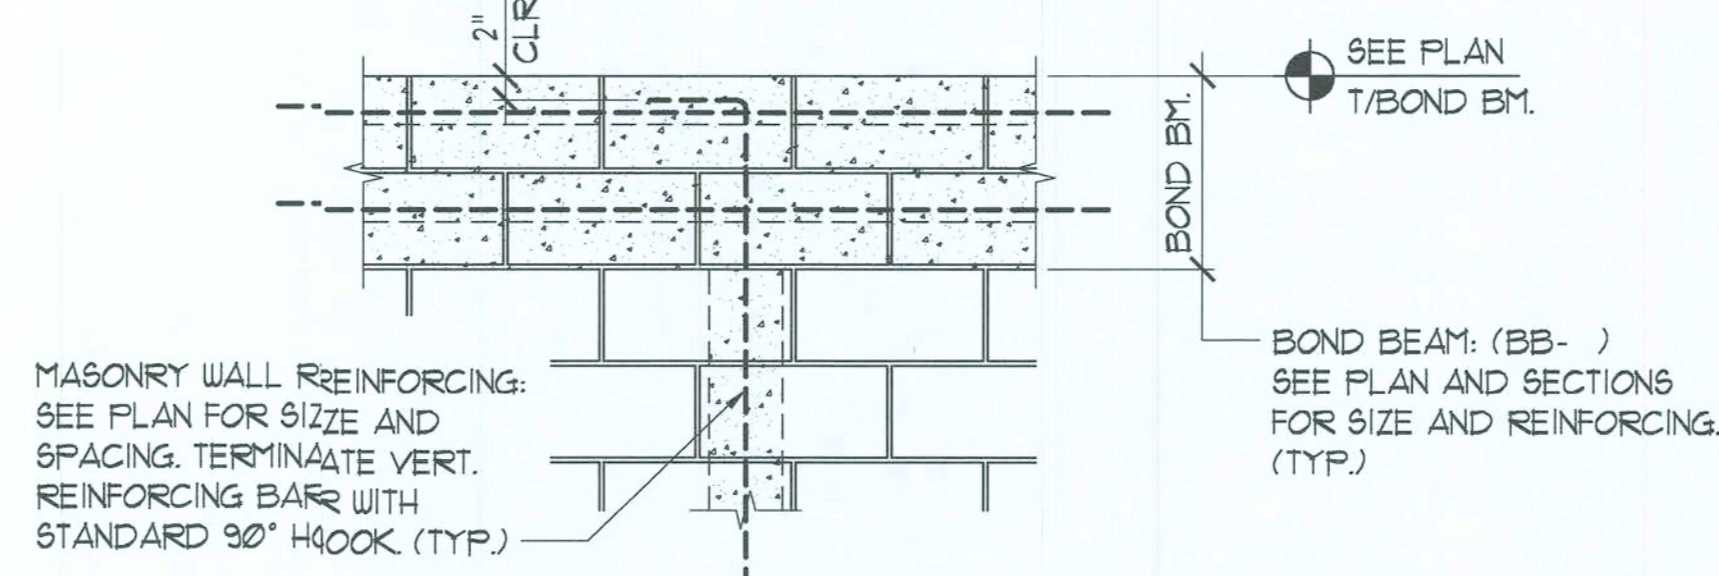


CONCRETE BEAM DIAGRAM
NOT TO SCALE

CONCRETE BEAM SCHEDULE							
MARK	S I Z E S (W x D)	REINFORCING			STIRRUPS		REMARKS
		BOT. BARS	TOP BARS	11D BAR	SIZE	SPACING	
CB-1	8"x21"	(2)-#5	(2)-#5	-	#3	@ 8" O.C.	SEE SEC. 3/5-8.02
-	-	-	-	-	-	-	-
-	-	-	-	-	-	-	-
-	-	-	-	-	-	-	-
-	-	-	-	-	-	-	-

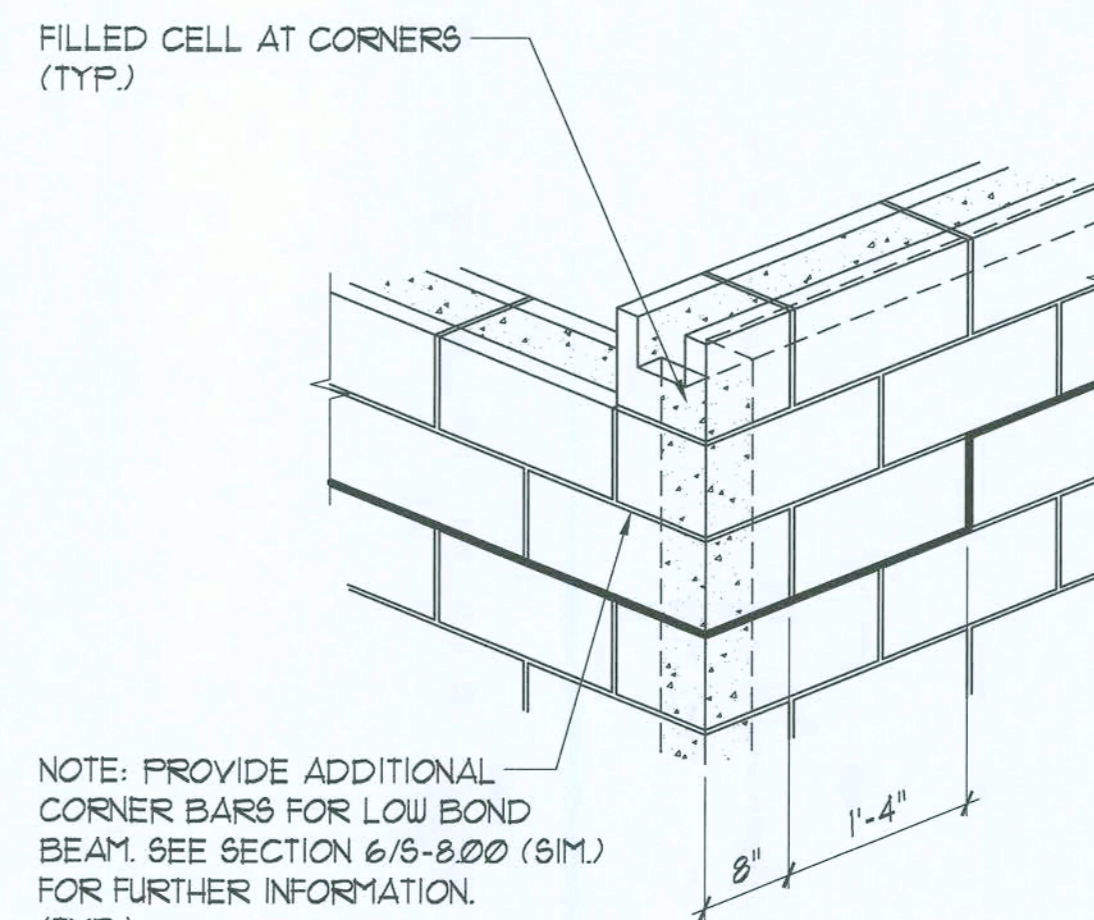
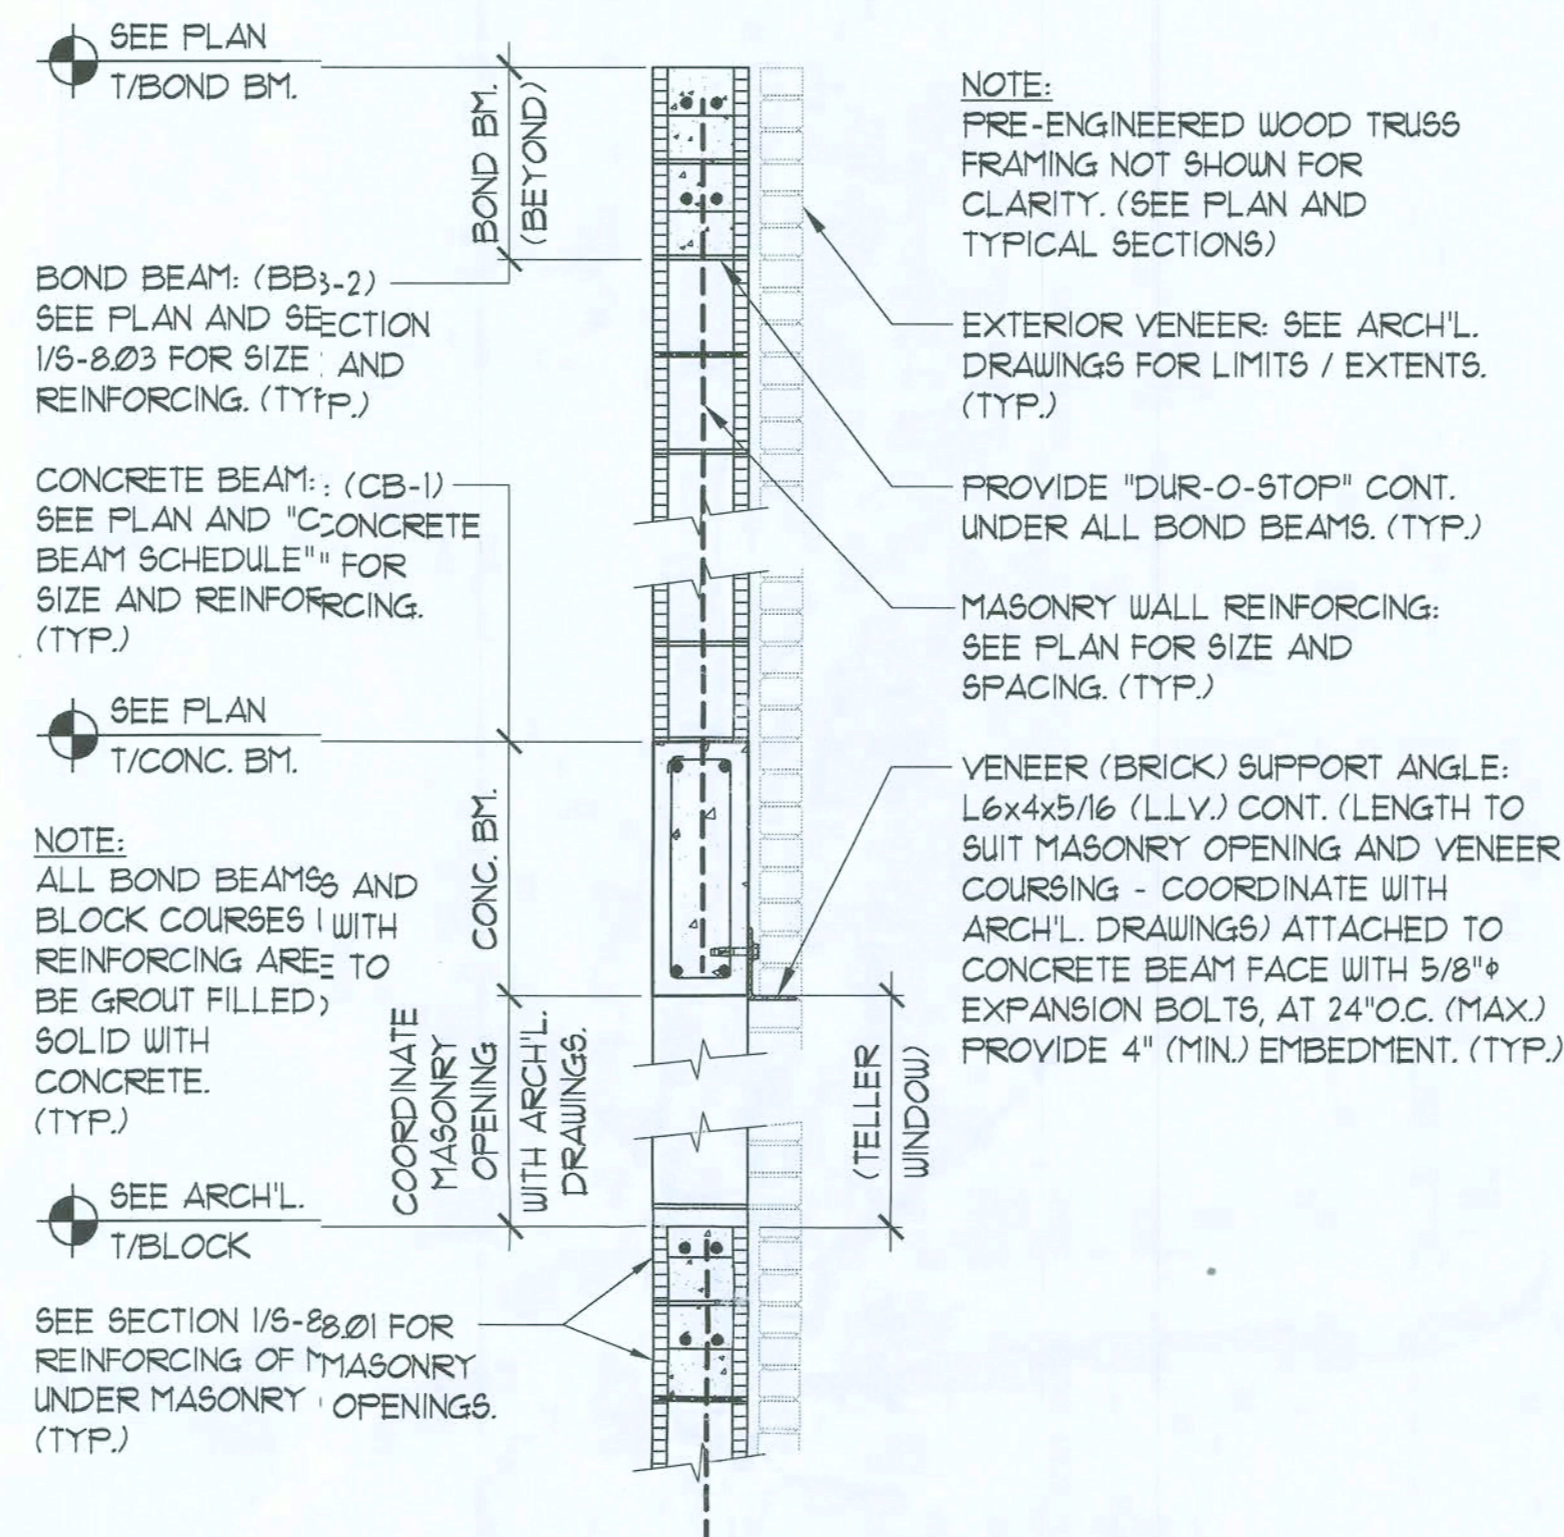
NOTE:

- ALL CONCRETE BEAMS (CB-) TO HAVE A MINIMUM OF 8" END BEARING ONTO MASONRY WALLS, TYPICAL AT EACH END.



2 TERMINATION OF FILLED CELL (VERT.) BARS

3/4" = 1'-0"




NOTE: PROVIDE ADDITIONAL CORNER BARS FOR LOW BOND BEAM. SEE SECTION 6/5-8.02 (SIM) FOR FURTHER INFORMATION. (TYP.)

CORNER VIEW

GENERAL CONTRACTOR TO COORDINATE LOCATION OF STEP IN BOND BEAM (CHANGE IN ELEVATIONS) TO SUIT BLOCK COURSING. (TYP.)

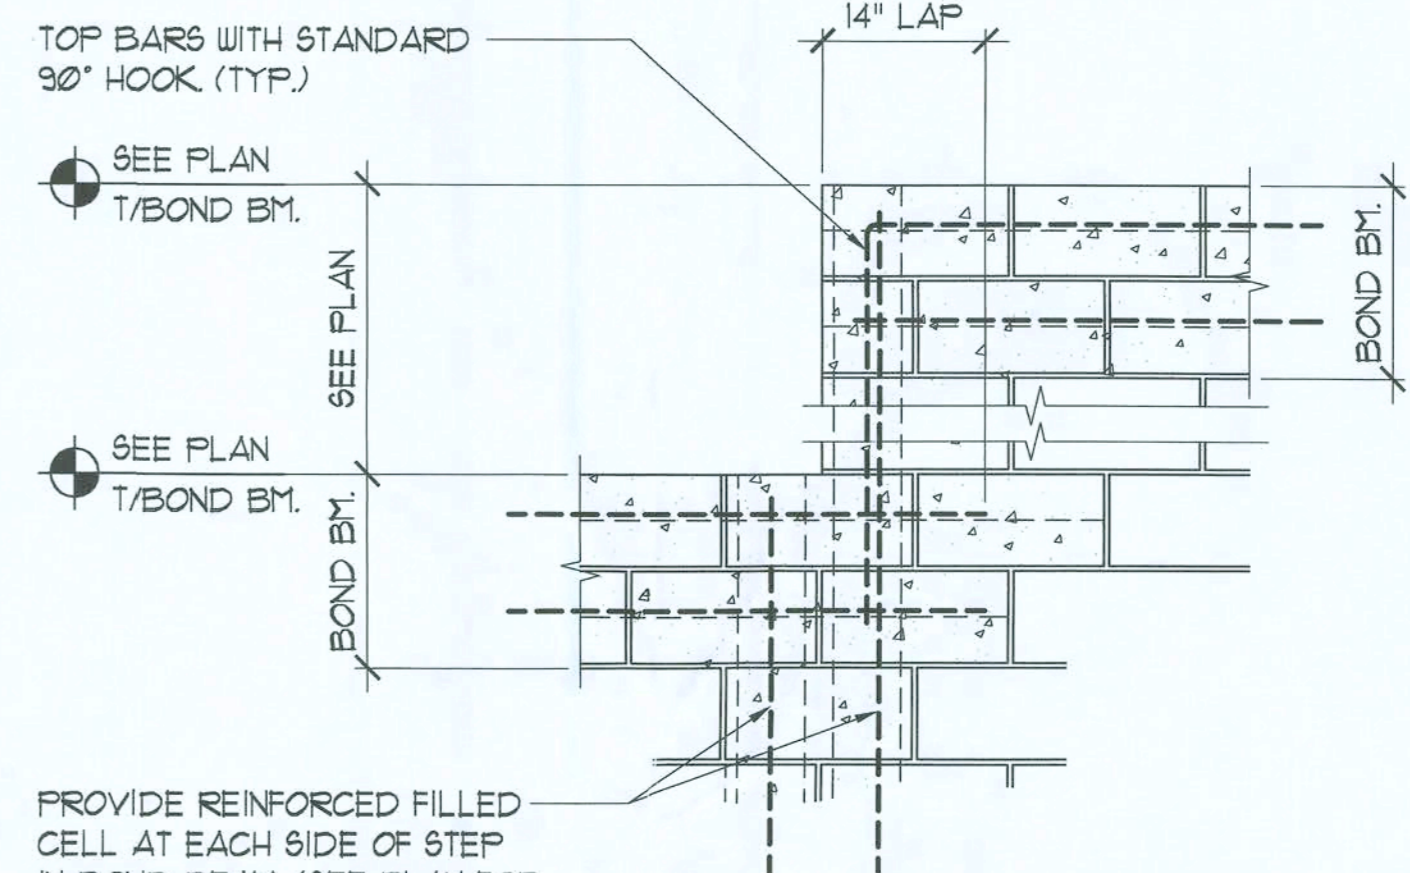BOND BEAM: SEE PLAN AND "CONCRETE BEAM SCHEDULE" FOR SIZE AND REINFG. (TYP.)



ELEVATION VIEW

PROVIDE REINFORCED FILLED CELL AT EACH SIDE OF STEP IN BOND BEAM. (SEE PLAN FOR TYP. FILLED CELL REINFORCING INFORMATION AND LOCATIONS) TYP.

1 CONCRETE BEAM SCHEDULE

3/4" = 1'-0"

3 MASONRY OPENING DETAIL

3/4" = 1'-0"

4 STEPPED BOND BEAM DETAIL

3/4" = 1'-0"

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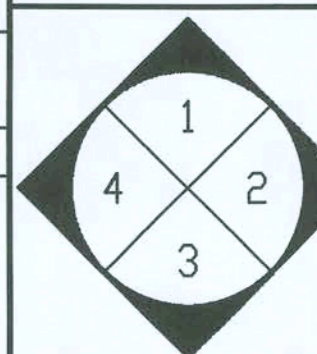
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ARCHITECTURE
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SPACE PLANNING

GENERAL NOTES



INTERIOR
ELEVATION
KEY




NORTH
ACTUAL
PLAN

MARK	DATE	REVISIONS

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DATE	02/15/06	CHECKED	W.M.
SCALE	AS NOTED		
FILE	2006-075602		
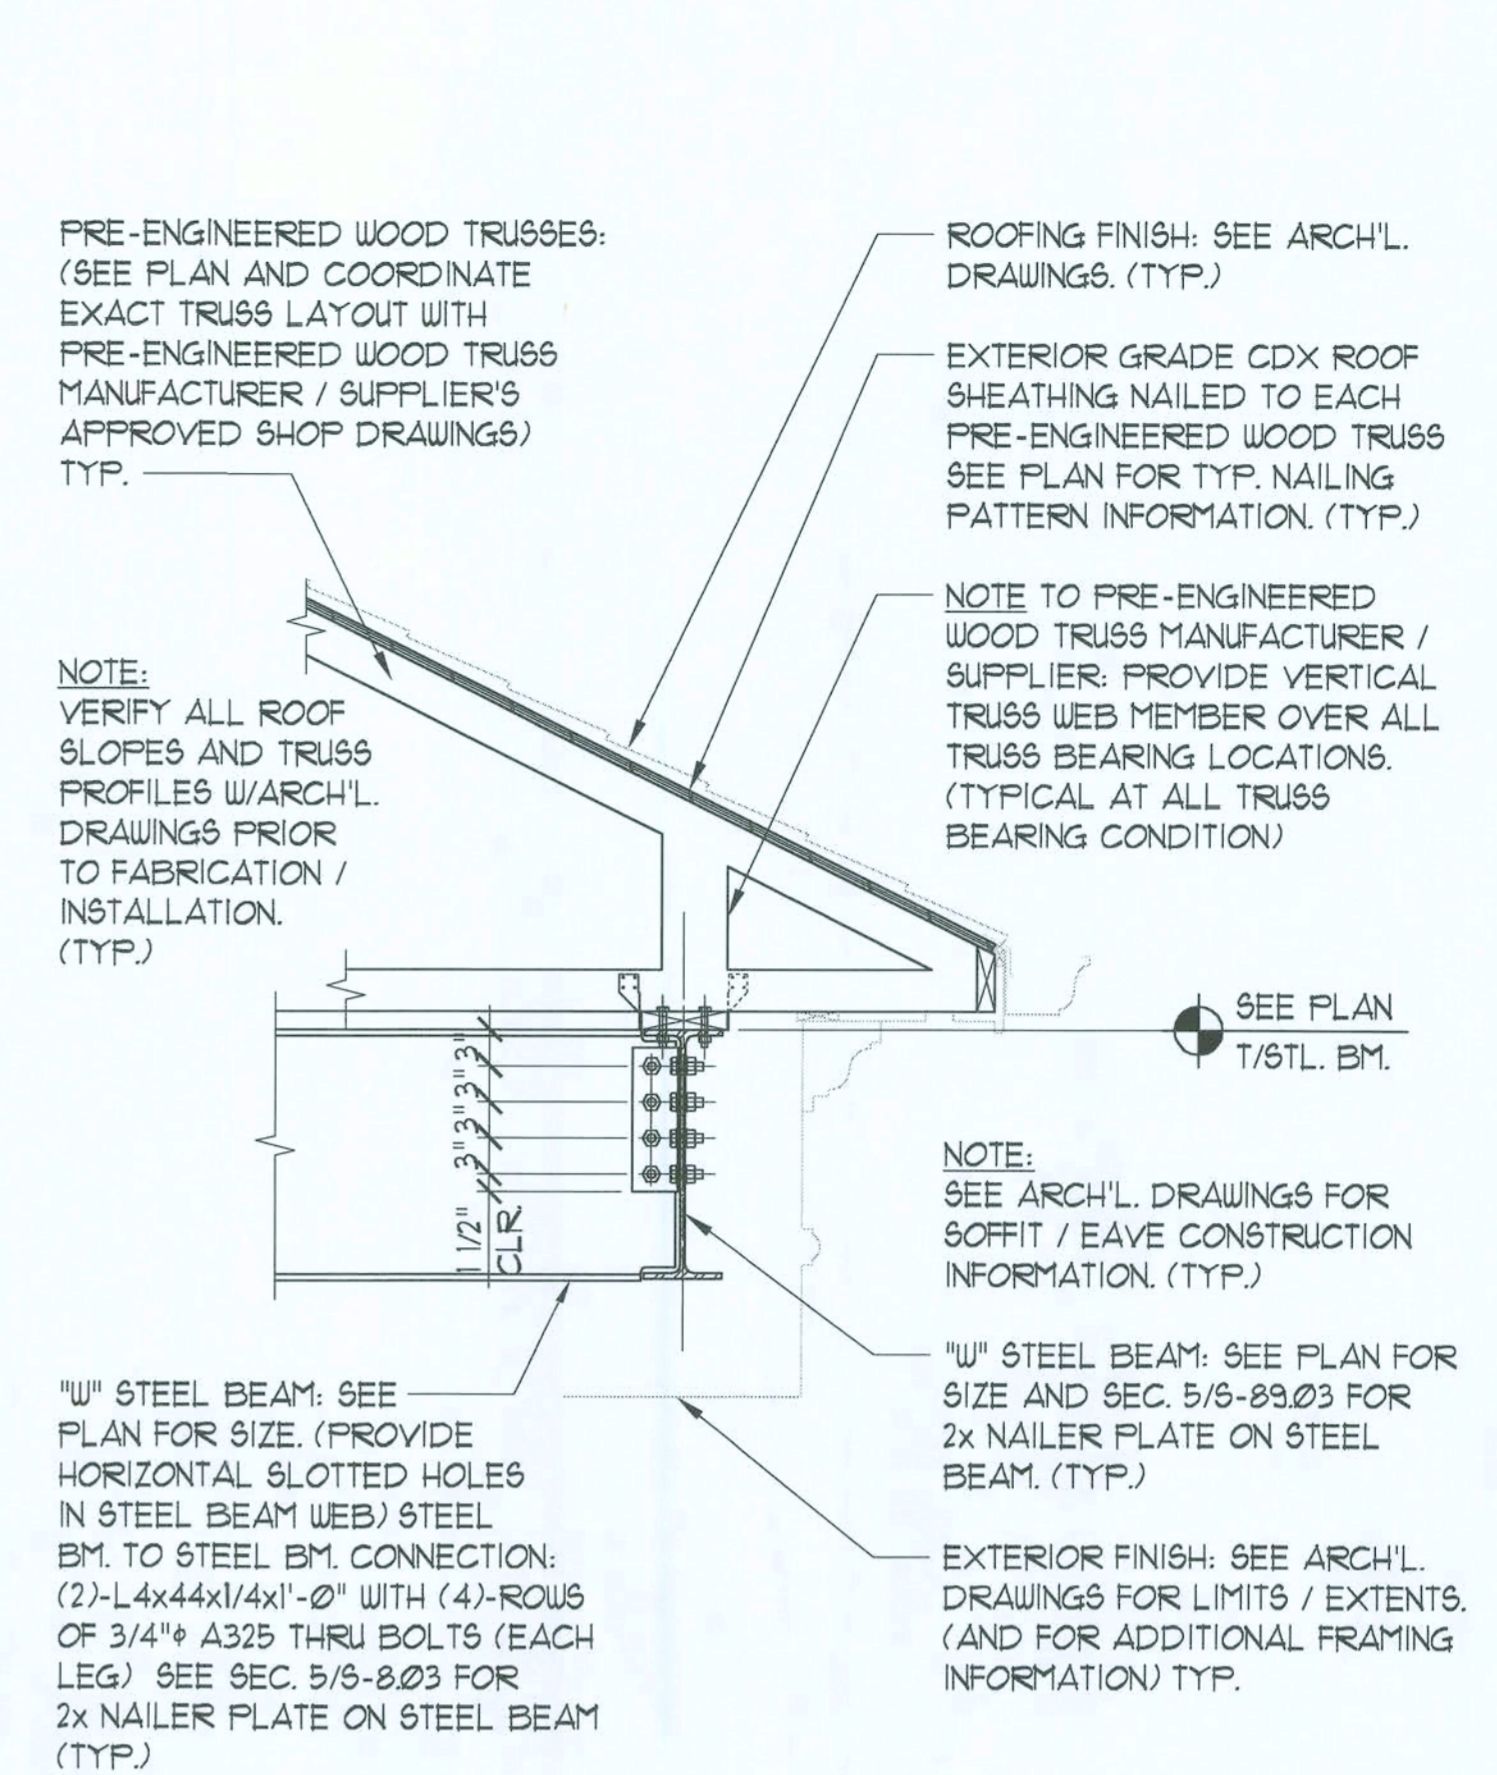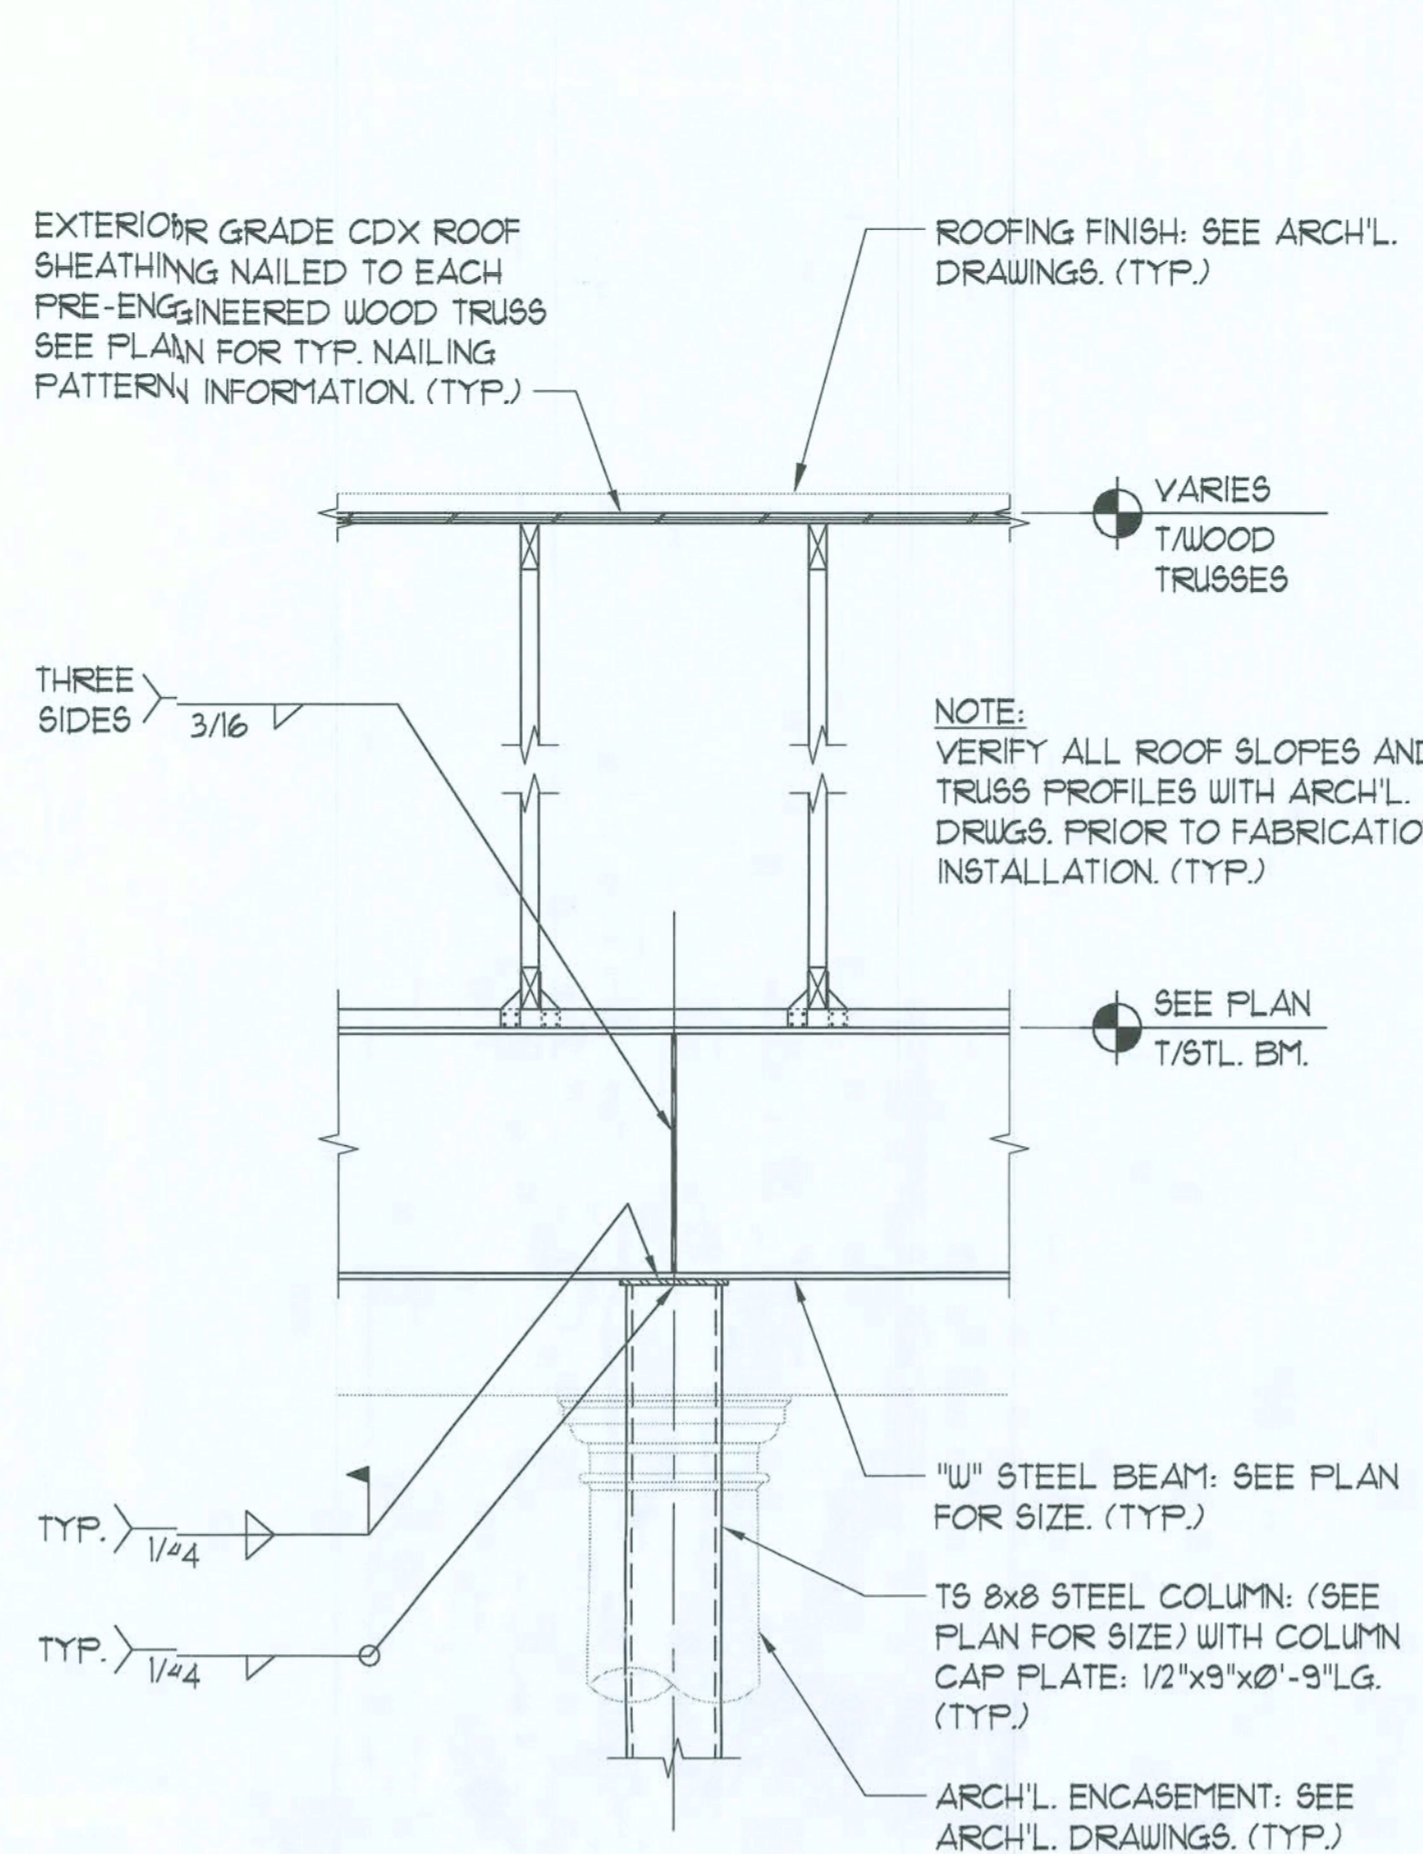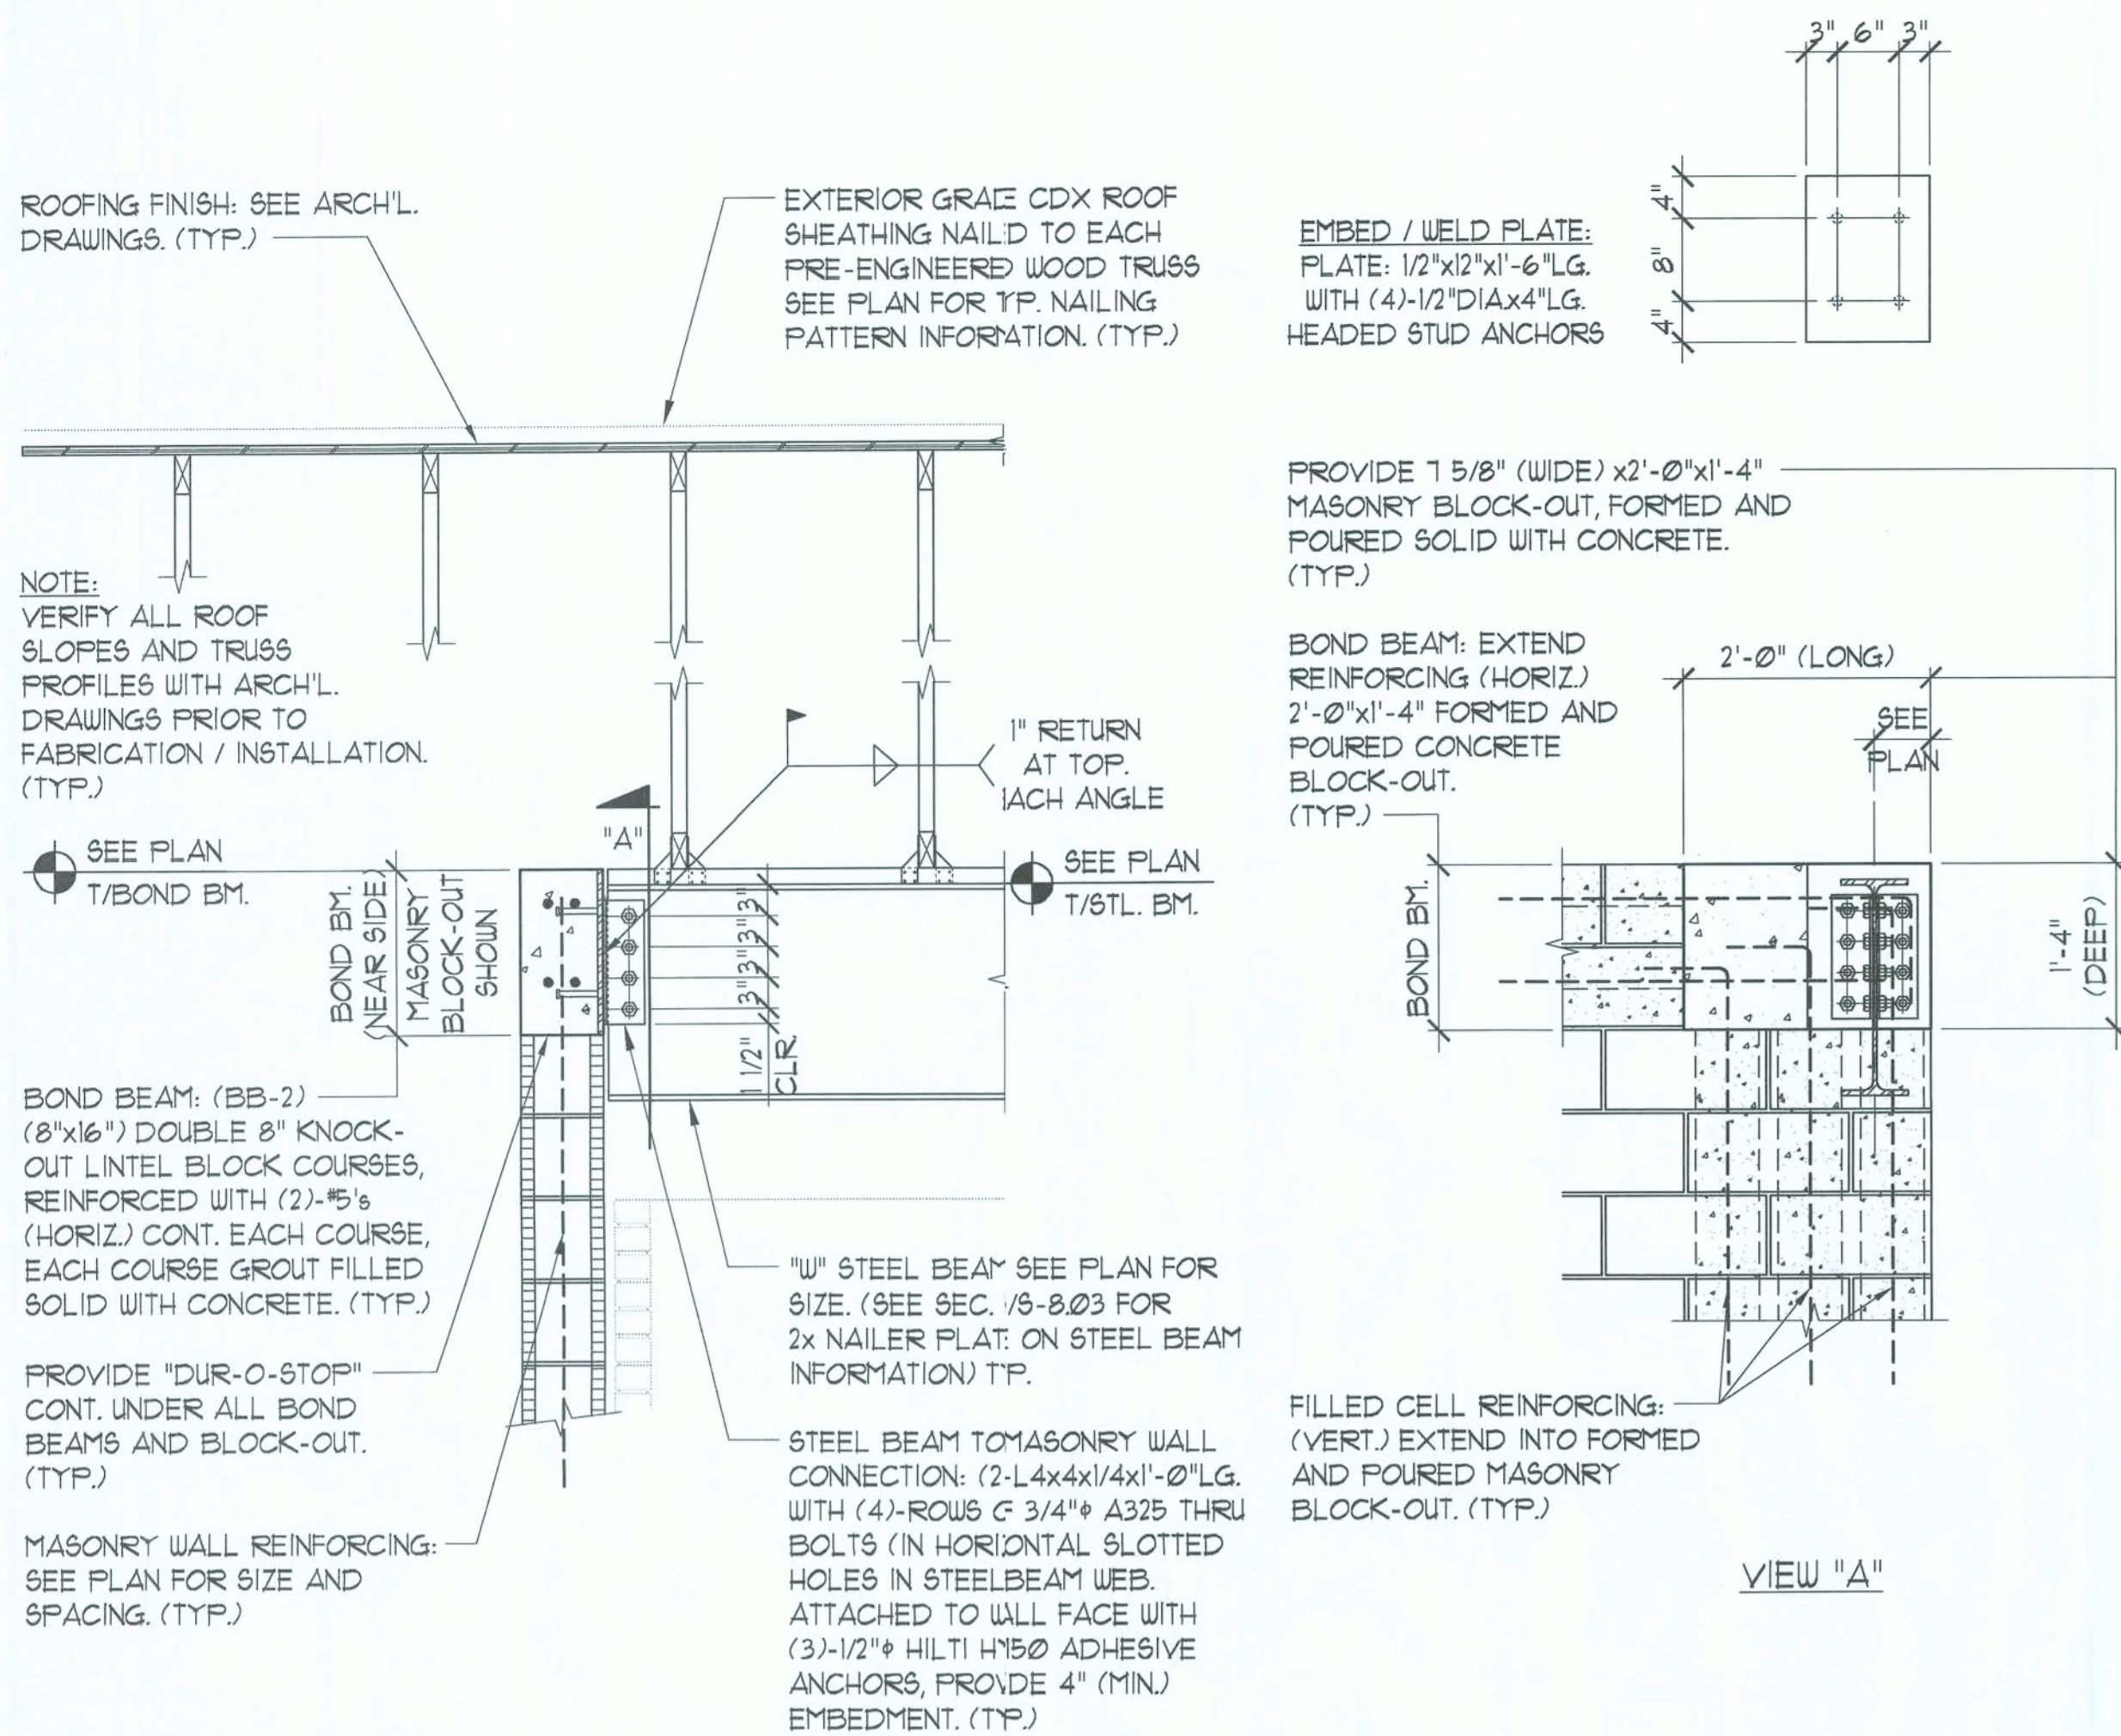
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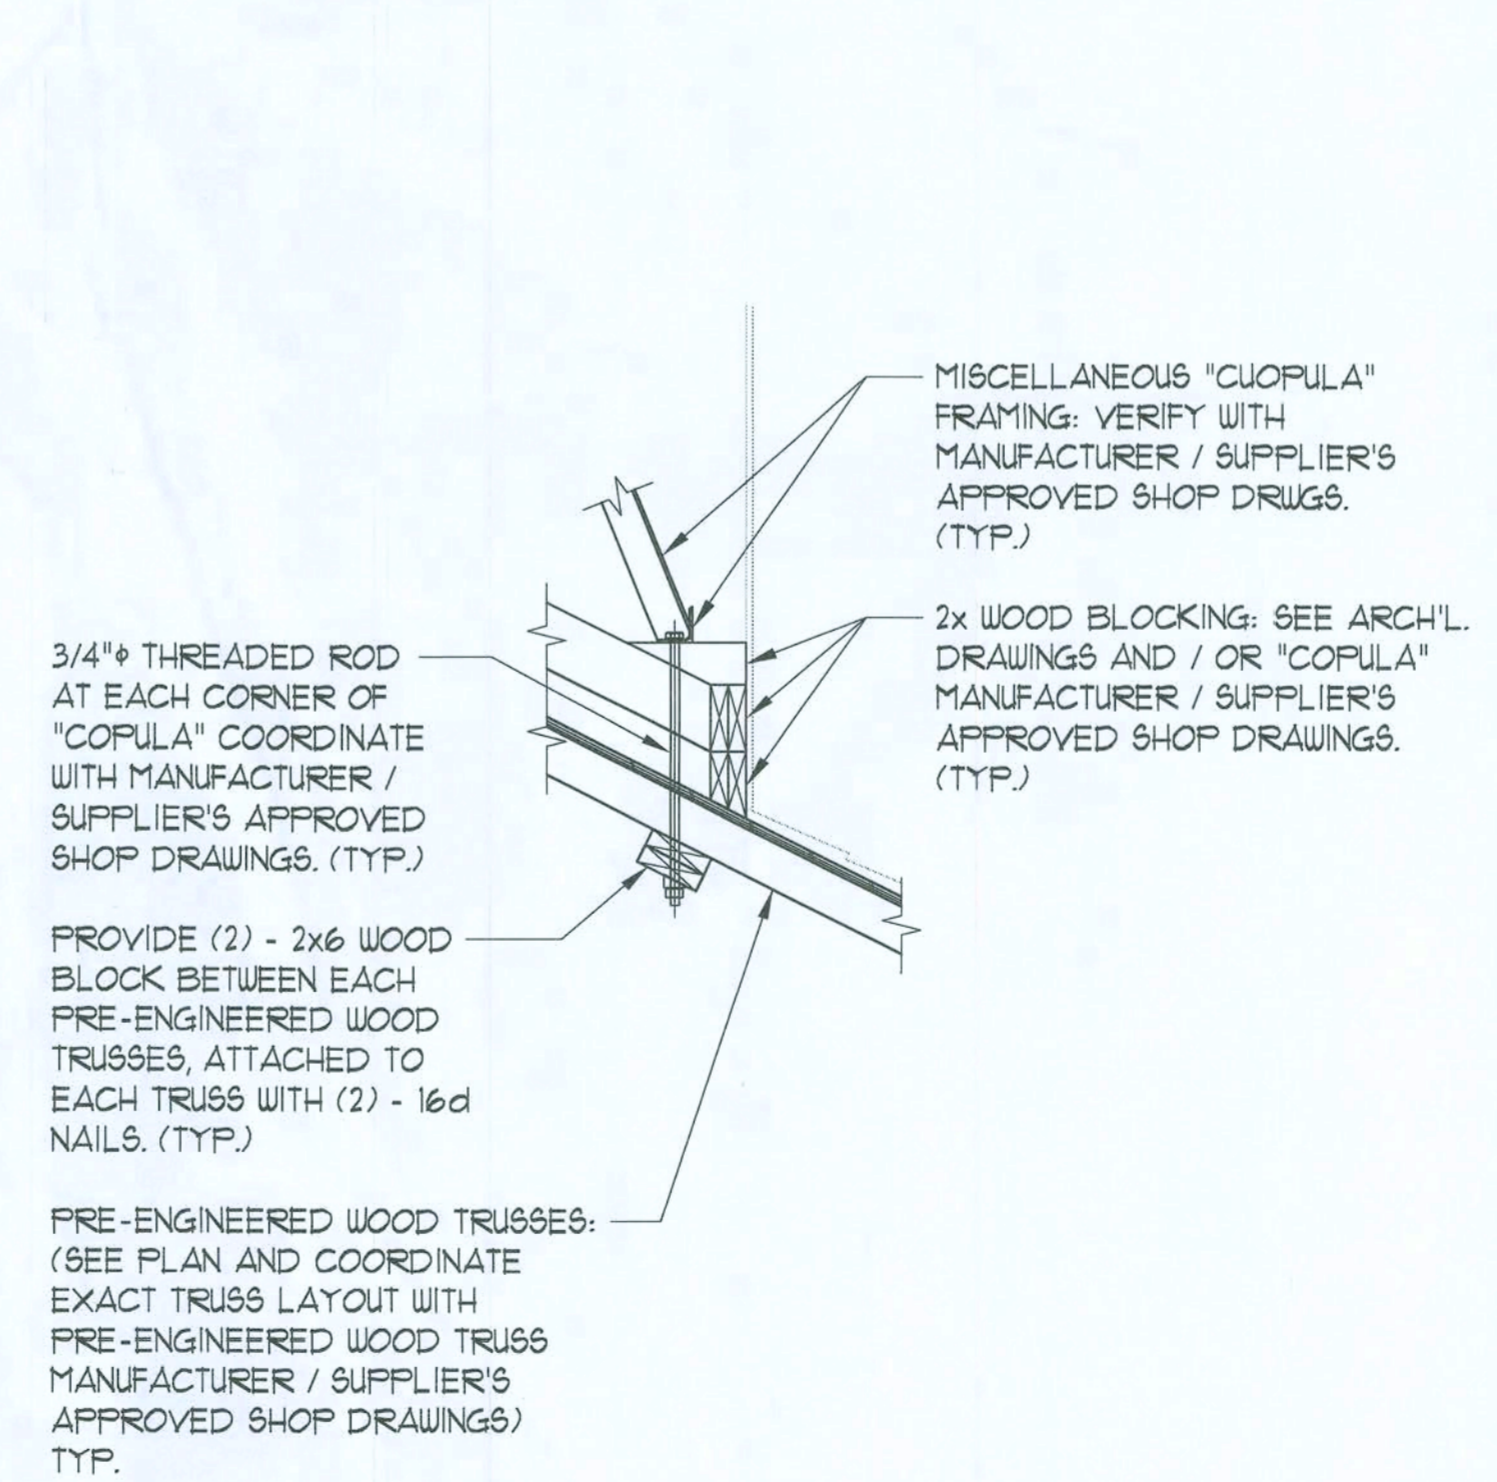
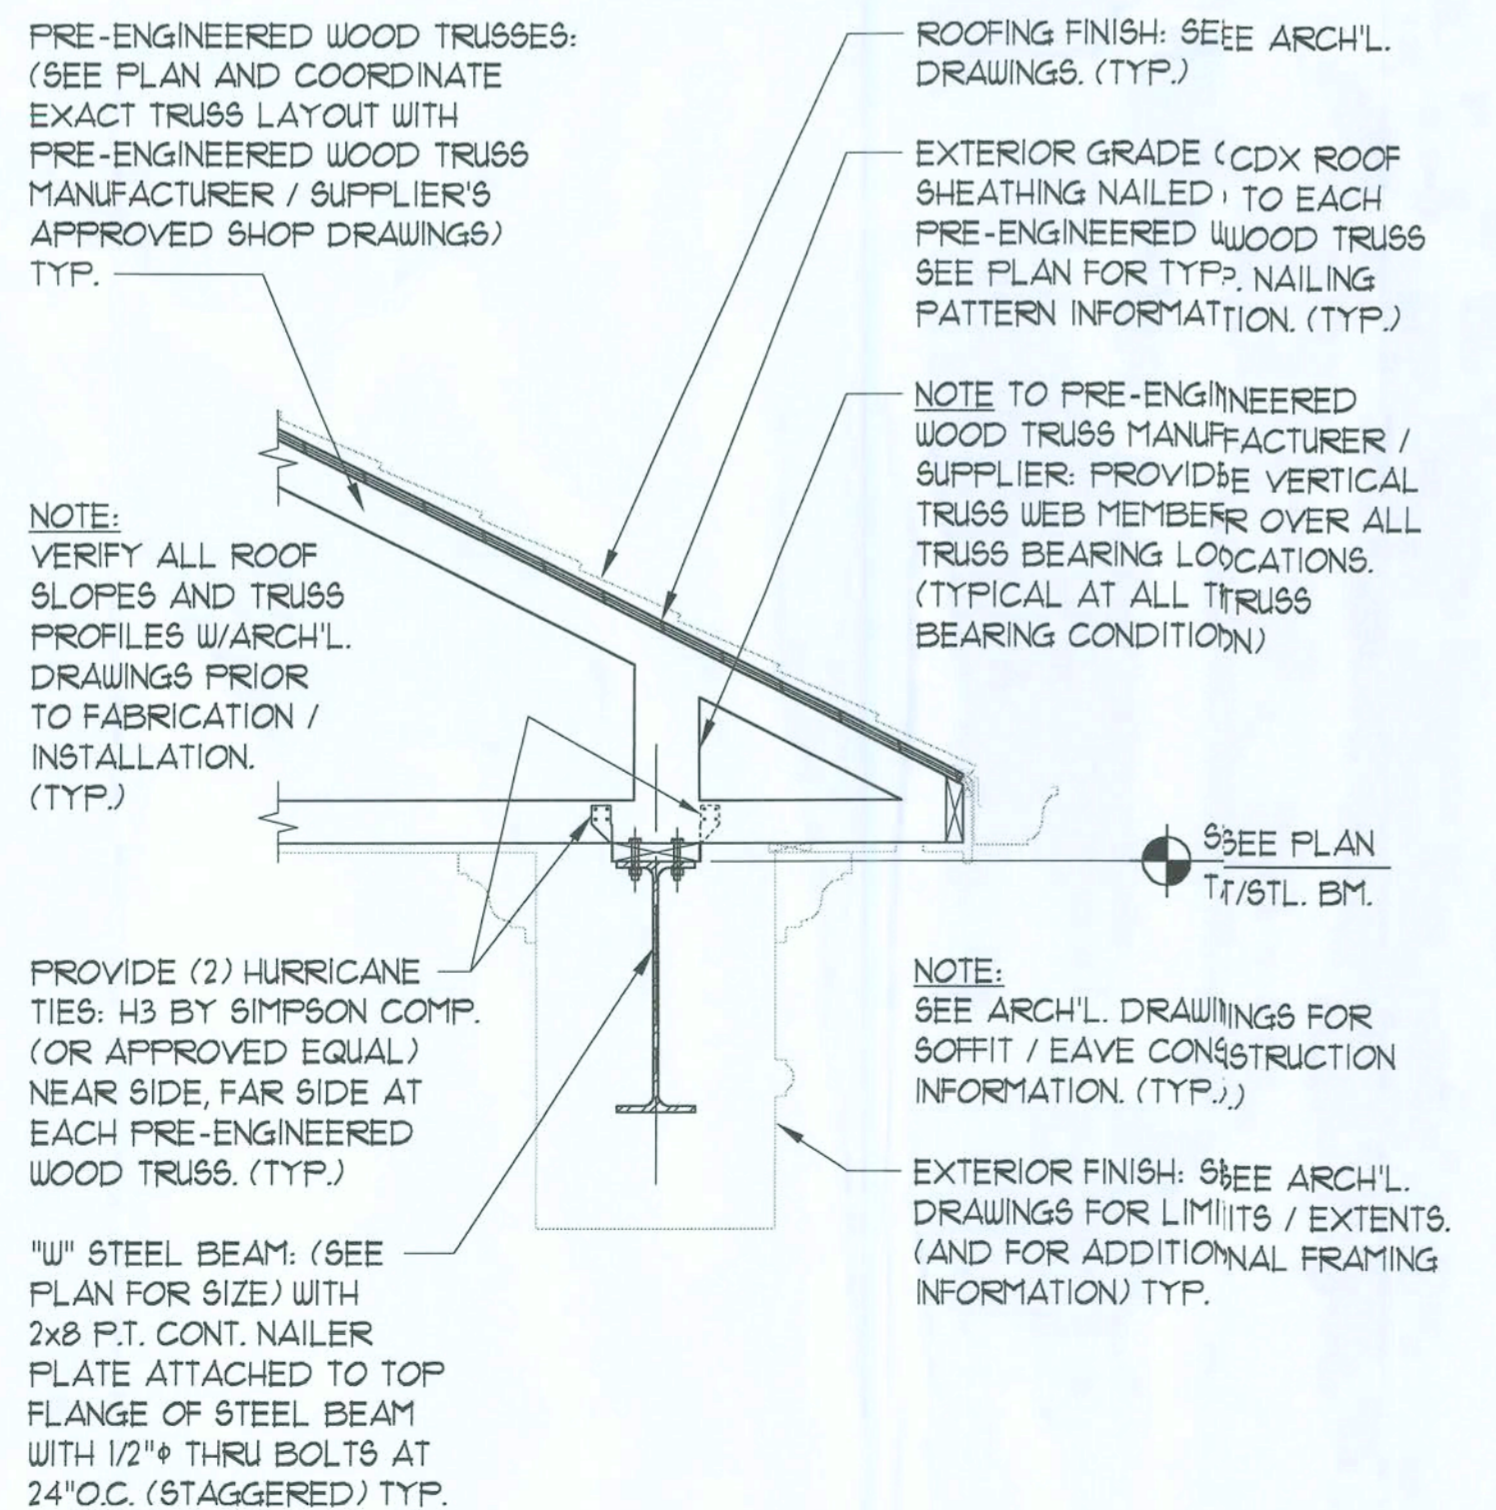
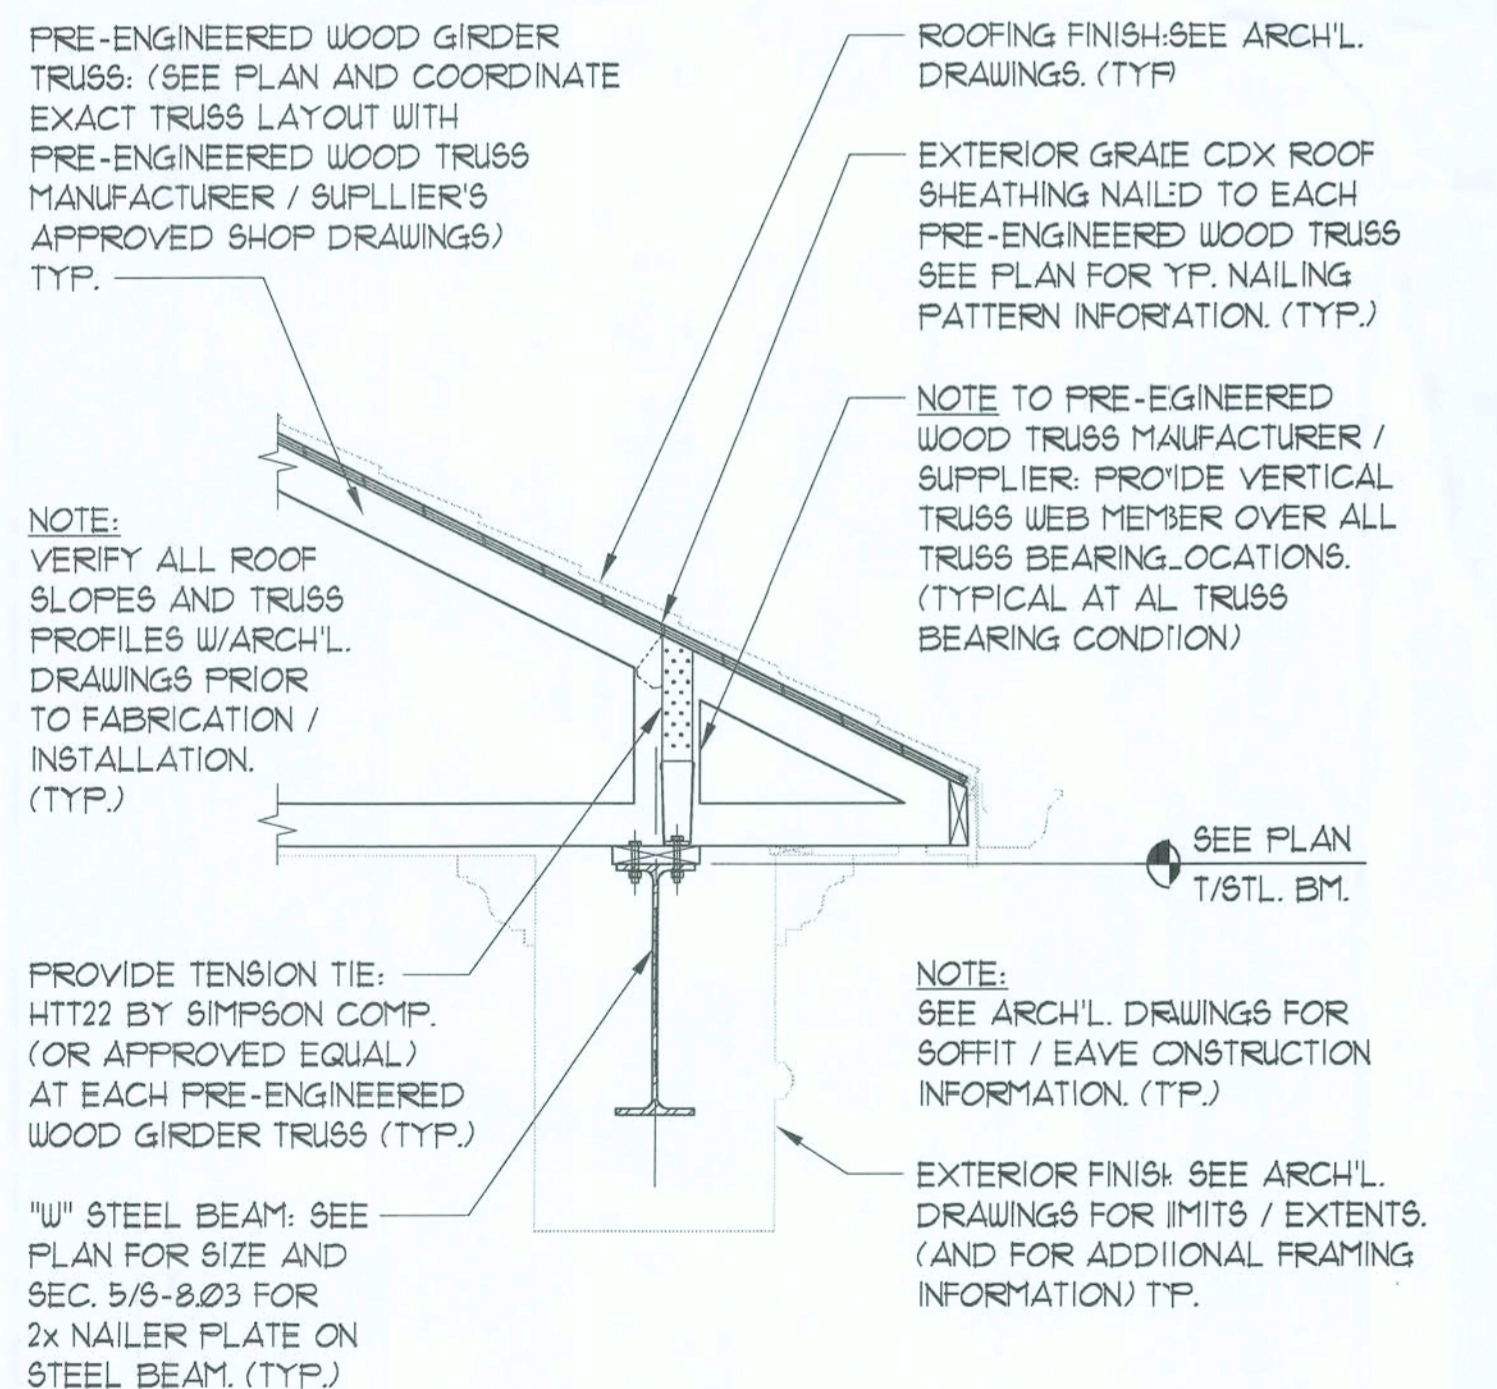
SEAL	ARCHITECT/CONSULTANT
MITZO ENGINEERING, LLC STRUCTURAL CONSULTANTS 870 NORTH ORLANDO AVE., SUITE 100A MAITLAND, FLORIDA 32751 PHONE: (407) 644-1000 FAX: (407) 644-1555	SHEET NUMBER
WILLIAM M. MITZO PROFESSIONAL ENGINEER FLORIDA REGISTRATION NUMBER: 27892	3-8.02



1 STEEL BEAM TO MASONRY WALL CONN.
3/4" = 1'-0"

2 STEEL BEAM ON STEEL COL. CONN.
3/4" = 1'-0"

3 STEEL BEAM TO STEEL BEAM CONN.
3/4" = 1'-0"



4 GIRDER TRUSS TO STEEL BEAM
3/4" = 1'-0"

5 TRUSS TO STEEL BEAM
3/4" = 1'-0"

6 "COPULA" ANCHORING DETAIL
3/4" = 1'-0"

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STATE BANK

GENERAL NOTES

NORTH
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INTERIOR ELEVATION KEY

MARK	DATE	REVISIONS

CON. NO.	DATE	DRWN.	SL.

DATE	CHECKED	W.M.

SCALE	AS NOTED


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	<p>MITRO ENGINEERING, LLC STRUCTURAL CONSULTANTS 670 NORTH ORLANDO AVE., SUITE 100A ORLANDO, FLORIDA 32731 PHONE: (407) 844-1000 FAX: (407) 844-1002</p>
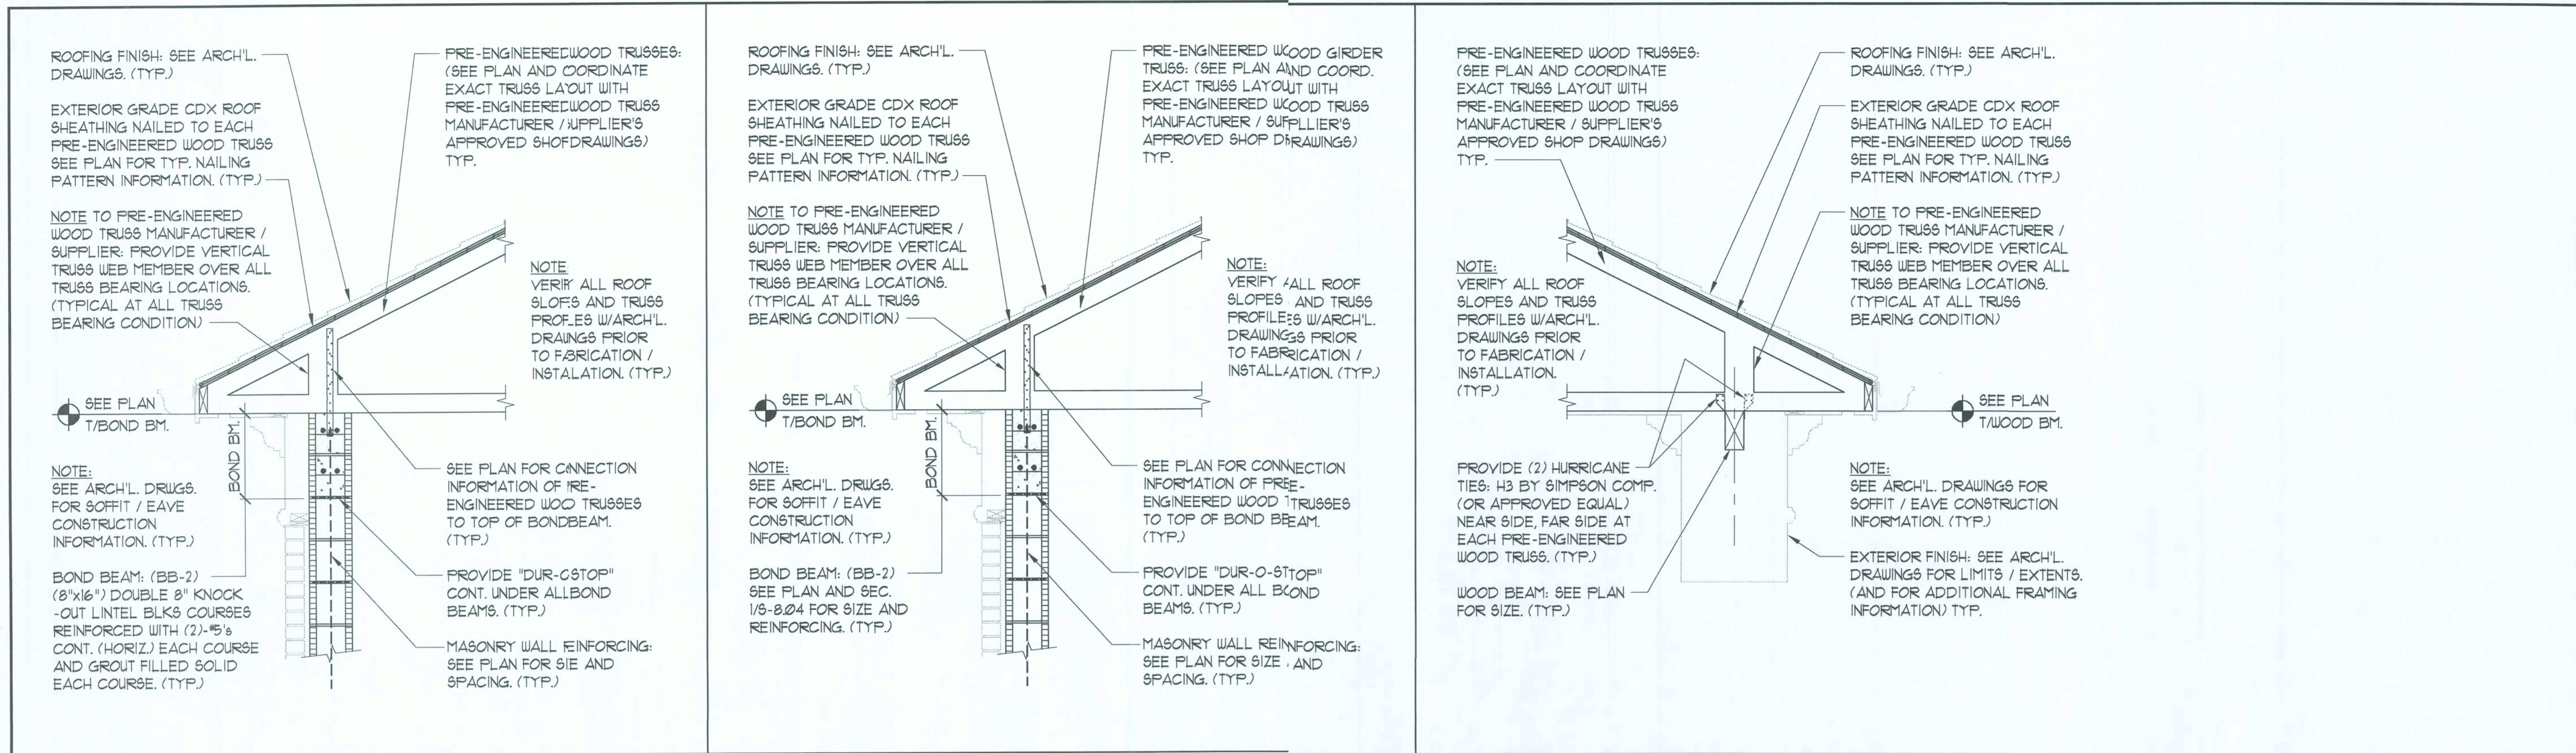
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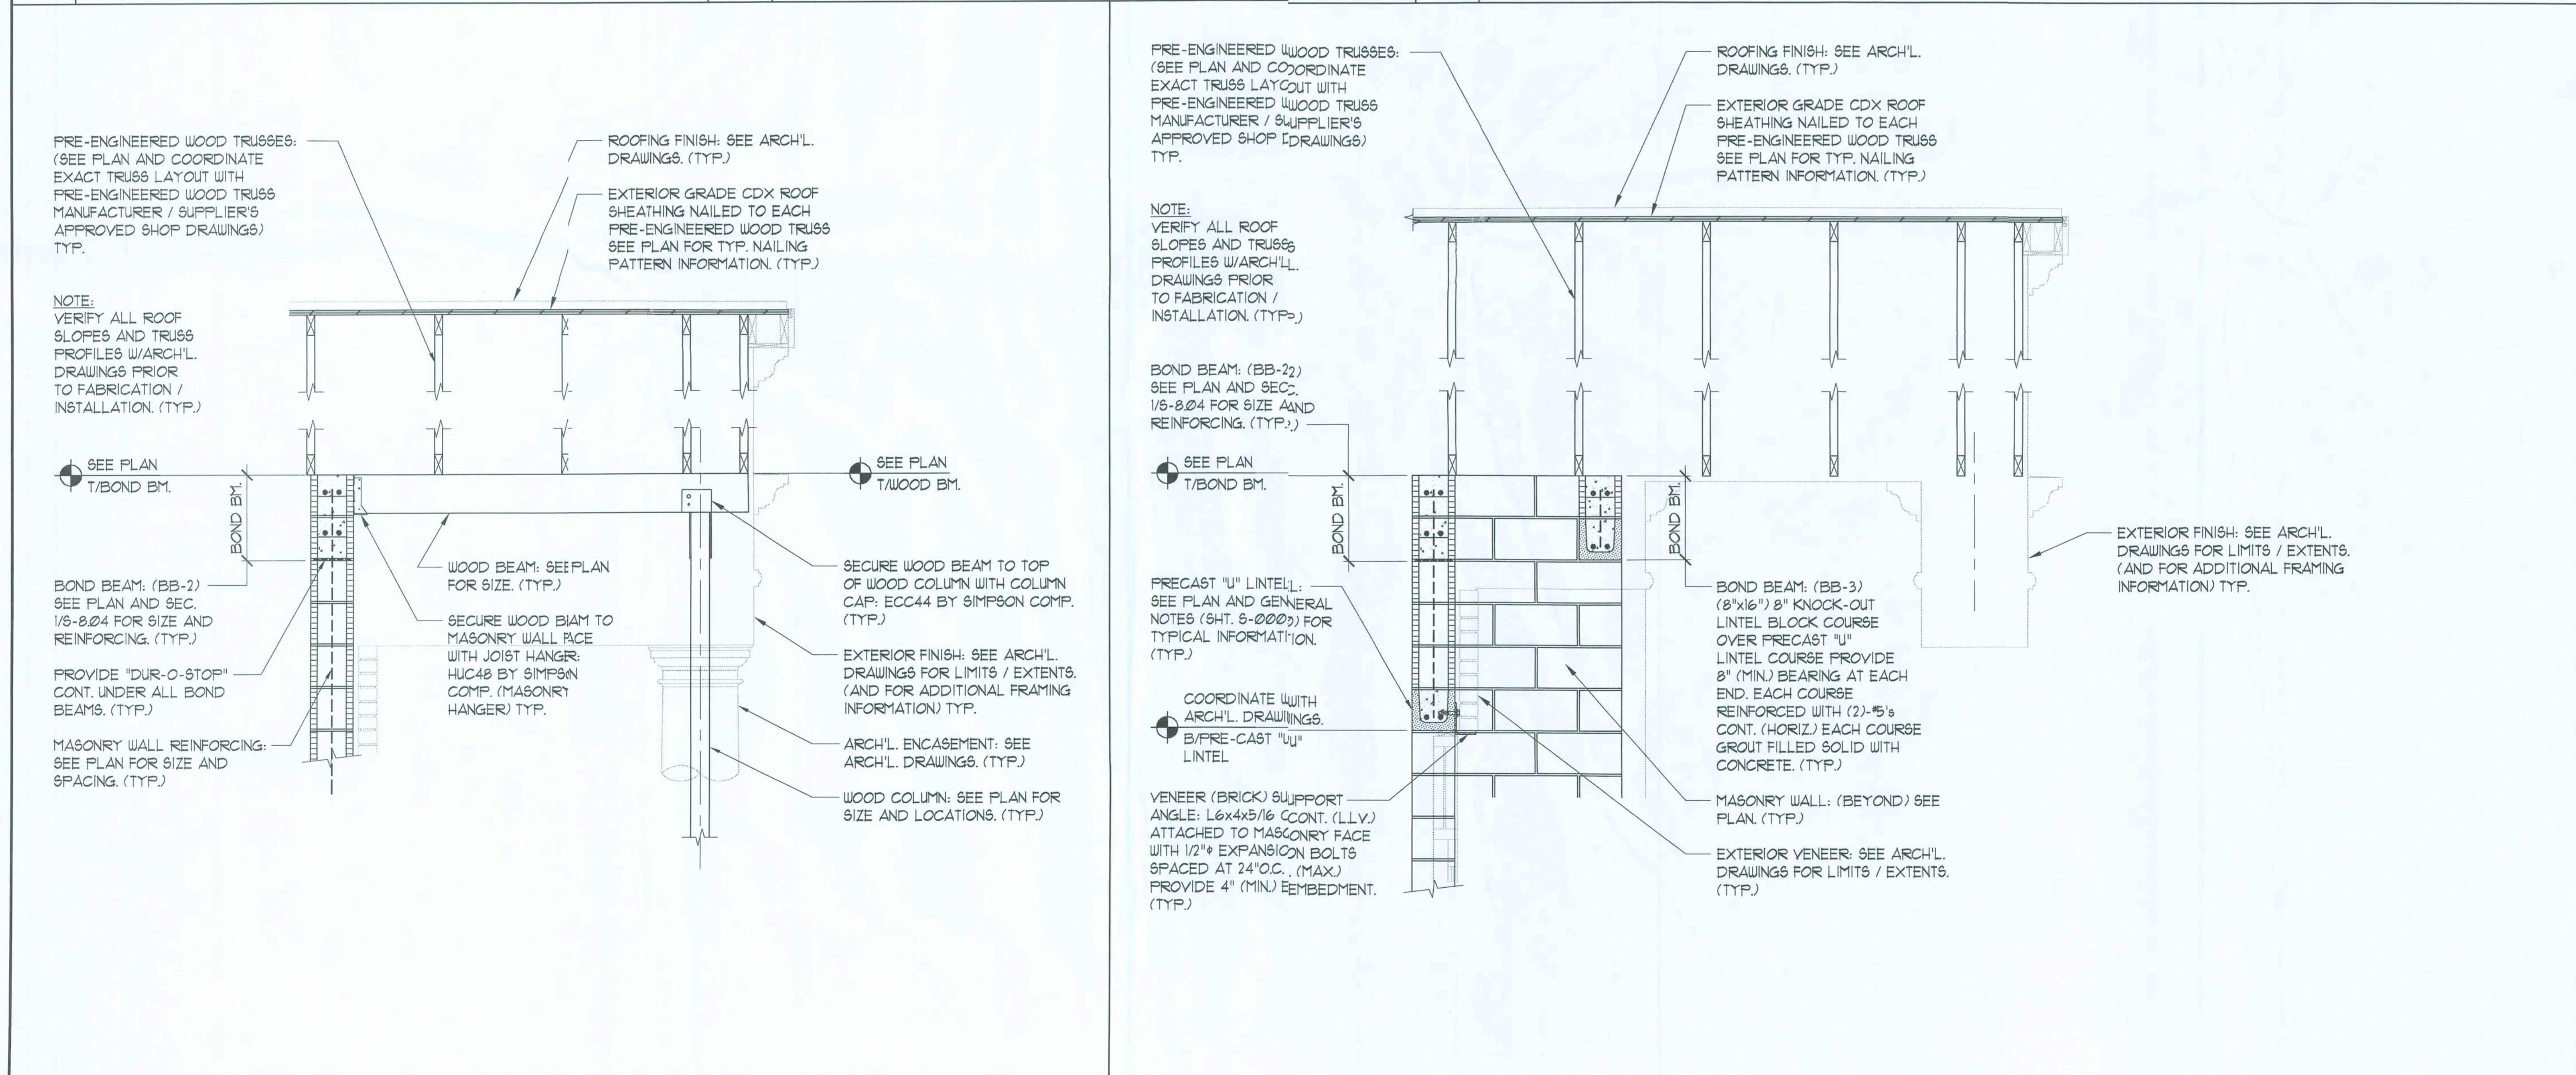
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1 TRUSS ON MASONRY WALL 3/4" = 1'-0"

2 GIRDER TRUSS ON MASONRY WALL 3/4" = 1'-0"

3 TRUSS ON WOOD BEAM 3/4" = 1'-0"



4 WOOD BEAM TO MASONRY WALL 3/4" = 1'-0"

5 SECTION 3/4" = 1'-0"

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DATE: 02/15/06 CHECKED W.M.

SCALE: AS NOTED

FILE: 2006045804

SECTIONS AND DETAILS

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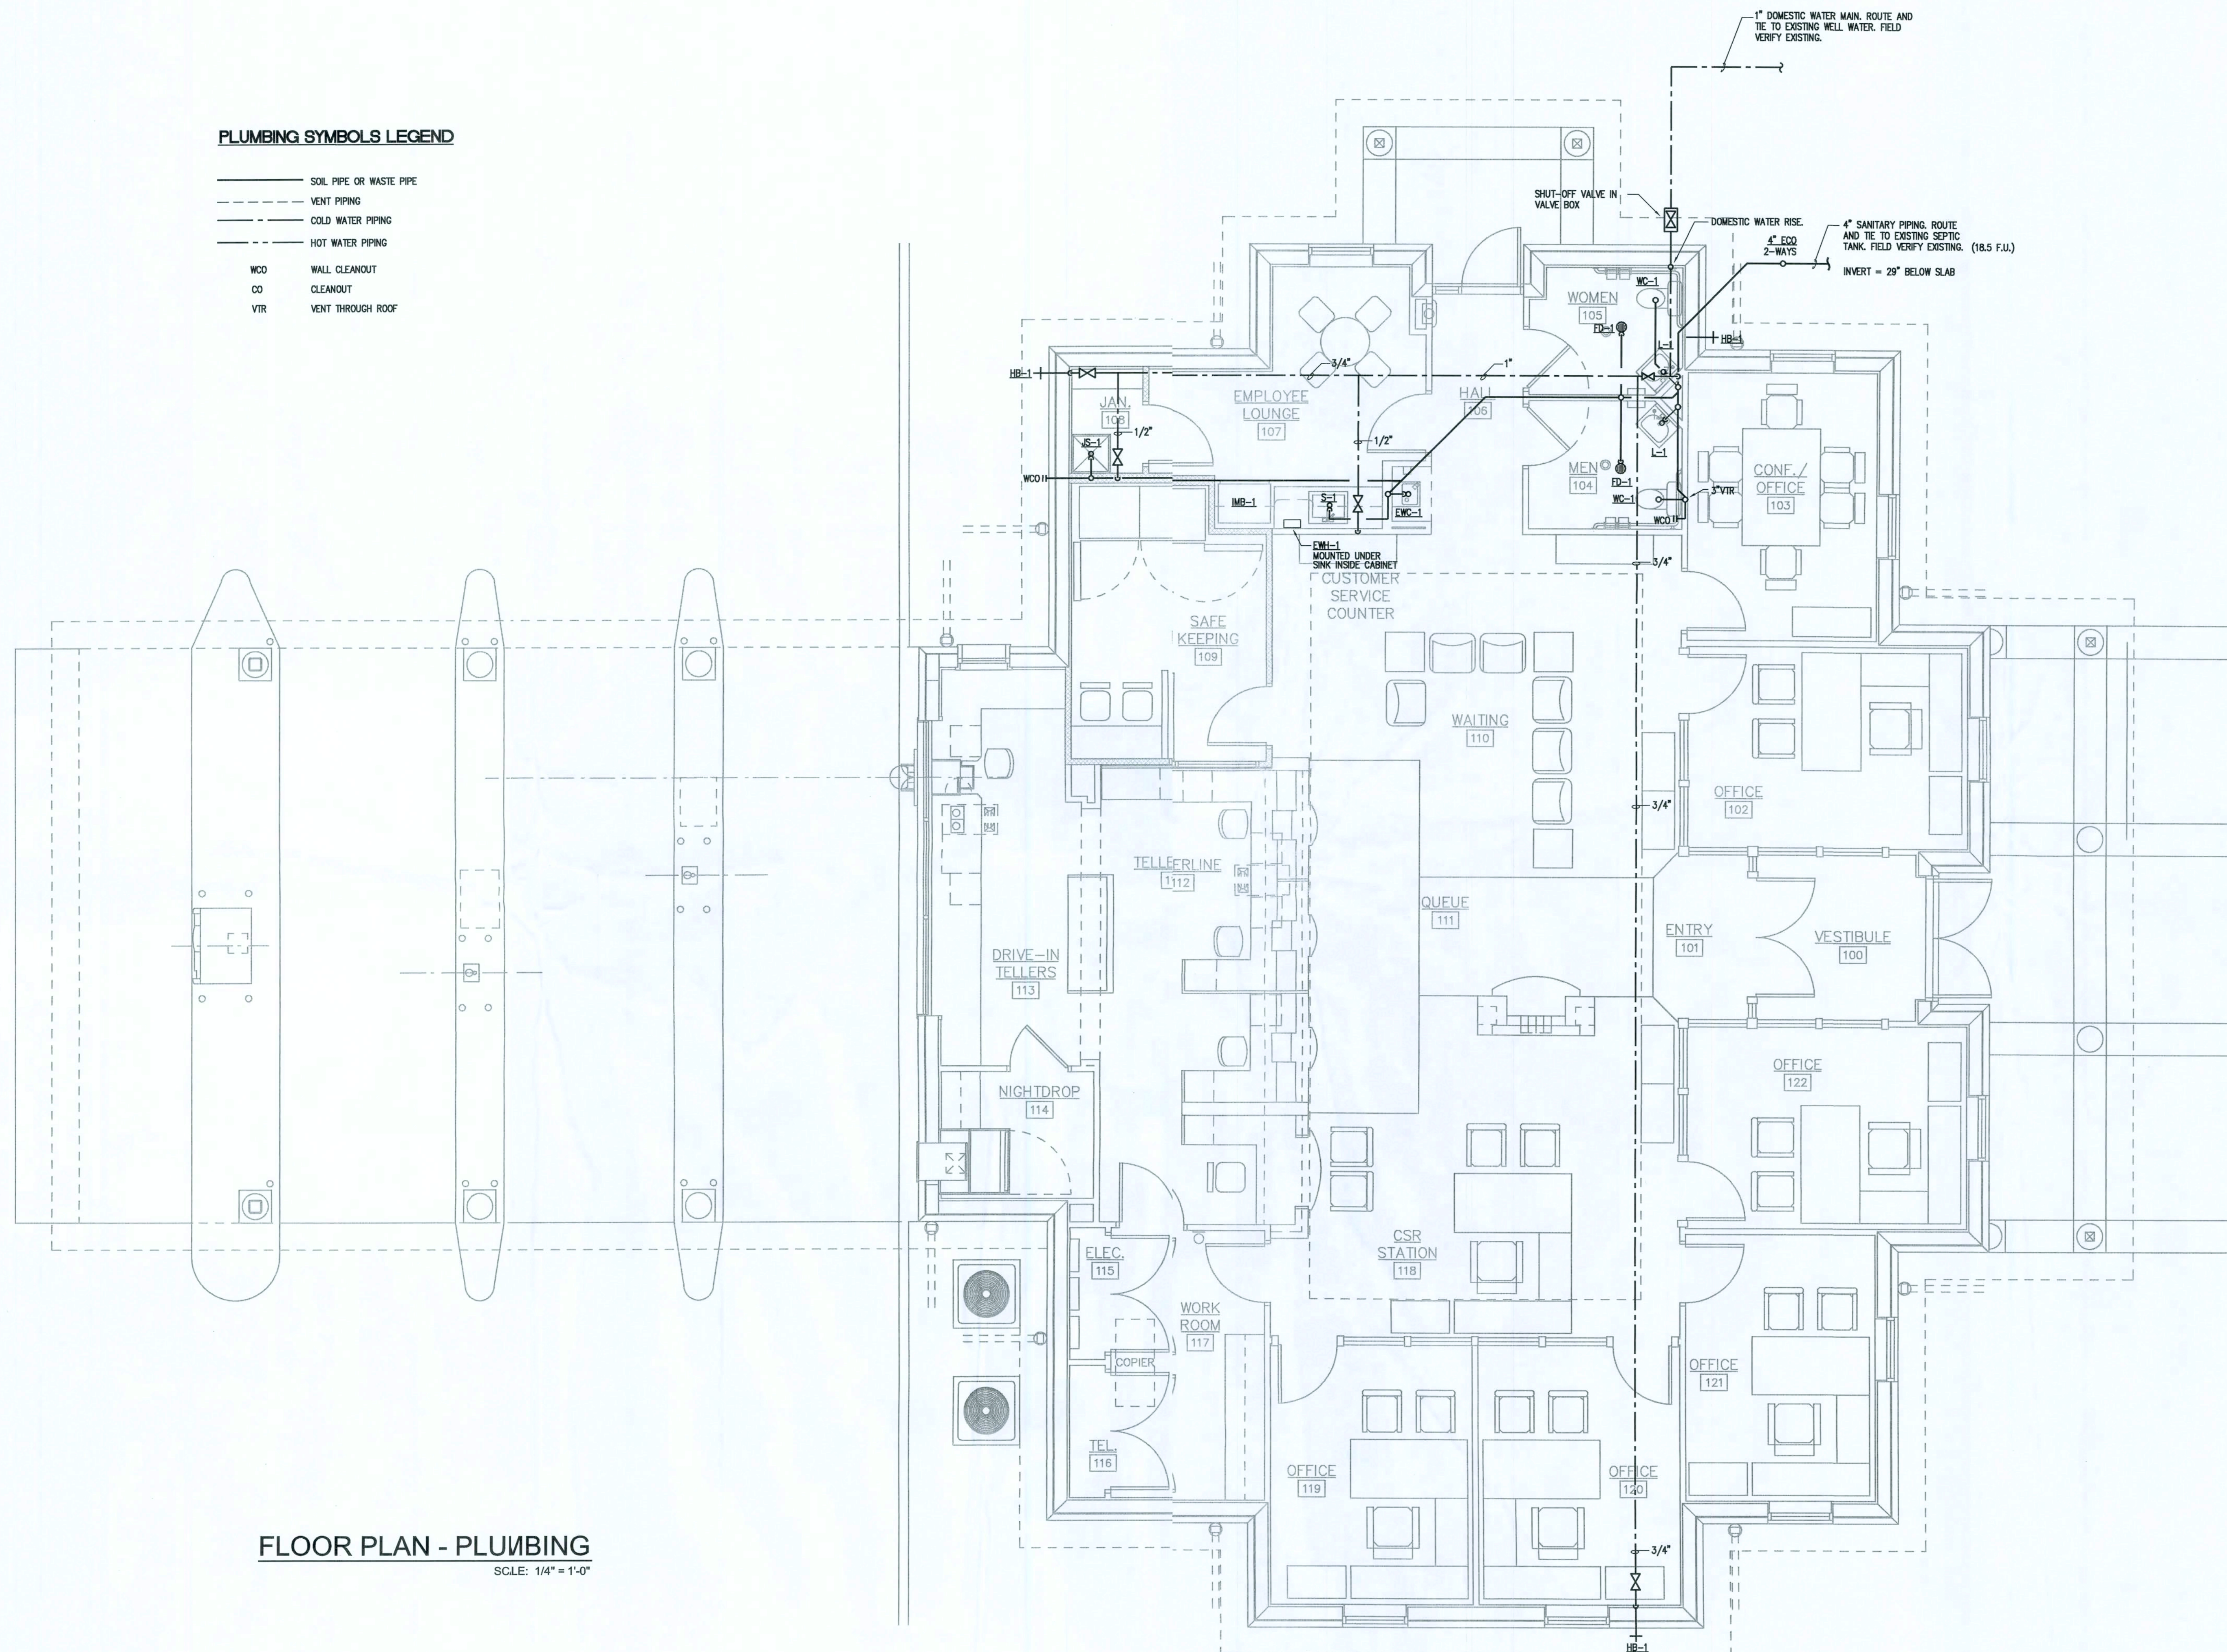
William M. Mitto

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SHEET NUMBER

S-8.04

—————	SOIL PIPE OR WASTE PIPE
- - - - -	VENT PIPING
———— -	COLD WATER PIPING
———— - - —	HOT WATER PIPING
WCO	WALL CLEANOUT
CO	CLEANOUT
VTR	VENT THROUGH ROOF




FLOOR PLAN - PLUMBING

Design Services Incorporated
1778 N. PARK AVENUE, SUITE 100, MAITLAND, FL 32751,
TELEPHONE (407) 629-5755

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INTERIOR DESIGN
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ELEVATION
KEY
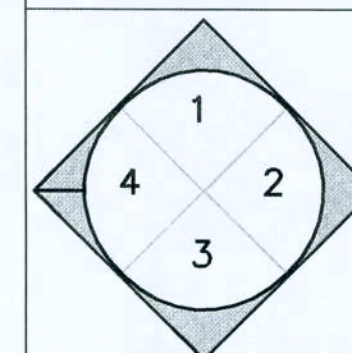
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ACTUAL
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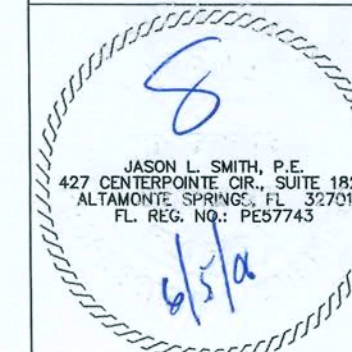
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FILE:			

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Consulting Engineers
Orlando • Ft. Pierce • West Palm Beach • Ft. Myers
427 Centerville Circle, Suite 1825
Altamonte Springs, FL 32701
(407) 332-6190 Fax (407) 332-7704
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FLOOR PLAN - PLUMBING

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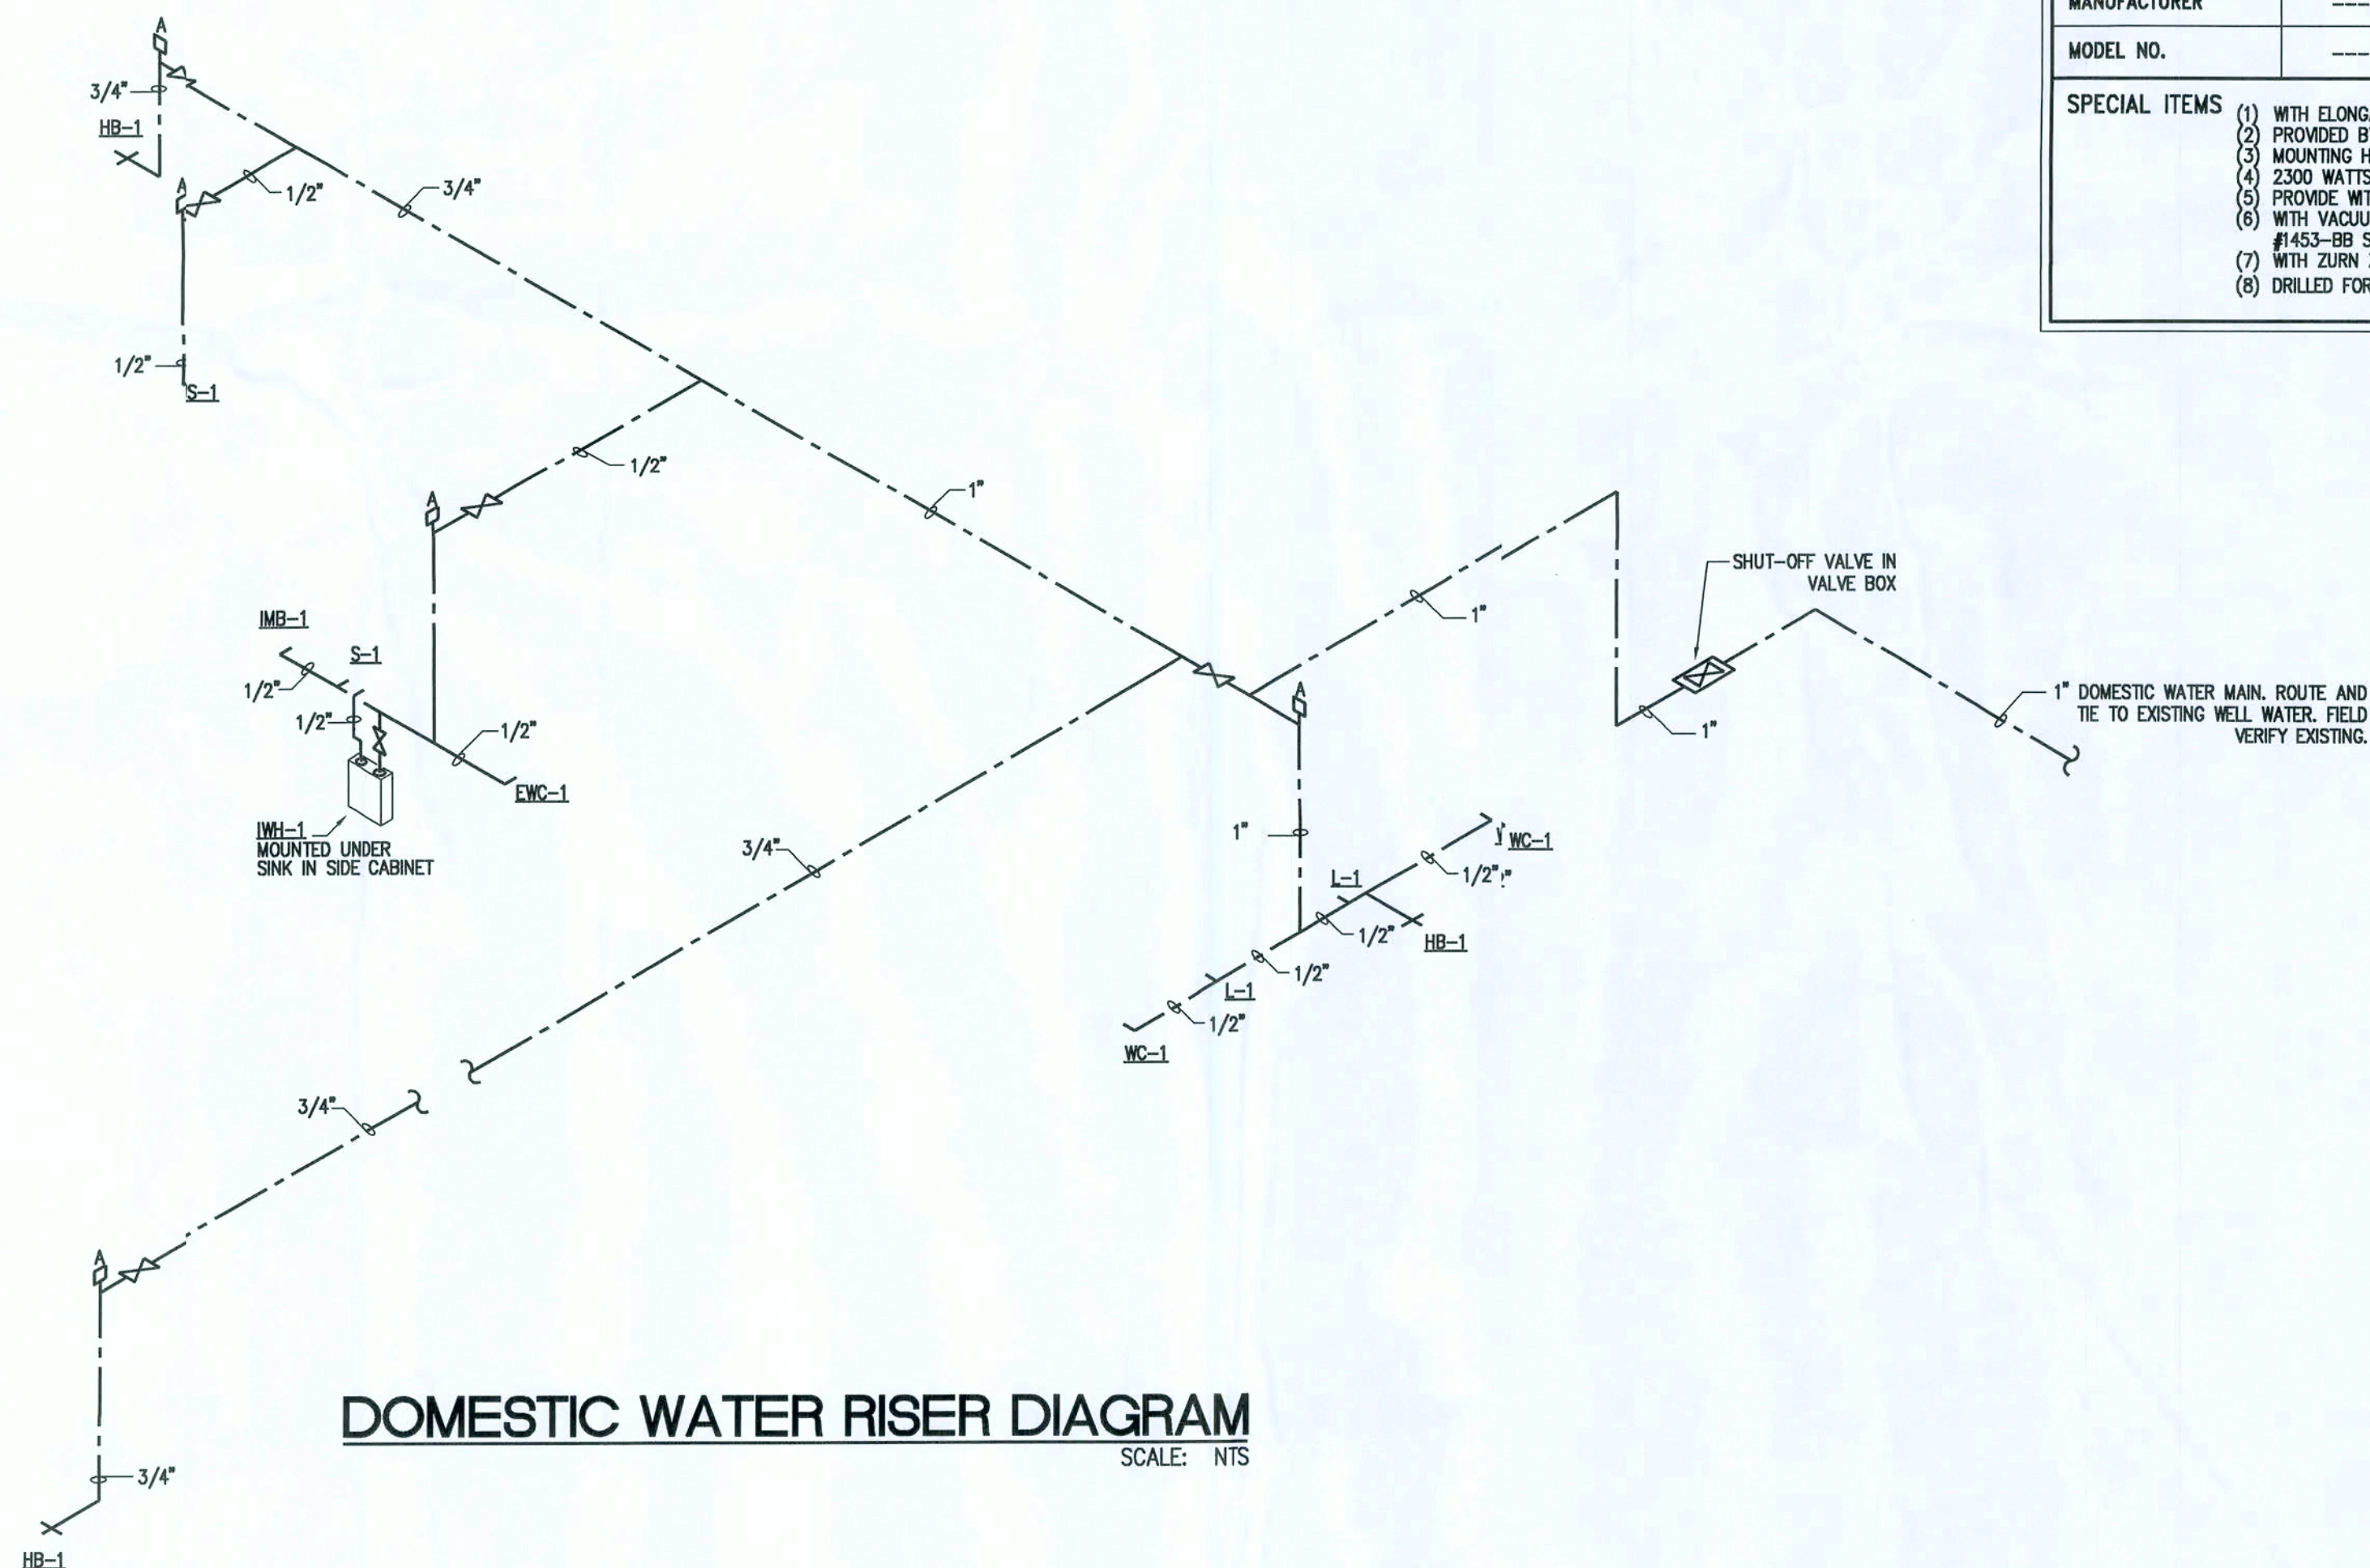


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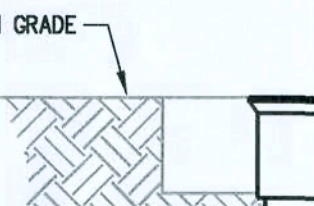
SANITARY RISER DIAGRAM

SALE: NTS



DOMESTIC WATER RISER DIAGRAM

SCALE: NTS



A cross-sectional diagram of a 2-Way Cleanout Installation. It shows a vertical PVC cleanout pipe passing through a 6" thick concrete pad. The top of the pad is at the finish grade. Below the pad, the pipe continues down and then splits into two horizontal branches, each with a 90-degree elbow. Labels with arrows point to the following components: FINISH GRADE, PVC CLEANOUT, 6" THICK CONCRETE PAD, PVC EXTENSION, SAME SIZE AS SEWER, and PVC 2-WAY CLEANOUT.

EXTERIOR 2-WAY CLEANOUT
N.T.S.

N.T.S.

DS DESIGN SERVICES INCORPORATED
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LAKE CITY, FLORIDA



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INTERIOR
ELEVATION
KEY

NORTH

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 PLAN

MARK	DATE	REVISIONS
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COMM. NO:	06003.00	DRAWN:	CAD
DATE:	02/15/05	CHECKED:	ENG
SCALE:	1/4" = 10"		
FILE:			


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SCHEDULE, DETAILS AND RISERS- PLUMBING

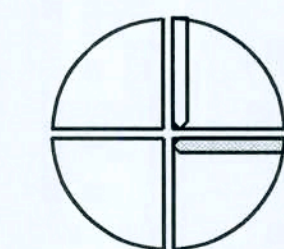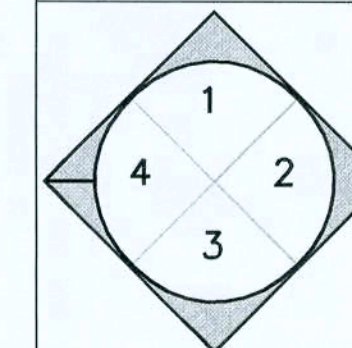SEAL

ARCHITECT/CONSULTANT



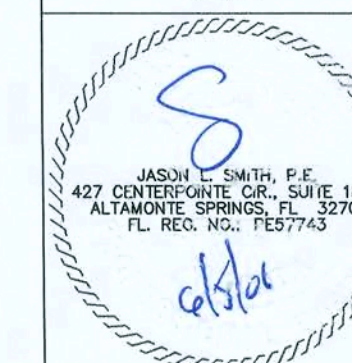SHEET NUMBER

P2.0

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GENERAL NOTES:

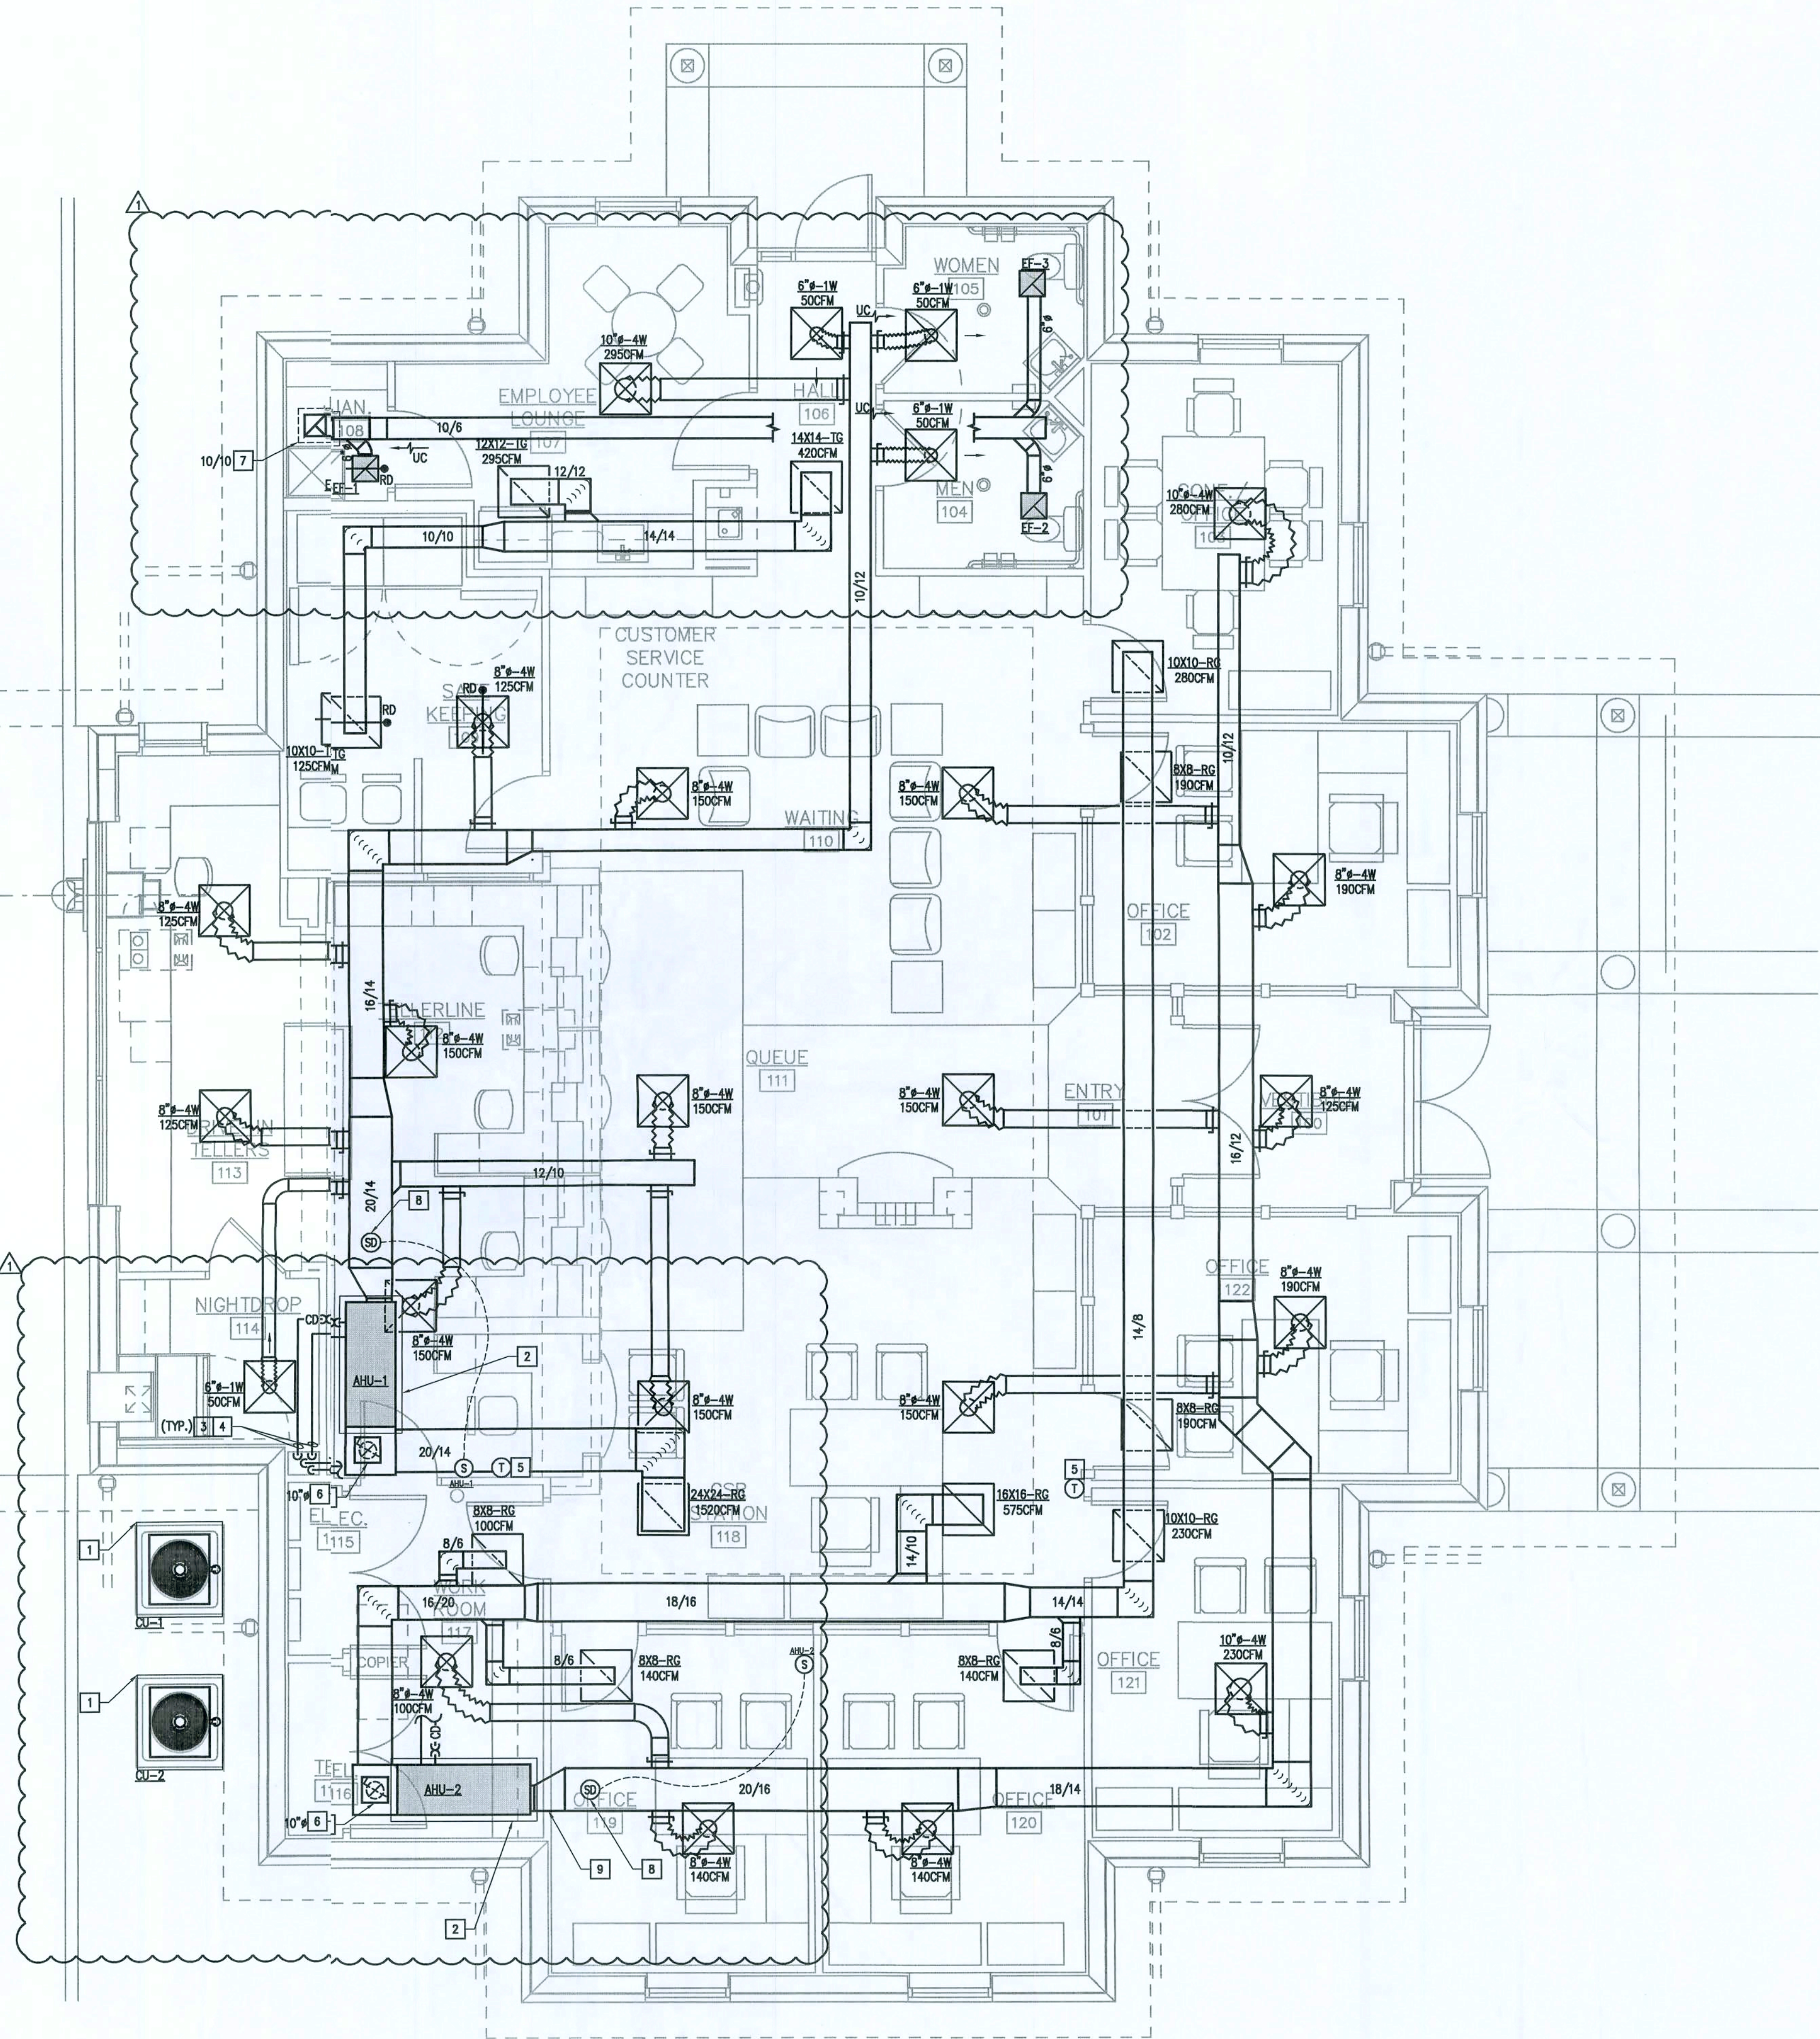
1. ALL SUPPLY DIFFUSERS AND RETURN AIR GRILLES SHALL BE 24 X 24 LAY-IN MODULE WITH NECK SIZES AS INDICATED ON PLANS.
2. ALL REFRIGERANT PIPING SHALL BE SIZED AND INSULATED PER MANUFACTURER'S RECOMMENDATIONS.
3. ALL RETURN AIR GRILLES SHALL BE 22X22 NECK SIZE. PROVIDE SQUARE TO ROUND NECK TRANSITION AS REQUIRED.
4. REFER TO REFLECTED CEILING PLAN FOR EXACT LOCATIONS FOR CEILING MOUNTED AIR DISTRIBUTION DEVICES. ALL GRILLES AND DIFFUSERS SHALL BE PERFORATED FACE WITH DIRECTIONAL LOUVERS BEHIND PERFORATED FLUSH FACE AND VOLUME DAMPER EQUAL TO TITUS MODEL TDC-AA. PAINT INSIDE OF DUCTWORK, DIFFUSERS AND GRILLES VISIBLE THROUGH DIFFUSERS AND GRILLES FLAT BLACK.

H.V.A.C. LEGEND:

- SUPPLY DIFFUSER
- RETURN AIR GRILLE
- EXHAUST AIR GRILLE
- RIGID DUCTWORK (WIDTH/DEPTH)
- ELBOW WITH TURNING VANES
- MANUAL SPLITTER DAMPER
- FLEXIBLE DUCT WITH SPIN-IN FITTING AND MANUAL VOLUME DAMPER
- MANUAL VOLUME DAMPER
- FIRE DAMPER
- DUCT MOUNTED SMOKE DETECTOR
- REMOTE TEST STATION
- THERMOSTAT
- CONDENSATE DRAIN LINE
- DOOR UNDERCUT

H.V.A.C. KEYNOTES:

1. PROVIDE 6" THICK CONCRETE SLAB UNDER CONDENSING UNITS, OVERLAP UNITS BY 6" ON ALL SIDES.
2. PROVIDE AUXILIARY DRAIN PAN UNDER EACH AIR HANDLING UNIT MOUNTED ABOVE CEILING. PAN SHALL BE 2" DEEP AND EXTEND 2" BEYOND AIR HANDLING UNIT ON ALL SIDES. PROVIDE FLOAT SWITCH IN AUXILIARY DRAIN PAN, INTERLOCKED WITH UNIT SUPPLY FAN TO SHUT THE UNIT DOWN WHEN WATER LEVEL IN PAN EXCEEDS 1/2".
3. RUN INDIVIDUAL 3/4" PVC CONDENSATE DRAIN LINES ABOVE THE CEILING FOR AHU-1&2 THEN DOWN IN WALL. COLLECT INTO A 2" PVC ROUTE UNDERGROUND TO DRYWELL. INSULATE ALL LINES WITH 3/4" THICK FLEX INSULATION INSIDE THE BUILDING.
4. ROUTE REFRIGERANT LINES FROM AHU IN 4" PVC CHASE TO ASSOCIATED CONDENSING UNIT. ROUTE REFRIGERANT PIPING OUTSIDE THE BUILDING IN A NEAT MANNER TO CONDENSING UNITS. NO PIPING SHALL BE VISIBLE FROM INSIDE OR OUTSIDE THE BUILDING.
5. MOUNT THERMOSTAT 5'-0" ABOVE FINISHED FLOOR. PROVIDE OPAQUE LOCKING COVER WITH KEY (FOR LOBBY AREA ONLY). THERMOSTAT SHALL BE FULLY PROGRAMMABLE 7-DAY ELECTRONIC WITH SET UP & SET BACK AND WITH STAGES SUITABLE FOR ASSOCIATED AHU/CO HEATING AND COOLING STAGES (TYPICAL ALL AHUS).
6. ROUTE OUTSIDE TO ROOF DISCHARGE CAP. PROVIDE MANUAL VOLUME CONTROL DAMPER IN EACH OUTSIDE AIR BRANCH DUCT CONNECTED TO RETURN AIR PLENUM.
7. ROUTE EXHAUST DUCTWORK UP TO ROOF DISCHARGE CAP.
8. PROVIDE DUCT MOUNTED SMOKE DETECTOR IN MAIN SUPPLY AIR DUCT. DETECTORS SHALL BE INTERLOCKED WITH ASSOCIATED SUPPLY AIR FAN.
9. COORDINATE LOCATION OF AHU AND DUCTWORK WITH STUD LOCATIONS. PROVIDE ENOUGH CLEARANCE FOR A CLEAN INSTALLATION.



FLOOR PLAN - HVAC

SCALE: 1/4" = 1'-0"


DESIGN SERVICES INCORPORATED
1778 N. PARK AVENUE, SUITE 100, MAITLAND, FL 32751,
TELEPHONE (407) 629-5755
LICENSE NO. F00061

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GENERAL NOTES:

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INTERIOR
ELEVATION
KEY

NORTH

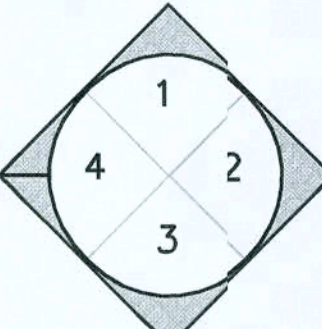ACTUAL
PLAN

MARK DATE REVISIONS
06/05/06 ADDENDUM #1

COMM. NO: 0603.00 DRAWN: JD
DATE: 02/15/06 CHECKED: JLS
SCALE: 1/4" = 1'-0"

FILE:

OCI ASSOCIATES, INC.

Consulting Engineers

Orlando - FL Phone: (407) 629-5755 FAX: (407) 629-5756

427 Canterbury Circle, Suite 100

Altamonte Springs, FL 32714

www.ociassociates.com


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FLOOR PLAN -
HVAC

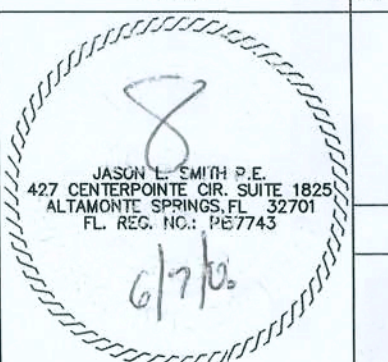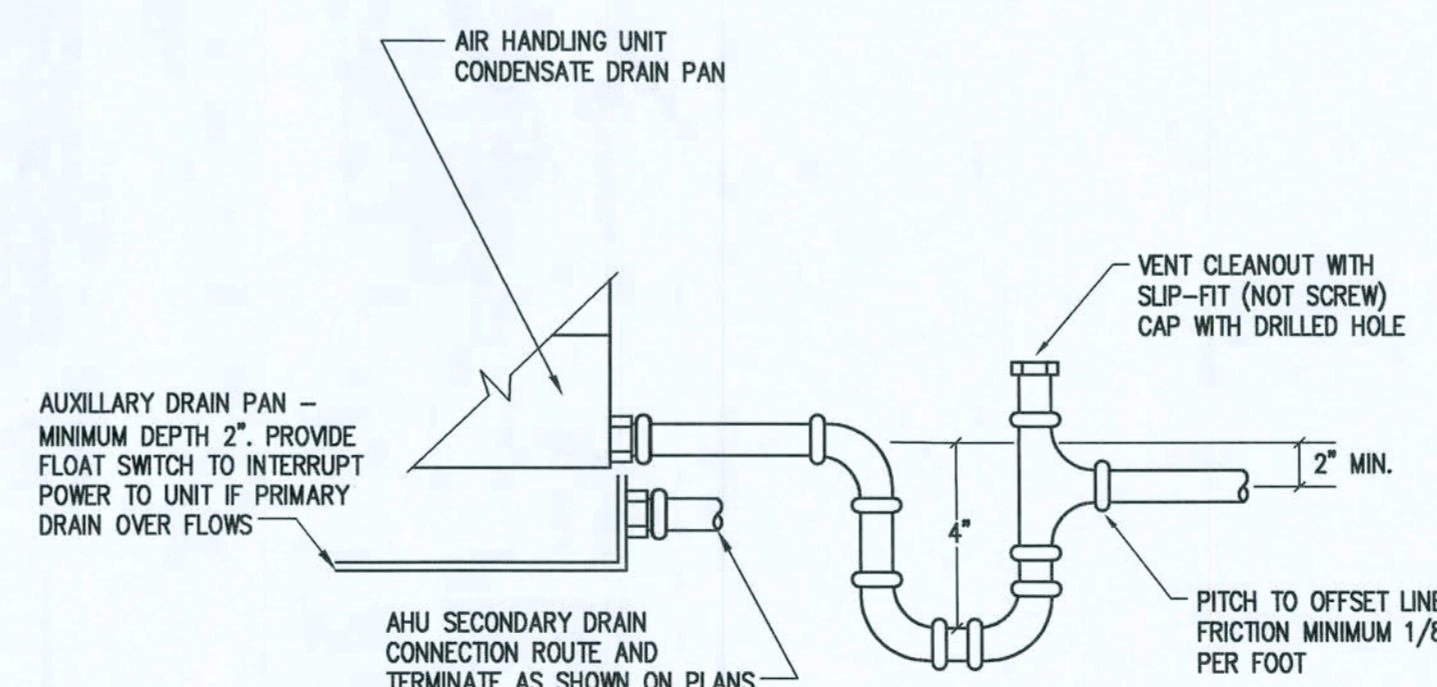
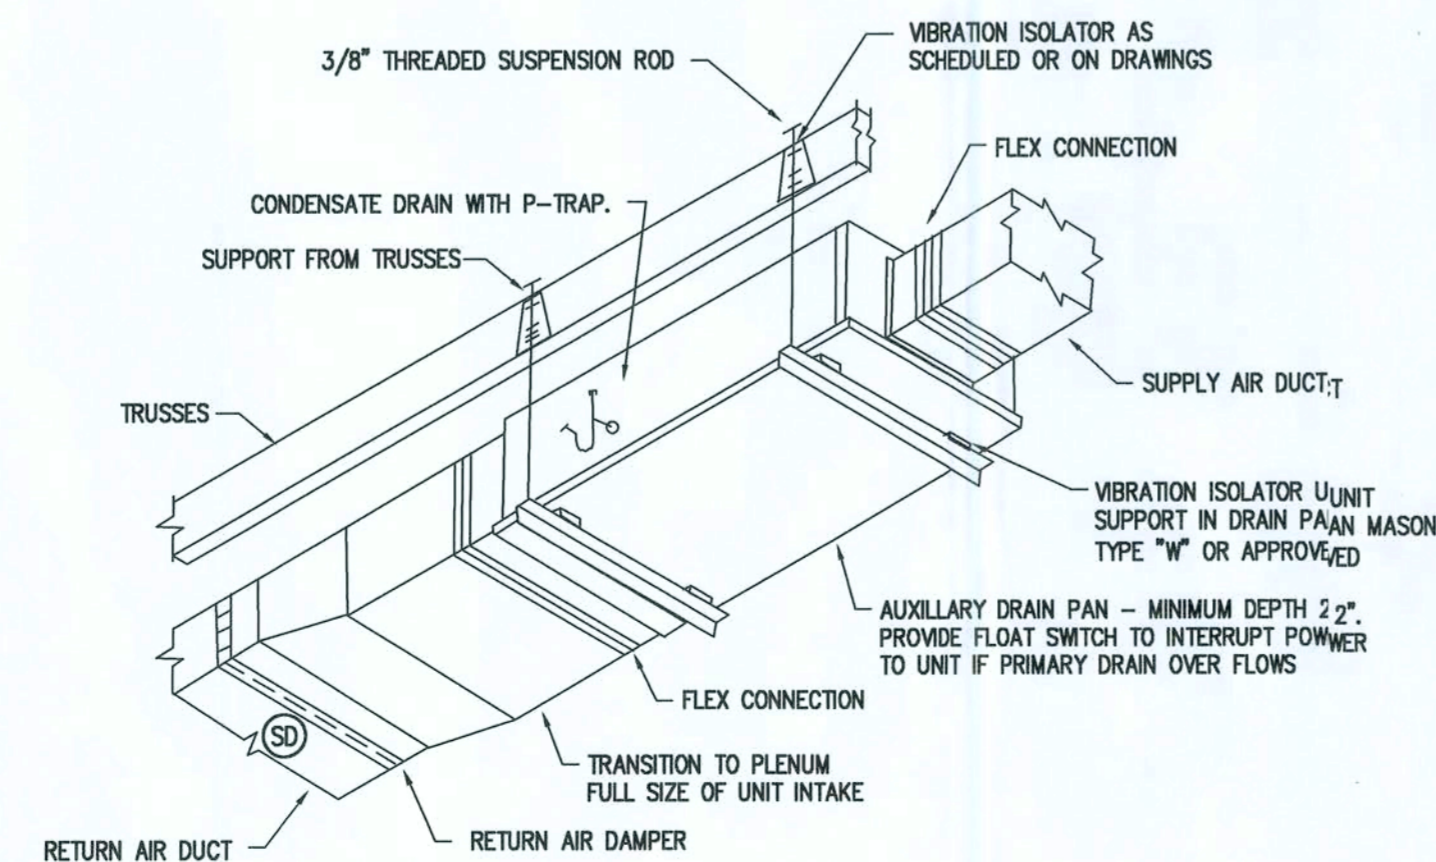
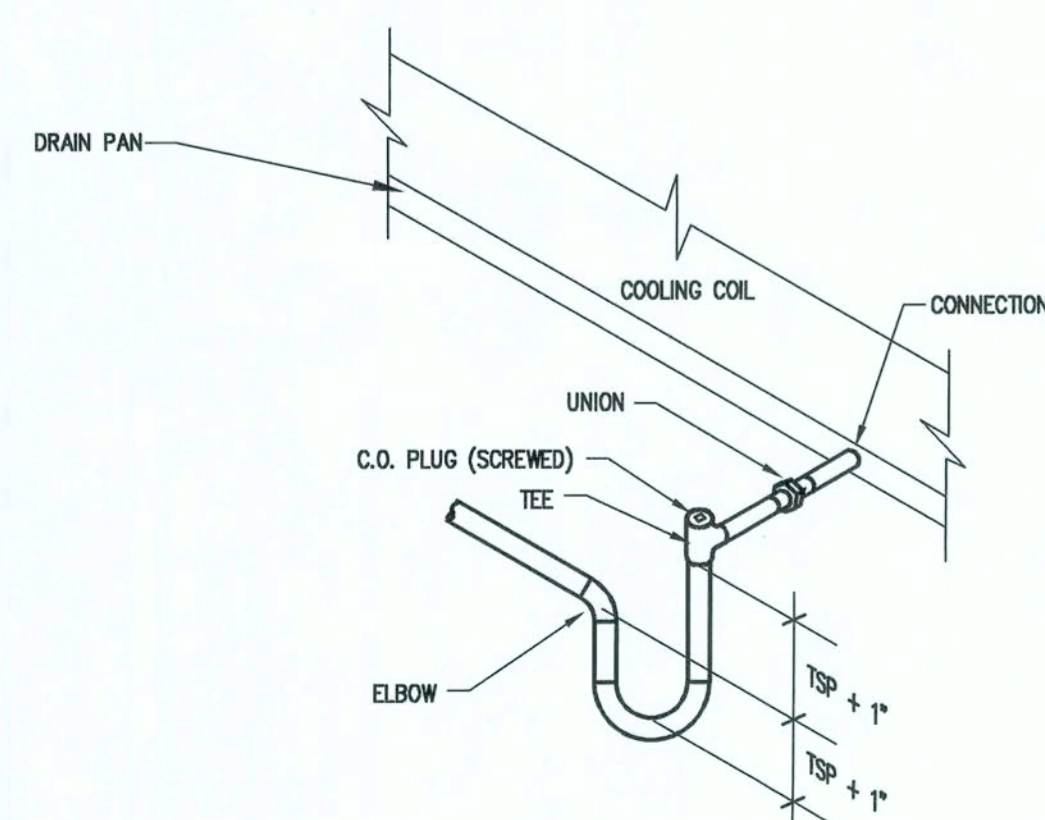
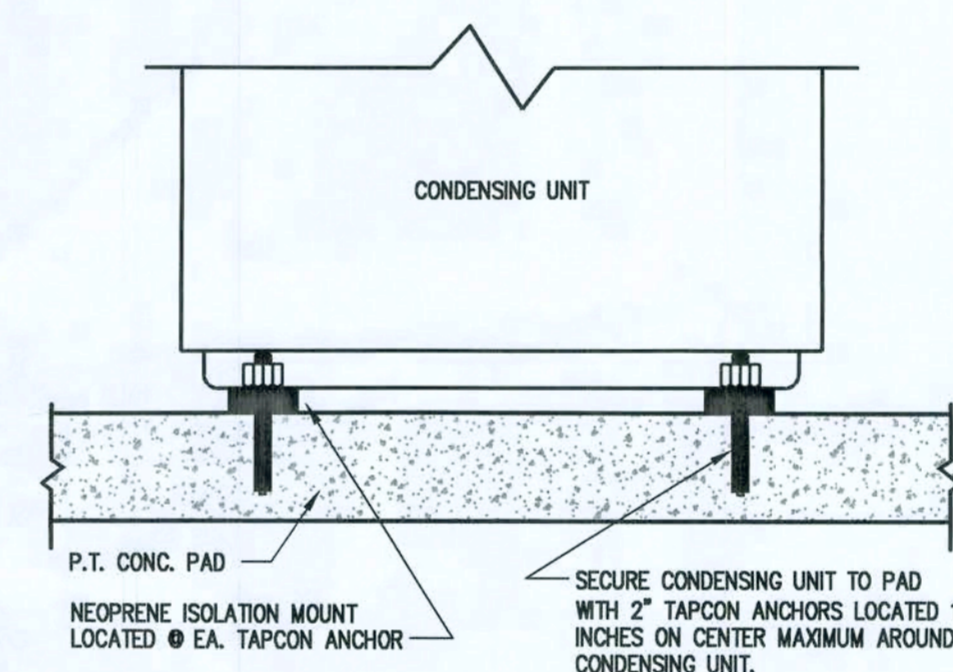
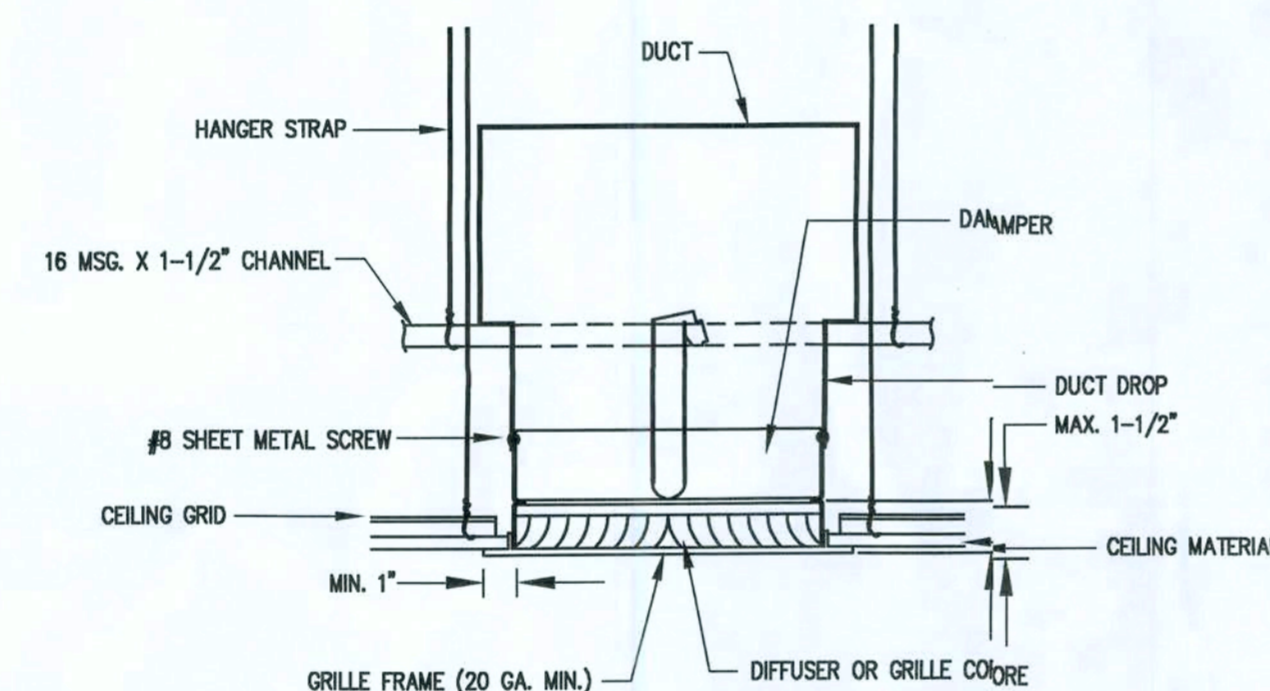
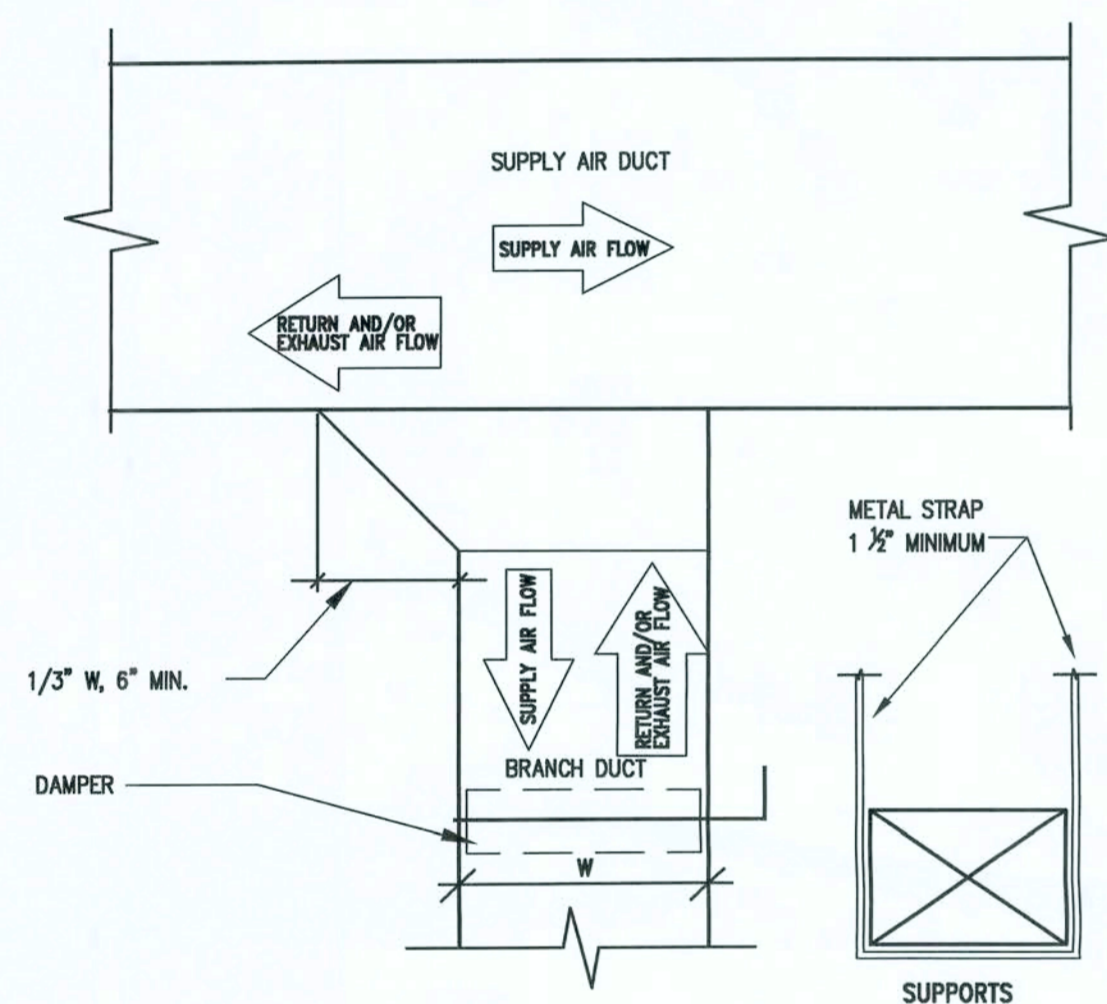
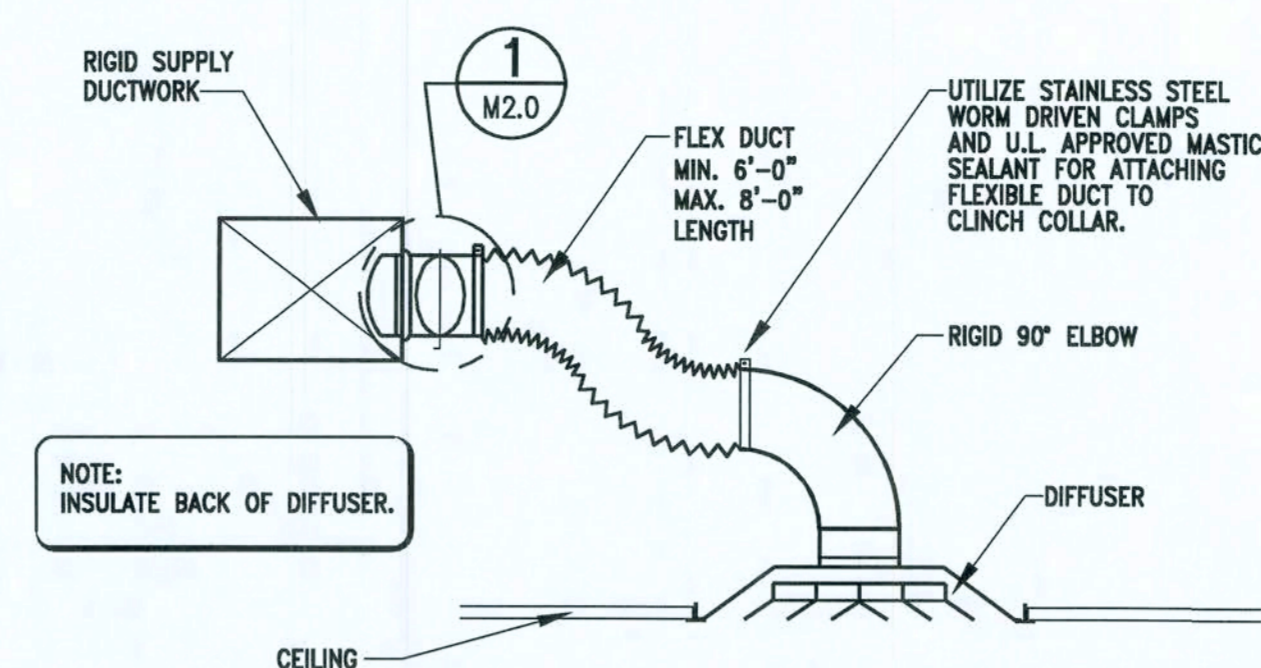
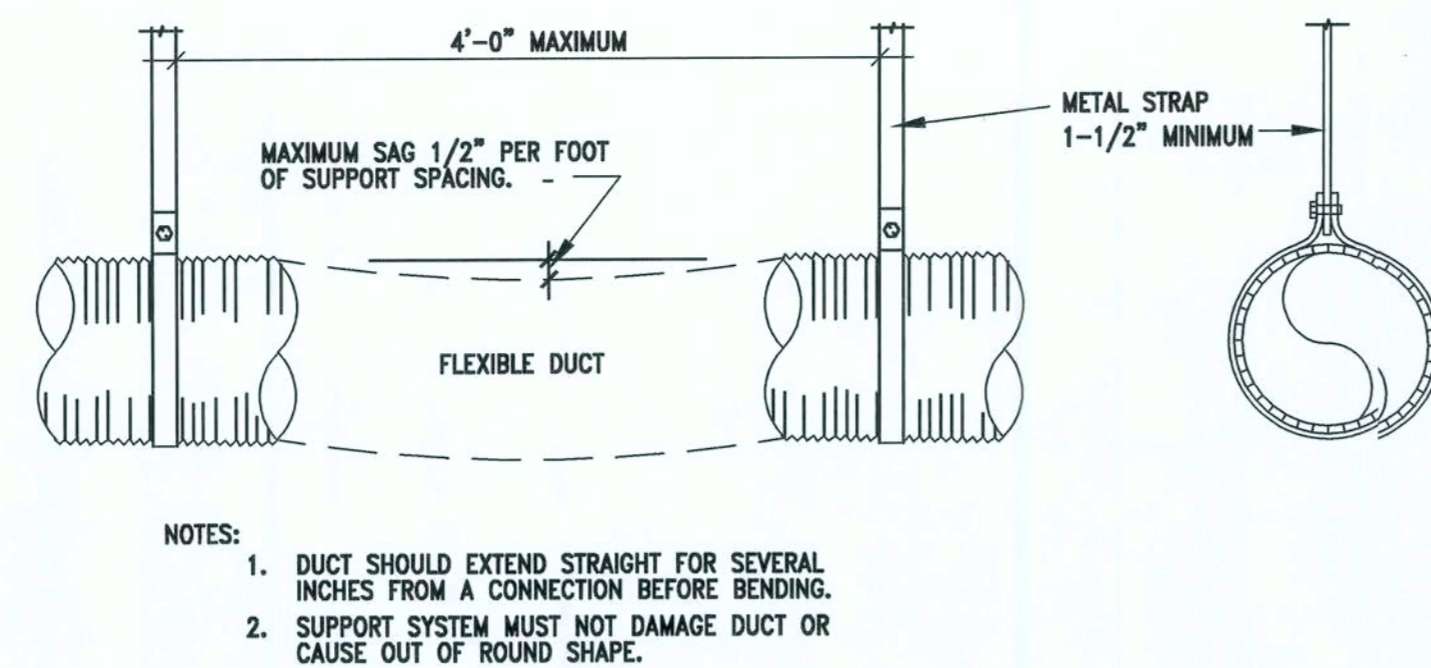
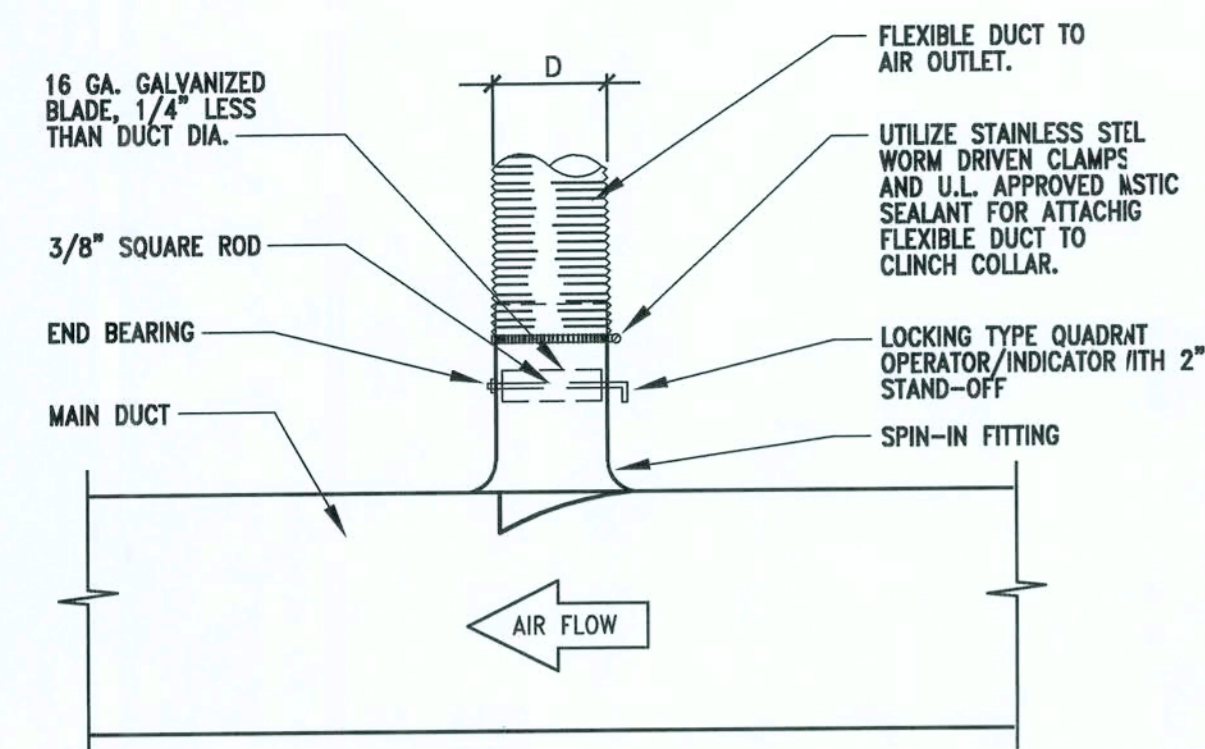
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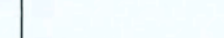
DESIGN SERVICES INCORPORATED
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