

PREPARED FOR:





PROJECT DESCRIPTION: RAW LAND NSB

SITE NAME:

HIGH SPRINGS WEST

VERIZON LOCATION CODE: 477684



CAUTION

FOR EMERGENCIES CALL: 911

PROJECT INFORMATION

SITE ADDRESS: 1034 SW CR 138 FT. WHITE, FL 32038

LATITUDE: 29° 51' 09.30" N (NAD 83) -82° 39' 26.61" W (NAD 83) LONGITUDE:

PARCEL ID: 30-7S-17-10069-002

COLUMBIA COUNTY JURISDICTION:

DONNA K. FRANKENHAUSER PROPERTY OWNER:

> TOWERCOM ENTERPRISES, LLC 7411 FULLERTON ST. #200 JACKSONVILLE, FL 32256

FORESITE GROUP, LLC 10150 HIGHLAND MANOR DR #210 TAMPA, FL 33610 ENGINEER:

CLAY ELECTRIC POWER:

TELCO: WINDSTREAM COMMUNICATIONS

DESIGN DATA:

APPLICANT:

DESIGN CODE:

FLORIDA BUILDING CODE, 7TH EDITION (2020) (FBC) & TIA/EIA 222-H (TIA)

BASIC WIND SPEED: 121 MPH (PER FBC)

EXPOSURE CATEGORY: STRUCTURAL RISK CATEGORY: II

SHEET INDEX


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3740 Davinci Ct. n I 770 368 1399 Suite 100



HIGH SPRINGS WEST 477684

> LOCATED AT: 1034 SW CR 138

APPROVALS CARRIER LANDLORD LEASING CONSTRUCTION REVISIONS

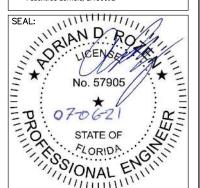ISSUED FOR: PERMIT/CONSTRUCTION PROJECT MANAGER: MWM DRAWING BY: MWM DATE: 07/06/21

TITLE:

TITLE SHEET

SHEET NUMBER: JOB/FILE NUMBER: 1306.002

GENERAL NOTES:

 FOR THE PURPOSE OF THE CONSTRUCTION DRAWINGS, THE FOLLOWING DEFINITIONS SHALL APPLY:

CONTRACTOR - GENERAL CONTRACTOR (CONSTRUCTION)
TOWER OWNER - TOWERCOM ENTERPRISES, LLC

- PRIOR TO THE SUBMISSION OF BIDS, THE BIDDING CONTRACTOR SHALL VISIT THE CELL SITE TO FAMILIARIZE WITH THE EXISTING CONDITIONS AND TO CONFIRM THAT THE WORK CAN BE ACCOMPLISHED AS SHOWN ON THE CONSTRUCTION DRAWINGS. ANY DISCREPANCY FOUND SHALL BE BROUGHT TO THE ATTENTION OF THE ENGINEER.
- 3. ALL MATERIALS FURNISHED AND INSTALLED SHALL BE IN STRICT ACCORDANCE WITH ALL APPLICABLE CODES, REGULATIONS AND ORDINANCES. CONTRACTOR SHALL ISSUE ALL APPROPRIATE NOTICES AND COMPLY WITH ALL LAWS, ORDINANCES, RULES, REGULATIONS, AND LAWFUL ORDERS OF ANY PUBLIC AUTHORITY REGARDING THE PERFORMANCE OF THE WORK.
- ALL WORK CARRIED OUT SHALL COMPLY WITH ALL APPLICABLE MUNICIPAL AND UTILITY COMPANY SPECIFICATIONS AND LOCAL JURISDICTIONAL CODES, ORDINANCES AND APPLICABLE REGULATIONS.
- 5. UNLESS NOTED OTHERWISE, THE WORK SHALL INCLUDE FURNISHING MATERIALS, EQUIPMENT, APPURTENANCES, AND LABOR NECESSARY TO COMPLETE ALL INSTALLATIONS AS INDICATED ON THE DRAWINGS.
- THE CONTRACTOR SHALL INSTALL ALL EQUIPMENT AND MATERIALS IN ACCORDANCE WITH MANUFACTURER'S RECOMMENDATIONS UNLESS SPECIFICALLY STATED OTHERWISE.
- IF THE SPECIFIED EQUIPMENT CANNOT BE INSTALLED AS SHOWN ON THESE DRAWINGS, THE CONTRACTOR SHALL PROPOSE AN ALTERNATIVE INSTALLATION FOR APPROVAL BY THE ENGINEER.
- 8. CONTRACTOR SHALL DETERMINE ACTUAL ROUTING OF CONDUIT, POWER, FIBER, AND GROUNDING CABLES SHOWN ON THE POWER & GROUNDING DRAWINGS.
- 9. THE CONTRACTOR SHALL PROTECT EXISTING IMPROVEMENTS, PAVEMENTS, CURBS, LANDSCAPING AND STRUCTURES. ANY DAMAGED PART SHALL BE REPAIRED AT CONTRACTOR'S EXPENSE TO THE SATISFACTION OF THE OWNER.
- 10. CONTRACTOR SHALL LEGALLY AND PROPERLY DISPOSE OF ALL SCRAP MATERIALS OFFSITE.
- 11. CONTRACTOR SHALL LEAVE PREMISES IN CLEAN CONDITION.
- 12. CONTRACTOR SHALL HAVE A PRECONSTRUCTION MEETING WITH OWNER TO DISCUSS ALL ASPECTS OF THE CONSTRUCTION SCOPE OF THIS DRAWING TO ENSURE HE IS FAMILIAR AND UNDERSTANDS ALL REQUIREMENTS AND INTENT OF EACH ACTIVITY.
- 13. THE CONTRACTOR MUST VERIFY ALL DIMENSIONS, CONDITIONS AND ELEVATIONS BEFORE STARTING WORK. ALL DISCREPANCIES SHALL BE CALLED TO THE ATTENTION OF THE ENGINEER AND SHALL BE RESOLVED BEFORE PROCEEDING WITH THE WORK. ALL WORK SHALL BE PERFORMED IN A WORKMANLIKE MANNER IN ACCORDANCE WITH ACCEPTED CONSTRUCTION PRACTICES.
- 14. IT IS THE INTENTION OF THESE DRAWINGS TO SHOW THE COMPLETE INSTALLATION. THE CONTRACTOR SHALL BE RESPONSIBLE FOR ALL TEMPORARY BRACING, SHORING, TIES, FORMWORK, ETC. IN ACCORDANCE WITH ALL NATIONAL, STATE AND LOCAL ORDINANCES, TO SAFELY EXECUTE ALL WORK AND SHALL BE RESPONSIBLE FOR SAME. ALL WORK SHALL BE IN ACCORDANCE WITH LOCAL CODES.
- 15. THE CONTRACTOR SHALL USE ADEQUATE NUMBERS OF SKILLED WORKMEN WHO ARE THOROUGHLY TRAINED AND EXPERIENCED IN THE NECESSARY CRAFTS, AND WHO ARE COMPLETELY FAMILIAR WITH THE SPECIFIED REQUIREMENTS AND METHODS NEEDED FOR PROPER PERFORMANCE OF THE WORK.
- 16. CONTRACTOR AGREES THAT IN ACCORDANCE WITH GENERALLY ACCEPTED CONSTRUCTION PRACTICES, CONTRACTOR WILL BE REQUIRED TO ASSUME SOLE AND COMPLETE RESPONSIBILITY FOR JOB SITE CONDITIONS DURING THE COURSE OF CONSTRUCTION OF THE PROJECT, INCLUDING SAFETY OF ALL PERSONS AND PROPERTY. THIS REQUIREMENT SHALL BE MADE TO APPLY CONTINUOUSLY AND NOT BE LIMITED TO NORMAL WORKING HOURS. CONTRACTOR FURTHER AGREES TO INDEMNIFY AND HOLD DESIGN ENGINEER HARMLESS FROM ANY AND ALL LIABILITY, REAL OR ALLEGED, IN CONNECTION WITH PERFORMANCE OF WORK ON THIS PROJECT. ALL WORK SHALL COMPLY WITH OSHA AND STATE SAFETY REQUIREMENTS. PROCEDURES FOR THE PROTECTION OF EXCAVATIONS, EXISTING CONSTRUCTION, AND UTILITIES SHALL BE ESTABLISHED PRIOR TO FOUNDATION INSTALLATION.

SITE WORK GENERAL NOTES:

- THE CONTRACTOR SHALL CONTACT UTILITY LOCATING SERVICES PRIOR TO THE START OF CONSTRUCTION.
- ALL EXISTING ACTIVE SEWER, WATER, GAS, ELECTRIC, AND OTHER UTILITIES WHERE ENCOUNTERED IN THE WORK, SHALL BE PROTECTED AT ALL TIMES, AND WHERE REQUIRED FOR THE PROPER EXECUTION OF THE WORK, SHALL BE RELOCATED AS DIRECTED BY ENGINEER. EXTREME CAUTION SHOULD BE USED BY THE CONTRACTOR WHEN EXCAVATION OR DRILLING PIERS AROUND OR NEAR UTILITIES. CONTRACTOR SHALL PROVIDE SAFETY TRAINING FOR THE WORKING CREW. THIS WILL INCLUDE BUT NOT BE LIMITED TO A) FALL PROTECTION B) CONFINED SPACE C) ELECTRICAL SAFETY D) TRENCHING & EXCAVATION.
- ALL SITE WORK SHALL BE AS INDICATED ON THE DRAWINGS AND IN ACCORDANCE WITH ALL APPLICABLE CODES, REGULATIONS, AND ORDINANCES.
- 4. IF NECESSARY, RUBBISH, STUMPS, DEBRIS, STICKS, STONES, AND OTHER REFUSE SHALL BE REMOVED FROM THE SITE AND DISPOSED OF LEGALLY.
- 5. ALL EXISTING INACTIVE SEWER, WATER, GAS, ELECTRIC AND OTHER UTILITIES, WHICH INTERFERE WITH THE EXECUTION OF THE WORK, SHALL BE REMOVED AND/OR CAPPED, PLUGGED OR OTHERWISE DISCONTINUED AT POINTS WHICH WILL NOT INTERFERE WITH THE EXECUTION OF THE WORK, SUBJECT TO THE APPROVAL OF OWNER AND/OR LOCAL UTILITY PROVIDER.
- 6. THE CONTRACTOR SHALL PROVIDE SITE SIGNAGE IN ACCORDANCE WITH THE TECHNICAL SPECIFICATIONS FOR SITE SIGNAGE.
- THE SITE SHALL BE GRADED TO CAUSE SURFACE WATER TO FLOW AWAY FROM THE BTS EQUIPMENT AND TOWER AREAS.
- 8. NO FILL OR EMBANKMENT MATERIAL SHALL BE PLACED ON FROZEN GROUND. FROZEN MATERIALS, SNOW, OR ICE SHALL NOT BE PLACED IN ANY FILL OR EMBANKMENT.
- THE SUB GRADE UNDER THE PROPOSED EQUIPMENT PAD SHALL BE COMPACTED TO 98% PROCTOR AND BROUGHT TO A SMOOTH UNIFORM GRADE PRIOR TO FINISHED SURFACE APPLICATION.
- 10. THE AREAS OF THE OWNERS PROPERTY DISTURBED BY THE WORK AND NOT COVERED BY THE TOWER, EQUIPMENT OR DRIVEWAY, SHALL BE GRADED TO A UNIFORM SLOPE, AND STABILIZED TO PREVENT EROSION AS SPECIFIED IN THE DRAWINGS AND IN ACCORDANCE WITH ALL APPLICABLE CODES, REGULATIONS, AND ORDINANCES.
- 11. CONTRACTOR SHALL MINIMIZE DISTURBANCE TO EXISTING SITE DURING CONSTRUCTION. EROSION CONTROL MEASURES, IF REQUIRED DURING CONSTRUCTION, SHALL BE IN CONFORMANCE WITH THE LOCAL GUIDELINES FOR EROSION AND SEDIMENT CONTROL.

STRUCTURAL STEEL NOTES:

- 1. ALL WELDING SHALL BE PERFORMED USING E70XX ELECTRODES AND WELDING SHALL CONFORM TO AISC. WHERE FILLET WELD SIZES ARE NOT SHOWN, PROVIDE THE MINIMUM SIZE PER TABLE J2.4 IN THE AISC "MANUAL OF STEEL CONSTRUCTION". PAINTED OR GALVANIZED SURFACES SHALL BE TOUCHED UP.
- BOLTED CONNECTIONS SHALL BE ASTM A325 BEARING TYPE CONNECTIONS AND SHALL HAVE MINIMUM OF TWO BOLTS UNLESS NOTED OTHERWISE.


TowerCom.



Foresite Group, LLC W | www.fg-inc.net

3740 Davinci Ct.
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Peachtree Corners, GA 30092

o | 770.368.1399 f | 770.368.1944

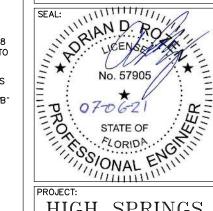

PROJECT: HIGH SPRINGS WEST 477684

LOCATED AT: 1034 SW CR 138 FT. WHITE, FL 32038

APPROVALS	
CARRIER	
LANDLORD	
LEASING	
CONSTRUCTION	
REVISIONS	DATE

ISSUED FOR: PERMIT/CONSTRUCTION
PROJECT MANAGER: MWM
DRAWING BY: MWM
DATE: 07/06/21
TITLE:

CONSTRUCTION NOTES

SHEET NUMBER:


JOB/FILE NUMBER: 1306.002

CONCRETE AND REINFORCING STEEL NOTES:

- ALL CONCRETE WORK SHALL BE IN ACCORDANCE WITH ACI 301, ACI 318, ACI 336, ASTM A184
- 2. ALL CONCRETE SHALL HAVE A MINIMUM COMPRESSIVE STRENGTH OF 4000 PSI AT 28 DAYS, UNLESS NOTED OTHERWISE; SLUMP: 2" MIN./4" MAX; AIR ENTRAINMENT: 45 TO 6% BY VOLUME; MAXIMUM COARSE AGGREGATE SIZE SHALL BE 1".
- 8. REINFORCING STEEL SHALL CONFORM TO ASTM A 615, GRADE 60, DEFORMED UNLESS NOTED OTHERWISE. WELDED WIRE FABRIC SHALL CONFORM TO ASTM A 185 WELDED STEEL WIRE REINFORCEMENT UNLESS NOTED OTHERWISE. SPLICES SHALL BE CLASS 'B' AND ALL HOOKS SHALL BE STANDARD, UNLESS NOTED OTHERWISE.
- THE FOLLOWING MINIMUM CONCRETE COVER SHALL BE PROVIDED FOR REINFORCING STEEL UNLESS SHOWN OTHERWISE ON DRAWINGS:

CONCRETE CAST AGAINST EARTH	.3"
CONCRETE EXPOSED TO EARTH OR WEATHER:	
#6 AND LARGER	3"
#5 AND SMALLER & WWF	
CONCRETE NOT EXPOSED TO EARTH OR WEATH	ER OR NOT
CAST AGAINST THE GROUND:	
SLAB AND WALL	1½"
BEAMS AND COLUMNS	1½"

- A CHAMFER OF 3/4" SHALL BE PROVIDED AT ALL EXPOSED EDGES OF CONCRETE, UNLESS NOTED OTHERWISE, IN ACCORDANCE WITH ACI 301.
- 6. INSTALLATION OF CONCRETE EXPANSION/WEDGE ANCHOR, SHALL BE PER MANUFACTURER'S WRITTEN RECOMMENDED PROCEDURE. THE ANCHOR BOLT, DOWEL OR ROD SHALL CONFORM TO MANUFACTURER'S RECOMMENDATION FOR EMBEDMENT DEPTH OR AS SHOWN ON THE DRAWINGS. IF DRILLING IN EXISTING CONCRETE, NO EXISTING REBAR WILL BE CUT WITHOUT PRIOR ENGINEERING APPROVAL
- 7. WELDING IS PROHIBITED ON REINFORCING STEEL AND EMBEDMENTS.
- 3. ALL CONCRETE SHALL BE READY—MIXED IN ACCORDANCE WITH ASTM C94. MAINTAIN TEMPERATURE OF CAST IN PLACE CONCRETE AT BETWEEN 50 DEGREES AND 90 DEGREES FARENHEIT.
- DO NOT USE RETEMPERED CONCRETE, OR ADD WATER TO READY-MIX CONCRETE AT THE JOBSITE.
- FOUNDATION INSTALLER SHALL INSURE THAT ALL PROTRUDING THREADS OF PROPOSED ANCHOR BOLTS SHALL BE MAINTAINED CLEAN AND FREE OF CONCRETE.
- 11. FOUNDATION DESIGN IS BASED ON SOIL WITH 2000 PSF BEARING CAPACITY. IF EXISTING SOIL DOES NOT HAVE A MINIMUM 2000 PSF BEARING CAPACITY CONTRACTOR SHALL EXTEND PERIMETER BEAM TO REACH SOIL WITH MINIMUM 2000 PSF BEARING CAPACITY.

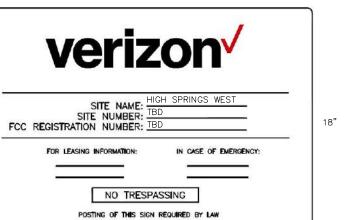

OWNER CONTACT SIGN

24"

WHITE/GREEN BACKGROUND, BLACK/RED LETTERING.
MOUNTING LOCATION: GATE
QUANTITY: 2



AUTHORIZED PERSONNEL SIGN

WHITE/BLUE BACKGROUND, WHITE/BLACK LETTERING.
MOUNTING LOCATION: GATE & BASE OF TOWER.
QUANTITY: 1
WHERE ACCESS GATE INSTALLED (QTY. 2)

Federal Communications Commission
Tower Registration Number

1 2 3 4 5 6 7

Posted in accordance with Federal Communications
Commission rules on antenna tower registration
of ATCFR 17.4(g).

12"

FCC REGISTRATION SIGN

WHITE/GREEN BACKGROUND, WHITE/BLACK LETTERING. MOUNTING LOCATION: GATE & BASE OF TOWER. QUANTITY: 2



DANGER NO TRESPASSING SIGN WHITE/BLACK BACKGROUND, WHITE/BLACK LETTERING. MOUNTING LOCATION: GATE & BASE OF TOWER. OLIANTITY: 1

WHERE ACCESS GATE INSTALLED (QTY. 2)



10"

NOTICE RF SIGN (BLUE)

WHITE/BLUE BACKGROUND, WHITE/BLACK LETTERING.
MOUNTING LOCATION: GATE & CENTERLINE OF FENCING
AROUND SITE. (QTY. 4)
WHERE ACCESS GATE INSTALLED (QTY. 5)



24"

OWNER CONTACT SIGN

WHITE BACKGROUND, BLACK/BLUE LETTERING.
20"x24" ALUMINUM SIGN WITH 1/4" DRILLED HOLES
IN EACH CORNER
THICKNESS: 0.05" (1/16") OR CLOSEST
STANDARD THICKNESS
MOUNTING LOCATION: GATE AND ACCESS ROAD GATE
IF APPLICABLE

TowerCom.




FORESITE

n I 770 368 1399

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Foresite Group, LLC 3740 Davinci Ct. Suite 100 Peachtree Corners, GA 30092

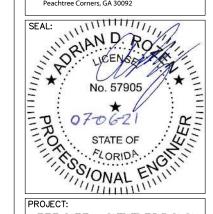

PROJECT: HIGH SPRINGS WEST 477684

LOCATED AT: 1034 SW CR 138 FT. WHITE, FL 32038

APPR	OVALS
CARRIER	
LANDLORD	
LEASING	
CONSTRUCTION	
REVISIONS	DATE
ISSUED FOR:	PERMIT/CONSTRUCTION
PROJECT MANAGER:	MWM

PROJECT MANAGER: MWM
DRAWING BY: MWM
DATE: 07/06/21
TITLE:


SITE SIGNAGE


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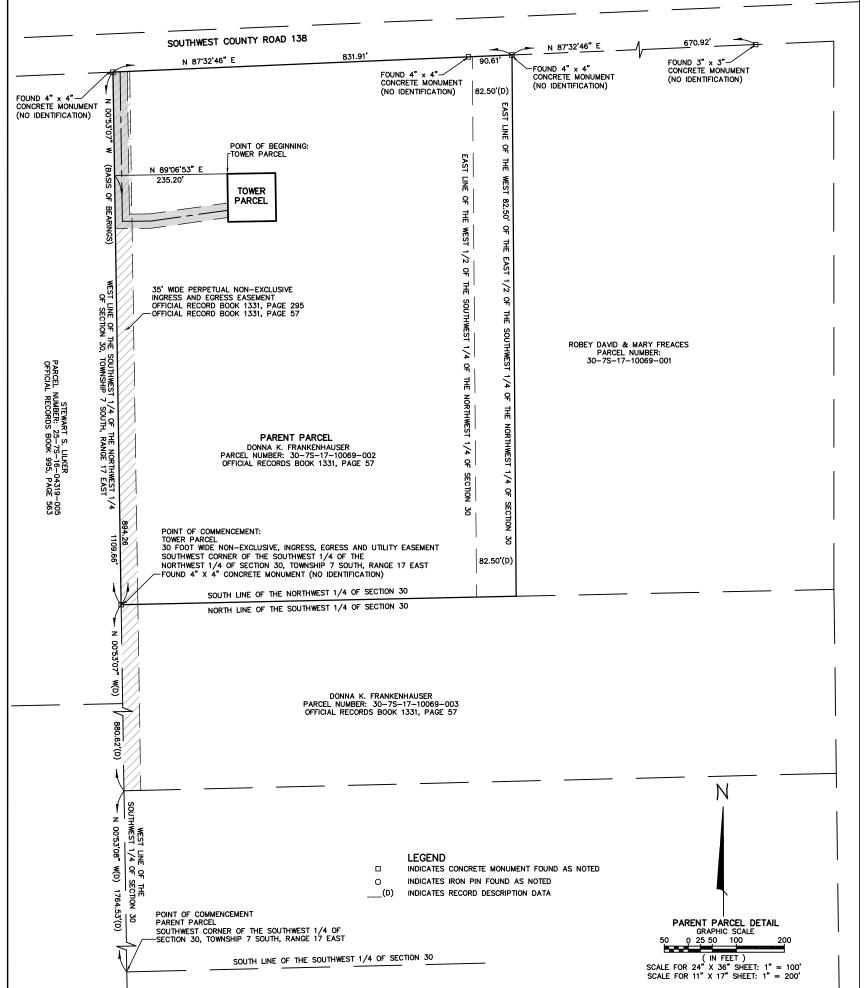
JOB/FILE NUMBER: 1306.002

QUANTITY: 1 (IF (2) HANG ON OUTER GATE(S))

SITE



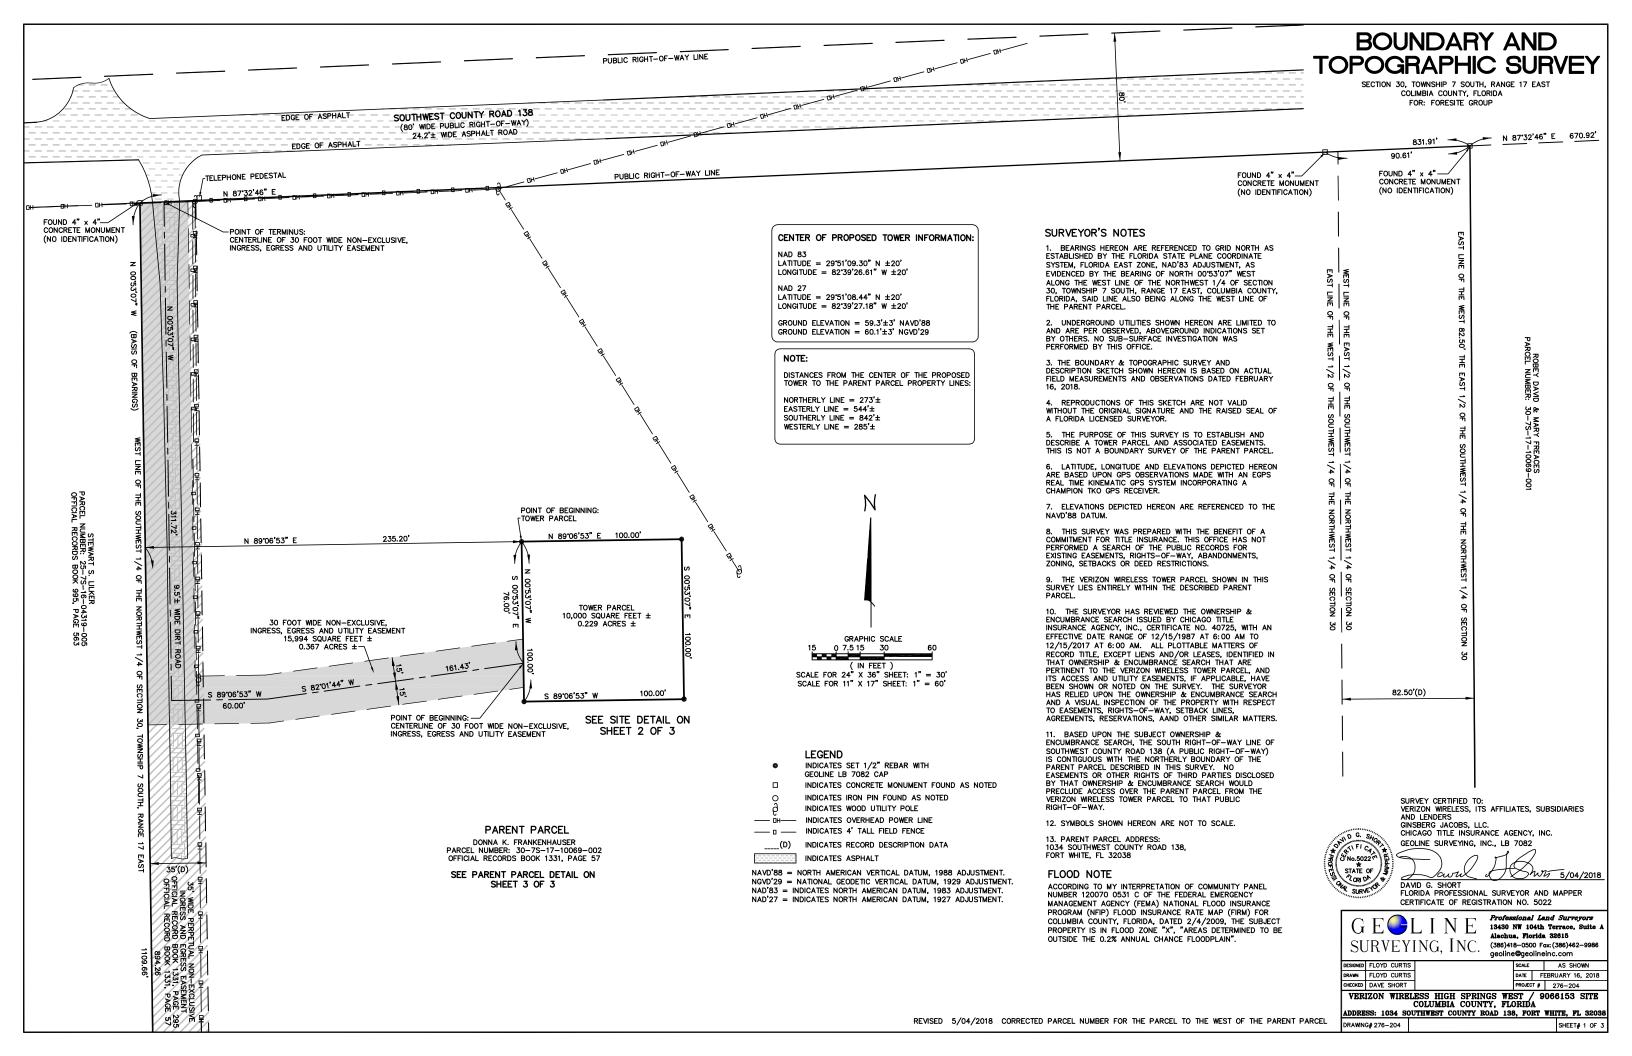

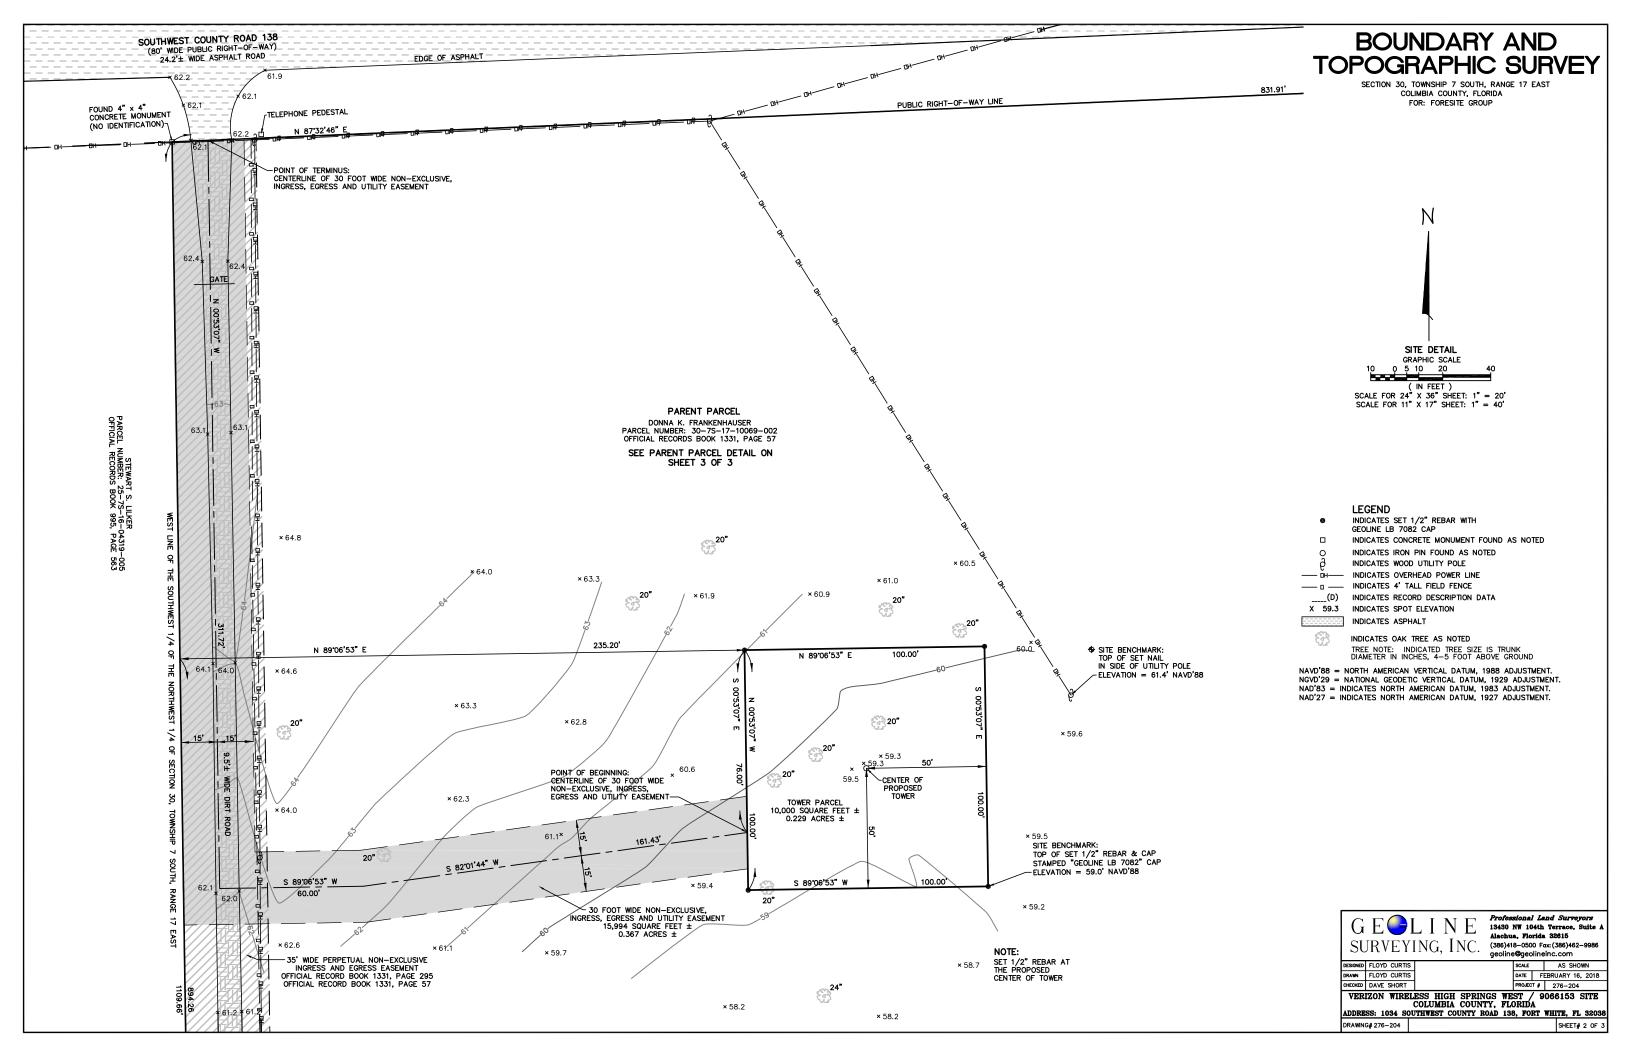

BOUNDARY AND TOPOGRAPHIC SURVEY

SECTION 30, TOWNSHIP 7 SOUTH, RANGE 17 EAST COLIMBIA COUNTY, FLORIDA FOR: FORESITE GROUP

PROPERTY DESCRIPTIONS

PARENT PARCEL

(OFFICIAL RECORD BOOK 1331, PAGE 57)

TOWNSHIP 7 SOUTH, RANGE 17 EAST, SECTION 30: THE WEST 1/2 OF THE SOUTHWEST 1/4 OF THE NORTHWEST 1/4, AND THE WEST 82.50 FEET OF THE EAST 1/2 OF THE SOUTHWEST 1/4 OF THE NORTHWEST 1/4, LESS AND EXEPT FOR THE RIGHT OF WAY FOR STATE ROAD S-138.

TOGETHER WITH THE FOLLOWING DESCRIBED PARCEL. TO WIT:

DESCRIPTION: FRANKENHAUSER

COMMENCE AT THE SW CORNER OF SECTION 30, TOWNSHIP 7 SOUTH, RANGE 17 EAST, COLUMBIA COUNTY, FLORIDA AND RUN N. 00°53'08" W., ALONG SAID WEST LINE OF SECTION 30, 1764.53 FEET TO THE POINT OF BEGINNING; THENCE CONTINUE N. 00°53'07" W., STILL ALONG SAID WEST LINE OF SECTION 30, 880.62 FEET; THENCE N. 88'46'18" E., 1485.25 FEET TO THE WEST LINE OF SANTA FE PLANTATIONS, A SUBDIVISION AS PER PLAT THEREOF RECORDED IN PLAT BOOK 4, PAGE(S) 55-55B, PUBLIC RECORDS OF COLUMBIA COUNTY, FLORIDA; THENCE RUN S. 00'43'44" E., ALONG SAID WEST LINE OF SANTA FE PLANTATIONS, 875.96 FEET; THENCE S. 88'35'27" W., 1482.89 FEET TO THE POINT OF BEGINNING. CONTAINING 29.92 ACRES, MORE OR LESS.

SUBJECT TO AND TOGETHER WITH AN EASEMENT FOR INGRESS AND EGRESS OVER AND ACROSS THE WEST 35 FEET OF SAID SECTION 30, TOWNSHIP 7 SOUTH, RANGE 17 EAST, COLUMBIA COUNTY, FLORIDA, AS LIES SOUTH OF SW COUNTY ROAD NO. 138 AND NORTH OF THE SOUTH 1764.00 FEET OF SAID SECTION 30.

(PREPARED BY GEOLINE SURVEYING, INC.)

THAT PART OF THE WEST 1/2 OF THE SOUTHWEST 1/4 OF THE NORTHWEST 1/4 OF SECTION 30, TOWNSHIP 7 SOUTH, RANGE 17 EAST, COLUMBIA COUNTY, FLORIDA, BEING MORE PARTICULARLY DESCRIBED AS FOLLOWS:

COMMENCE AT THE SOUTHWEST CORNER OF THE SOUTHWEST 1/4 OF THE NORTHWEST 1/4 OF SECTION 30, TOWNSHIP 7 SOUTH, RANGE 17 EAST, COLUMBIA COUNTY, FLORIDA; THENCE NORTH 00°53°07" WEST ALONG THE WEST LINE OF SAID SOUTHWEST 1/4 OF THE NORTHWEST 1/4 FOR 894.26 FEET; THENCE NORTH 89°06'53" EAST FOR 235.20 FEET TO THE POINT OF BEGINNING; THENCE CONTINUE NORTH 89°06'53" EAST FOR 100.00 FEET; THENCE SOUTH 00°53'07" WEST FOR 100.00 FEET; THENCE NORTH 00°53'07" WEST FOR 100.00 FEET; THENCE NORTH 00°53'07" WEST FOR 100.00 FEET; THENCE NORTH 00°53'07" WEST FOR 100.00 FEET TO SAID POINT OF BEGINNING.


CONTAINING 10,000 SQUARE FEET (0.229 ACRES), MORE OR LESS.

30 FOOT WIDE NON-EXCLUSIVE, INGRESS, EGRESS AND UTILITY EASEMENT (PREPARED BY GEOLINE SURVEYING, INC.)


THAT PART OF THE WEST 1/2 OF THE SOUTHWEST 1/4 OF THE NORTHWEST 1/4 OF SECTION 30, TOWNSHIP 7 SOUTH, RANGE 17 EAST, COLUMBIA COUNTY, FLORIDA, LYING WITHIN 15 FEET OF BOTH SIDES OF A CENTERLINE, BEING MORE PARTICULARLY DESCRIBED AS FOLLOWS:

COMMENCE AT THE SOUTHWEST CORNER OF THE SOUTHWEST 1/4 OF THE NORTHWEST 1/4 OF SECTION 30, TOWNSHIP 7 SOUTH, RANGE 17 EAST, COLUMBIA COUNTY, FLORIDA; THENCE NORTH 00°53'07" WEST ALONG THE WEST LINE OF SAID SOUTHWEST 1/4 OF THE NORTHWEST 1/4 FOR 894.26 FEET; THENCE NORTH 89°06'53" EAST FOR 235.20 FEET TO THE NORTHWESTERLY CORNER OF AN 100 FOOT BY 100 FOOT TOWER PARCEL; THENCE SOUTH 00°53'07" EAST ALONG THE WESTERLY LINE OF SAID TOWER PARCEL FOR 76.00 FEET TO THE POINT OF BEGINNING OF THE CENTERLINE OF THE HERREIN DESCRIBED 30 FOOT WIDE NON-EXCLUSIVE, INGRESS, EGRESS AND UTILITY EASEMENT; THENCE SOUTH 82°06'53" WEST FOR 60.00 FEET TO AN INTERSECTION WITH A LINE THAT IS PARALLEL WITH AND OFFSET 15 FEET EAST OF SAID WEST LINE; THENCE NORTH 00°53" OY WEST ALONG SAID PARALLEL LINE FOR 311.72 FEET TO AN INTERSECTION WITH THE SOUTH RIGHT—OF—WAY LINE OF SOUTHWEST COUNTY ROAD 138 AND THE POINT OF TERMINUS OF THE HERREIN DESCRIBED CENTERLINE.

CONTAINING 15,994 SQUARE FEET (0.367 ACRES), MORE OR LESS.

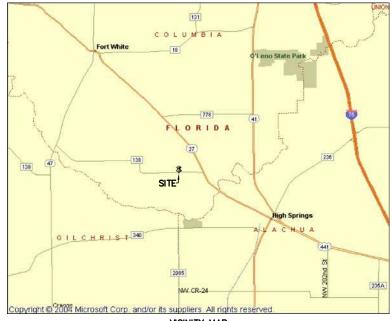

VICINITY MAP NOT TO SCALE

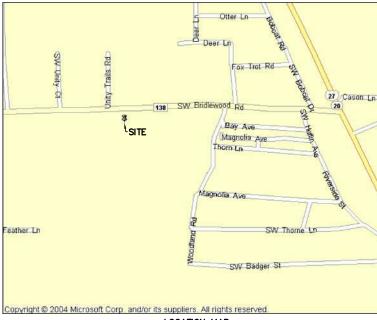

LOCATION MAP NOT TO SCALE



EXISTING CONDITIONS ARE BASED ON A SITE WALK COMPLETED BY FORESITE GROUP ON **TowerCom** 01/31/2018 AND SURVEY PREPARED BY GEOLINE SURVEYING, INC., DATED 05/04/2018. CONTRACTOR SHALL FIELD VERIFY EXISTING CONDITIONS PRIOR TO COMMENCEMENT OF CONSTRUCTION. -EXISTING EDGE OF PAVEMENT EXISTING ADJACENT verizon^v PROPERTY/ROW LINE SW COUNTY RD 138 (80' PUBLIC ROW) - EXISTING TELCO PEDESTAL w | www.fg-inc.net - EXISTING UTILITY POLE (TYP.) 3740 Davinci Ct. n I 770 368 1399 EXISTING PARENT Suite 100 f | 770.368.1944 PROPOSED CONDUIT STUB UP Peachtree Corners, GA 30092 - 30'-0" INGRESS, EGRESS, & UTILITY EASEMENT PARCEL/ROW LINE SEAL:

No. 57905


No. 57906

STATE OF

FLORIDA

PROJECT: (2) PROPOSED FIBER HANDHOLES INSTALLED NEAR PUBLIC ROW (ROW HANDHOLES) EXISTING OVERHEAD POWER LINE (TYP.) (CONTRACTOR TO CONFIRM ADEQUATE CLEARANCE FOR CONSTRUCTION EXISTING GATE EQUIPMENT PRIOR TO CONSTRUCTION COMMENCEMENT, COORDINATE WITH POWER COMPANY AS NEEDED) PARENT PARCEL EXISTING BARBED WIRE DONNA K. FRANKENHAUSER FENCE (TYP.) APN: 30-7S-17-10069-002 DEED: BOOK 1331 PAGE 57 EXISTING EDGE OF TRAILS PROJECT: EXISTING TREE TO -EXISTING DIRT DRIVE REMAIN (TYP.) HIGH SPRINGS WEST **(3)** UNITY 477684 PROPOSED VERIZON -35'-0" PERPETUAL NON-EXCLUSIVE ₩WIRELESS LEASE AREA INGRESS & EGRESS EASEMENT LOCATED AT: (SEE SHEET C-2) OFFICIAL RECORD BOOK 1331 PAGE 295 1034 SW CR 138 **(33** OFFICIAL RECORD BOOK 1331 PAGE 57 FT. WHITE, FL 32038 STEWART LILKER APN: 25-7S-16-04319-005 DEED: BOOK 995 PAGE 563 58 (2) PROPOSED FIBER HANDHOLES -**(3**) PROPOSED SELF (COMPOUND HANDHOLES) SUPPORT TOWER (2) PROPOSED VERIZON WIRELESS 2" FIBER CONDUITS WITH MULE TAPE FROM COMPOUND PROPOSED 12' GRAVEL HANDHOLE TO ROW HANDHOLE (570± LF). ACCESS DRIVE HANDHOLES SHALL BE SPACED AT 400' MAX. (2) PROPOSED TOWERCOM 4" CONDUITS FOR POWER FROM MULTI-TENANT METER BANK TO PUBLIC ROW (585± LF). CONTRACTOR SHALL COORDINATE WITH THE LOCAL UTILITY PROVIDER TO VERIFY ROUTING & FINAL CONNECTION POINT. (SEE SHEET E-2) PROPOSED 70'x80' - PROPOSED 16' CATTLE GATE 100'x100' TOWER (SEE SHEET C-1.1) LEASE AREA 3 PROPOSED DISTURBANCE AREA - PROPOSED MULTI-TENANT TITLE: (SEE GRADING PLAN) H-FRAME GRAPHIC SCALE **(3)** EXISTING TREE TO BE 30' 60' REMOVED (TYP. OF 5) **OVERALL SITE PLAN** (SCALE IN FEET) SHEET NUMBER: 11x17 SCALE: 1"=60' JOB/FILE NUMBER: 24x36 SCALE: 1"=30' 1306.002




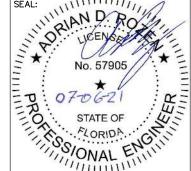


APPROVALS
CARRIER
LANDLORD
LEASING
CONSTRUCTION
REVISIONS DATE

ISSUED FOR:	PERMIT/CONSTRUCTION
PROJECT MANAGER:	MWM
DRAWING BY:	MWM
DATE:	07/06/21
T.T. C	

OVERALL SITE PLAN C-1

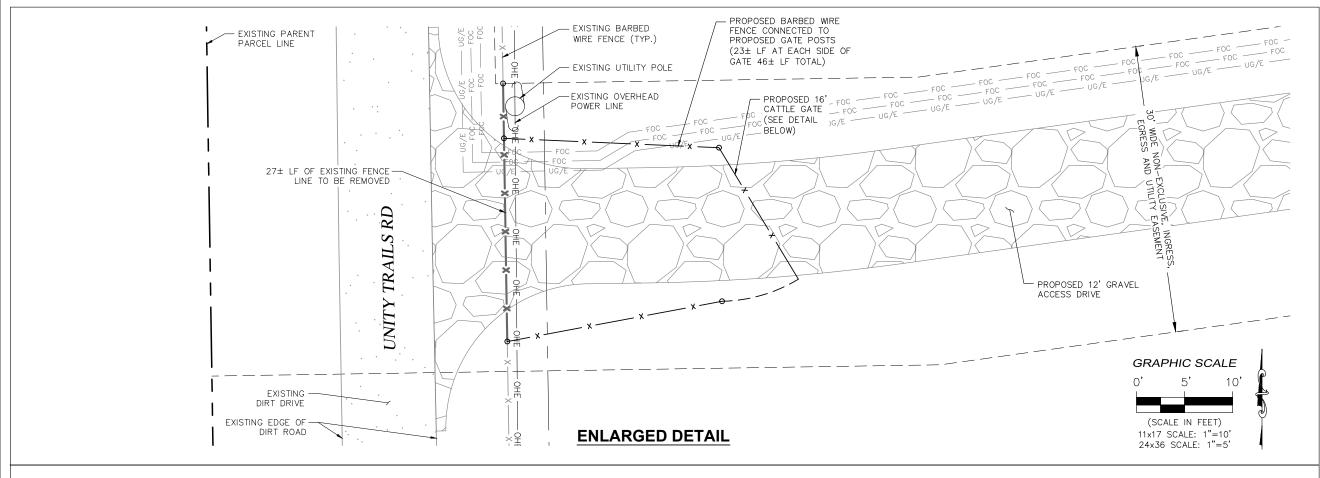

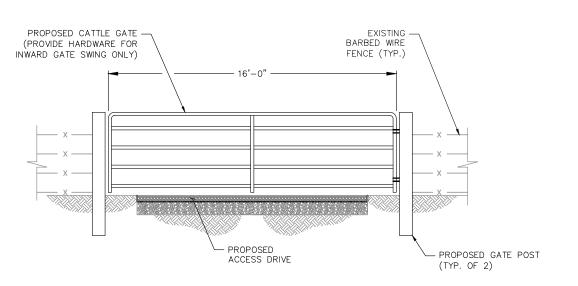


CATTLE GATE DETAIL NOT TO SCALE





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PROJECT:

HIGH SPRINGS WEST 477684

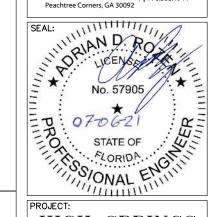
LOCATED AT: 1034 SW CR 138 FT. WHITE, FL 32038

APPROVALS	
CARRIER	
LANDLORD	
LEASING	
CONSTRUCTION	
REVISIONS	DATE

ISSUED FOR:	PERMIT/CONSTRUCTION
PROJECT MANAGER:	MWM
DRAWING BY:	MWM
DATE:	07/06/21
TITLE:	

CATTLE GATE DETAIL

SHEET NUMBER: C - 1.1JOB/FILE NUMBER: 1306.002

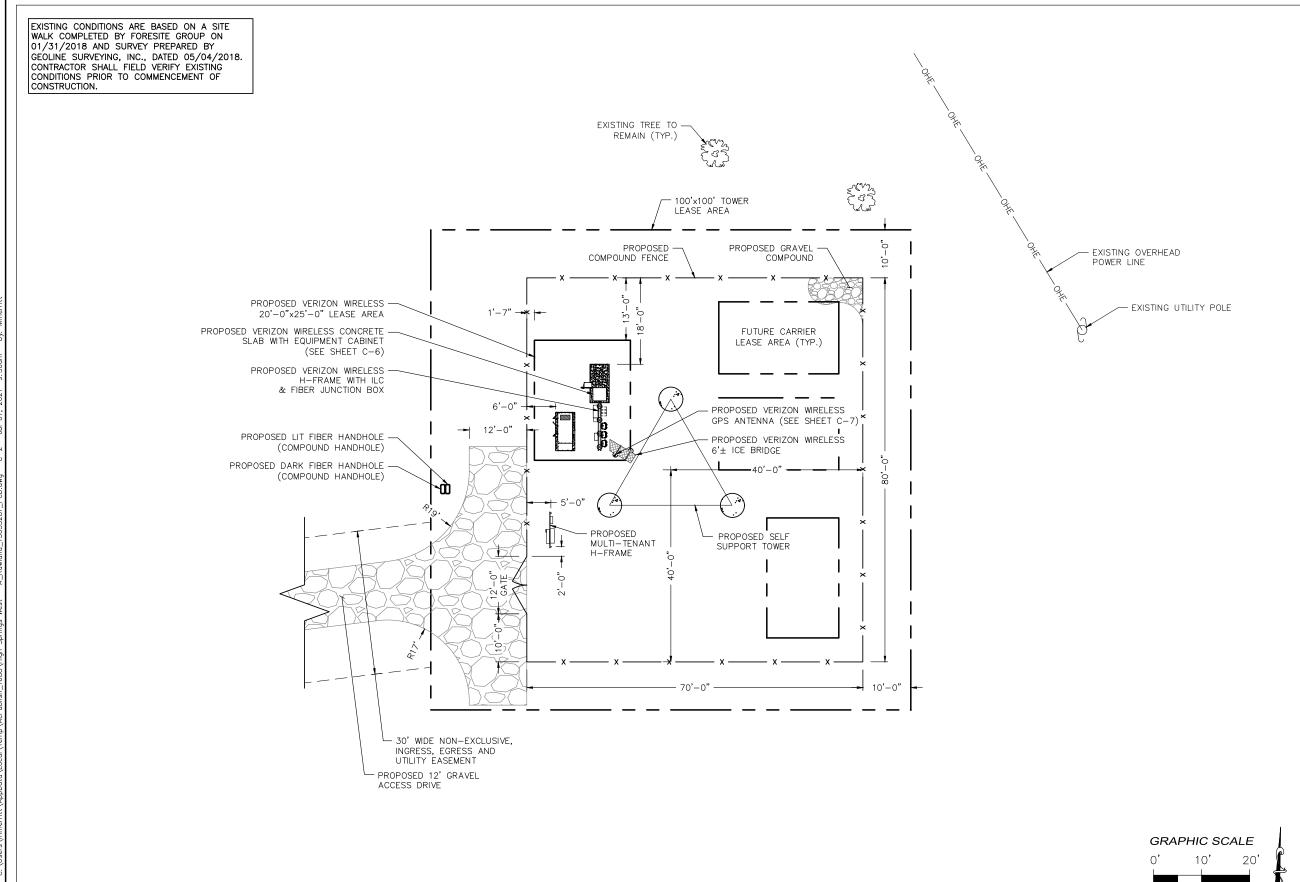






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PROJECT:

HIGH SPRINGS WEST 477684

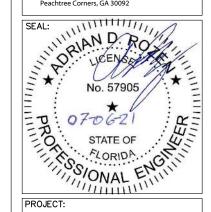LOCATED AT: 1034 SW CR 138 FT. WHITE, FL 32038

APPROVALS CARRIER LANDLORD LEASING CONSTRUCTION REVISIONS DATE


ISSUED FOR: PERMIT/CONSTRUCTION PROJECT MANAGER: MWM DRAWING BY: MWM DATE: 07/06/21

TITLE:

ENLARGED SITE PLAN SHEET NUMBER: C-2JOB/FILE NUMBER: 1306.002

(SCALE IN FEET) 11x17 SCALE: 1"=20' 24x36 SCALE: 1"=10'

ENLARGED SITE PLAN

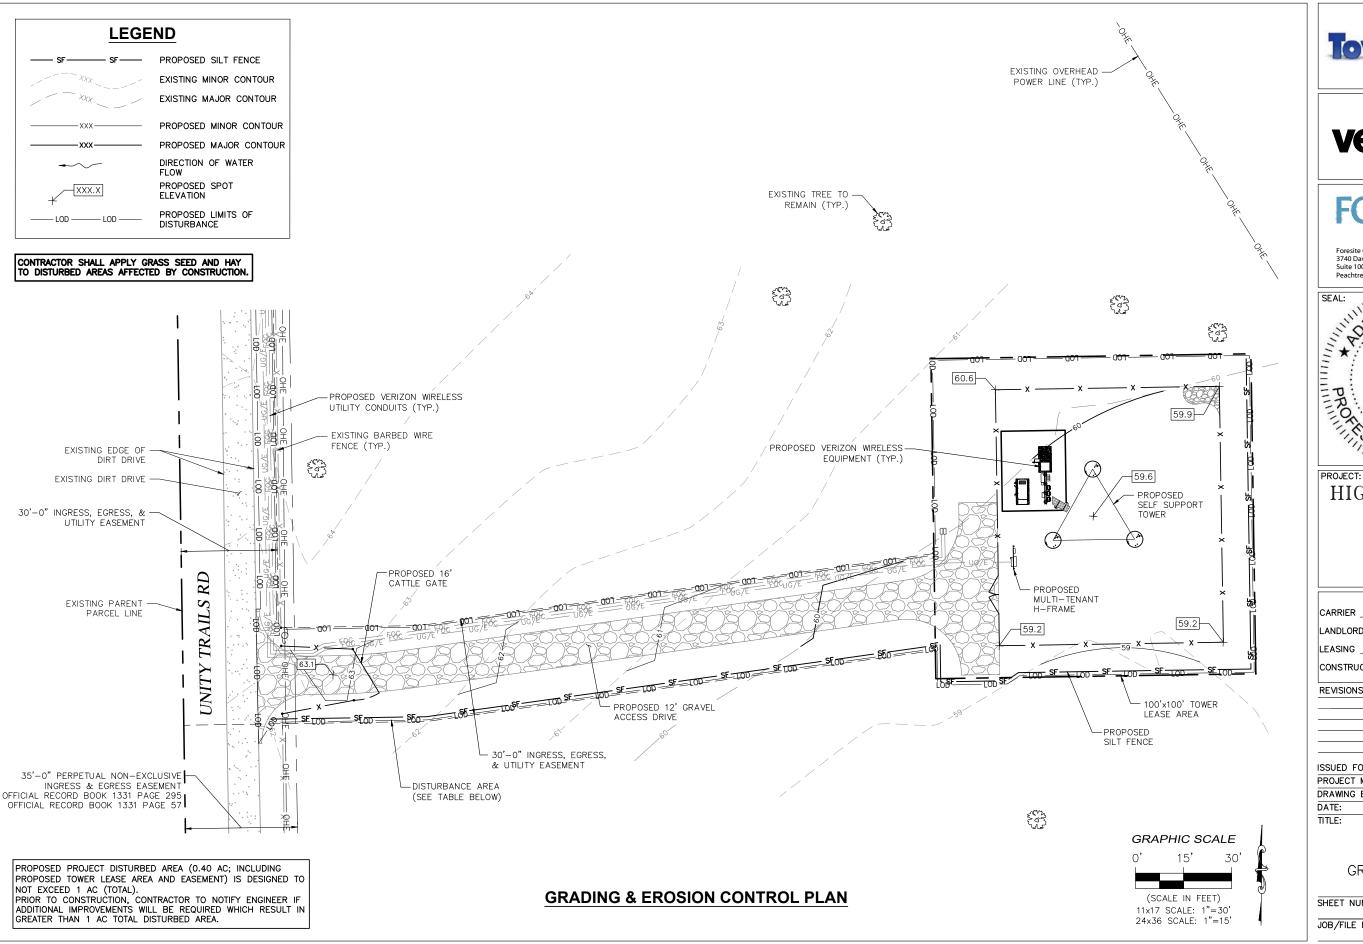






FORESITE group

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HIGH SPRINGS

WEST 477684
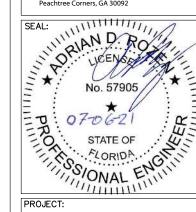
> LOCATED AT: 1034 SW CR 138 FT. WHITE, FL 32038

APPROVALS

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GRADING & EROSION CONTROL PLAN

SHEET NUMBER: C-3JOB/FILE NUMBER: 1306.002

SILT FENCE NOTES:

- 1) GEOTEXTILE FABRIC TO BE FASTENED SECURELY TO FENCE POST BY WIRE TIES OR HOG RINGS.(3 FASTENERS
- 2) ENDS OF INDIVIDUAL ROLLS OF GEOTEXTILE SHALL BE SECURELY FASTENED TO A COMMON POST OR OVERLAPPED 3' MINIMUM.
- 3) THIS DEVICE IS INTENDED TO CONTROL SHEET FLOW ONLY. DO NOT USE IN AREAS OF CONCENTRATED FLOW WITH A DRAINAGE AREA OF 1/2 ACRE OR MORE.
- 4) ALL SILT FENCING SHALL BE INSTALLED PRIOR TO COMMENCING ANY LAND DISTURBING ACTIVITIES, AND SHALL REMAIN IN PLACE UNTIL ALL CONSTRUCTION ACTIVITIES ARE COMPLETED.





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HIGH SPRINGS WEST 477684

LOCATED AT: 1034 SW CR 138 FT. WHITE, FL 32038

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CONSTRUCTION	
DEVICIONS	DATE

ISSUED FOR: PERMIT/CONSTRUCTION

PROJECT MANAGER: MWM DRAWING BY: MWM DATE: 07/06/21 TITLE:

EROSION CONTROL DETAILS SHEET NUMBER:

C - 3.1


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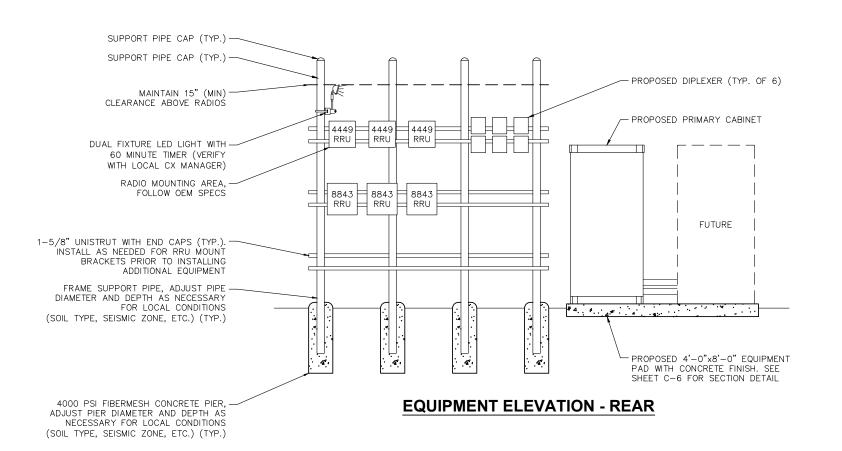
1306.002

SILT FENCE DETAIL NOT TO SCALE

NOTES:

- 1. ALL WORK SHALL CONFORM TO THE NATIONAL ELECTRICAL CODE, STATE BUILDING CODES AND THE LOCAL BUILDING CODES. ALL COMPONENTS SHALL BE U.L. LISTED.
- 2. REFER TO SHEET C-2 FOR EQUIPMENT LAYOUT AND EXACT LOCATION OF VERIZON H-FRAME.
- 3. CONTRACTOR TO COORDINATE WITH LOCAL UTILITY COMPANY FOR INSTALLATION OF NEW METER IN UTILITY H-FRAME.
- 4. COORDINATE EXACT LOCATION OF UNDERGROUND FEEDERS AND CIRCUITRY WITH THE OWNER.
- 5. CONTRACTOR SHALL COORDINATE EFFORTS WITH (LOCAL, ELECTRICAL) AUTHORITY HAVING JURISDICTION (AHJ) AND OTHER TRADES TO DETERMINE "FROST" LINE, AND TYPES OF RACEWAYS REQUIRED FOR INSTALLATION.
- 6. BOND ALL ELECTRICAL EQUIPMENT TO RACK.
- 7. DIMENSIONS SHOWN ARE APPROXIMATE AND MAY BE ALTERED IN THE FIELD AS APPROVED BY OWNER TO BETTER SUIT ACTUAL CONDITIONS OR EQUIPMENT RECEIVED.
- 8. FOR ANY METAL CONDUIT ENTERING AN ENCLOSURE WHERE A PRE—PUNCHED CONCENTRIC OR ECCENTRIC KNOCKOUT IS USED, THE CONTRACTOR SHALL ENSURE ADEQUATE BONDING BETWEEN THE METAL CONDUIT AND ENCLOSURE BY INSTALLING A BONDING JUMPER AROUND THE CONCENTRIC OR ECCENTRIC KNOCKOUT
- 9. CONTRACTOR SHALL INSURE THAT NO OPERABLE DEVICE SHALL EXCEED 6'-6" TO CENTER LINE OF DEVICE.
- 10. GENERATOR STOP SWITCH TO BE FURNISHED BY LESSEE AND INSTALLED BY GC.
- 11. ILC TO BE FURNISHED BY VZW AND INSTALLED BY GC.



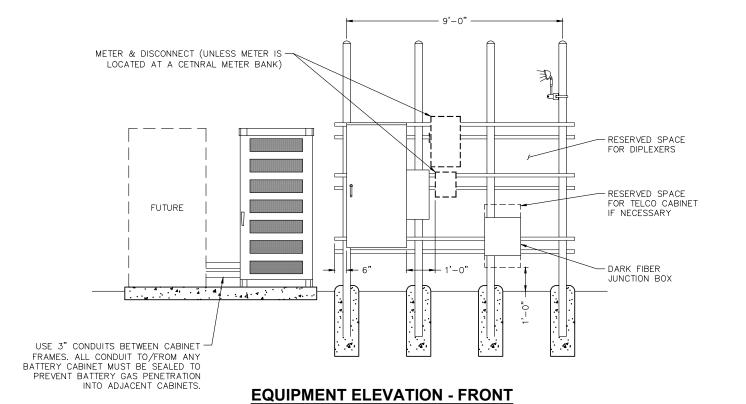








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PROJECT:

HIGH SPRINGS WEST 477684

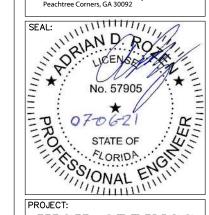
LOCATED AT: 1034 SW CR 138 FT. WHITE, FL 32038

APPROVALS	
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TITLE:	


EQUIPMENT DETAILS SHEET NUMBER:

C-4JOB/FILE NUMBER: 1306.002

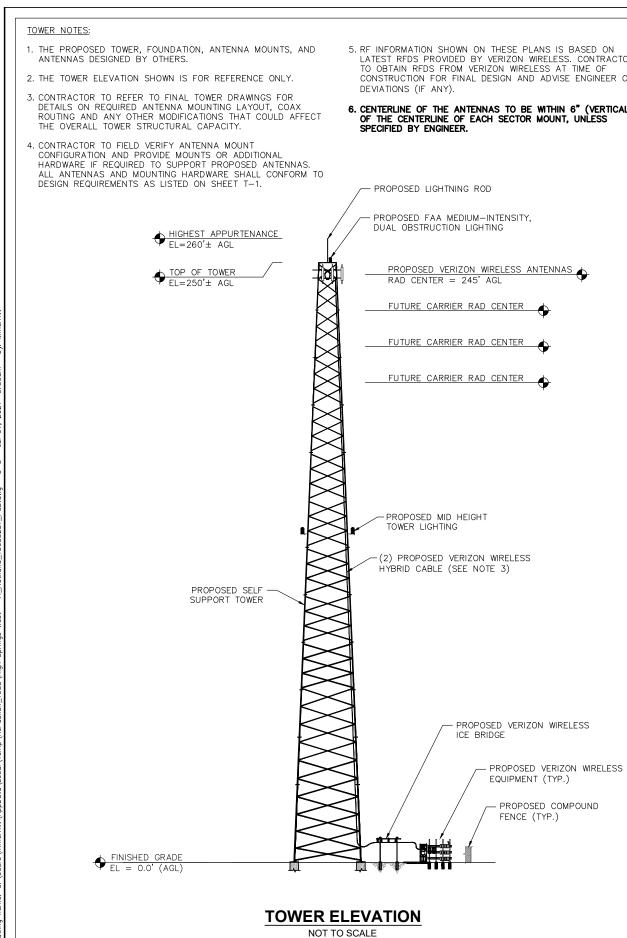

5. RF INFORMATION SHOWN ON THESE PLANS IS BASED ON LATEST RFDS PROVIDED BY VERIZON WIRELESS. CONTRACTOR TO OBTAIN RFDS FROM VERIZON WIRELESS AT TIME OF CONSTRUCTION FOR FINAL DESIGN AND ADVISE ENGINEER OF

6. CENTERLINE OF THE ANTENNAS TO BE WITHIN 6" (VERTICALLY) OF THE CENTERLINE OF EACH SECTOR MOUNT, UNLESS

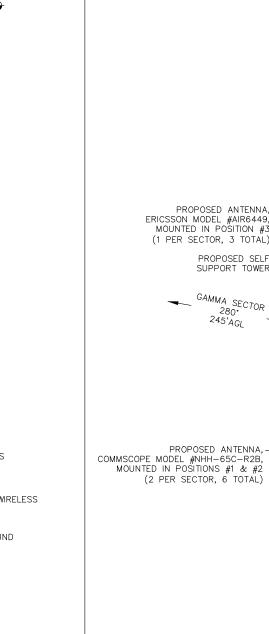

PROPOSED ANTENNA. ERICSSON MODEL #AIR6449, MOUNTED IN POSITION #3

PROPOSED SELF SUPPORT TOWER

GAMMA SECTOR

280° 245'AGL

(1 PER SECTOR, 3 TOTAL)

(2 PER SECTOR, 6 TOTAL)

GENERAL CONTRACTOR TO

PROPOSED 2" SCH. 40 PIPE, 8' LONG, (SITEPRO1 MODEL #P296 OR APPROVED EQUAL) (3 PER SECTOR, 9 TOTAL)

PROPOSED STIFF-ARM (INCLUDED WITH MOUNT) (TYP.)

(1 PER SECTOR, 3 TOTAL)


-PROPOSED SECTOR FRAME, SITEPRO1 MODEL #VFA12-HD, OR EQUAL VERIZON WIRELESS NSTD-445 APPROVED MOUNT





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PROJECT: HIGH SPRINGS WEST 477684

LOCATED AT: 1034 SW CR 138 FT. WHITE, FL 32038
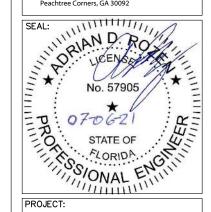
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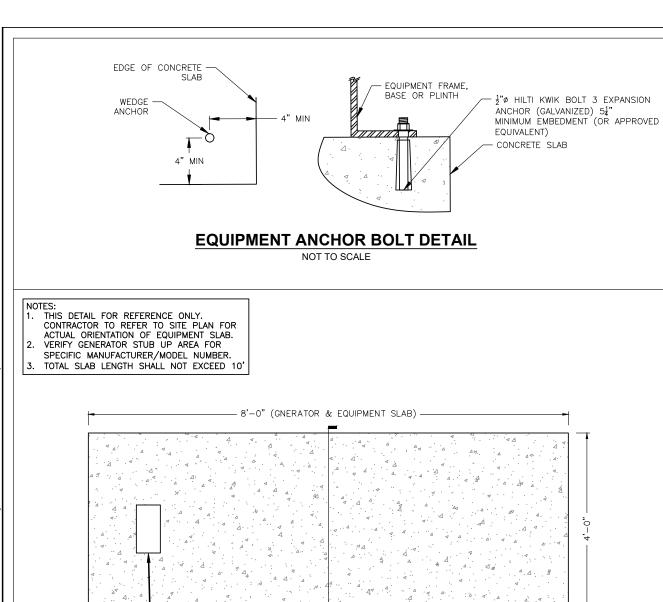
ISSUED FOR: PERMIT/CONSTRUCTION PROJECT MANAGER: MWM DRAWING BY: MWM 07/06/21 DATE: TITLE:

> TOWER ELEVATION & ANTENNA ORIENTATION

> > C-5


SHEET NUMBER: JOB/FILE NUMBER: 1306.002

PROPOSED ANTENNA ORIENTATION DETAIL NOT TO SCALE



COMPOUND BASE DETAIL NOT TO SCALE

TYPICAL FOR ENTIRE FENCE AREA

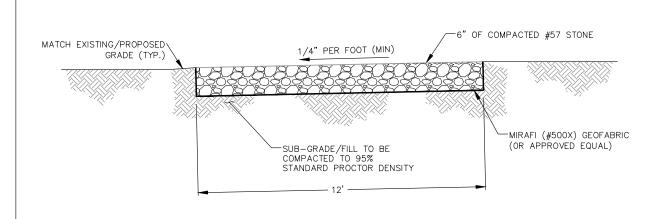

CROSS-SLOPED DRIVE - PROPOSED ACCESS DRIVE DETAIL NOT TO SCALE

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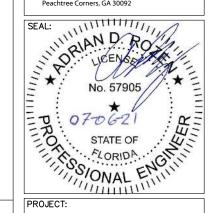
6" COMPACTED #57 STONE

MIRAFI (#500X) GEOFABRIC

(OR APPROVED EQUAL)

SUB-GRADE COMPACTED TO 95% STANDARD PROCTOR DENSITY

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PROJECT: HIGH SPRINGS WEST 477684

LOCATED AT: 1034 SW CR 138 FT. WHITE, FL 32038

APPROVALS CARRIER LANDLORD LEASING CONSTRUCTION REVISIONS DATE

ISSUED FOR: PERMIT/CONSTRUCTION PROJECT MANAGER: MWM DRAWING BY: MWM DATE: 07/06/21 TITLE:

FOUNDATION & ACCESS DRIVE DETAILS SHEET NUMBER: C-6JOB/FILE NUMBER: 1306.002

3/4" CHAMFER (TYP.) 8" (MIN.) CAST IN PLACE CONCRETE SLAB -TOP OF CONC (4000 PSI CONCRETE WITH FIBERMESH 650 OR APPROVED EQUAL) PROPOSED GRAVEL - (MIN.) ^{_} - 6 MIL POLYVINYL VAPOR BARRIER UNDER PAD PREPARED SUBGRADE COMPACTED TO 98% **SECTION A**

SLAB DETAIL

NOT TO SCALE


NOT TO SCALE


PROPOSED KNOCK OUT -

FOR CONDUITS TO BE INSTALLED ON

GENERATOR SLAB ONLY (SEE SHEET C-9 FOR

EXACT LOCATION)

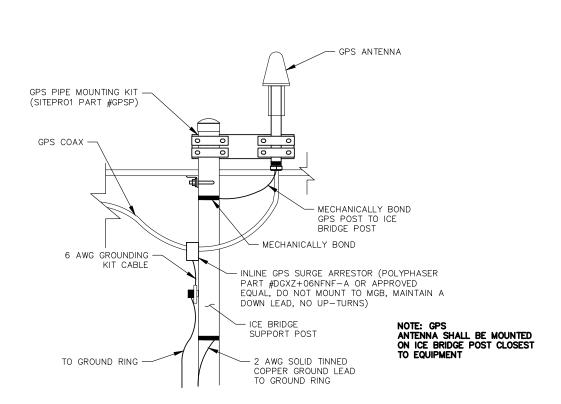

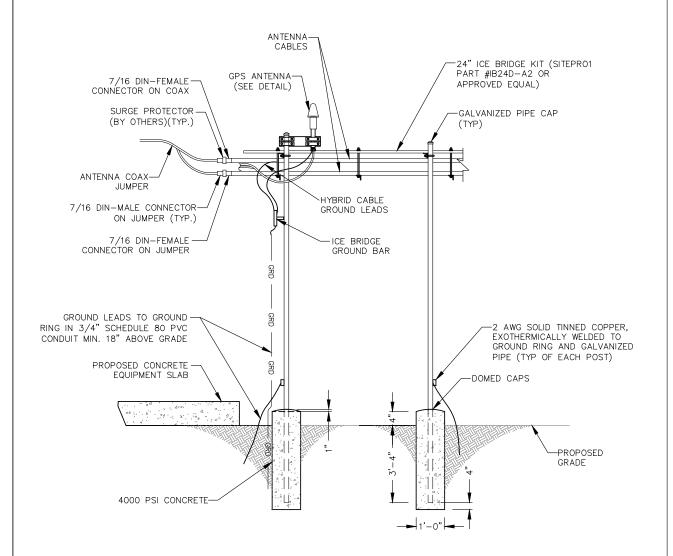

ICE BRIDGE ELEVATION

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HIGH SPRINGS WEST 477684

LOCATED AT: 1034 SW CR 138 FT. WHITE, FL 32038

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ISSUED FOR:	PERMIT/CONSTRUCTION			
PROJECT MANAGER:	MWM			
DRAWING BY:	MWM			
DATE:	07/06/21			
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ICE BRIDGE DETAILS SHEET NUMBER: C-7JOB/FILE NUMBER:

1306.002

GPS MOUNTING DETAIL

NOT TO SCALE


FENCE NOTES:

(INSTALL FENCING PER ASTM F-567, SWING GATES PER ASTM F- 900) Ì. GATE POST: 3½" DIA. SCHEDULE 40 PER ASTM-F 1083.


- 2. CORNER AND TERMINAL OR PULL POST: 3" DIA. SCHEDULE 40 PER ASTM-F 1083.
- 3. LINE POST: 2" DIA. SCHEDULE 40 PIPE PER ASTM-F 1083.
- 4. GATE FRAME: 11/2" DIA. SCHEDULE 40 PIPE PER ASTM-F 1083.
- 5. TOP RAIL AND BRACE RAIL: 11/2" DIA. SCHEDULE 40 PIPE PER ASTM-F 1083.
- 6. FABRIC: 9 GA. CORE WIRE SIZE 2" MESH, CONFORMING TO ASTM-A392.
- 7. TIE WIRE: MINIMUM 9 GA. GALVANIZED STEEL AT POSTS AND RAILS A SINGLE WRAP OF FABRIC TIE AND AT TENSION WIRE BY HOG RINGS SPACED MAXIMUM 24" INTERVALS.
- 8. TENSION WIRE: 6 GA. GALVANIZED STEEL.
- 9. BARBED WIRE DOUBLE STRAND 12-1/2" GA. TWISTED WIRE TO MATCH WITH FABRIC 14 GA., 4 PT. BARBS SPACED ON APPROXIMATELY 5" CENTERS.
- 10. GATE LATCH: STYMIE STYLE LOCK, KEYED ALIKE FOR ALL SITES IN A GIVEN MTA.
- 11. COMPLY WITH ANY LOCAL ORDINANCES REQUIRING PERMITS FOR PLACEMENT OF BARBED
- 12. WARNING SIGNS USING THE INTERNATIONAL SYMBOL OF ELECTRICAL SHOCK HAZARD SHALL BE FURNISHED AND INSTALLED ON THE EXTERIOR OF ALL SIDES OF THE MAIN PERIMETER FENCE AND THE GATE. ADDITIONALLY, SIGNS SHALL BE FURNISHED AND INSTALLED THAT STATE "NO TRESPASSING" IN ENGLISH. THE SIGNS SHALL BE IMPERVIOUS TO WEATHERING AND BE MOUNTED TO AVOID EASE OF REMOVAL BY VANDALS.

TYPICAL WOVEN WIRE FENCING NOTES

NOT TO SCALE

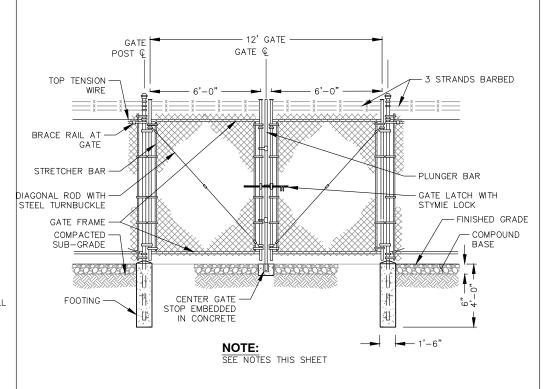


DOUBLE SWING GATE DETAIL NOT TO SCALE

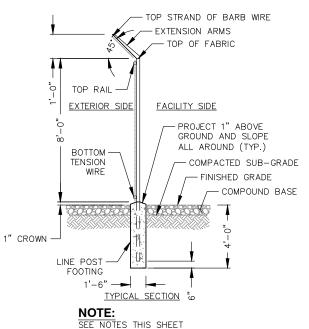

WOVEN WIRE FENCE DETAIL

NOT TO SCALE

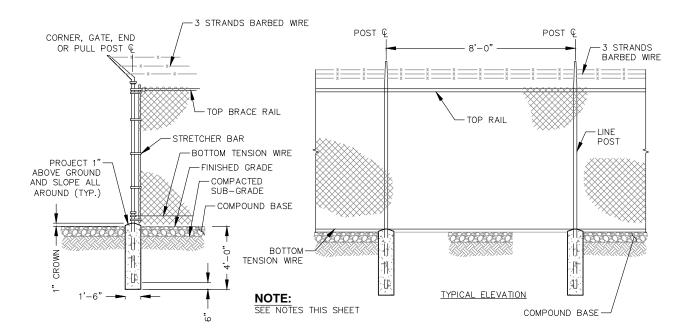

WOVEN WIRE CORNER, GATE, END OR PULL POST DETAIL


NOT TO SCALE





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PROJECT: HIGH SPRINGS WEST 477684


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APPROVALS CARRIER LANDLORD LEASING CONSTRUCTION REVISIONS DATE

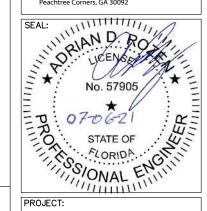ISSUED FOR: PERMIT/CONSTRUCTION PROJECT MANAGER: MWM DRAWING BY: MWM DATE: 07/06/21 TITLE:

FENCE DETAILS SHEET NUMBER:

C-8JOB/FILE NUMBER: 1306.002

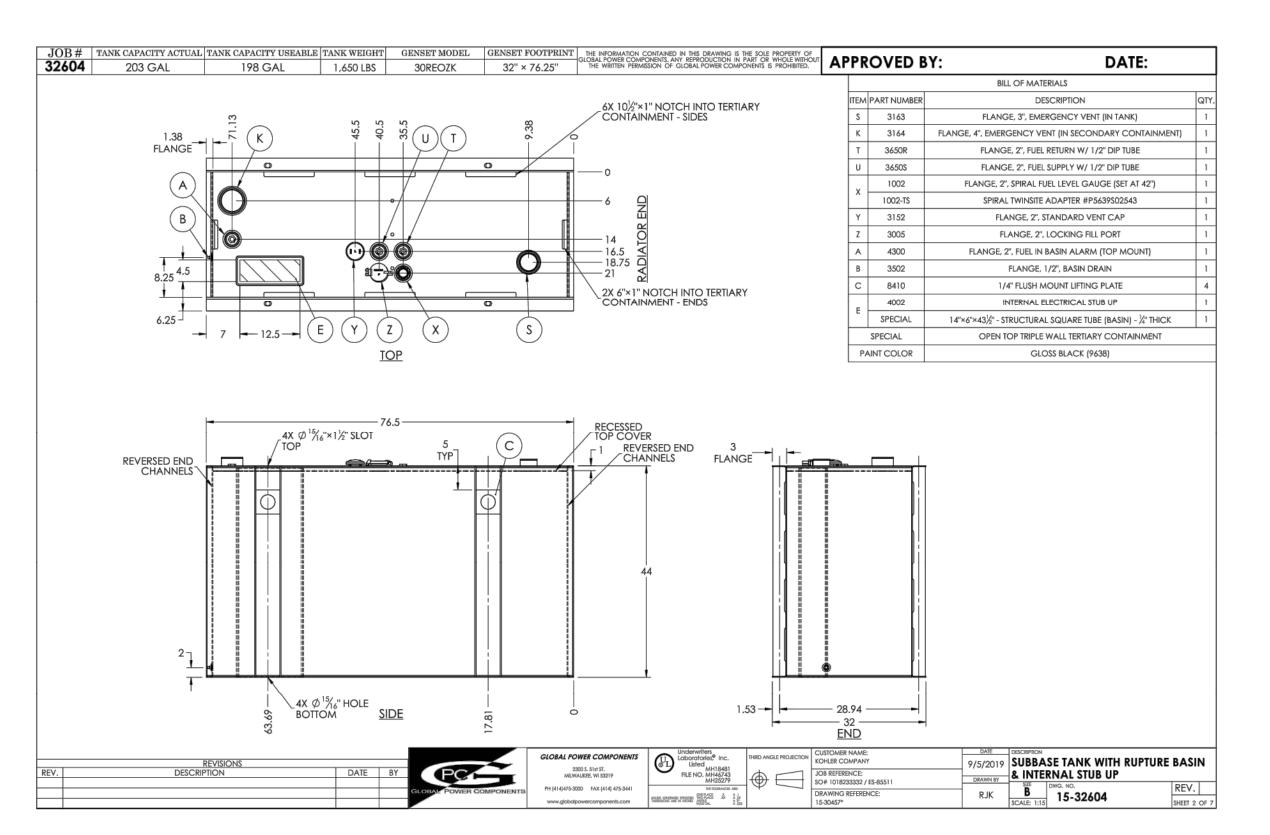


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PROJECT:

HIGH SPRINGS WEST 477684

LOCATED AT: 1034 SW CR 138 FT. WHITE, FL 32038

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CARRIER	
LANDLORD	
LEASING	
CONSTRUCTION	
REVISIONS	DATE

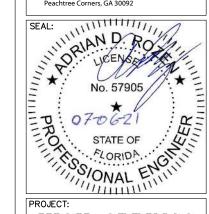SSUED FOR:	PERMIT/CONSTRUCTION			
PROJECT MANAGER:	MWM			
DRAWING BY:	MWM			
DATE:	07/06/21			
TITLE:				

GENERATOR DETAILS

SHEET NUMBER: C-9JOB/FILE NUMBER: 1306.002

NOTE:

GENERATOR SPEC SHEET

FOR REFERENCE ONLY

ELECTRICAL INSTALLATION NOTES

- 1. ALL ELECTRICAL WORK SHALL BE PERFORMED IN ACCORDANCE WITH THE PROJECT SPECIFICATIONS, NEC AND ALL APPLICABLE LOCAL CODES.
- 2. ALL ELECTRICAL EQUIPMENT AND ACCESSORIES SHALL BE U.L. APPROVED OR LISTED.
- 3. CONDUIT ROUTINGS ARE SCHEMATIC. CONTRACTOR SHALL INSTALL CONDUITS SO THAT ACCESS TO EQUIPMENT IS NOT BLOCKED.
- 4. WIRING, RACEWAY AND SUPPORT METHODS AND MATERIALS SHALL COMPLY WITH THE REQUIREMENTS OF THE NEC.
- 5. ALL CIRCUITS SHALL BE SEGREGATED AND MAINTAIN MINIMUM CABLE SEPARATION AS REQUIRED BY THE NEC.
- 6. CABLES SHALL NOT BE ROUTED THROUGH LADDER-STYLE CABLE TRAY RUNGS.
- 7. EACH END OF EVERY POWER, POWER PHASE CONDUCTOR (I.E., HOTS), GROUNDING, AND T1 CONDUCTOR AND CABLE SHALL BE LABELED WITH COLOR-CODED INSULATION OR ELECTRICAL TAPE (3M BRAND, ½ INCH PLASTIC ELECTRICAL TAPE WITH UV PROTECTION, OR EQUAL). THE IDENTIFICATION METHOD SHALL CONFORM WITH NE & OSHA.
- 8. ALL ELECTRICAL COMPONENTS SHALL BE CLEARLY LABELED WITH ENGRAVED LAMACOID PLASTIC LABELS. ALL EQUIPMENT SHALL BE LABELED WITH THEIR VOLTAGE RATING, PHASE CONFIGURATION, WIRE CONFIGURATION, POWER OR AMPACITY RATING, AND BRANCH CIRCUIT ID NUMBERS (IE., PANELBOARD AND CIRCUIT ID'S).
- PANELBOARDS (ID NUMBERS) AND INTERNAL CIRCUIT BREAKERS (CIRCUIT ID NUMBERS) SHALL BE CLEARLY LABELED WITH ENGRAVED LAMACOID PLASTIC LABELS.
- 10. POWER, CONTROL, AND EQUIPMENT GROUND WIRING IN TUBING OR CONDUIT SHALL BE SINGLE CONDUCTOR (#14 AWG OR LARGER), 600 V, OIL RESISTANT THHN OR THWN-2 OR XHHW-2, STRANDED COPPER CABLE RATED FOR 90'C (WET AND DRY) OPERATION; LISTED OR LABELED FOR THE LOCATION AND RACEWAY SYSTEM USED, UNLESS OTHERWISE SPECIFIED.
- 11. POWER AND CONTROL WRING, NOT IN TUBING OR CONDUIT, SHALL BE MULTI-CONDUCTOR, TYPE USE-2 CABLE (314 AWG OR LARGER), 600 V, OIL RESISTANT RHW-2 OR XHHW-2, STRANDED COPPER CABLE RATED FOR 90'C (WET AND DRY) OPERATION; WITH OUTER JACKET; LISTED OR LABELED FOR THE LOCATION USED, UNLESS OTHERWISE SPECIFIED.
- 12. ALL POWER AND GROUNDING CONNECTIONS SHALL BE CRIMP-STYLE, COMPRESSION WIRE LUGS AND WIRE NUTS BY THOMAS AND BETTS (OR EQUAL). LUGS AND WIRE NUTS SHALL BE RATED FOR OPERATION AT NO LESS THAN 90°C.
- 13. RACEWAY AND CABLE TRAY SHALL BE LISTED OR LABELED FOR ELECTRICAL USE IN ACCORDANCE WITH NEMA, UL, ANSI/IEEE, AND NEC.
- 14. ELECTRICAL METALLIC TUBING (EMT) OR RIGID METALLIC CONDUIT (RMC) SHALL BE USED FOR EXPOSED INDOOR LOCATIONS.
- 15. ELECTRICAL METALLIC TUBING (EMT) OR RIGID METALLIC CONDUIT (RMC) SHALL BE USED FOR CONCEALED INDOOR LOCATIONS.
- 16. RIGID NON-METALLIC CONDUIT (I.E., RIGID PVC SCHEDULE 80) SHALL BE USED UNDERGROUND; DIRECT BURIED, IN AREAS OF OCCASIONAL LIGHT VEHICLE TRAFFIC OR IN ARES OF HEAVY VEHICLE TRAFFIC, GALVANIZED RIGID CONDUIT SHALL BE USED.
- 17. ALL OUTDOOR EXPOSED CONDUIT SHALL BE RMC AND SHALL BE SUPPORTED ADEQUATELY.
- 18. LIQUID-TIGHT FLEXIBLE METALLIC CONDUIT LTMC) SHALL BE USED INDOORS AND OUTDOORS, WHERE VIBRATION OCCURS OR FLEXIBILITY IS NEEDED. LFMC SHALL CONFORM TO NEC ARTICLE 350.
- 19. CONDUIT AND TUBING FITTINGS SHALL BE THREADED OR COMPRESSION—TYPE AND APPROVED FOR THE LOCATION USED. SET SCREW FITTINGS ARE NOT ACCEPTABLE
- 20. CABINETS, BOXES, AND WIREWAYS SHALL BE LISTED OR LABELED FOR ELECTRICAL USE IN ACCORDANCE WITH NEMA, UL, ANSI/IEEE, AND NEC.
- 21. WIREWAYS SHALL BE EPOXY-COATED (GRAY) AND INCLUDE A HINGED COVER, DESIGNED TO SWING OPEN DOWNWARD; SHALL BE PANDUIT TYPE E (OR EQUAL); AND RATED NEMA 1 (OR BETTER) INDOORS, OR NEMA 3R (OR BETTER) OUTDOORS.
- 22. EQUIPMENT CABINETS, TERMINAL BOXES, JUNCTION BOXES, AND PULL BOXES SHALL BE GALVANIZED OR EPOXY—COATED SHEET STEEL, SHALL MEET OR EXCEED UL 50, AND RATED NEMA 1 (OR BETTER) INDOORS, OR WEATHER PROTECTED (WP OR BETTER) OUTDOORS.
- 23. METAL RECEPTACLE, SWITCH, AND DEVICE BOXES SHALL BE GALVANIZED, EPOXY—COATED, OR NON—CORRODING; SHALL MEET OR EXCEED UL 514A AND NEMA OS 1 (OR BETTER) INDOORS, OR WEATHER PROTECTED (WP OR BETTER) OUTDOORS.
- 24. NON-METALLIC RECEPTACLE, SWITCH, AND DEVICE BOXES SHALL MEET OR EXCEED NEMA OS 2; AND RATED NEMA 1 (OR BETTER) INDOORS, OR WEATHER PROTECTED (WP OR BETTER) OUTDOORS.
- 25. CONTRACTOR SHALL APPLY FOR ELECTRICAL SERVICE AS SOON AS POSSIBLE AND COORDINATE REQUIREMENTS, SERVICE ROUTING, AND METER SOCKET TYPE WITH LOCAL POWER COMPANY.

ELECTRICAL INSTALLATION NOTES (CONT.)

- 26. CONTRACTOR SHALL APPLY FOR TELEPHONE SERVICE AS SOON AS POSSIBLE AND COORDINATE REQUIREMENTS AND SERVICE ROUTING WITH TELEPHONE COMPANY.
- 27. CONTRACTOR SHALL OBTAIN ALL PERMITS, PAY PERMIT FEES, AND SCHEDULE INSPECTIONS.
- 28. ALL SAFETY SWITCHES SHALL BE NEMA 1 FOR INDOOR, NEMA 3R FOR OUTDOOR, UL LISTED 200K SCCR RATED, REJECTION TYPE, WITH RK1 FUSES. FUSES SHALL HAVE AN AIR OF 200K AND SHALL HAVE A LIMITING RATING AS SHOWN IN THESE DRAWINGS. EQUIPMENT AND ACCESSORIES SHALL BE RATED FOR 75 DEGREES CELSIUS OR HIGHER.
- 29. ALL LOAD CENTERS SHALL BE 42 SPACE UNLESS NOTED OTHERWISE, NEMA 1 FOR INDOOR, NEMA 3R FOR OUTDOOR, MCB WITH CONVERTIBLE MAINS, UL LISTED 22K IA OR HIGHER SCCR, WITH 22K AIR BREAKERS, BREAKERS AND LOAD CENTER SHALL BE RATED FOR 75 DEGREES CELSIUS OR HIGHER. BREAKERS SHALL HAVE A LIMITING RATING AS SPECIFIED ON THESE DRAWINGS.
- 30. CONTRACTOR SHALL LABEL ELECTRICAL EQUIPMENT IN ACCORDANCE WITH NEC 110.16 AND 110.24.
- 31. CONTRACTOR SHALL VERIFY THAT THE MAIN BONDING JUMPER AND GROUNDING ELECTRODE CONDUCTOR IS INSTALLED PROPERLY AT SERVICE ENTRANCE.
- 32. CONTRACTOR SHALL SEAL AROUND ALL CONDUIT PENETRATIONS TO PREVENT MOISTURE PENETRATION OR VERMIN INFESTATIONS
- 33. DURING TRENCH BACK-FILLING FOR EACH UNDERGROUND ELECTRICAL, TELEPHONE, SIGNAL AND COMMUNICATIONS LINE, PROVIDE A CONTINUOUS UNDERGROUND WARNING TAPE TWELVE INCHES BELOW FINISHED GRADE.

GROUNDING NOTES


- 1. ALL GROUNDING CONNECTIONS SHALL BE MADE USING EXOTHERMIC WELDING PROCESS (CAD WELD OR EQUAL) EXCEPT FOR EQUIPMENT THAT MAY BE MECHANICALLY FASTENED. ALL LUGS SHALL BE TWO HOLE, LONG BARREL TYPE, FOR COPPER, UNLESS OTHERWISE NOTED.
- 2. ALL GROUND RODS SHALL BE INSTALLED AT 30" BELOW GRADE PER MANUFACTURER'S SPECIFICATIONS. UNDERGROUND GROUNDING CONDUCTORS SHALL BE 30" BELOW GRADE.
- 3. ALL EXTERIOR GROUND CONDUCTORS SHALL BE MIN. #2 AWG SOLID TINNED BARE COPPER WIRE. EQUIPMENT GROUND CONDUCTORS SHALL BE MIN. #6 GREEN INSULATED, UNLESS OTHERWISE NOTED.
- 4. GROUND RODS FOR GROUND RING SHALL BE SPACED AT BETWEEN 2 x LENGTH OF ROD (MIN.) AND 2.5 x LENGTH OF ROD (MAX.) TO MAXIMIZE EFFICIENCY.
- 5. ANY METAL OBJECT WITHIN 6 FEET OF THE TOWER OR EQUIPMENT GROUND RING SHALL BE BONDED DIRECTLY TO THE RING.
- 6. THE MINIMUM BENDING RADIUS FOR ALL GROUNDING CONDUCTORS #6 AWG OR LARGER SHALL BE 24".
- 7. ALL ABOVE GRADE GROUND CONDUCTORS SHALL BE ROUTED DOWNWARD TOWARD EARTH AND HORIZONTAL ONLY WHERE NECESSARY.
- 8. ALL CONDUCTORS SHALL BE ROUTED SUCH THAT THERE ARE NO INCLUDED ANGLES OF LESS THAN 90 DEGREES.
- 9. PRIOR TO CONNECTING TO UTILITY, THE CONTRACTOR SHALL PERFORM IEEE FALL-OF-POTENTIAL RESISTANCE TO EARTH TESTING (PER IEEE 1100 AND 81) FOR GROUND ELECTRODE SYSTEMS. THE SUBCONTRACTOR SHALL FURNISH AND INSTALL SUPPLEMENTAL GROUND ELECTRODES AS NEEDED TO ACHIEVE A RECOMMENDED TEST RESULT OF 5 OHMS OR LESS INDEPENDENT OF UTILITY GROUND.
- 10. ALL GROUNDING SHALL COMPLY WITH THE N.E.C. AND UL96A LIGHTNING PROTECTION STANDARD.
- 11. ALL GROUNDING COMPONENTS SHALL BE FURNISHED AND INSTALLED BY CONTRACTOR.
- 12. ANY METAL CONDUIT MOUNTED ON THE TOWER SHALL BE BONDED TO THE TOWER AT EACH END.
- 13. ALL EXPOSED GROUNDING SHALL BE IN NON-METALLIC FLEX CONDUIT AND SECURED AS NECESSARY.
- 14. WHEN BONDING TO EQUIPMENT, REMOVE PAINT TO BARE STEEL AND PROTECT WITH A COATING OF NO-OX.
- 15. APPROVED ANTIOXIDANT COATINGS SHALL BE USED ON ALL COMPRESSION AND BOLTED GROUND CONNECTIONS.
- 16. BOND ICE BRIDGE SECTIONS TOGETHER EXOTHERMICALLY OR WITH 2 HOLE LUGS. BOND ICE BRIDGE TO SUPPORT POSTS.
- 17. THESE NOTES ARE NOT ALL-ENCOMPASSING. REFER TO CARRIER/TOWER OWNER FOR COMPLETE GROUNDING GUIDELINES.







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PROJECT:
HIGH SPRINGS
WEST
477684

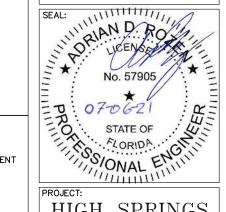LOCATED AT: 1034 SW CR 138 FT. WHITE, FL 32038

APPROVALS

	CARRIER
	LANDLORD
	LEASING
	CONSTRUCTION
	REVISIONS DATE
•	


ISSUED FOR: PERMIT/CONSTRUCTION
PROJECT MANAGER: MWM
DRAWING BY: MWM
DATE: 07/06/21
TITLE:

ELECTRICAL NOTES

SHEET NUMBER: E-1

JOB/FILE NUMBER: 1306.002

NOTE: PANEL SCHEDULE AND SINGLE LINE DIAGRAM REPRESENT A SITE WITH A NEW GE POWER PLANT, 30 KW DIESEL GENERATOR, AND TWO SOURCE ILC (THREE SOURCE ILC OPTIONAL AS NEEDED). ADJUST AS NECESSARY PER LOCAL UTILITY REQUIREMENTS AND SITE CONDITIONS.

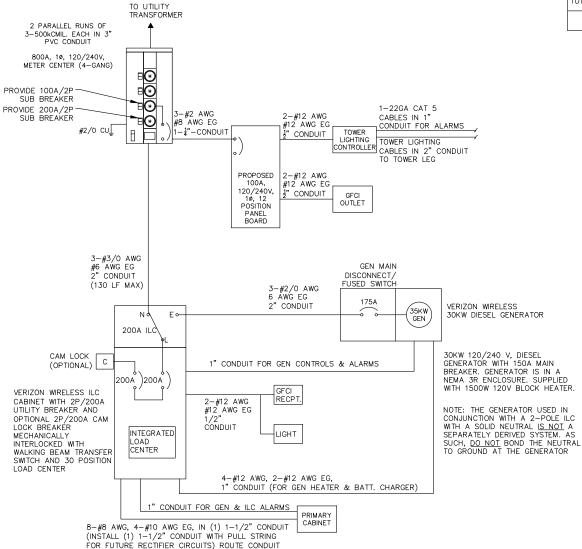

ELECTRICAL SINGLE LINE DIAGRAM

CONDUCTOR SIZES AND DISTANCES HAVE BEEN SIZED FOR 3% MAX VOLTAGE DROP (TOTAL SYSTEM VOLTAGE DROP ON BOTH

5. CONDUCTOR SIZES AND BISANCES HAVE BEEN SIZED FOR 3% MAX VOLTAGE DROP (INTEL STSTEM VOLTAGE DROP ON BOTH FEEDERS AND BRANCH CIRCUITS TO THE FARTHEST DEMAND SHALL NOT EXCEED 5%)

4. WIRE SIZING AND MAXIMUM DISTANCE FROM GENERATOR TO ILC ASSUMES POWER FACTOR OF 0.9.

5. BELOW GRADE CONDUIT SHALL BE SCHEDULE 40 PVC. ABOVE GRADE CONDUIT SHALL BE GALVANIZED RIGID CONDUIT. BELOW GRADE PVC CONDUIT SHALL BE SUITABLE FOR USE WITH THREADED RIGID CONDUIT. VERIFY CONDUIT TYPE WITH LOCAL CONSTRUCTION MANAGER AND ADJUST IF NECESSARY. ALL CONDUIT SHALL MEET NEC, STATE, AND LOCAL CODE REQUIREMENTS AS REQUIRED.

NOTES:

1. ALL EQUIPMENT SHALL BE NEMA 3R RATED.
2. ALL EQUIPMENT SHALL BE LIGHTNING PROTECTED IN ACCORDANCE WITH TIA AND VERIZON WIRELESS STANDARDS.

ABOVE GROUND SECURED TO EQUIPMENT FRAME


LOAD CA	LCULATION		
LOAD	AMPS		
PROPOSED LOAD:	140.0		
TOTAL DEMAND:	140.0		
VOLTAGE: 120 PHASE 3	/240V SINGLE 3W 200A		

PANE NAMI	Ξ:	VZW	ILC		MODEL NUMBEI	R:	ASCO D300L SERIES								
RATE	D AGE:	240	120	VOLTS	PHASE,	/WIRE:	1 3								
MAIN	AKER:	200	AMPS		BUS RATING		2	00			KEY DOOR LATCH:	YES			
мои		SURF	ACE		NEUTRA BAR:	AL.	YI	ES			HINGED DOOR:	YES			
ENCL TYPE	.OSURE ::	NEMA	. 3R		AIC:		6	5K							
POS	USAGE	BUS	AMPS	LOAD	POLES	AMPS	. 1	L2	AMPS	POLES	LOAD	BUS	AMPS	USAGE	POS
FU3	FACTOR	L1	L2	LOAD	FULES	AMPS		LZ	AMPS	FULES	LOAD	L1	L2	FACTOR	F 03
1	1	18		RECTIFIER	2	30A			30A	2	FUTURE	18		1	2
3	1		18	RECTIFIER	2	JUA			JUA	2	RECTIFIER		18	1	4
5	1	18		RECTIFIER	2	30A			30A	2	FUTURE	18		1	6
7	1		18	RECTIFIER		JUA			JUA	2	RECTIFIER		18	1	8
9	1	18		RECTIFIER	2	30A								1	10
11	1		18	RECTIFIER	2	JUA								1	12
13	1	18		RECTIFIER	2	30A									14
15	1		18			JUA									16
17	1	16		GFI RECEPT. /LIGHT	1	20A									18
19	1		16	BLOCK HEATER	1	20A									20
21	1	16		BATT. CHARGER	1	20A									22
23															24
25															26
27															28
29															30
		104	88	:SUB TOTAL AMPS							SUB TOTAL AMPS:	36	36		
											FACTORED TOTAL AMPS:	140	124		

DANE

- ALL CONDUCTORS ARE TYPE THWN (75°C) COPPER.
- MAXIMUM LENGTH OF RUN FOR RECTIFIER CIRCUITS IS 50'.
 ASCO INTEGRATED LOAD CENTER INCLUDES 200 AMP MAIN DISCONNECT AND TRANSFER SWITCH FOR PERMANENT
- AND/OR TEMPORARY GENERATOR.
 RECTIFIER LOADS ARE CONSIDERED TO BE NON-CONTINUOUS.
 IF ADDITIONAL FUTURE LOADS ARE ADDED WHICH CAUSE TOTAL DEMAND TO EXCEED GENERATOR BREAKER SIZE, BACKUP POWER SYSTEM SHALL BE EVALUATED AND UPGRADED AS NECESSARY.

PANEL SCHEDULE

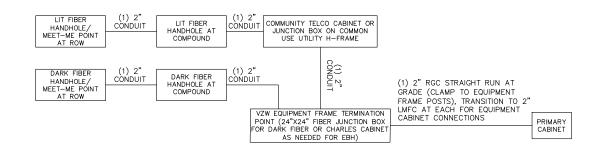

FIBER SINGLE LINE DIAGRAM








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PROJECT: HIGH SPRINGS WEST 477684

LOCATED AT: 1034 SW CR 138 FT. WHITE, FL 32038

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LANDLORD	
LEASING	
CONSTRUCTION	
REVISIONS	DATE

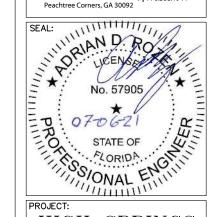
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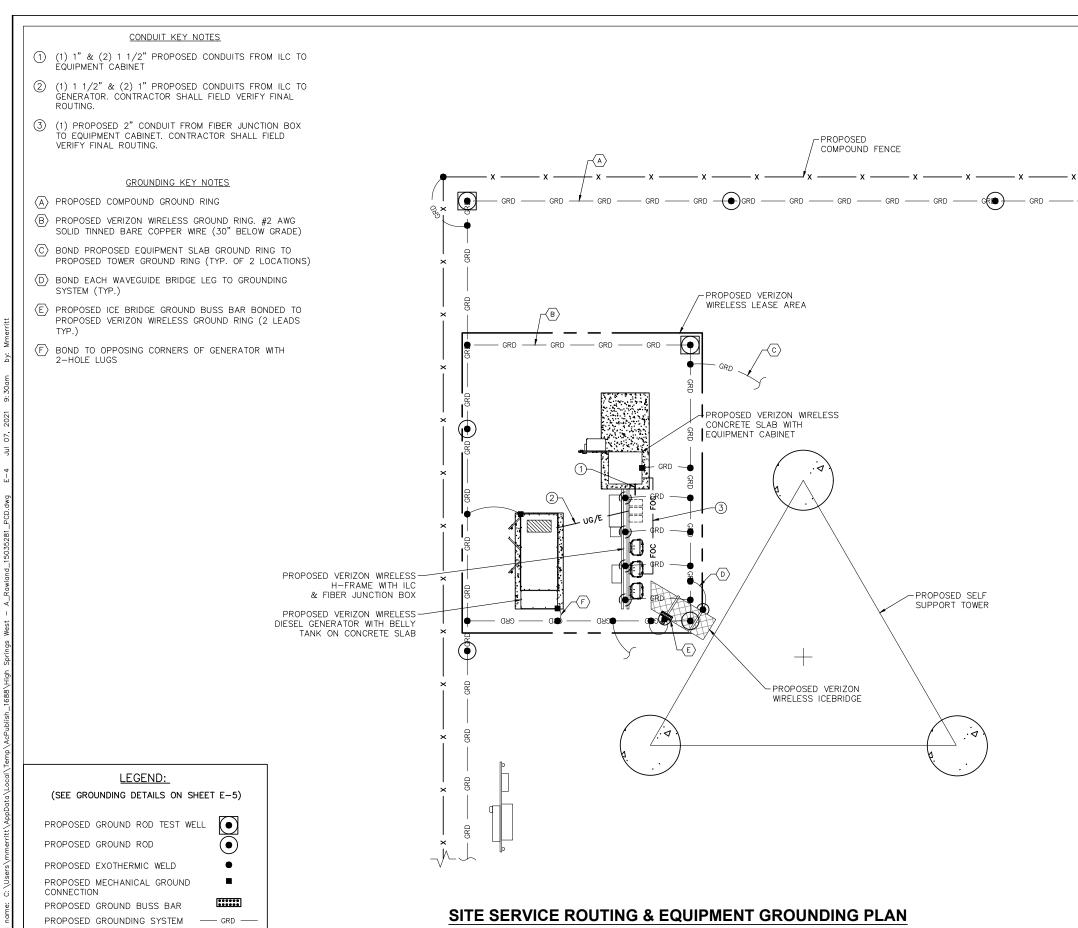
PANEL SCHEDULE & SINGLE LINE DIAGRAMS

SHEET NUMBER:

JOB/FILE NUMBER: 1306.002

E-2



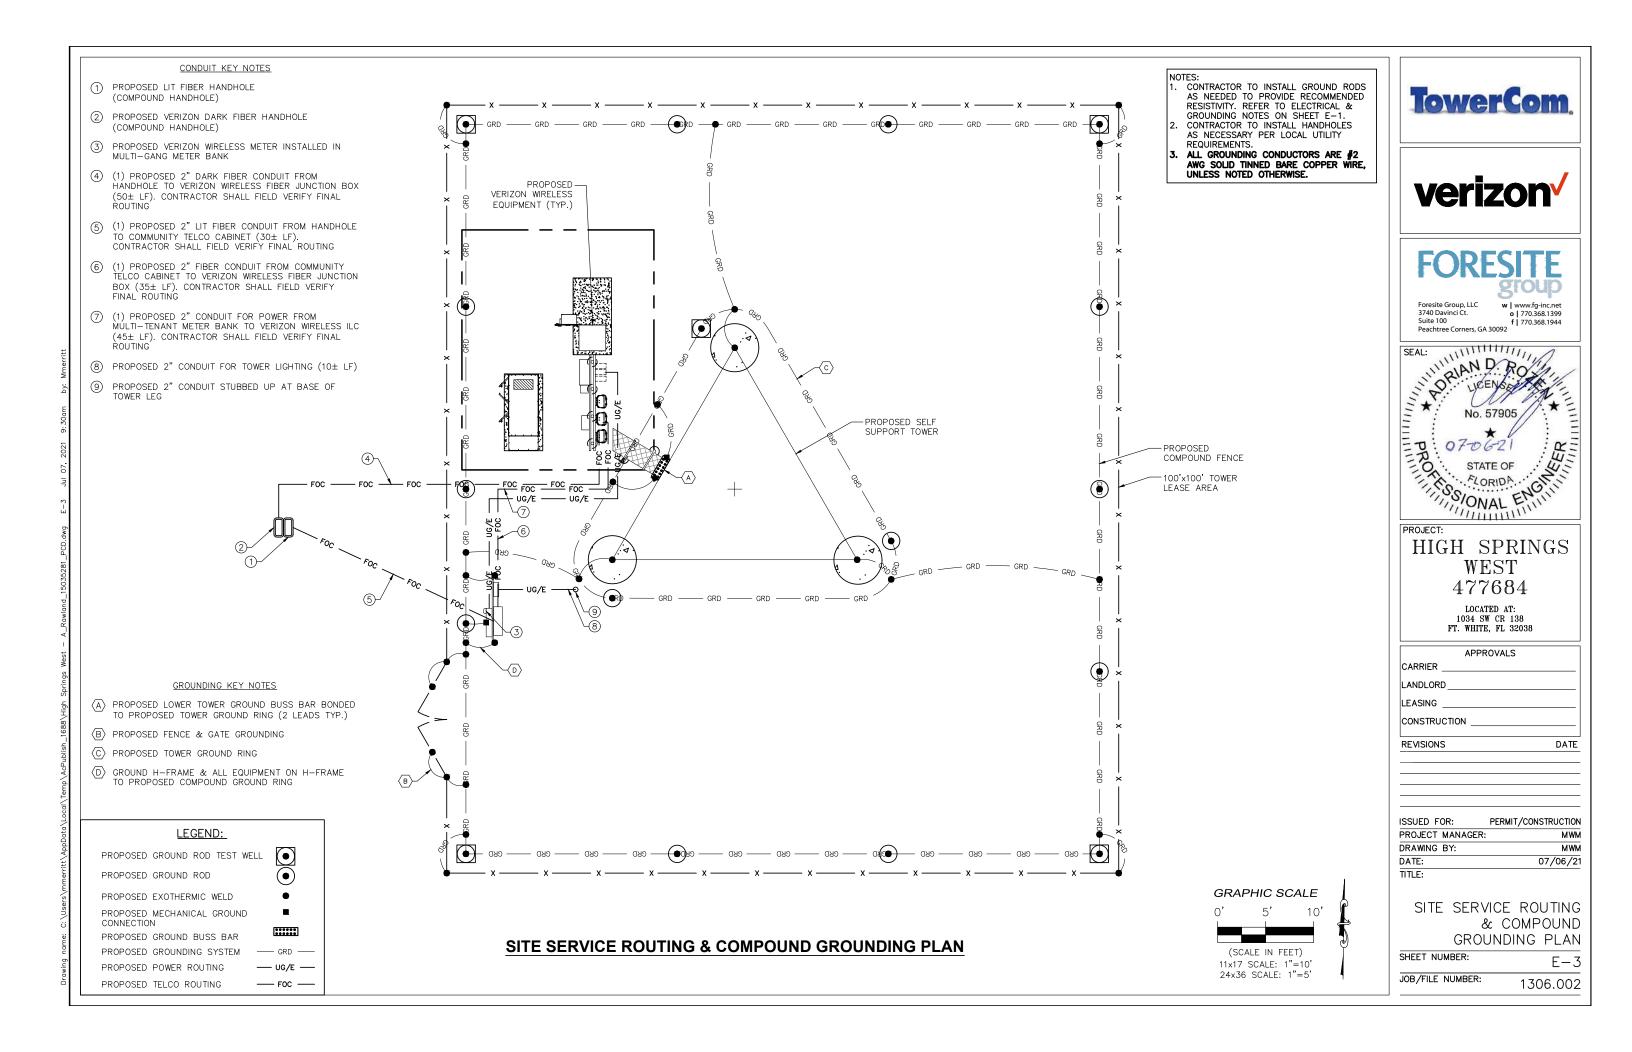

NOTES:

CONTRACTOR TO INSTALL GROUND RODS AS NEEDED TO PROVIDE RECOMMENDED RESISTIVITY. REFER TO ELECTRICAL & GROUNDING NOTES ON SHEET E-1.

ALL GROUNDING CONDUCTORS ARE #2
AWG SOLID TINNED BARE COPPER WIRE, UNLESS NOTED OTHERWISE.

GRAPHIC SCALE

(SCALE IN FEET)

11x17 SCALE: 1"=8'


24x36 SCALE: 1"=4"





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ISSUED FOR: PERMIT/CONSTRUCTION PROJECT MANAGER: MWM DRAWING BY: MWM DATE: 07/06/21 TITLE:

> SITE SERVICE ROUTING & EQUIPMENT GROUNDING PLAN

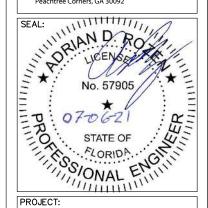
SHEET NUMBER: E-4JOB/FILE NUMBER: 1306.002


PROPOSED POWER ROUTING

PROPOSED TELCO ROUTING

— UG/E — — FOC —

6" WIDE YELLOW WARNING -METALLIC TAPE WITH THE BLACK LETTERS, TAPE TO READ: CAUTION ELECTRIC LINE BURIED BELOW. - FINISHED GRADE COMPACTED FIBER BACKFILL - BACKFILL AND TAMP WITH EXCAVATED POWER -MATERIAL 6" SEPARATION (CONFIRM WITH LOCAL UTILITY PROVIDER)

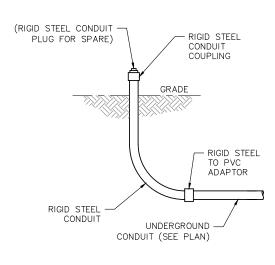

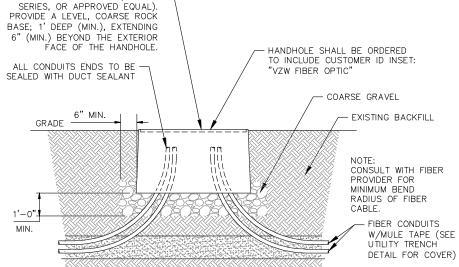

NEW 24"x36"x24" DEEP, OPEN -


BOTTOM FIBER HANDHOLE (TIER 22





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HIGH SPRINGS WEST

LOCATED AT:

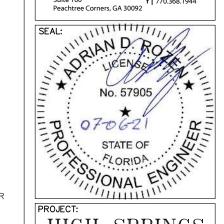APPROVALS CARRIER

PROJECT MANAGER: MWM DRAWING BY: MWM DATE: 07/06/21 TITLE:

GROUNDING &

SHEET NUMBER:

UNDERGROUND CONDUIT STUB-UP

NOT TO SCALE

FIBER HANDHOLE DETAIL NOT TO SCALE

UTILITY TRENCH DETAIL NOT TO SCALE


477684


1034 SW CR 138 FT. WHITE, FL 32038

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LEASING	
CONSTRUCTION _	
REVISIONS	DATE
ISSUED FOR:	PERMIT/CONSTRUCTION


CONDUIT DETAILS

E-5JOB/FILE NUMBER: 1306.002

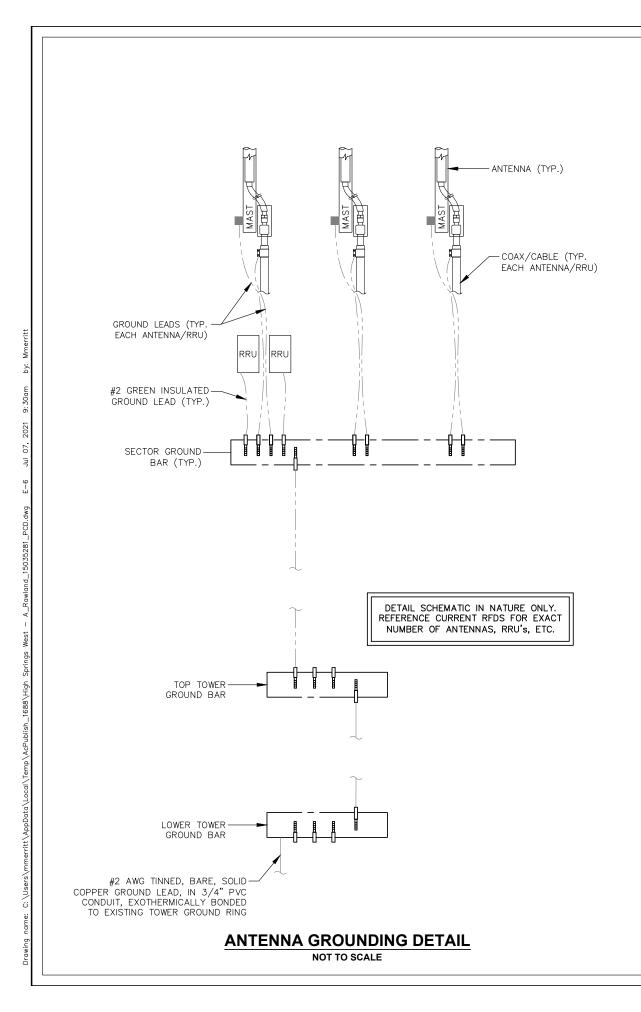

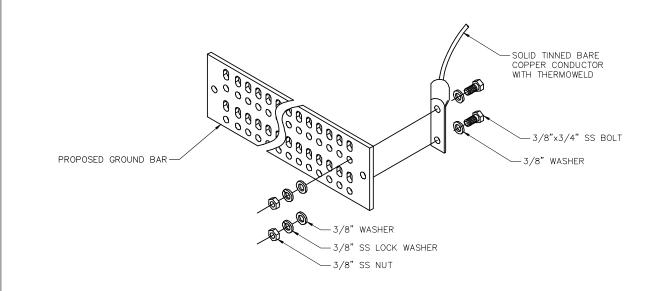

TYP. GROUND BAR CONNECTION DETAIL NOT TO SCALE

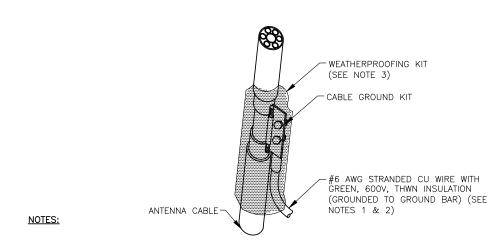

- 1. DO NOT INSTALL CABLE GROUND KIT AT A BEND AND ALWAYS DIRECT GROUND WIRE DOWN TO GROUND BAR.
- 2. GROUNDING KIT SHALL BE TYPE AND PART NUMBER AS SUPPLIED OR RECOMMENDED BY CABLE MANUFACTURER.
- 3. WEATHERPROOFING SHALL BE TYPE AND PART NUMBER AS SUPPLIED OR RECOMMENDED BY CABLE MANUFACTURER.

CONNECTION OF GROUND KIT TO ANTENNA CABLE


NOT TO SCALE





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PROJECT: HIGH SPRINGS WEST 477684

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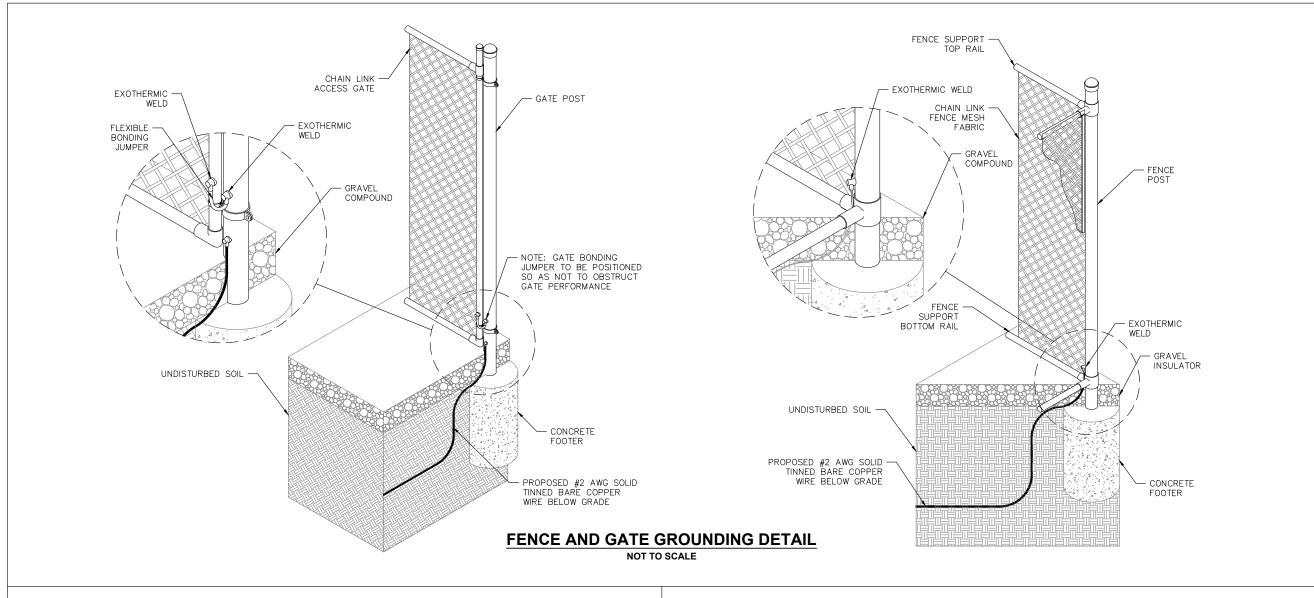
APPROVALS		
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REVISIONS DATE		

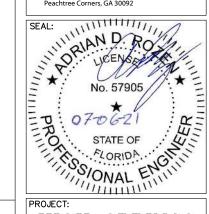
ISSUED FOR:	PERMIT/CONSTRUCTION		
PROJECT MANAGER:	MWM		
DRAWING BY:	MWM		
DATE:	07/06/21		
TITLE:			

SHEET NUMBER: E-6JOB/FILE NUMBER:

GROUNDING DETAILS

1306.002




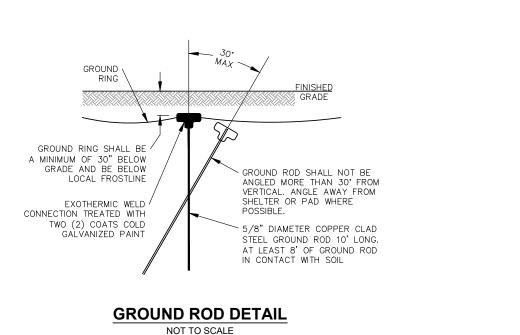





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HIGH SPRINGS

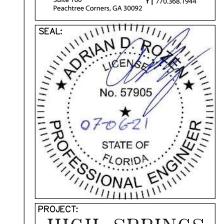WEST 477684


> LOCATED AT: 1034 SW CR 138 FT. WHITE, FL 32038

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DRAWING BY:	MWM	
DATE:	07/06/21	
TITLE:		

GROUNDING DETAILS SHEET NUMBER: E-7


JOB/FILE NUMBER: 1306.002

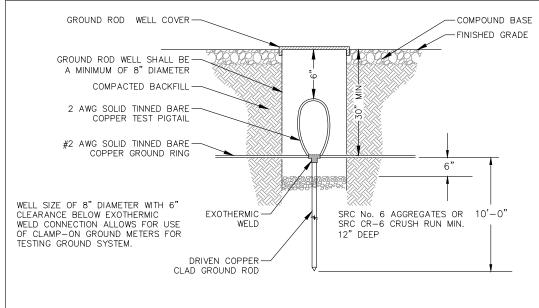


GROUND ROD TEST WELL DETAIL NOT TO SCALE

NOTES:

- CONTRACTOR TO FIELD LOCATE THE METER PEDESTAL AS SHOWN ON SITE PLAN. INSTALL THE METER PEDESTAL NEAR THE PERIMETER OF THE FENCED COMPOUND WITH THE METERS FACING AS SHOWN.
- 2. THE CONTRACTOR SHALL COORDINATE THE THE LOCAL UTILITY COMPANY FOR THE CONDUIT RUN TO THE MAIN SERVICE CONNECTION OR TRANSFORMER.
- THE CONTRACTOR SHALL COORDINATE THE THE LOCAL UTILITY COMPANY FOR GROUND ROD REQUIREMENTS. IF REQUIRED, THE CONTRACTOR SHALL ORDER AND PAY FOR NECESSARY GROUND TESTS.
- 4. SUPPORT POST AND UNISTRUT SHALL BE GALVANIZED. PIPE CLAMPS AND HARDWARE SHALL BE GALVANIZED OR STAINLESS STEEL.
- 5. TELCO CABINET SHALL BE A 48"x48"x12" HOFFMAN OR EQUIVALENT. PROVIDE 3/4" PLYWOOD BACKBOARD INSIDE THE MULTI-TENANT TELCO CABINET.
- ADJUSTMENTS TO THE METER PEDESTAL DESIGN MAY BE REQUIRED DEPENDING ON THE EXACT METER PANEL INSTALLED. CONTRACTOR SHALL FIELD COORDINATE ADJUSTMENTS AND INFORM THE ENGINEER IF ANY UNUSUAL CONDITIONS ARE FOUND TO EXIST.

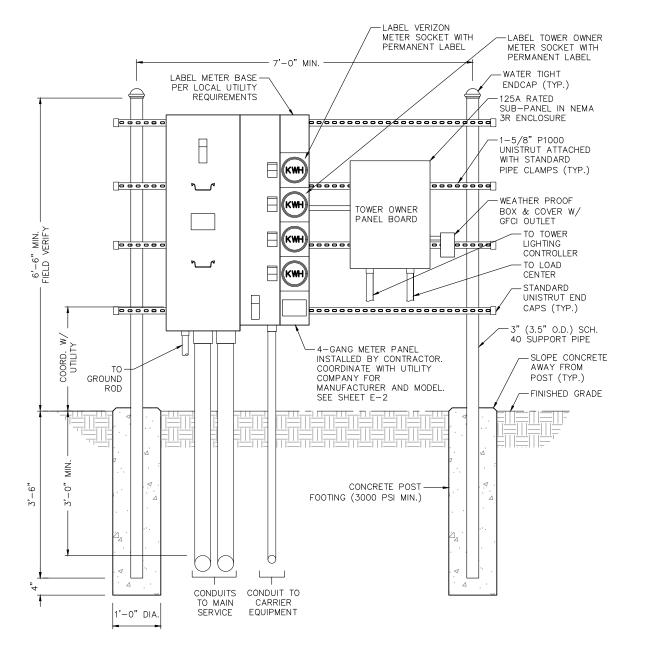

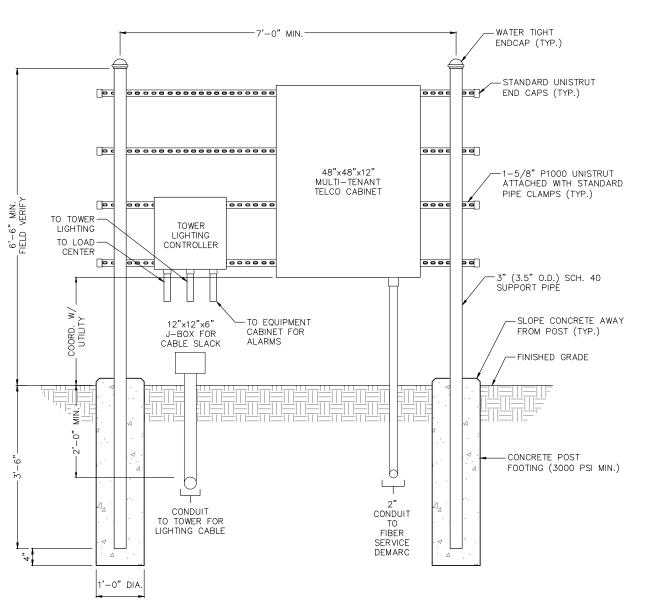

UTILITY H-FRAME DETAIL (GANG METER) NOT TO SCALE

UTILITY H-FRAME DETAIL (TELCO)

NOT TO SCALE






FORESITE

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HIGH SPRINGS WEST 477684

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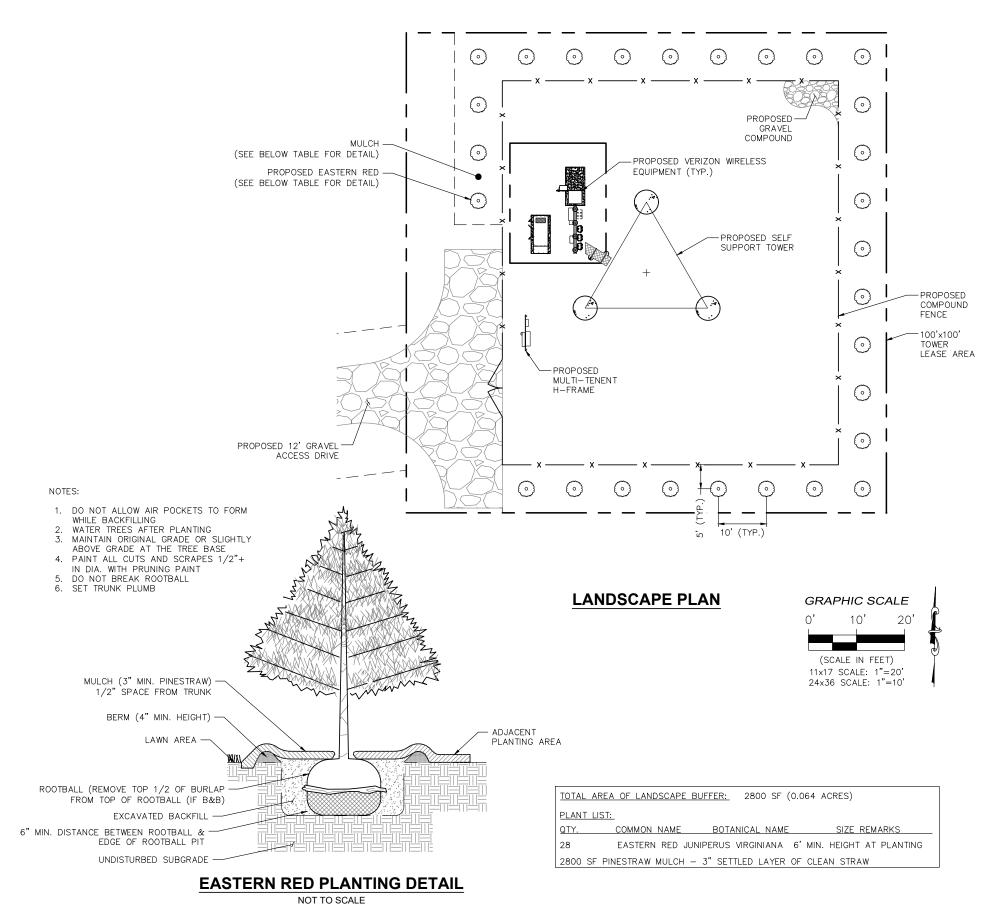
H-FRAME DETAILS

SHEET NUMBER: E-8

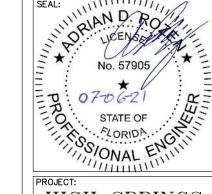JOB/FILE NUMBER: 1306.002

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- 3. PLANTS SHALL BE SPECIMEN QUALITY. PLANTS SHALL BE SOUND, HEALTHY AND VIGOROUS, WELL BRANCHED. AND DENSELY FOLIATED WHEN IN LEAF.
- 4. HEIGHT AND SPREAD DIMENSIONS SPECIFIED REFER TO THE MAIN BODY OF THE PLANT AND NOT FROM BRANCH TIP TO TIP. IF A RANGE OF SIZE IS GIVEN, NO PLANT SHALL BE AS LARGE AS THE MAXIMUM SIZE SPECIFIED.
- 5. SHADE TREES SHALL BE STRAIGHT UNLESS OTHERWISE SPECIFIED
- 6. PLANTS SHALL BE SUBJECT TO REVIEW BY OWNER'S REPRESENTATIVE. OWNER'S REPRESENTATIVE SHALL BE THE SOLE JUDGE OF THE QUALITY AND ACCEPTABILITY OF MATERIALS AND PLACEMENT.
- 7. PLANTING PLANS INDICATE DIAGRAMMATIC LOCATIONS ONLY. SITE ADJUSTMENTS OF PLANTING DESIGN AND RELOCATION OF PLANT MATERIAL INSTALLED PRIOR TO OWNER REPRESENTATIVE'S APPROVAL SHALL BE DONE WITHOUT PENALTY OR ADDITIONAL COST TO OWNER. STAKE PLANT LOCATIONS AT SITE AND OBTAIN OWNER REPRESENTATIVE'S APPROVAL PRIOR TO PLANT INSTALL ATION.
- 8. PLACE PLANTS UPRIGHT AND TURNED SO THAT THE MOST ATTRACTIVE SIDE IS VIEWED.
- 9. UNDERGROUND UTILITIES SHALL BE LOCATED AND MARKED BEFORE DIGGING. THE CONTRACTOR SHALL BE FULLY RESPONSIBLE FOR ALL DAMAGE OF UTILITY LINES.
- 10. IF DRAINAGE IS NOT SUFFICIENT NOTIFY OWNER'S REPRESENTATIVE IN WRITING BEFORE INSTALLING PLANTS, OTHERWISE, CONTRACTOR SHALL BE TOTALLY RESPONSIBLE FOR THE GUARANTEE AND LIVABILITY OF THE PLANT.
- 11. PROVIDE TRENCH EDGING, 7" WIDE AT SHRUB BEDS IN LAWN AREAS UNLESS OTHERWISE NOTED.
- 12. PROVIDE 3" THICKNESS MULCH AT ALL PLANTS AND PLANTING BEDS. MULCH SHALL BE PINE STRAW UNLESS OTHERWISE NOTED.
- 13. MAINTENANCE WORK SHALL BE PERFORMED UNTIL DATE OF FINAL ACCEPTANCE BY OWNER'S REPRESENTATIVE.
- 14. FRONDS OR LEAVES: MUST BE OF MEDIUM FOLIAGE, ALL GOOD LEAVES, MAXIMUM OF 10% CHLOROSIS ALLOWED. WITH NO EXTREME SUCCULENCE.
- 15. ROOT SYSTEM: ROOTS MUST BE STURDILY ESTABLISHED IN BALL THAT HAS BEEN TIGHTLY WRAPPED AND SECURELY TIED WITH TWINE OR WIRE, OR PINNED.
- 16. CONTRACTOR'S PRICES SHALL INCLUDE ALL LABOR AND MATERIAL NECESSARY TO COMPLETE THE WORK, I.E. MULCH, PLANTING, SOIL MIX, WOOD AND WIRE STAKING MATERIAL, ETC.
- 17. WHERE WIRE BASKETS ARE USED ON TREES OR SHRUBS, CUT WIRE BACK TO BASE OF ROOT BALL AND REMOVE FROM PLANTING.
- 18. QUANTITIES NECESSARY TO COMPLETE THE WORK ON THE DRAWING SHALL BE FURNISHED. QUANTITY ESTIMATES HAVE BEEN MADE CAREFULLY, BUT THE OWNER'S REPRESENTATIVE ASSUMES NO LIABILITY FOR OMISSION OR ERRORS. HIS ESTIMATES ARE ONLY AN AID FOR CLARIFICATION OF UNITS AND A CHECK FOR THE CONTRACTOR TO COMPARE WITH HIS OWN ESTIMATES. DIFFERENCES SHALL BE BROUGHT TO THE ATTENTION OF OWNER'S REPRESENTATIVE. NO EXTRA COMPENSATION SHALL BE ALLOWED FOR EXTRA QUANTITIES NECESSARY TO COMPLETE THE WORK.
- 19. CONTRACTOR TO DESIGN-BUILD IRRIGATION SYSTEM.








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 PERMIT/CONSTRUCTION

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 MWM

 DATE:
 07/06/21

 TITLE:
 07/06/21

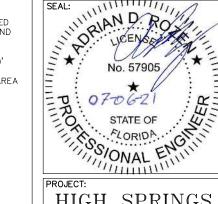LANDSCAPING PLAN
SHEET NUMBER: L-1

JOB/FILE NUMBER: 1306.002