
SITEWORK FOR NEW LIQUID FERTILIZER FACILITY LAKE CITY, FL

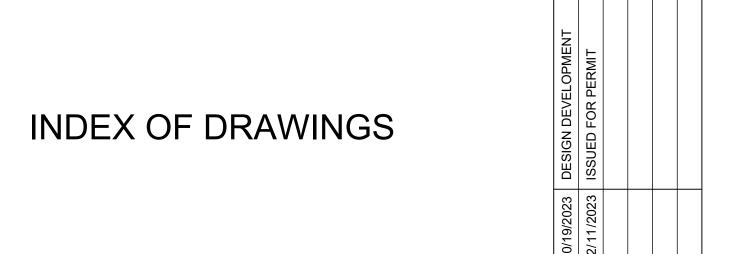

	,				
SHEET NO.	DESCRIPTION				
C001	TITLE SHEET AND DRAWING INDEX				
-	CERTIFIED BOUNDARY SURVEY				
C101	OVERALL EXISTING CONDITIONS AND REMOVALS PLAN				
C102	EXISTING CONDITIONS AND REMOVALS PLAN				
C103	EXISTING CONDITIONS AND REMOVALS PLAN				
C104	EXISTING CONDITIONS AND REMOVALS PLAN				
C105	EXISTING CONDITIONS AND REMOVALS PLAN				
C106	EXISTING CONDITIONS AND REMOVALS PLAN				
C107	EXISTING CONDITIONS AND REMOVALS PLAN				
C108	EXISTING CONDITIONS AND REMOVALS PLAN				
C201	OVERALL SITE PAVING AND UTILITY PLAN				
C202	SITE PAVING AND UTILITY PLAN				
C203	SITE PAVING AND UTILITY PLAN				
C204	SITE PAVING AND UTILITY PLAN				
C205	SITE PAVING AND UTILITY PLAN				
C206	SITE PAVING AND UTILITY PLAN				
C207	SITE PAVING AND UTILITY PLAN				
C208	SITE PAVING AND UTILITY PLAN				
C301	OVERALL GRADING AND DRAINAGE PLAN				
C302	GRADING AND DRAINAGE PLAN				
C303	GRADING AND DRAINAGE PLAN				
C304	GRADING AND DRAINAGE PLAN				
C305	GRADING AND DRAINAGE PLAN				
C306	GRADING AND DRAINAGE PLAN				
C307	GRADING AND DRAINAGE PLAN				
C308	GRADING AND DRAINAGE PLAN				
C401	OVERALL EROSION AND SEDIMENT CONTROL PLAN				
C402	EROSION AND SEDIMENT CONTROL PLAN				
C403	EROSION AND SEDIMENT CONTROL PLAN				
C404	EROSION AND SEDIMENT CONTROL PLAN				
C405	EROSION AND SEDIMENT CONTROL PLAN				
C406	EROSION AND SEDIMENT CONTROL PLAN				
C407	EROSION AND SEDIMENT CONTROL PLAN				
C408	EROSION AND SEDIMENT CONTROL PLAN				
C501	CIVIL DETAILS				
C502	CIVIL DETAILS				
C503	CIVIL DETAILS				
C601	STORMWATER POLLUTION PREVENTION PLAN (SWPPP)				
	•	-	 		_

OWNER:

TODD CRESSMSAN AGROLIQUID 3055 W M-21 SAINT JOHNS, MI 48879

CONTRACTOR / SITE MANAGER:

CIVIL:

GREYSTONE CONSTRUCTION 2995 WINNERS CIRCLE DRIVE, SUITE 200 SHAKOPEE, MN 55379


VAA, LLC

2300 BERKSHIRE LANE NORTH, SUITE 200 PLYMOUTH, MN 55441

CONTACT: ALEX RAKOS EMAIL: ARAKOS@VAAENG.COM PHONE: (763) 559-9100



LOCATION MAP

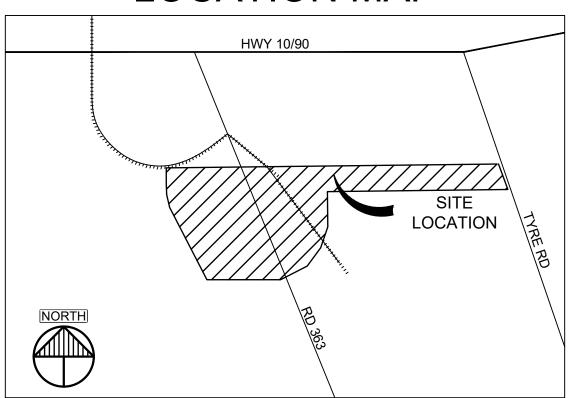





NEW LIQUID FERTILIZER FACILITY LAKE CITY, FL

NO	DATE	ISSUE/REVISION	BY
Α	10/19/2023	DESIGN DEVELOPMENT	RCQ
В	12/11/2023	ISSUED FOR PERMIT	RCQ

MARK D. MIELKE, PE Registration No. 68730 This item has been digitally signed	Mark Digitally signed by Mark Mielke Date: 09:46:48 -06'00'

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and sealed by Mark D. Mielke. Printed copies of this document are not considered signed and sealed and the signature must be verified on

any electronic copies.

	DATE:		DRAWN:	
	10/19/2023		RCQ	
	DESIGNED:	CHECKE	D:	APPROVED:
	AJR	ARL		MDM


DRAWING TITLE:

CERTIFICATION:

TITLE SHEET AND **DRAWING INDEX**

DRAWING NO:

PROJECT NO: 230384 SCALE: AS NOTED

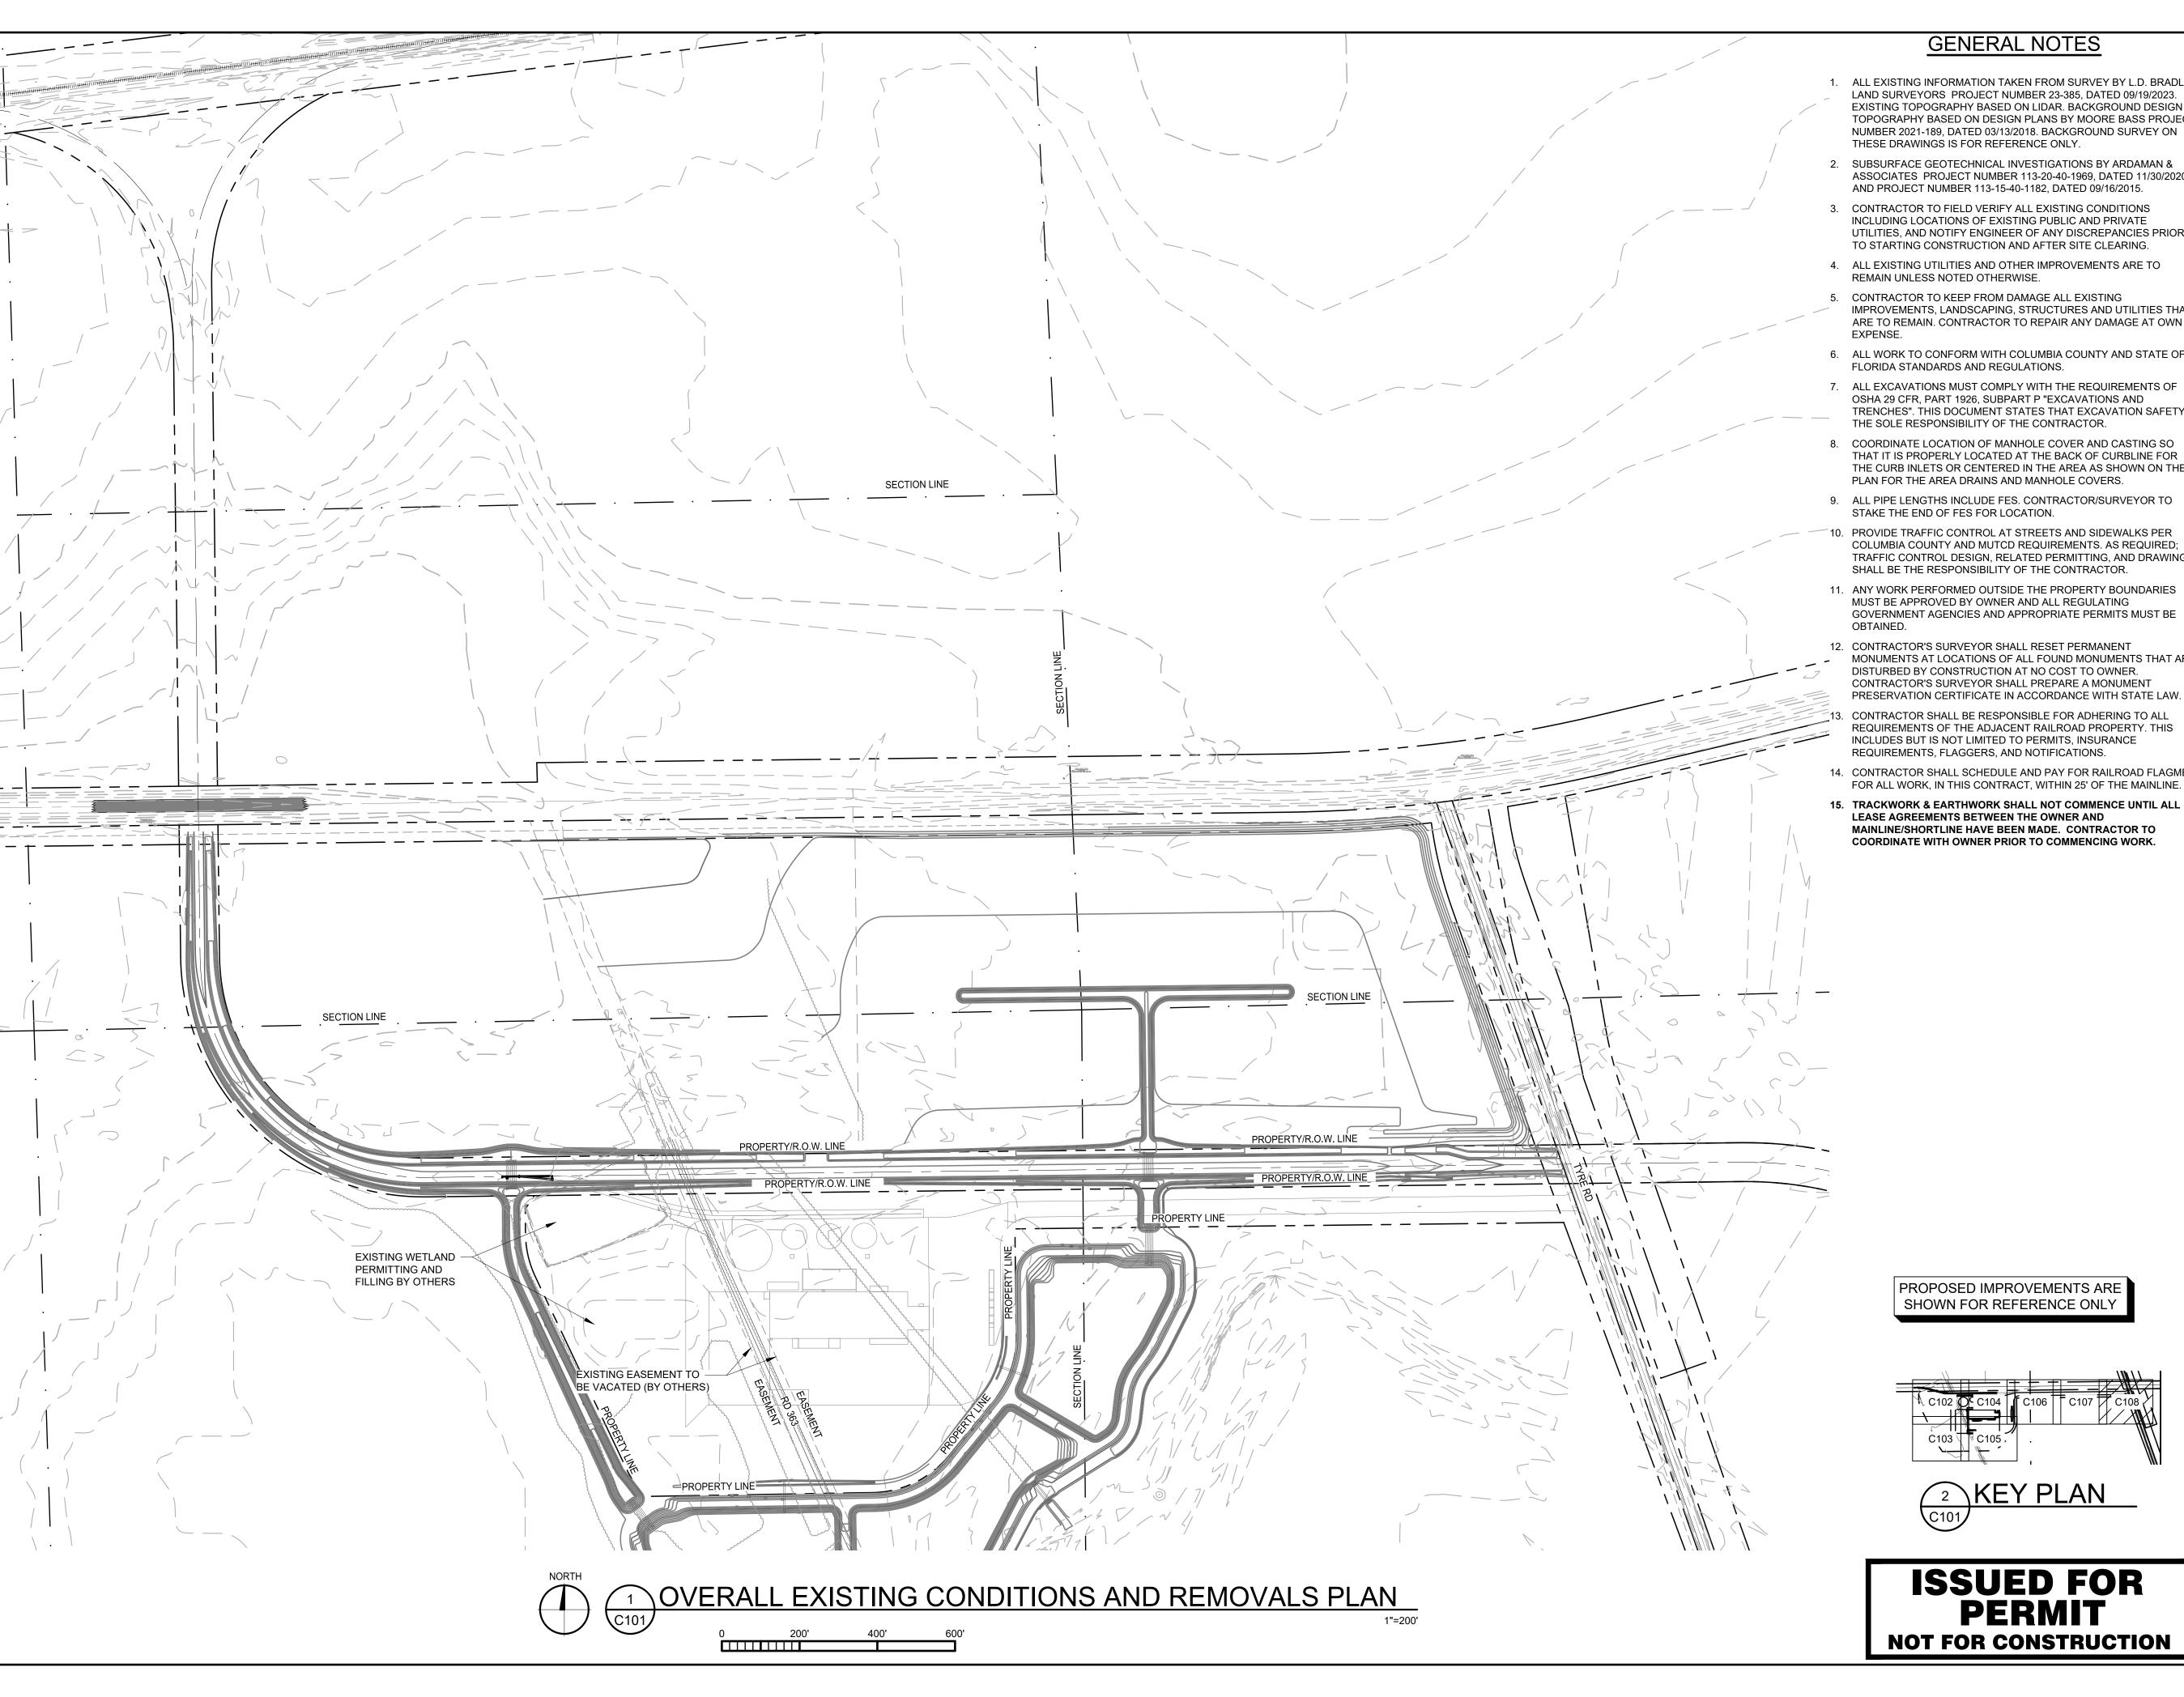

GENERAL NOTES

- 1. ALL EXISTING INFORMATION TAKEN FROM SURVEY BY L.D. BRADLEY LAND SURVEYORS PROJECT NUMBER 23-385, DATED 09/19/2023. EXISTING TOPOGRAPHY BASED ON LIDAR. BACKGROUND DESIGN TOPOGRAPHY BASED ON DESIGN PLANS BY MOORE BASS PROJECT NUMBER 2021-189, DATED 03/13/2018. BACKGROUND SURVEY ON THESE DRAWINGS IS FOR REFERENCE ONLY.
- 2. SUBSURFACE GEOTECHNICAL INVESTIGATIONS BY ARDAMAN & ASSOCIATES PROJECT NUMBER 113-20-40-1969, DATED 11/30/2020, AND PROJECT NUMBER 113-15-40-1182, DATED 09/16/2015.
- 3. CONTRACTOR TO FIELD VERIFY ALL EXISTING CONDITIONS INCLUDING LOCATIONS OF EXISTING PUBLIC AND PRIVATE UTILITIES, AND NOTIFY ENGINEER OF ANY DISCREPANCIES PRIOR TO STARTING CONSTRUCTION AND AFTER SITE CLEARING.
- 4. ALL EXISTING UTILITIES AND OTHER IMPROVEMENTS ARE TO REMAIN UNLESS NOTED OTHERWISE.
- 5. CONTRACTOR TO KEEP FROM DAMAGE ALL EXISTING IMPROVEMENTS, LANDSCAPING, STRUCTURES AND UTILITIES THAT ARE TO REMAIN. CONTRACTOR TO REPAIR ANY DAMAGE AT OWN
- 6. ALL WORK TO CONFORM WITH COLUMBIA COUNTY AND STATE OF FLORIDA STANDARDS AND REGULATIONS.
- 7. ALL EXCAVATIONS MUST COMPLY WITH THE REQUIREMENTS OF OSHA 29 CFR, PART 1926, SUBPART P "EXCAVATIONS AND TRENCHES". THIS DOCUMENT STATES THAT EXCAVATION SAFETY IS THE SOLE RESPONSIBILITY OF THE CONTRACTOR.
- THE CURB INLETS OR CENTERED IN THE AREA AS SHOWN ON THE PLAN FOR THE AREA DRAINS AND MANHOLE COVERS.
- 9. ALL PIPE LENGTHS INCLUDE FES. CONTRACTOR/SURVEYOR TO STAKE THE END OF FES FOR LOCATION.
- 10. PROVIDE TRAFFIC CONTROL AT STREETS AND SIDEWALKS PER COLUMBIA COUNTY AND MUTCD REQUIREMENTS. AS REQUIRED; TRAFFIC CONTROL DESIGN, RELATED PERMITTING, AND DRAWINGS SHALL BE THE RESPONSIBILITY OF THE CONTRACTOR.
- 11. ANY WORK PERFORMED OUTSIDE THE PROPERTY BOUNDARIES MUST BE APPROVED BY OWNER AND ALL REGULATING GOVERNMENT AGENCIES AND APPROPRIATE PERMITS MUST BE
- 12. CONTRACTOR'S SURVEYOR SHALL RESET PERMANENT MONUMENTS AT LOCATIONS OF ALL FOUND MONUMENTS THAT ARE DISTURBED BY CONSTRUCTION AT NO COST TO OWNER. CONTRACTOR'S SURVEYOR SHALL PREPARE A MONUMENT PRESERVATION CERTIFICATE IN ACCORDANCE WITH STATE LAW
- CONTRACTOR SHALL BE RESPONSIBLE FOR ADHERING TO ALL REQUIREMENTS OF THE ADJACENT RAILROAD PROPERTY. THIS INCLUDES BUT IS NOT LIMITED TO PERMITS, INSURANCE REQUIREMENTS, FLAGGERS, AND NOTIFICATIONS.
- 14. CONTRACTOR SHALL SCHEDULE AND PAY FOR RAILROAD FLAGMEN FOR ALL WORK, IN THIS CONTRACT, WITHIN 25' OF THE MAINLINE.
- 15. TRACKWORK & EARTHWORK SHALL NOT COMMENCE UNTIL ALL LEASE AGREEMENTS BETWEEN THE OWNER AND MAINLINE/SHORTLINE HAVE BEEN MADE. CONTRACTOR TO COORDINATE WITH OWNER PRIOR TO COMMENCING WORK.

² KEY PLAN

PERMIT

2300 Berkshire Lane N, Suite 200 Plymouth, MN 55441

www.vaaeng.com Project # 230384



PROJECT:

NEW LIQUID FERTILIZER FACILITY LAKE CITY, FL

NO	DATE	ISSUE/REVISION	BY
Α	10/19/2023	DESIGN DEVELOPMENT	RCQ
В	12/11/2023	ISSUED FOR PERMIT	RCQ

CERTIFICATION:

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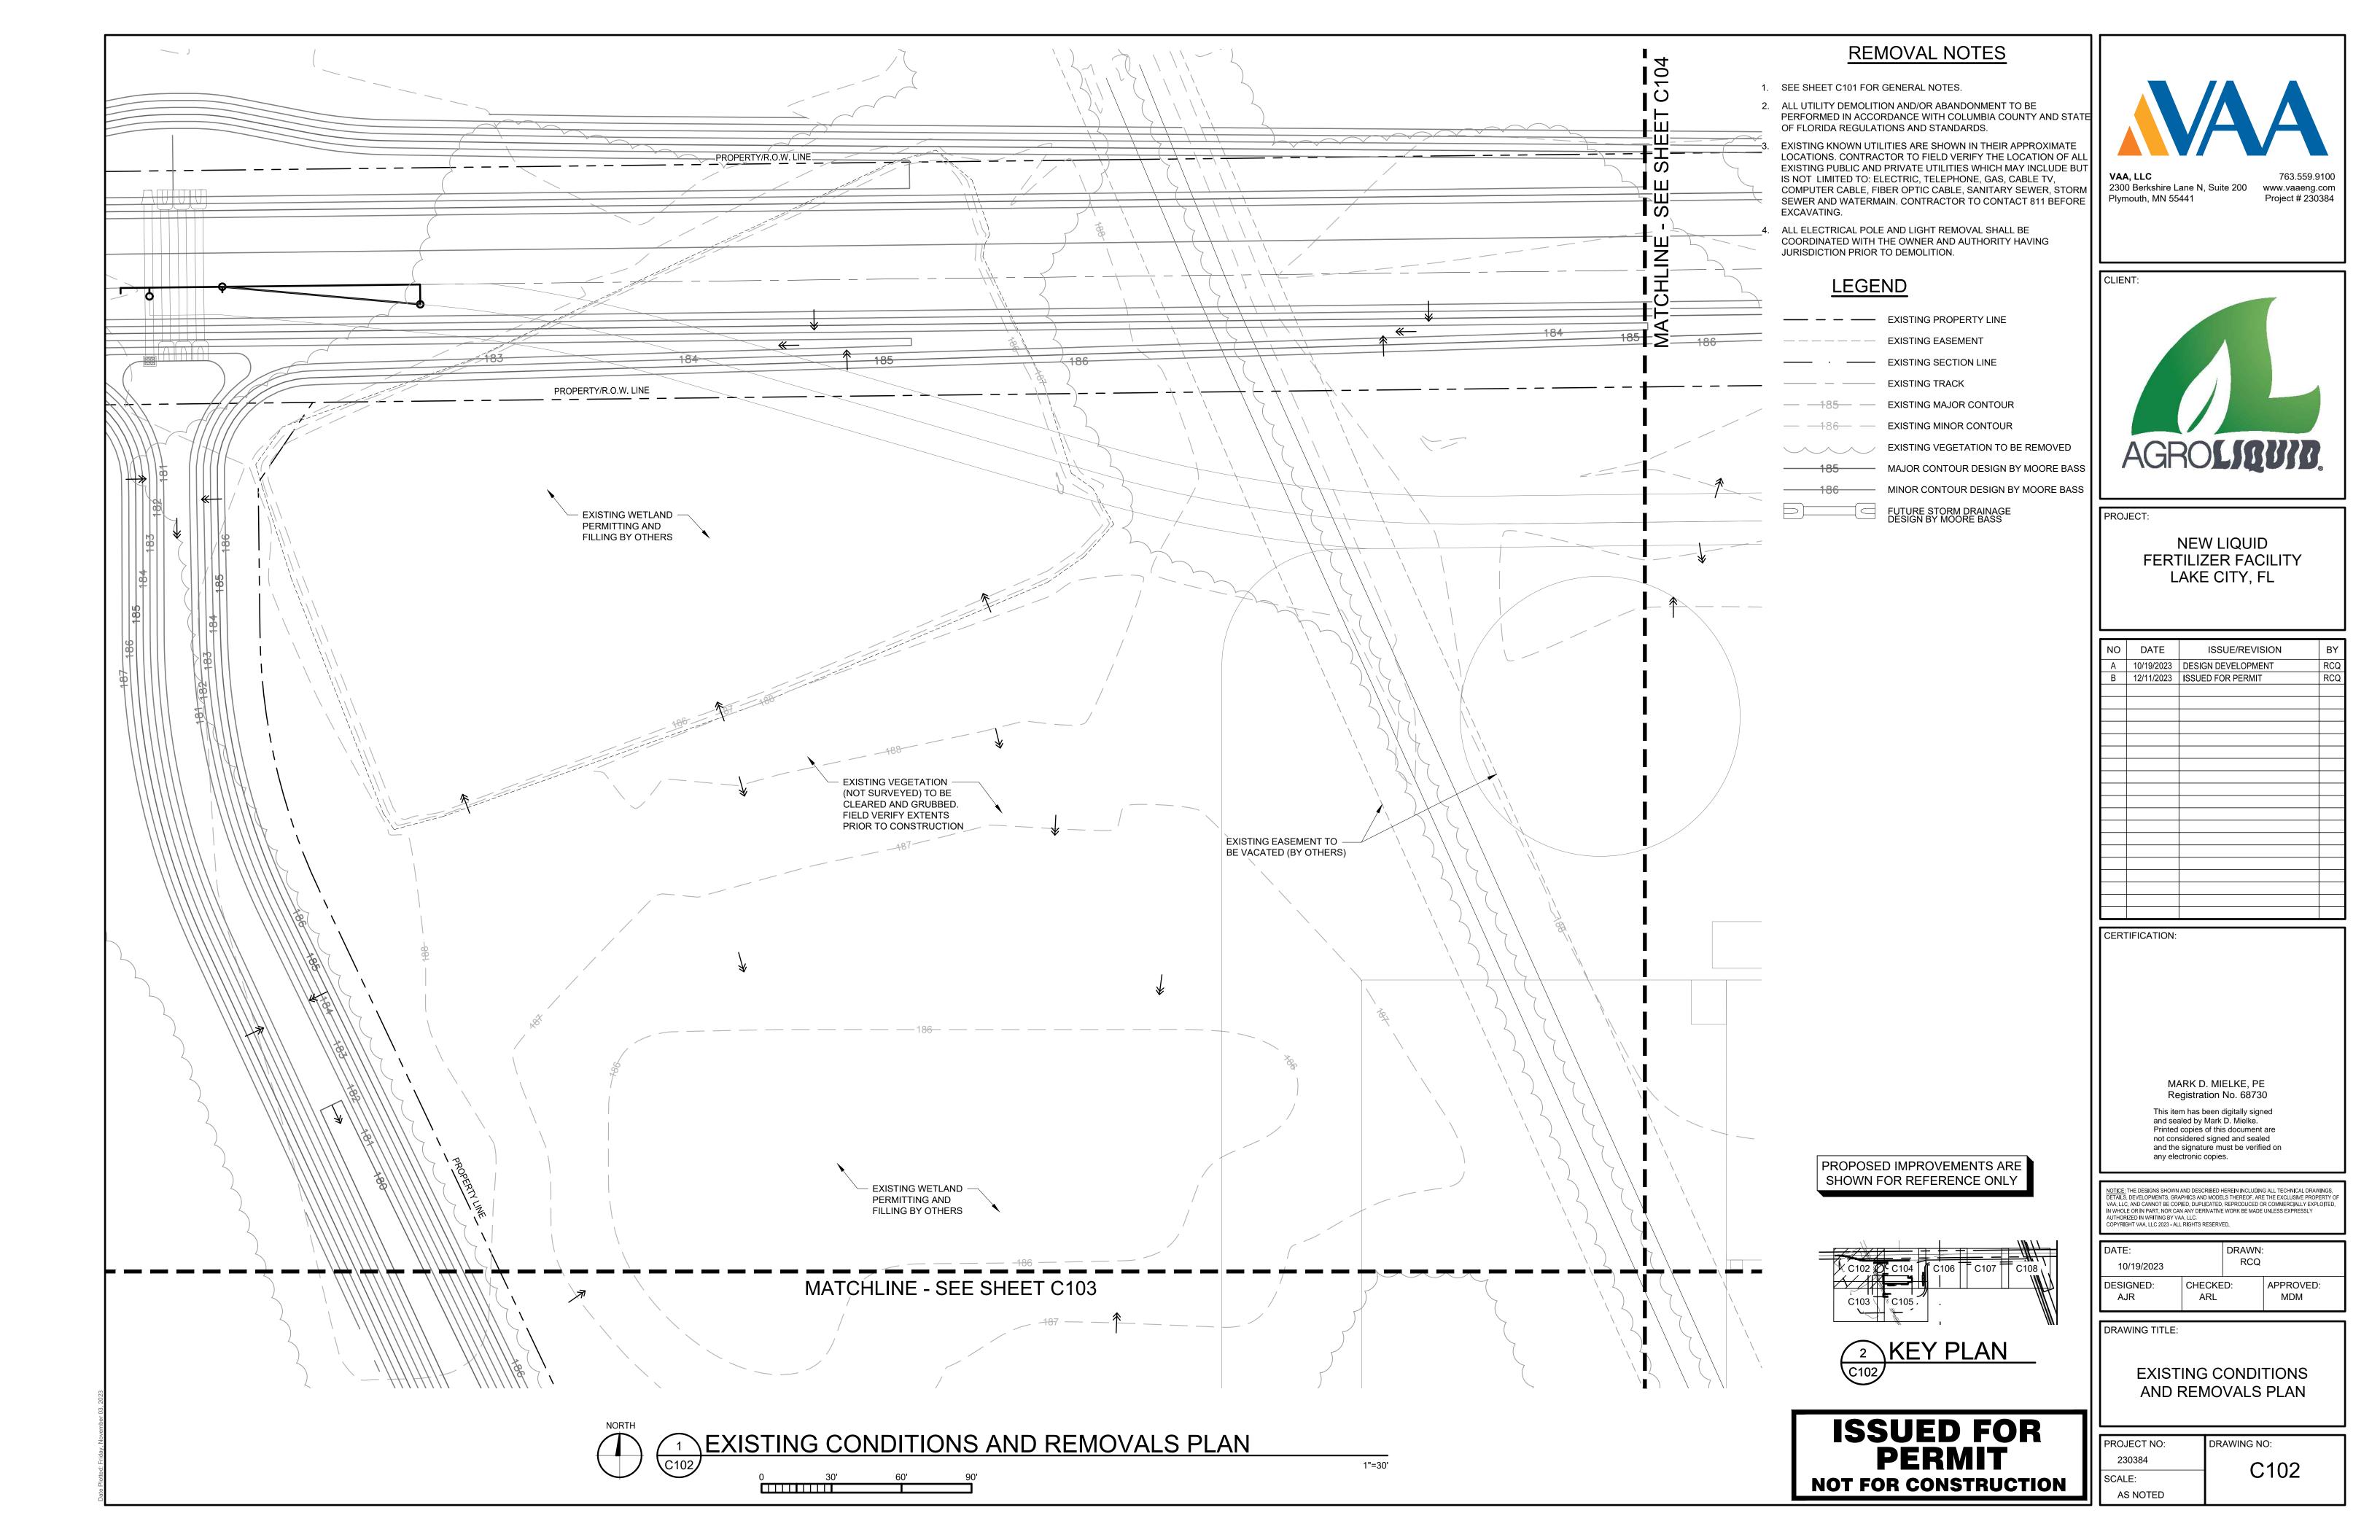
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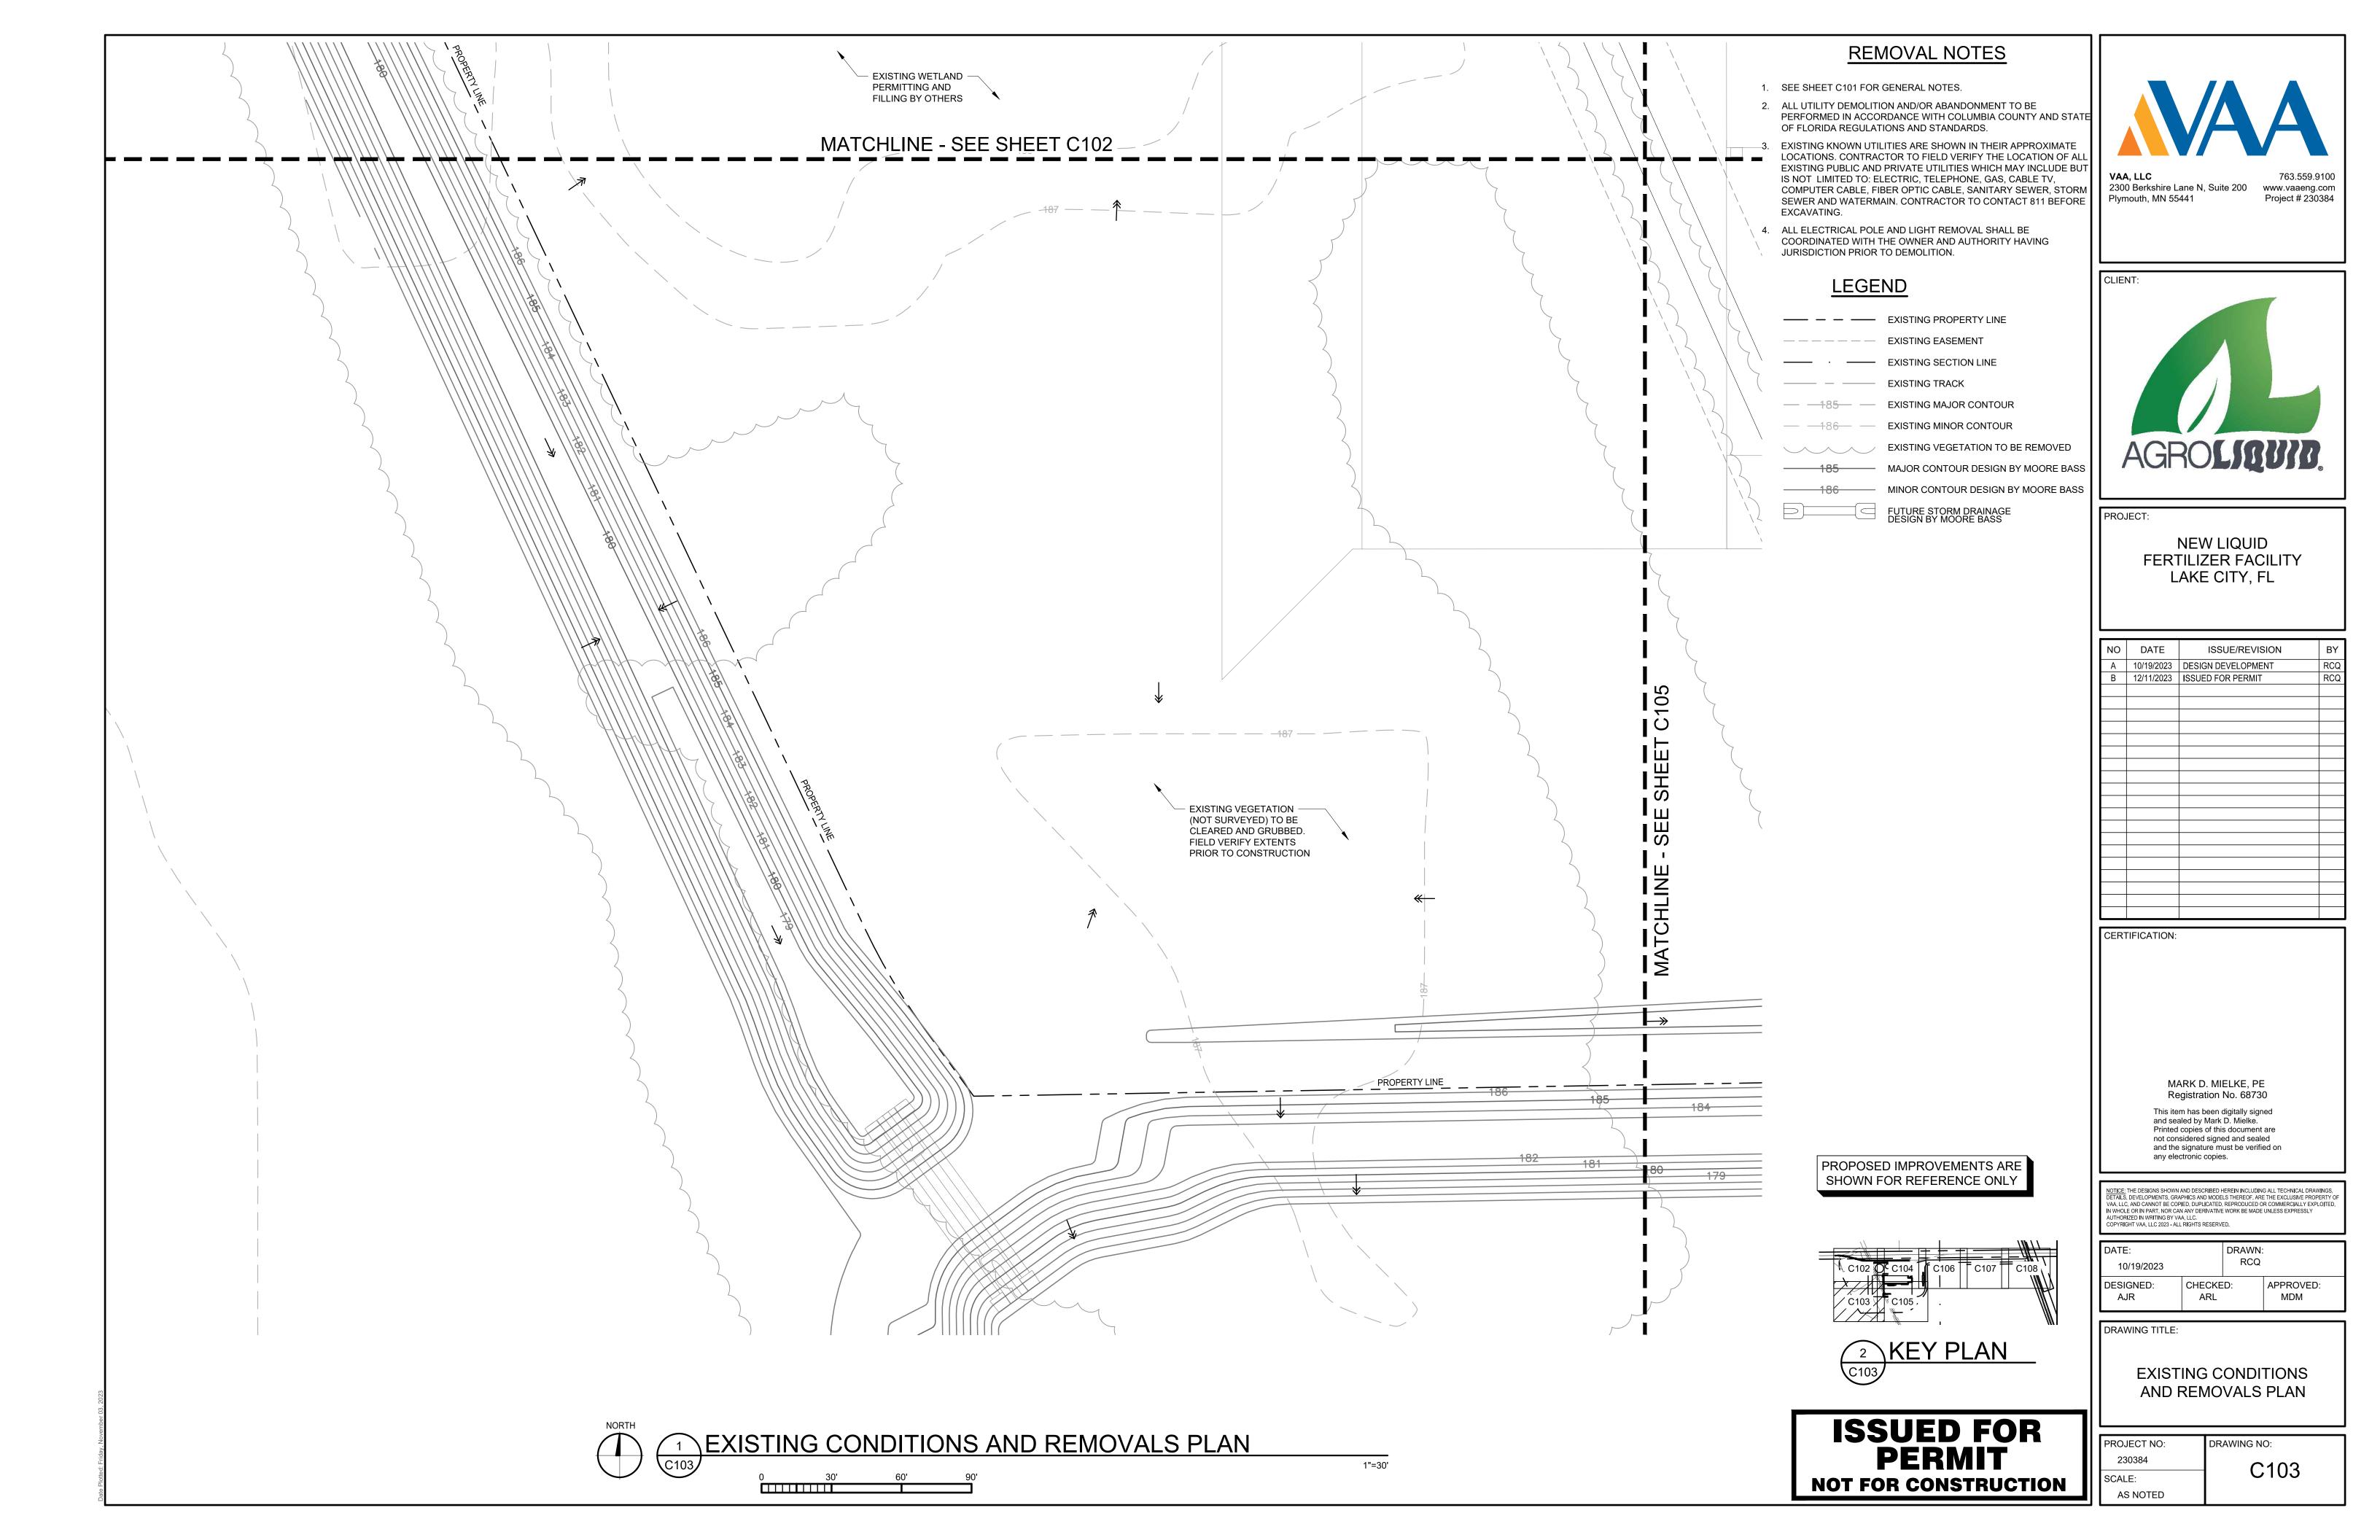
DRAWN: 10/19/2023 DESIGNED: CHECKED: APPROVED: AJR


DRAWING TITLE:

OVERALL EXISTING CONDITIONS AND REMOVALS PLAN

PROJECT NO: DRAWING NO: 230384 C101 SCALE: AS NOTED





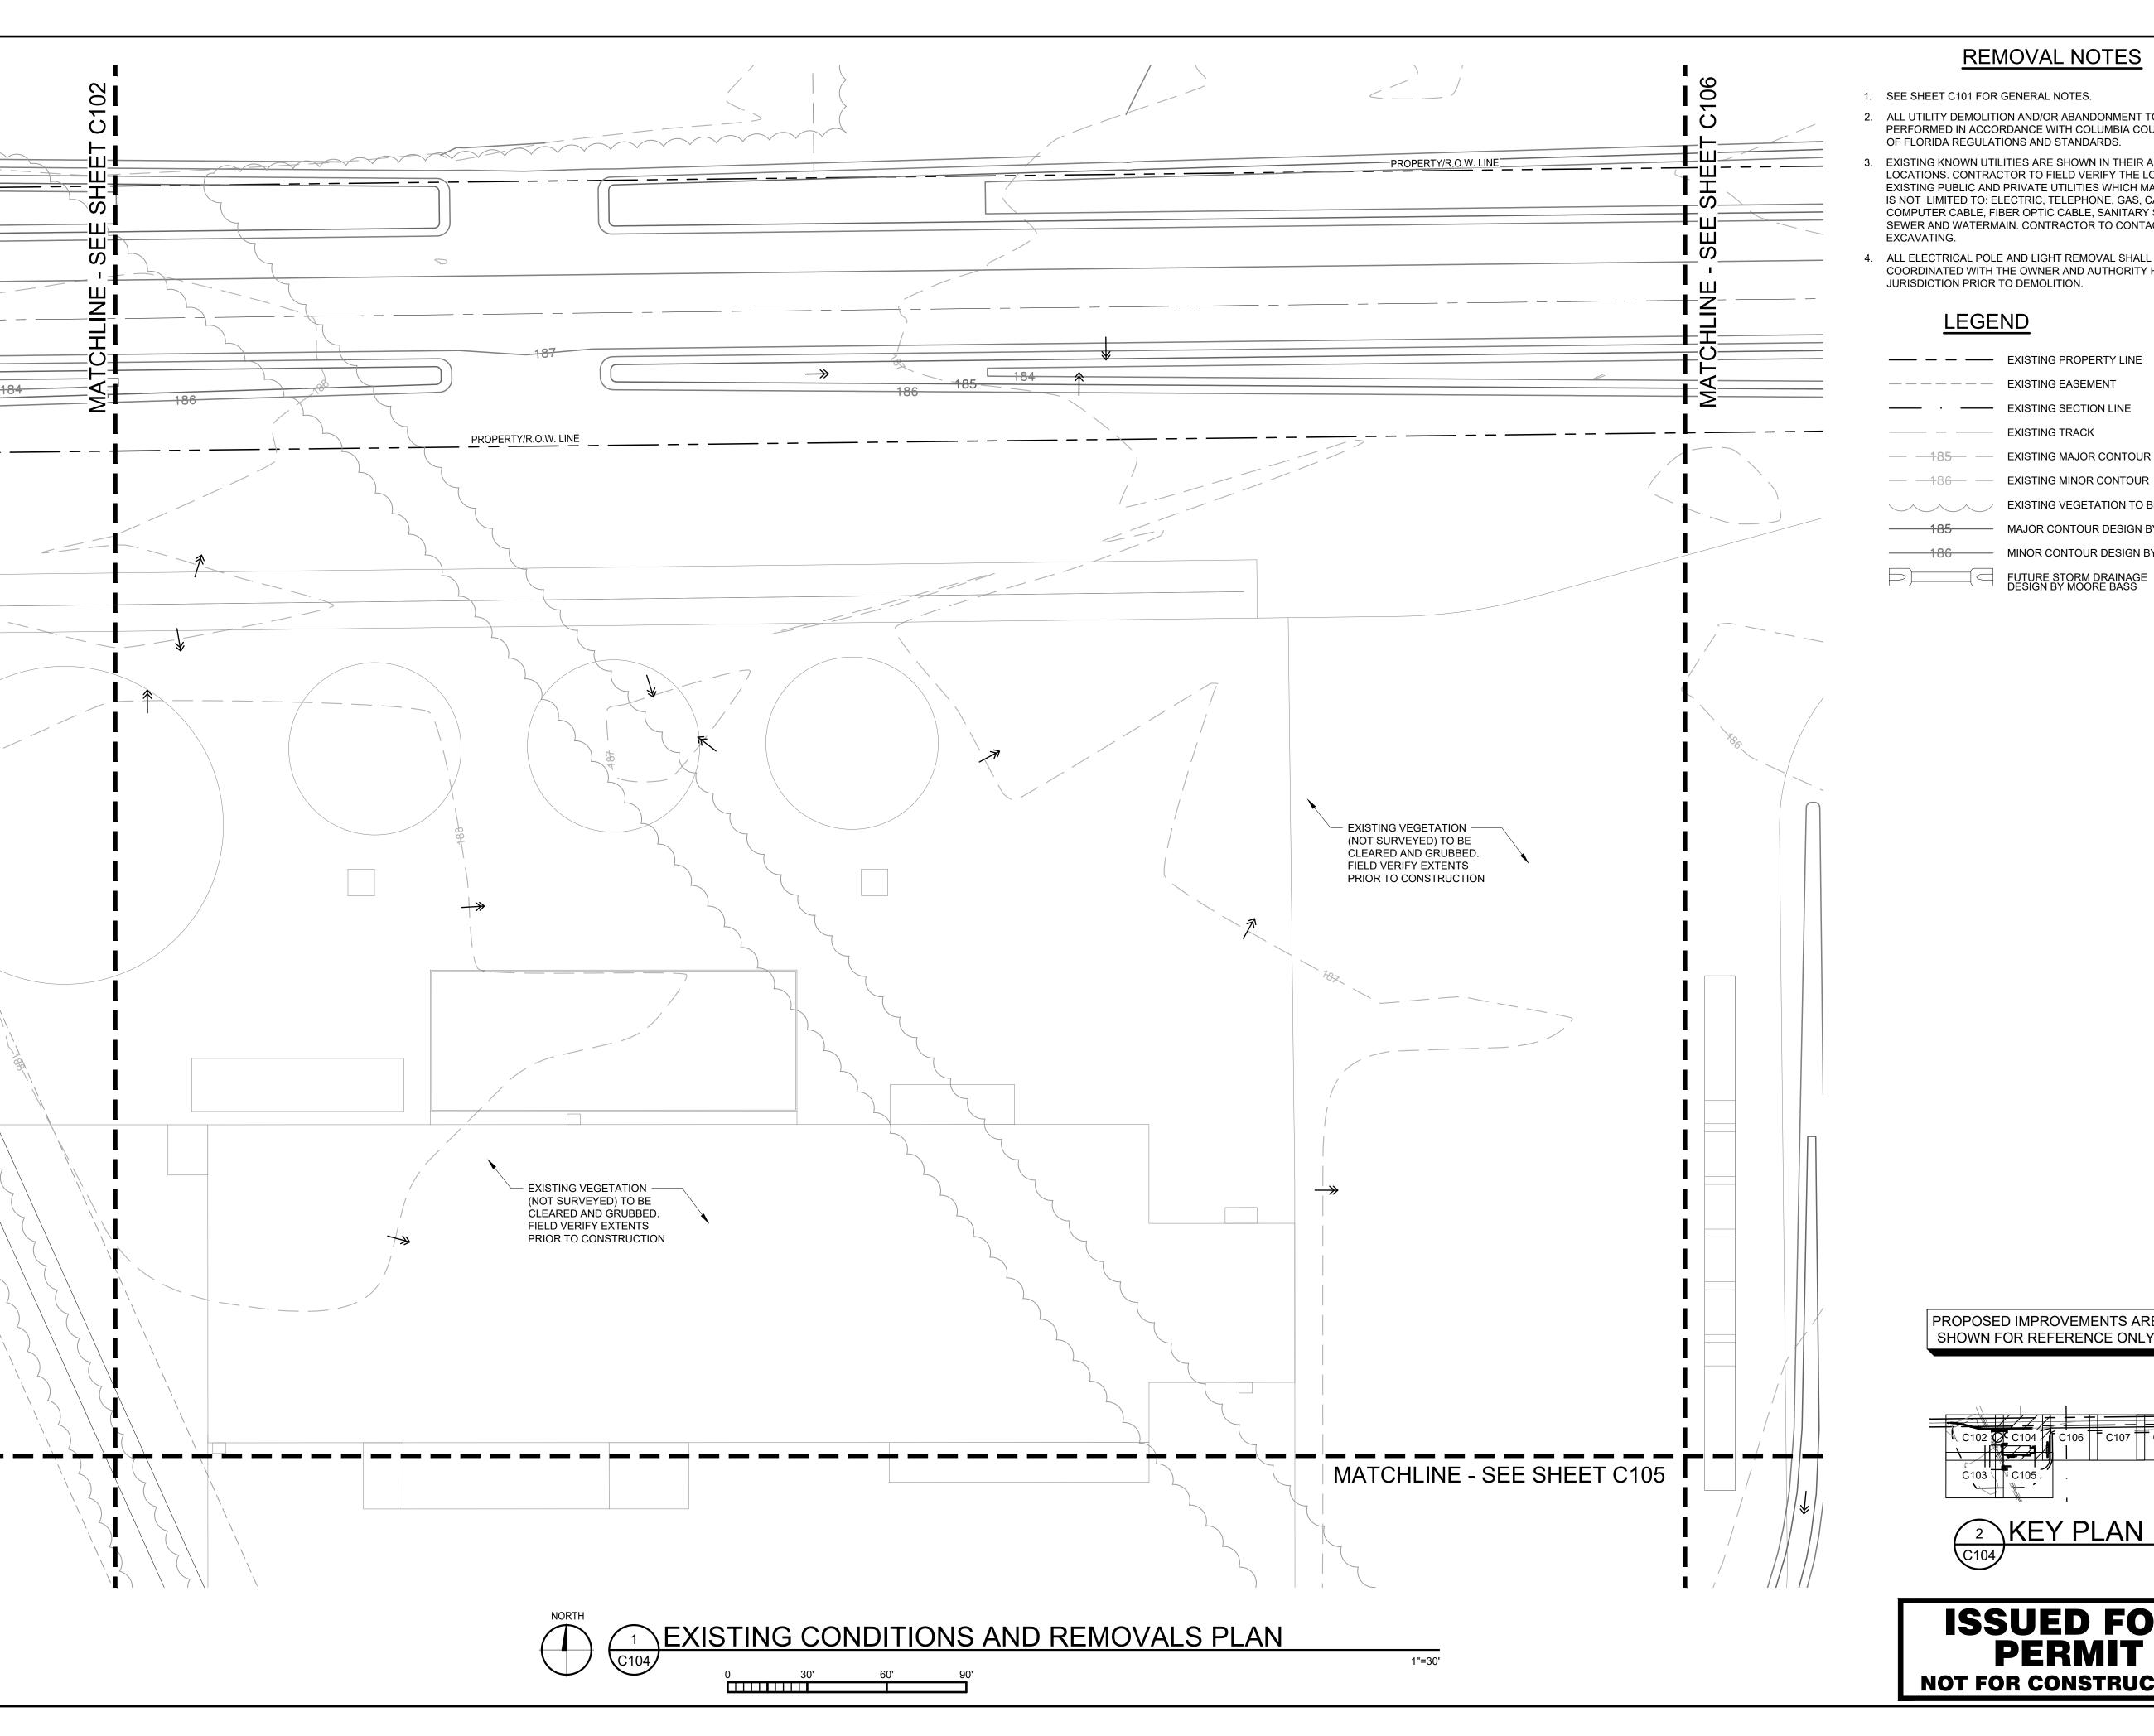

- 1. SEE SHEET C101 FOR GENERAL NOTES.
- 2. ALL UTILITY DEMOLITION AND/OR ABANDONMENT TO BE PERFORMED IN ACCORDANCE WITH COLUMBIA COUNTY AND STA OF FLORIDA REGULATIONS AND STANDARDS.
- EXISTING KNOWN UTILITIES ARE SHOWN IN THEIR APPROXIMATE LOCATIONS. CONTRACTOR TO FIELD VERIFY THE LOCATION OF A EXISTING PUBLIC AND PRIVATE UTILITIES WHICH MAY INCLUDE BUT IS NOT LIMITED TO: ELECTRIC, TELEPHONE, GAS, CABLE TV, COMPUTER CABLE, FIBER OPTIC CABLE, SANITARY SEWER, STORM SEWER AND WATERMAIN. CONTRACTOR TO CONTACT 811 BEFORE
- ALL ELECTRICAL POLE AND LIGHT REMOVAL SHALL BE COORDINATED WITH THE OWNER AND AUTHORITY HAVING JURISDICTION PRIOR TO DEMOLITION.

LEGEND

—— — — EXISTING PROPERTY LINE — — — — EXISTING EASEMENT —— EXISTING SECTION LINE

—— — EXISTING TRACK — — 185— — EXISTING MAJOR CONTOUR

EXISTING VEGETATION TO BE REMOVED 185 MAJOR CONTOUR DESIGN BY MOORE BASS

— MINOR CONTOUR DESIGN BY MOORE BASS

Plymouth, MN 55441 Project # 230384

2300 Berkshire Lane N, Suite 200



www.vaaeng.com

PROJECT:

NEW LIQUID FERTILIZER FACILITY LAKE CITY, FL

NO	DATE	ISSUE/REVISION	BY
Α	10/19/2023	DESIGN DEVELOPMENT	RCQ
В	12/11/2023	ISSUED FOR PERMIT	RCQ

CERTIFICATION:

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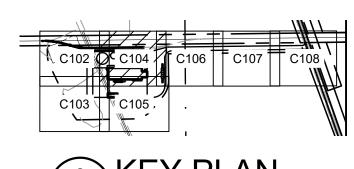
DRAWN: 10/19/2023 DESIGNED: APPROVED: CHECKED: AJR

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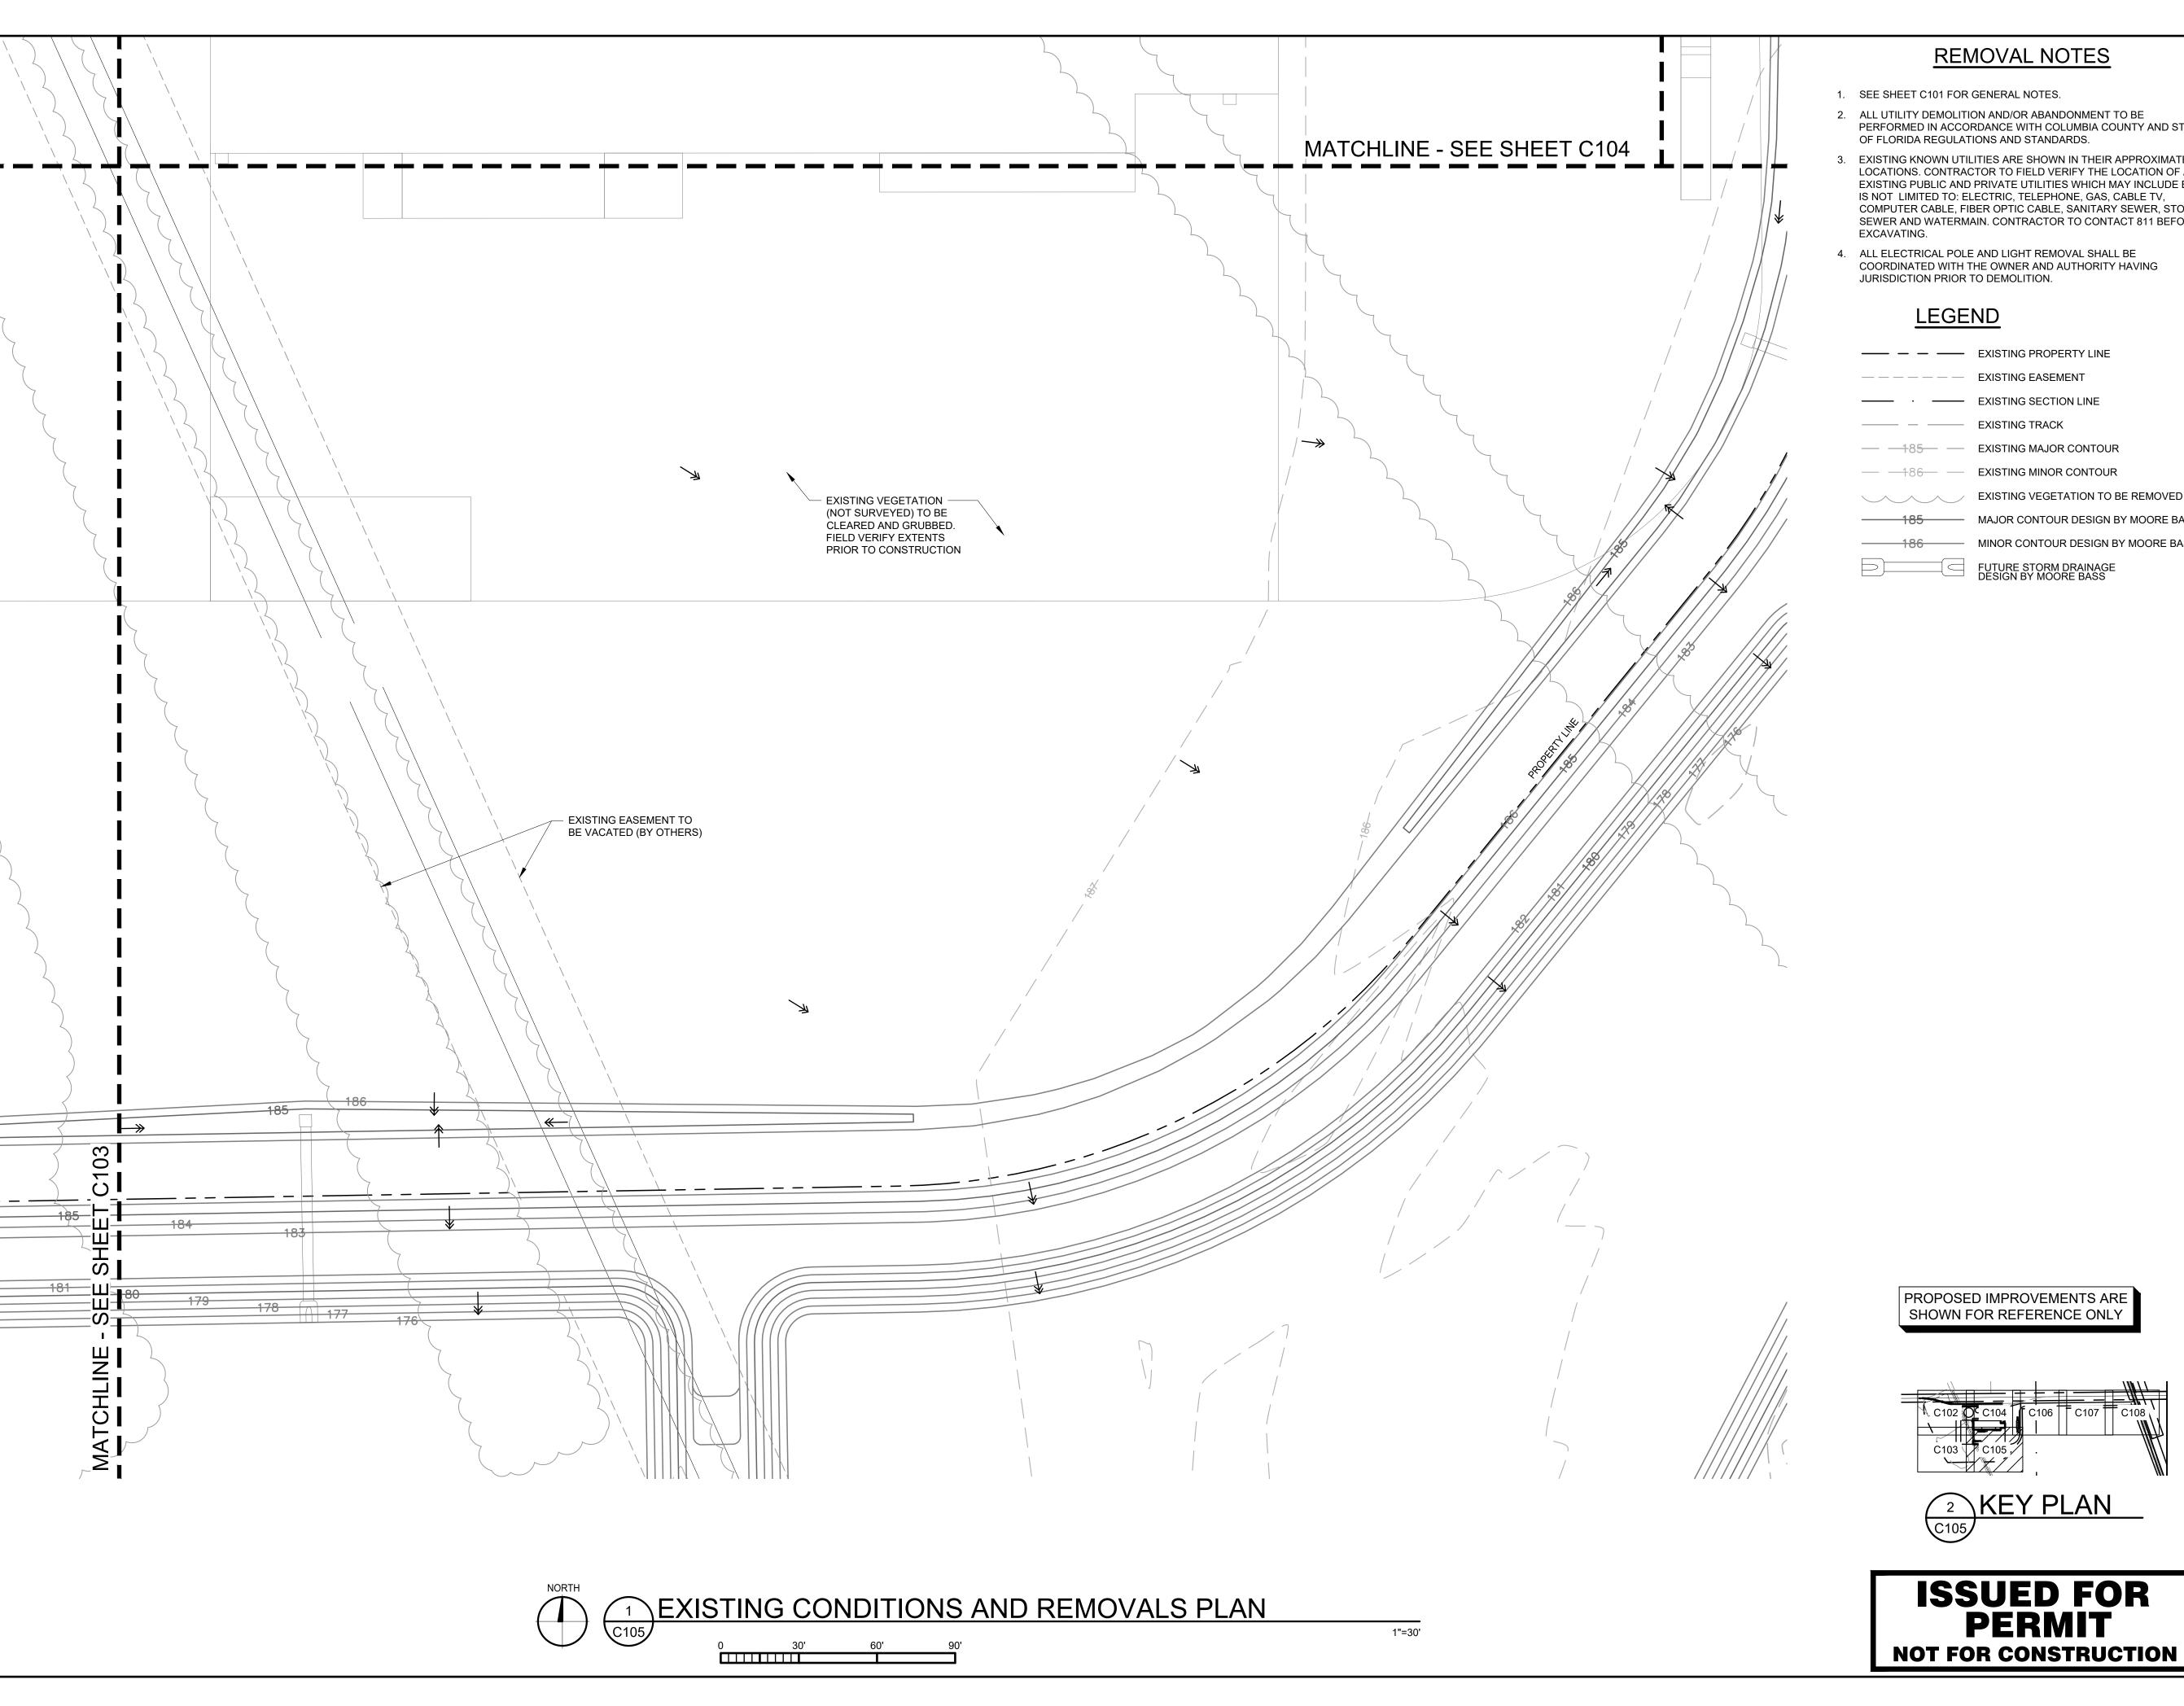
EXISTING CONDITIONS AND REMOVALS PLAN

DRAWING NO: PROJECT NO: 230384 C104 SCALE: AS NOTED

PROPOSED IMPROVEMENTS ARE SHOWN FOR REFERENCE ONLY







- 1. SEE SHEET C101 FOR GENERAL NOTES.
- ALL UTILITY DEMOLITION AND/OR ABANDONMENT TO BE PERFORMED IN ACCORDANCE WITH COLUMBIA COUNTY AND STAT OF FLORIDA REGULATIONS AND STANDARDS.
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- 4. ALL ELECTRICAL POLE AND LIGHT REMOVAL SHALL BE COORDINATED WITH THE OWNER AND AUTHORITY HAVING JURISDICTION PRIOR TO DEMOLITION.

LEGEND

—— — — EXISTING PROPERTY LINE — — — — EXISTING EASEMENT · — EXISTING SECTION LINE ——— — EXISTING TRACK — 185 — EXISTING MAJOR CONTOUR — — 186— — EXISTING MINOR CONTOUR EXISTING VEGETATION TO BE REMOVED 185 MAJOR CONTOUR DESIGN BY MOORE BASS — MINOR CONTOUR DESIGN BY MOORE BASS



2300 Berkshire Lane N, Suite 200 www.vaaeng.com Plymouth, MN 55441



PROJECT:

NEW LIQUID FERTILIZER FACILITY LAKE CITY, FL

NO	DATE	ISSUE/REVISION	BY
Α	10/19/2023	DESIGN DEVELOPMENT	RCQ
В	12/11/2023	ISSUED FOR PERMIT	RCQ

CERTIFICATION:

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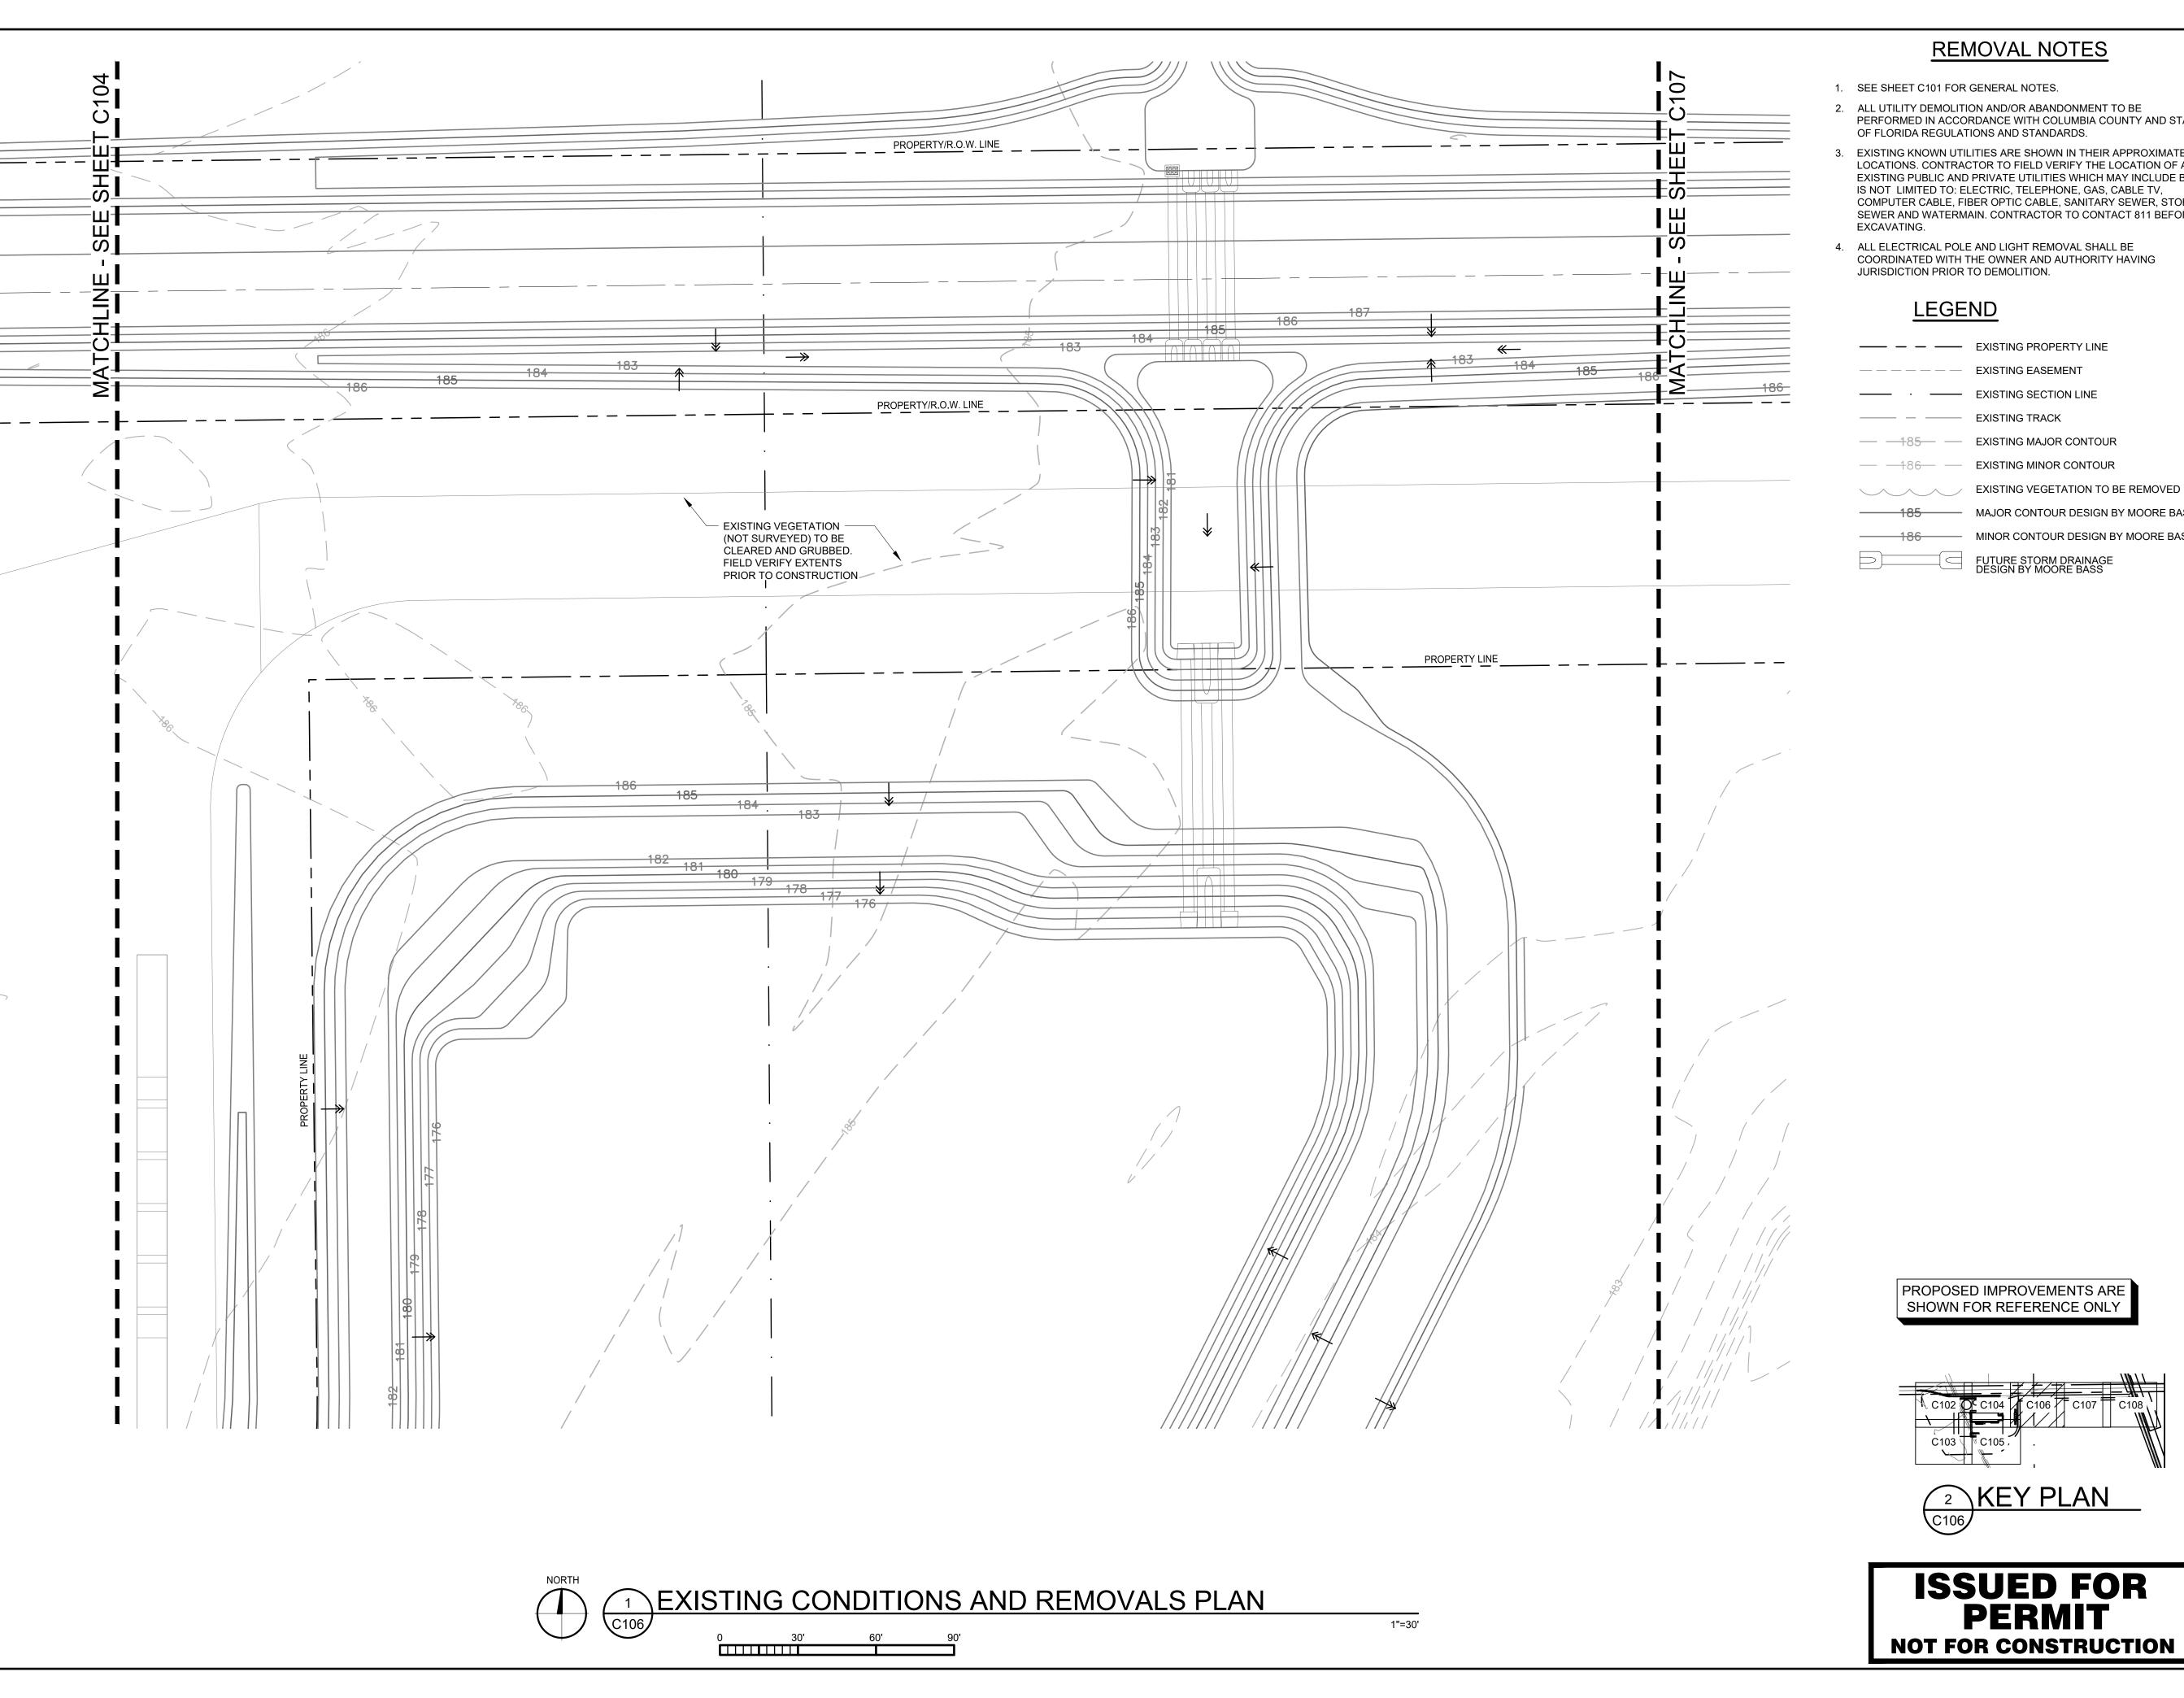
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	DATE:		DRAWN:	
	10/19/2023		RCQ	
	DESIGNED:	CHECKE	D:	APPROVED:
	7.01.	/		

DRAWING TITLE:

EXISTING CONDITIONS AND REMOVALS PLAN

DRAWING NO: PROJECT NO: 230384 C105 SCALE: AS NOTED



- 1. SEE SHEET C101 FOR GENERAL NOTES.
- 2. ALL UTILITY DEMOLITION AND/OR ABANDONMENT TO BE PERFORMED IN ACCORDANCE WITH COLUMBIA COUNTY AND STA OF FLORIDA REGULATIONS AND STANDARDS.
- 3. EXISTING KNOWN UTILITIES ARE SHOWN IN THEIR APPROXIMATE LOCATIONS. CONTRACTOR TO FIELD VERIFY THE LOCATION OF AL EXISTING PUBLIC AND PRIVATE UTILITIES WHICH MAY INCLUDE BUT IS NOT LIMITED TO: ELECTRIC, TELEPHONE, GAS, CABLE TV, COMPUTER CABLE, FIBER OPTIC CABLE, SANITARY SEWER, STORM SEWER AND WATERMAIN. CONTRACTOR TO CONTACT 811 BEFORE
- 4. ALL ELECTRICAL POLE AND LIGHT REMOVAL SHALL BE COORDINATED WITH THE OWNER AND AUTHORITY HAVING JURISDICTION PRIOR TO DEMOLITION.

LEGEND

— — — — EXISTING EASEMENT —— EXISTING SECTION LINE ——— — EXISTING TRACK — — 185— — EXISTING MAJOR CONTOUR — — 186— — EXISTING MINOR CONTOUR

186 MINOR CONTOUR DESIGN BY MOORE BASS

185 MAJOR CONTOUR DESIGN BY MOORE BASS

FUTURE STORM DRAINAGE DESIGN BY MOORE BASS



www.vaaeng.com

Project # 230384

2300 Berkshire Lane N, Suite 200 Plymouth, MN 55441



PROJECT:

NEW LIQUID FERTILIZER FACILITY LAKE CITY, FL

NO	DATE	ISSUE/REVISION	BY
Α	10/19/2023	DESIGN DEVELOPMENT	RCQ
В	12/11/2023	ISSUED FOR PERMIT	RCQ

CERTIFICATION:

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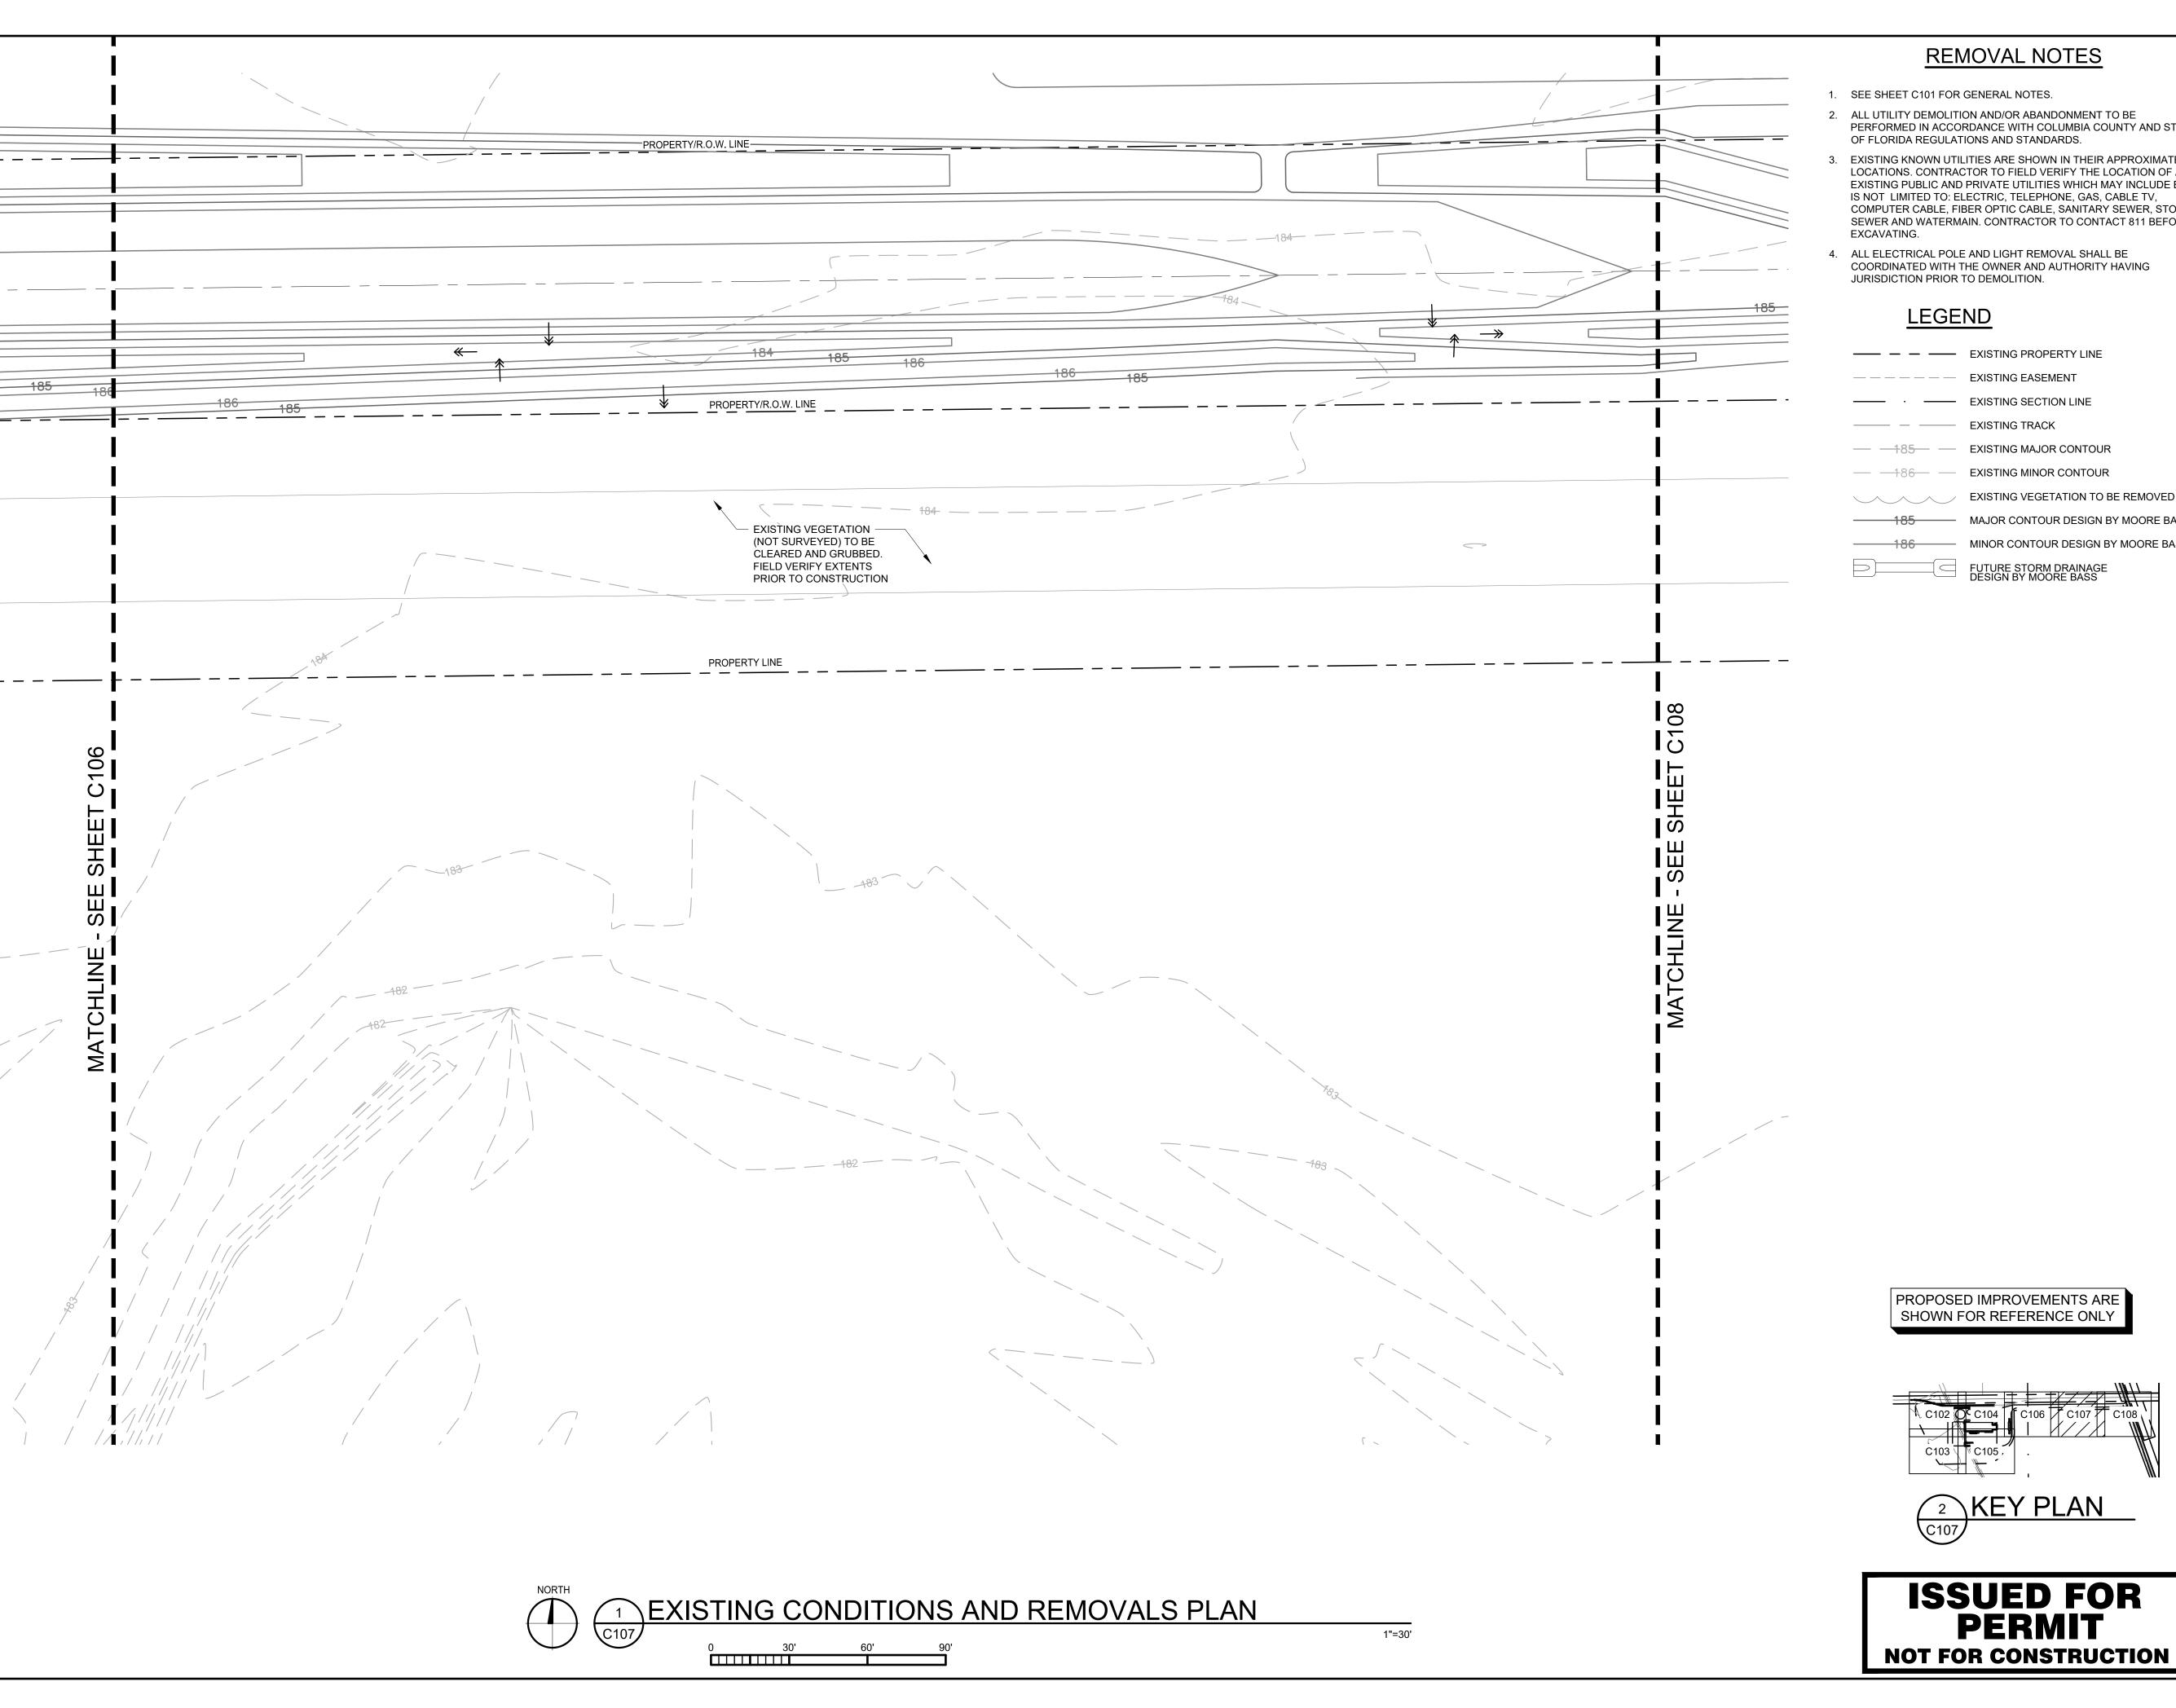
DRAWN: RCQ 10/19/2023 DESIGNED: APPROVED: CHECKED: AJR MDM

DRAWING TITLE:

EXISTING CONDITIONS AND REMOVALS PLAN

C106

ISSUED FOR PROJECT NO: DRAWING NO: **PERMIT** 230384 SCALE: NOT FOR CONSTRUCTION AS NOTED



- 1. SEE SHEET C101 FOR GENERAL NOTES.
- 2. ALL UTILITY DEMOLITION AND/OR ABANDONMENT TO BE PERFORMED IN ACCORDANCE WITH COLUMBIA COUNTY AND STA OF FLORIDA REGULATIONS AND STANDARDS.
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LEGEND

—— — — EXISTING PROPERTY LINE — — — — EXISTING EASEMENT —— EXISTING SECTION LINE

— — 185— — EXISTING MAJOR CONTOUR

EXISTING VEGETATION TO BE REMOVED 185 MAJOR CONTOUR DESIGN BY MOORE BASS

186 MINOR CONTOUR DESIGN BY MOORE BASS FUTURE STORM DRAINAGE DESIGN BY MOORE BASS

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Project # 230384

2300 Berkshire Lane N, Suite 200 Plymouth, MN 55441



PROJECT:

NEW LIQUID FERTILIZER FACILITY LAKE CITY, FL

NO	DATE	ISSUE/REVISION	BY
Α	10/19/2023	DESIGN DEVELOPMENT	RCQ
В	12/11/2023	ISSUED FOR PERMIT	RCQ

CERTIFICATION:

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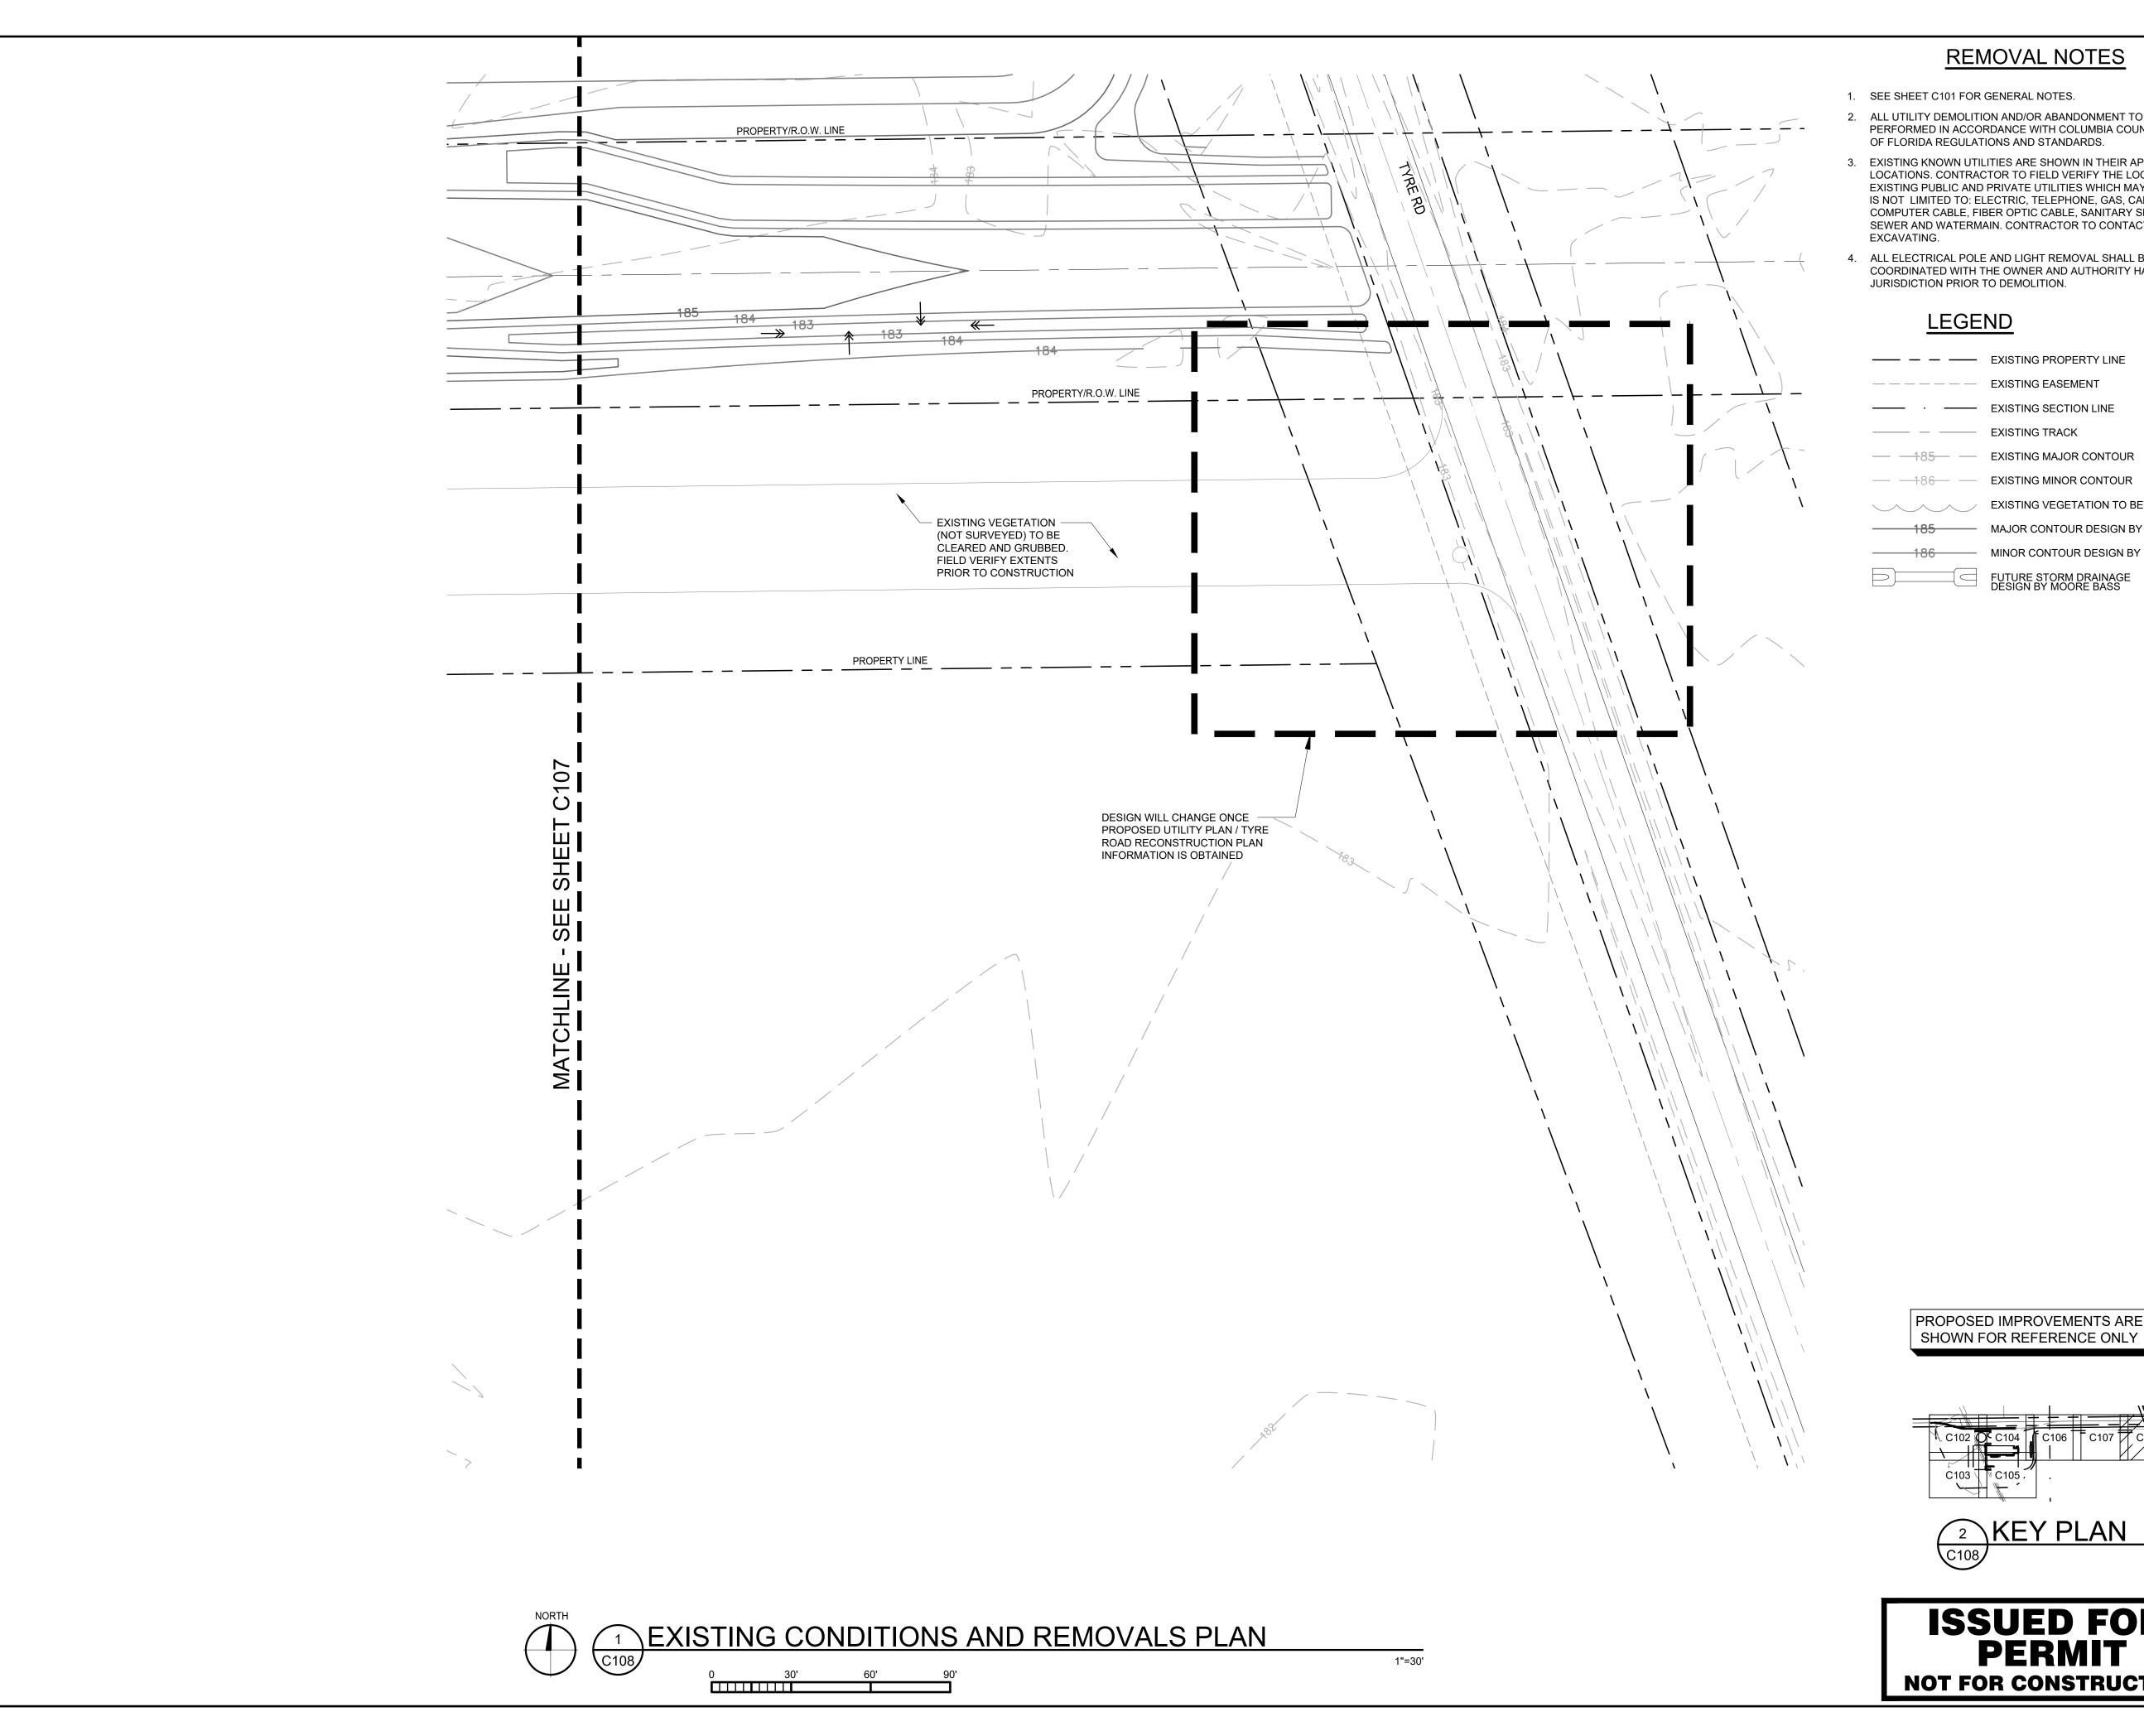
DESIGNED: CHECKED: APPROVED: AJR

DRAWING TITLE:

EXISTING CONDITIONS AND REMOVALS PLAN

C107

PROJECT NO: DRAWING NO: 230384 SCALE: AS NOTED



- 1. SEE SHEET C101 FOR GENERAL NOTES.
- 2. ALL UTILITY DEMOLITION AND/OR ABANDONMENT TO BE PERFORMED IN ACCORDANCE WITH COLUMBIA COUNTY AND STA OF FLORIDA REGULATIONS AND STANDARDS.
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LEGEND

—— — — EXISTING PROPERTY LINE — — — — EXISTING EASEMENT —— EXISTING SECTION LINE

——— — EXISTING TRACK

— — 186— — EXISTING MINOR CONTOUR

EXISTING VEGETATION TO BE REMOVED 185 MAJOR CONTOUR DESIGN BY MOORE BASS

— MINOR CONTOUR DESIGN BY MOORE BASS FUTURE STORM DRAINAGE DESIGN BY MOORE BASS

www.vaaeng.com

Project # 230384

2300 Berkshire Lane N, Suite 200

Plymouth, MN 55441



PROJECT:

NEW LIQUID FERTILIZER FACILITY LAKE CITY, FL

ΙГ	NO	DATE	ISSUE/REVISION	DV
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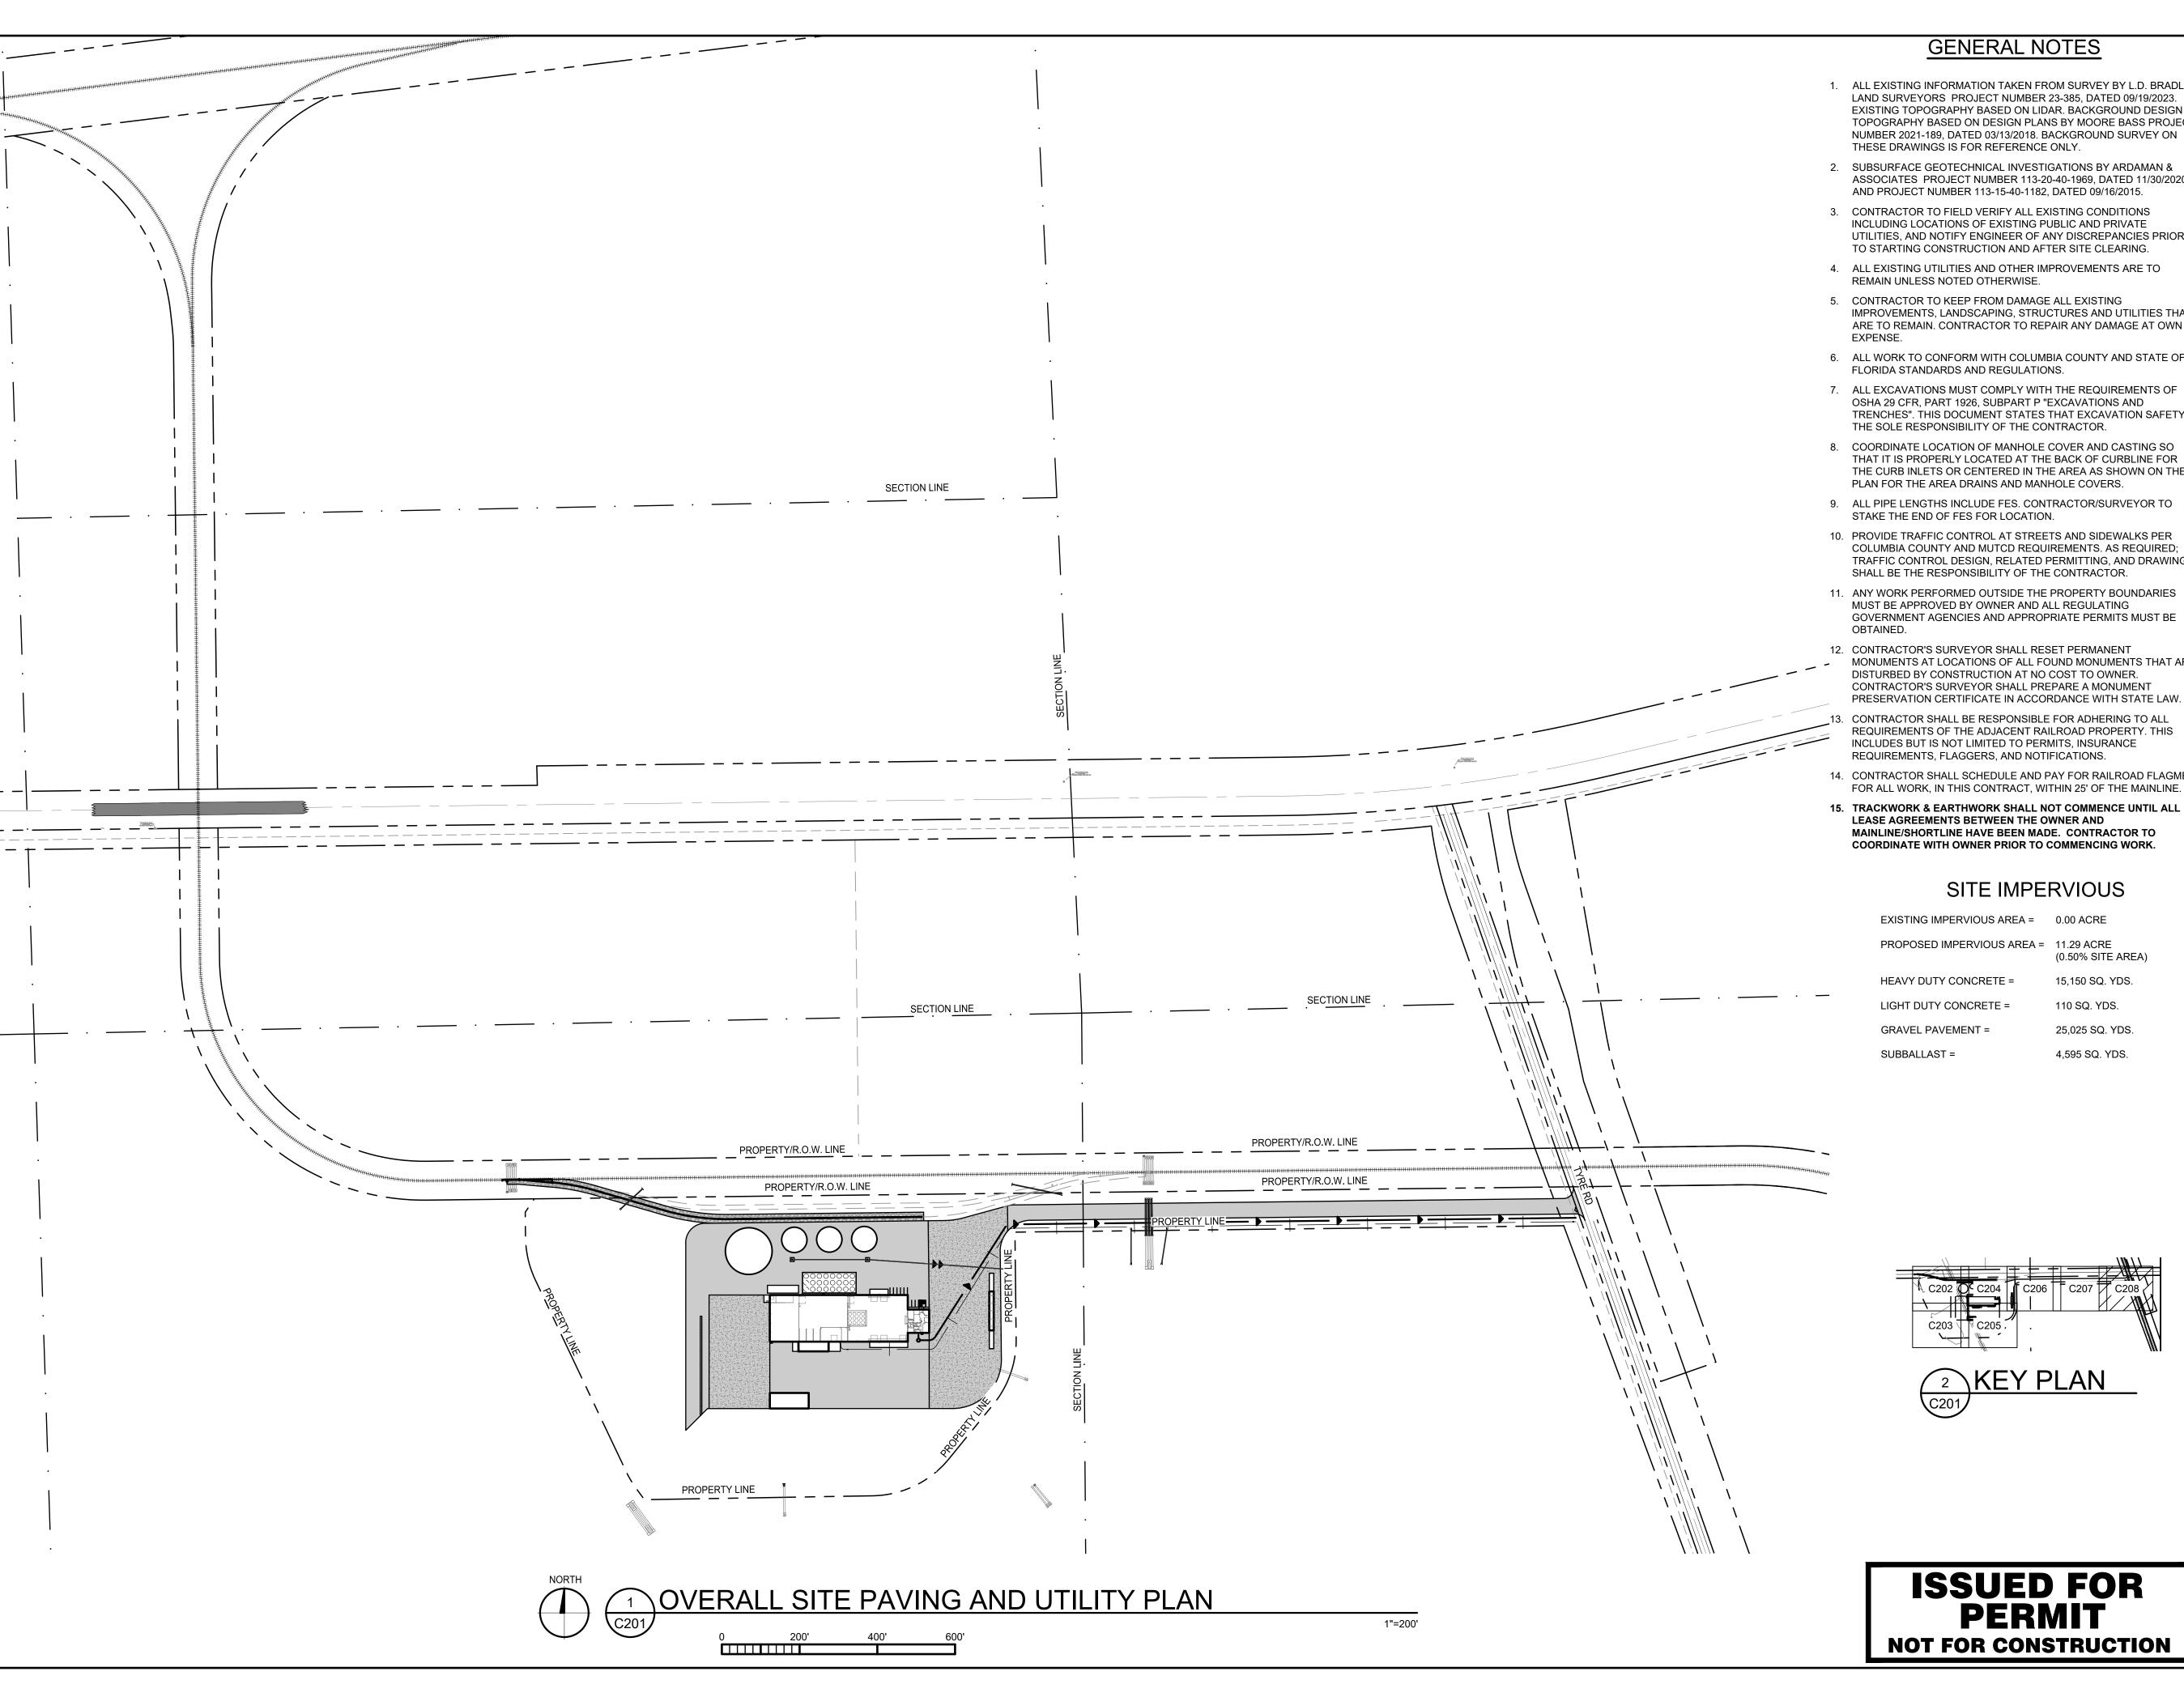
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10/19/2023 CHECKED: DESIGNED: APPROVED: AJR

DRAWING TITLE:

EXISTING CONDITIONS AND REMOVALS PLAN

ROJECT NO:	DRAWING NO:
230384	C100
CALE:	─ C108
AS NOTED	



GENERAL NOTES

- 1. ALL EXISTING INFORMATION TAKEN FROM SURVEY BY L.D. BRADLEY LAND SURVEYORS PROJECT NUMBER 23-385, DATED 09/19/2023. EXISTING TOPOGRAPHY BASED ON LIDAR. BACKGROUND DESIGN TOPOGRAPHY BASED ON DESIGN PLANS BY MOORE BASS PROJECT NUMBER 2021-189, DATED 03/13/2018. BACKGROUND SURVEY ON THESE DRAWINGS IS FOR REFERENCE ONLY.
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- 15. TRACKWORK & EARTHWORK SHALL NOT COMMENCE UNTIL ALL LEASE AGREEMENTS BETWEEN THE OWNER AND MAINLINE/SHORTLINE HAVE BEEN MADE. CONTRACTOR TO COORDINATE WITH OWNER PRIOR TO COMMENCING WORK.

SITE IMPERVIOUS

25,025 SQ. YDS.


EXISTING IMPERVIOUS AREA = 0.00 ACRE

PROPOSED IMPERVIOUS AREA = 11.29 ACRE (0.50% SITE AREA)

HEAVY DUTY CONCRETE = 15,150 SQ. YDS.

LIGHT DUTY CONCRETE = 110 SQ. YDS.

4,595 SQ. YDS.

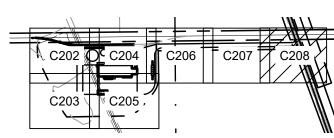



ISSUED FOR PERMIT NOT FOR CONSTRUCTION



2300 Berkshire Lane N, Suite 200 Plymouth, MN 55441

www.vaaeng.com

Project # 230384

PROJECT:

NEW LIQUID FERTILIZER FACILITY LAKE CITY, FL

NO	DATE	ISSUE/REVISION	BY
Α	10/19/2023	DESIGN DEVELOPMENT	RCQ
В	12/11/2023	ISSUED FOR PERMIT	RCQ

CERTIFICATION:

MARK D. MIELKE, PE Registration No. 68730

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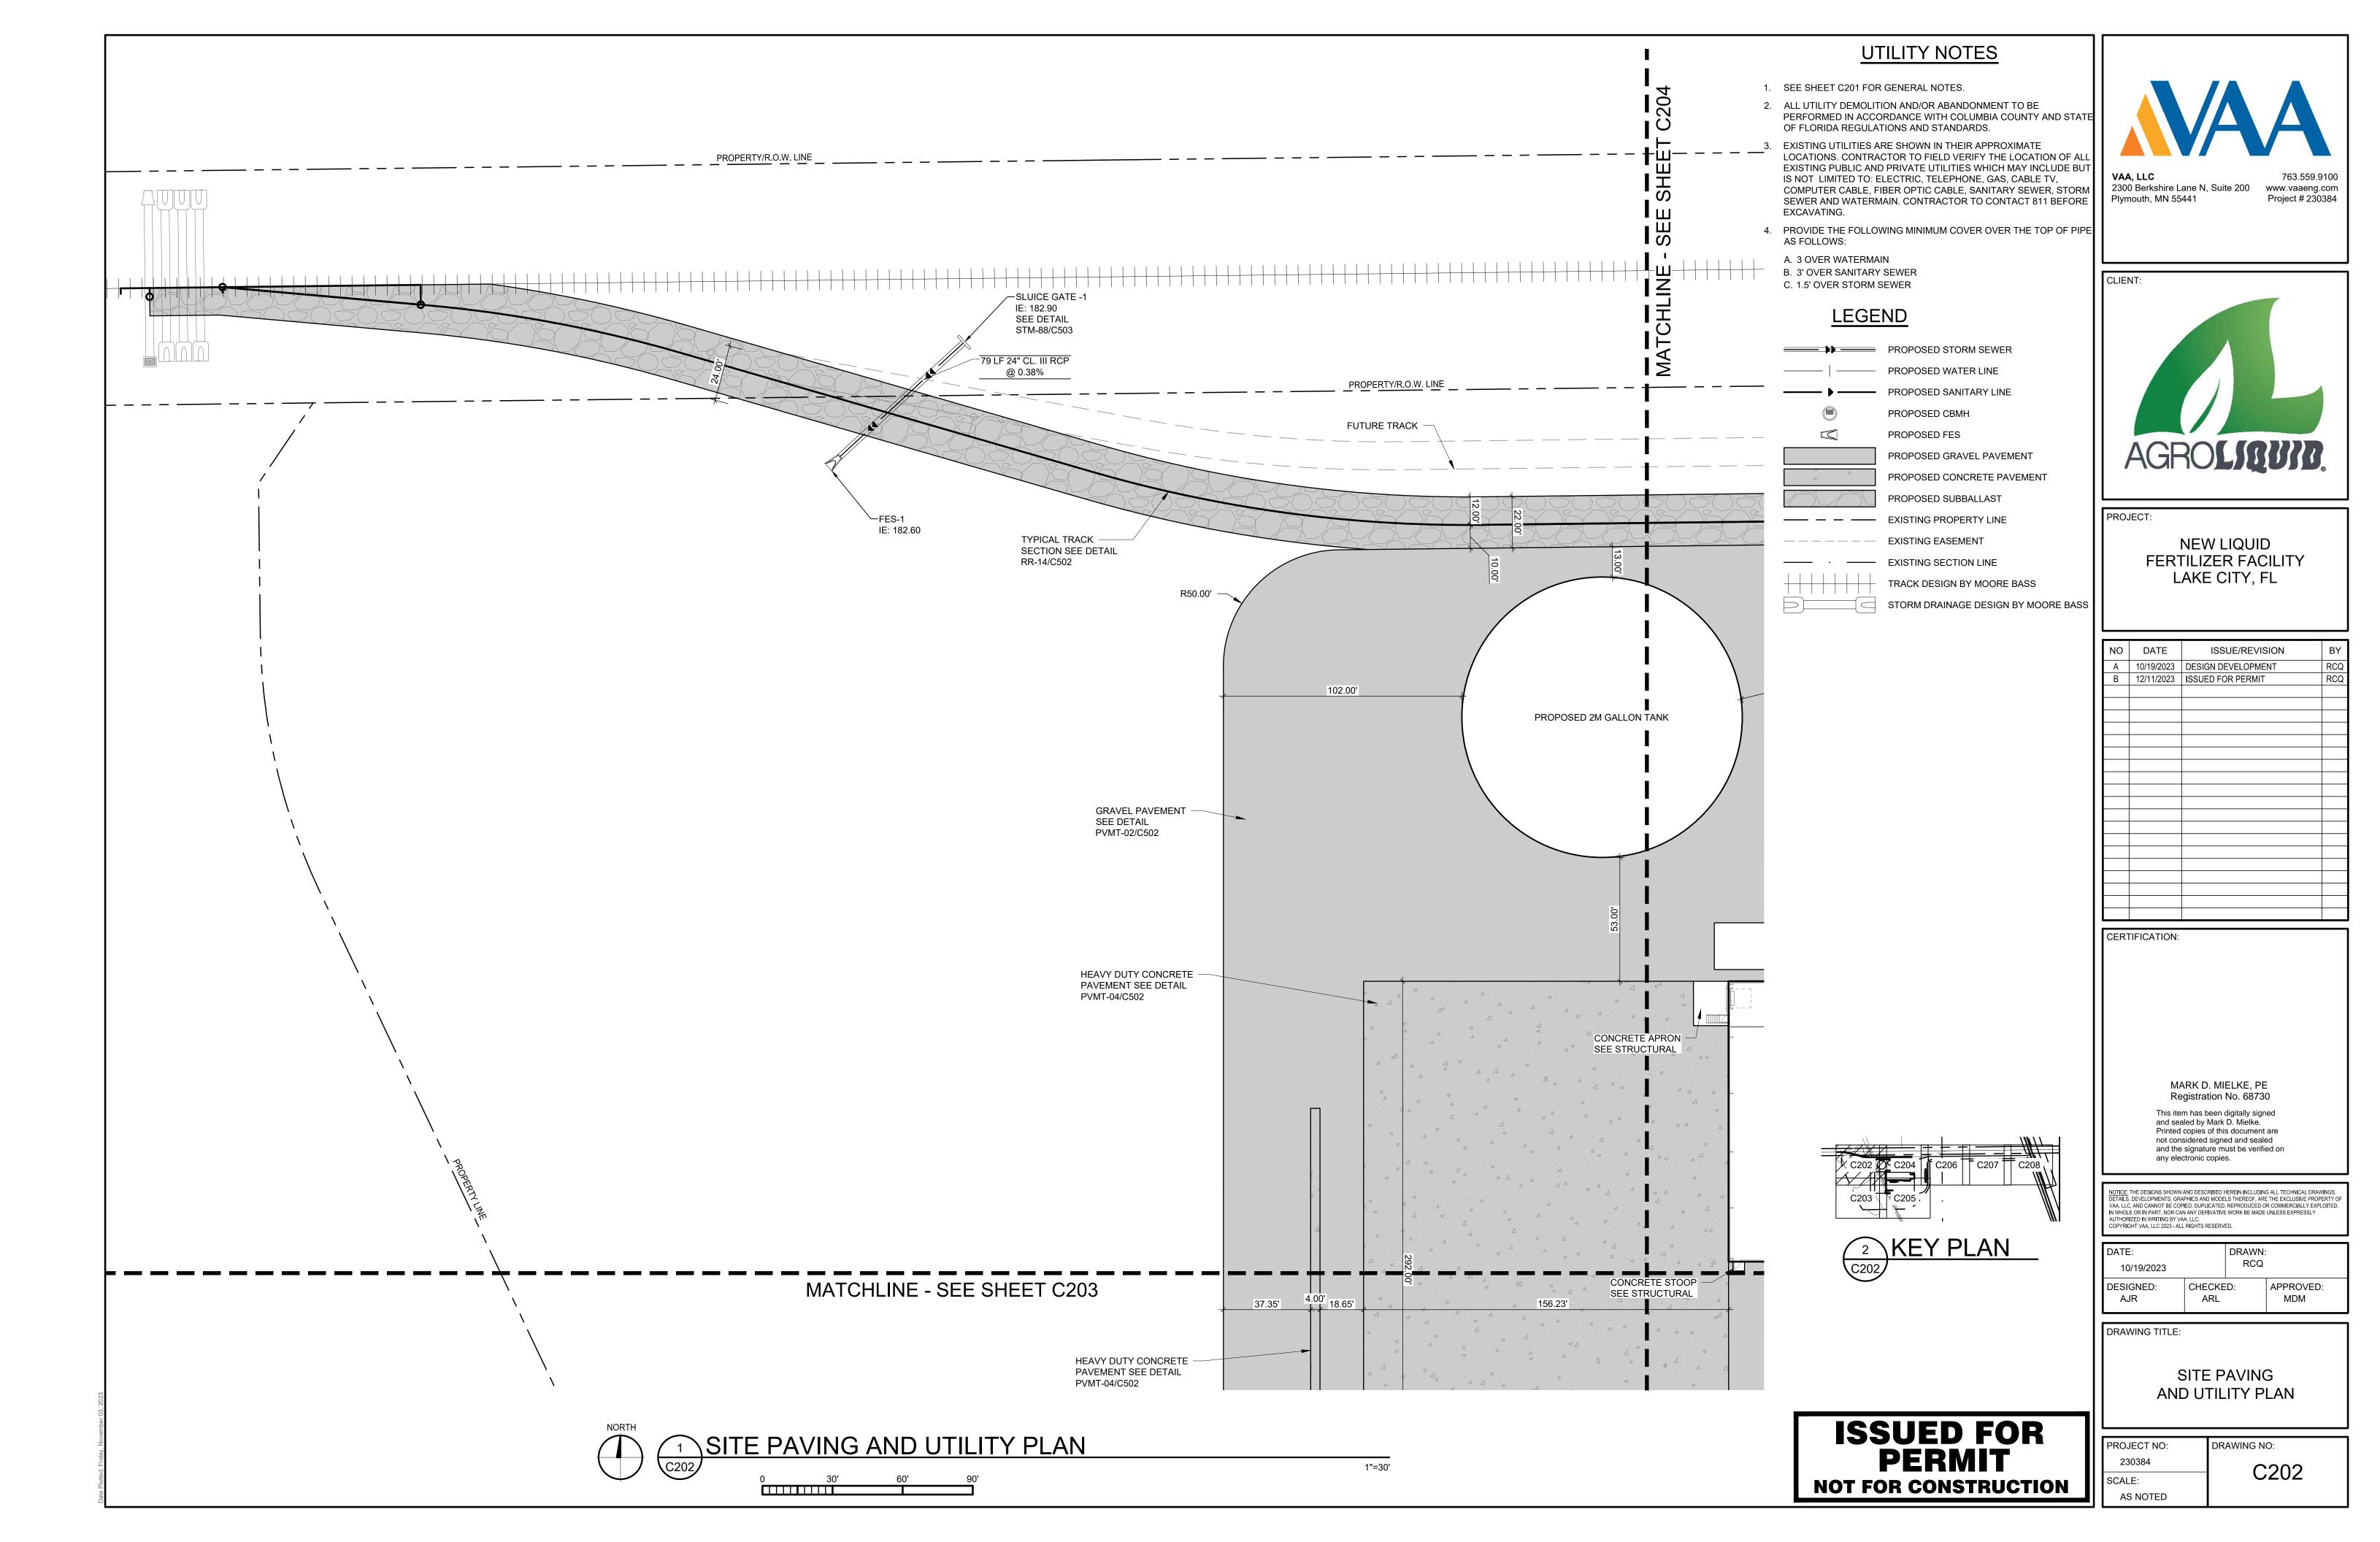
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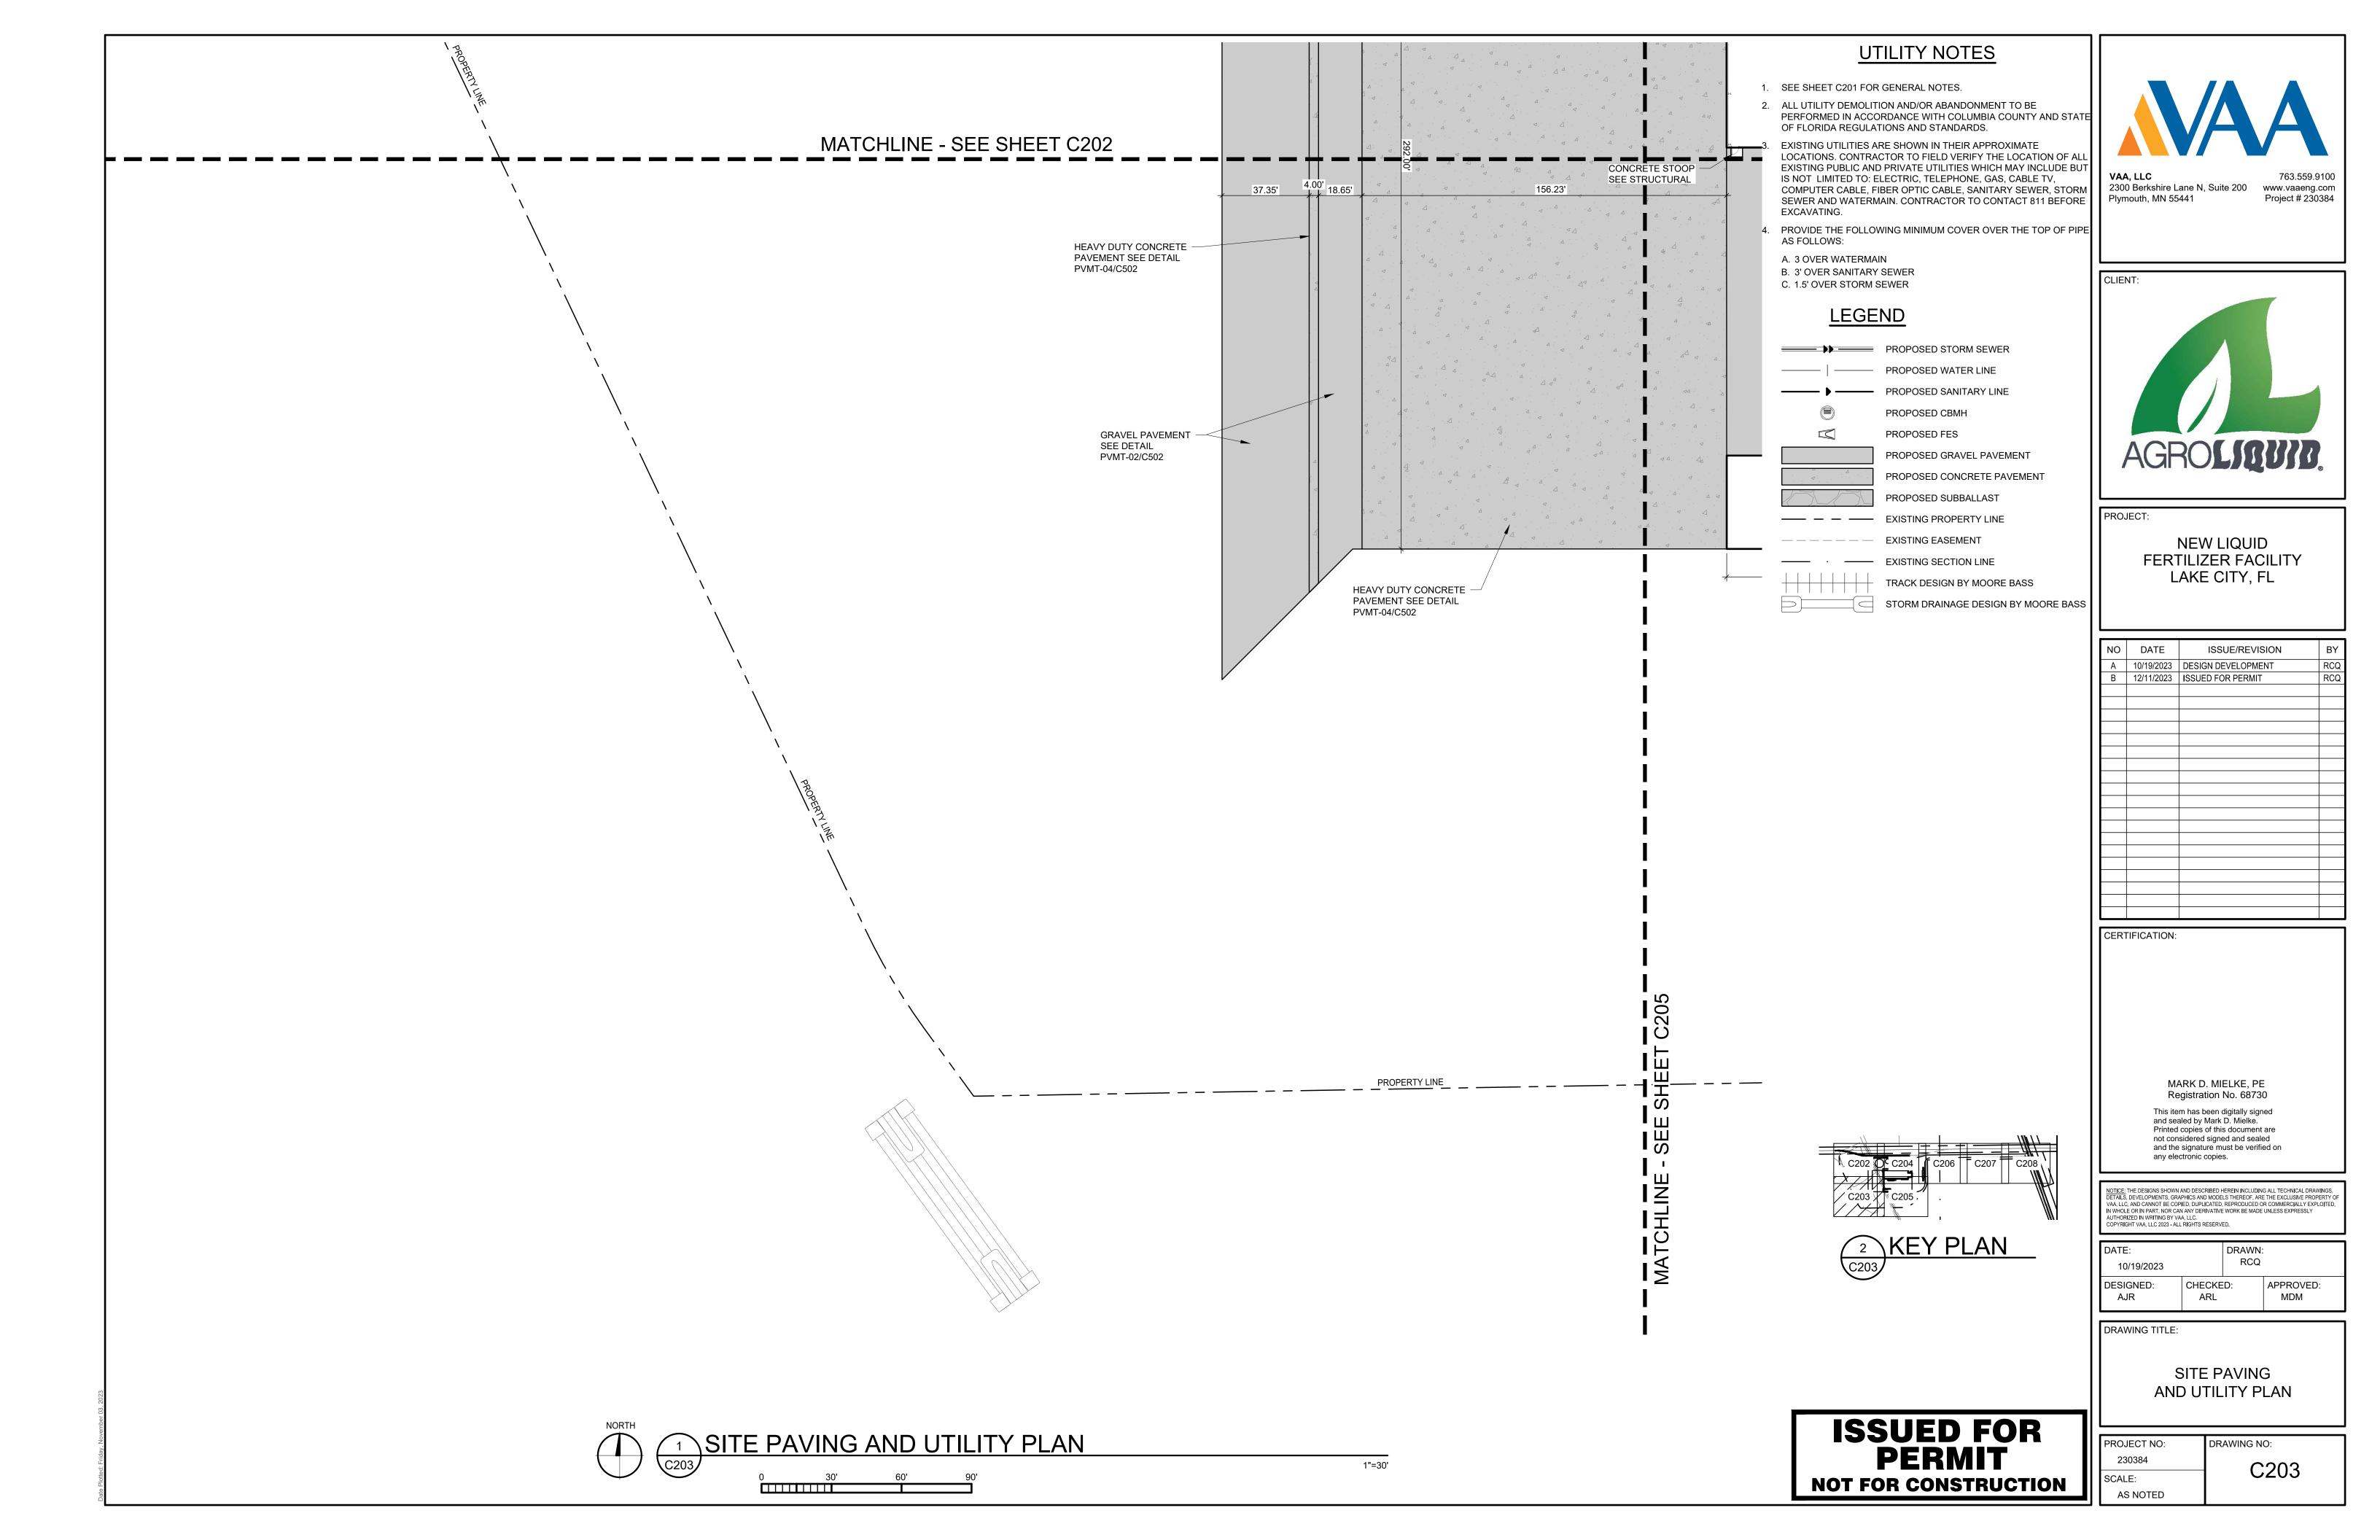
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ı	DATE:		DRAWN:	
	10/19/2023		RCQ	
	DESIGNED:	CHECKE	D:	APPROVED:


DRAWING TITLE:

OVERALL SITE PAVING AND UTILITY PLAN

PROJECT NO: DRAWING NO: 230384 C201 SCALE: AS NOTED





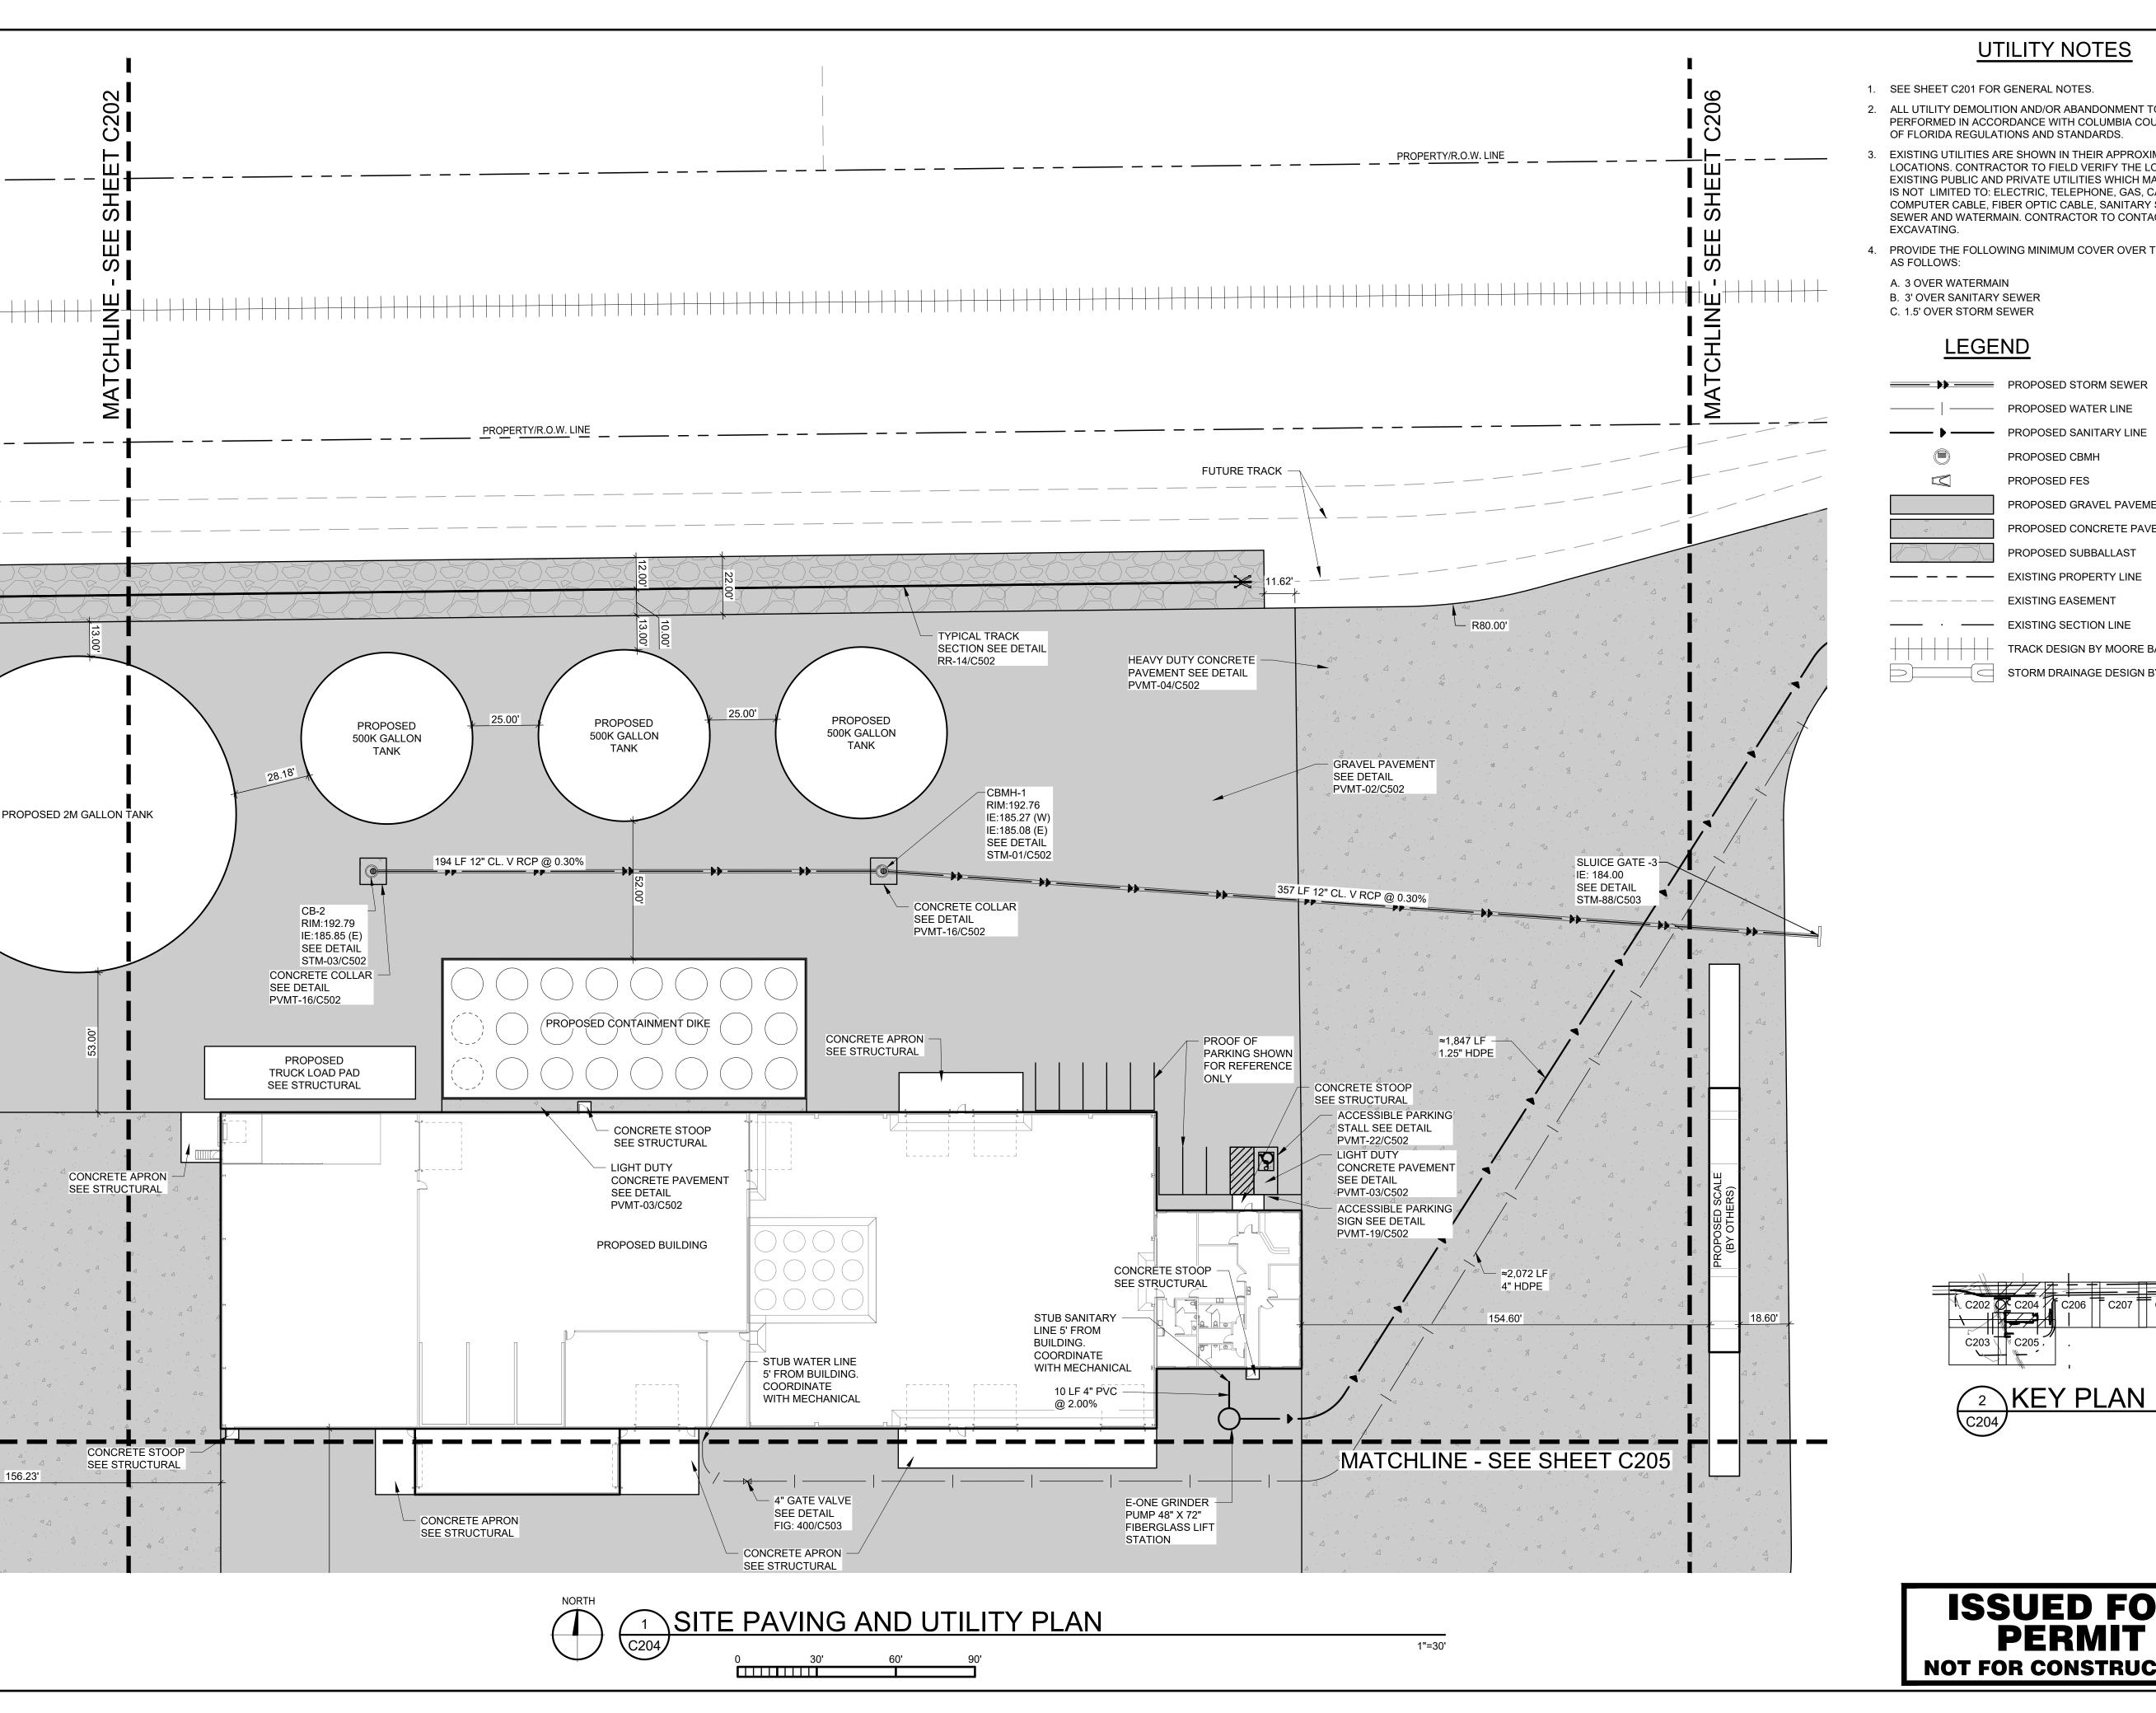

1. SEE SHEET C201 FOR GENERAL NOTES.

2. ALL UTILITY DEMOLITION AND/OR ABANDONMENT TO BE PERFORMED IN ACCORDANCE WITH COLUMBIA COUNTY AND STA OF FLORIDA REGULATIONS AND STANDARDS.


3. EXISTING UTILITIES ARE SHOWN IN THEIR APPROXIMATE

LOCATIONS. CONTRACTOR TO FIELD VERIFY THE LOCATION OF AL EXISTING PUBLIC AND PRIVATE UTILITIES WHICH MAY INCLUDE BUT IS NOT LIMITED TO: ELECTRIC, TELEPHONE, GAS, CABLE TV, COMPUTER CABLE, FIBER OPTIC CABLE, SANITARY SEWER, STORM SEWER AND WATERMAIN. CONTRACTOR TO CONTACT 811 BEFORE

4. PROVIDE THE FOLLOWING MINIMUM COVER OVER THE TOP OF PIPE

B. 3' OVER SANITARY SEWER C. 1.5' OVER STORM SEWER

LEGEND

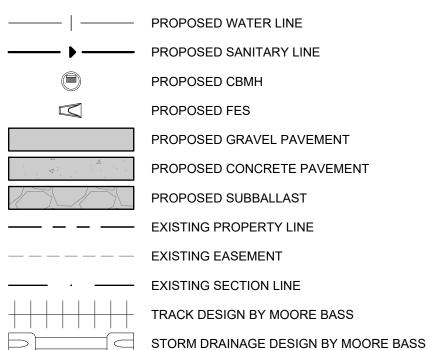



763.559.9100

www.vaaeng.com

Project # 230384

2300 Berkshire Lane N, Suite 200 Plymouth, MN 55441



PROJECT:

NEW LIQUID FERTILIZER FACILITY LAKE CITY, FL

NO	DATE	ISSUE/REVISION	B,
Α	10/19/2023	DESIGN DEVELOPMENT	RC
В	12/11/2023	ISSUED FOR PERMIT	RC

CERTIFICATION:

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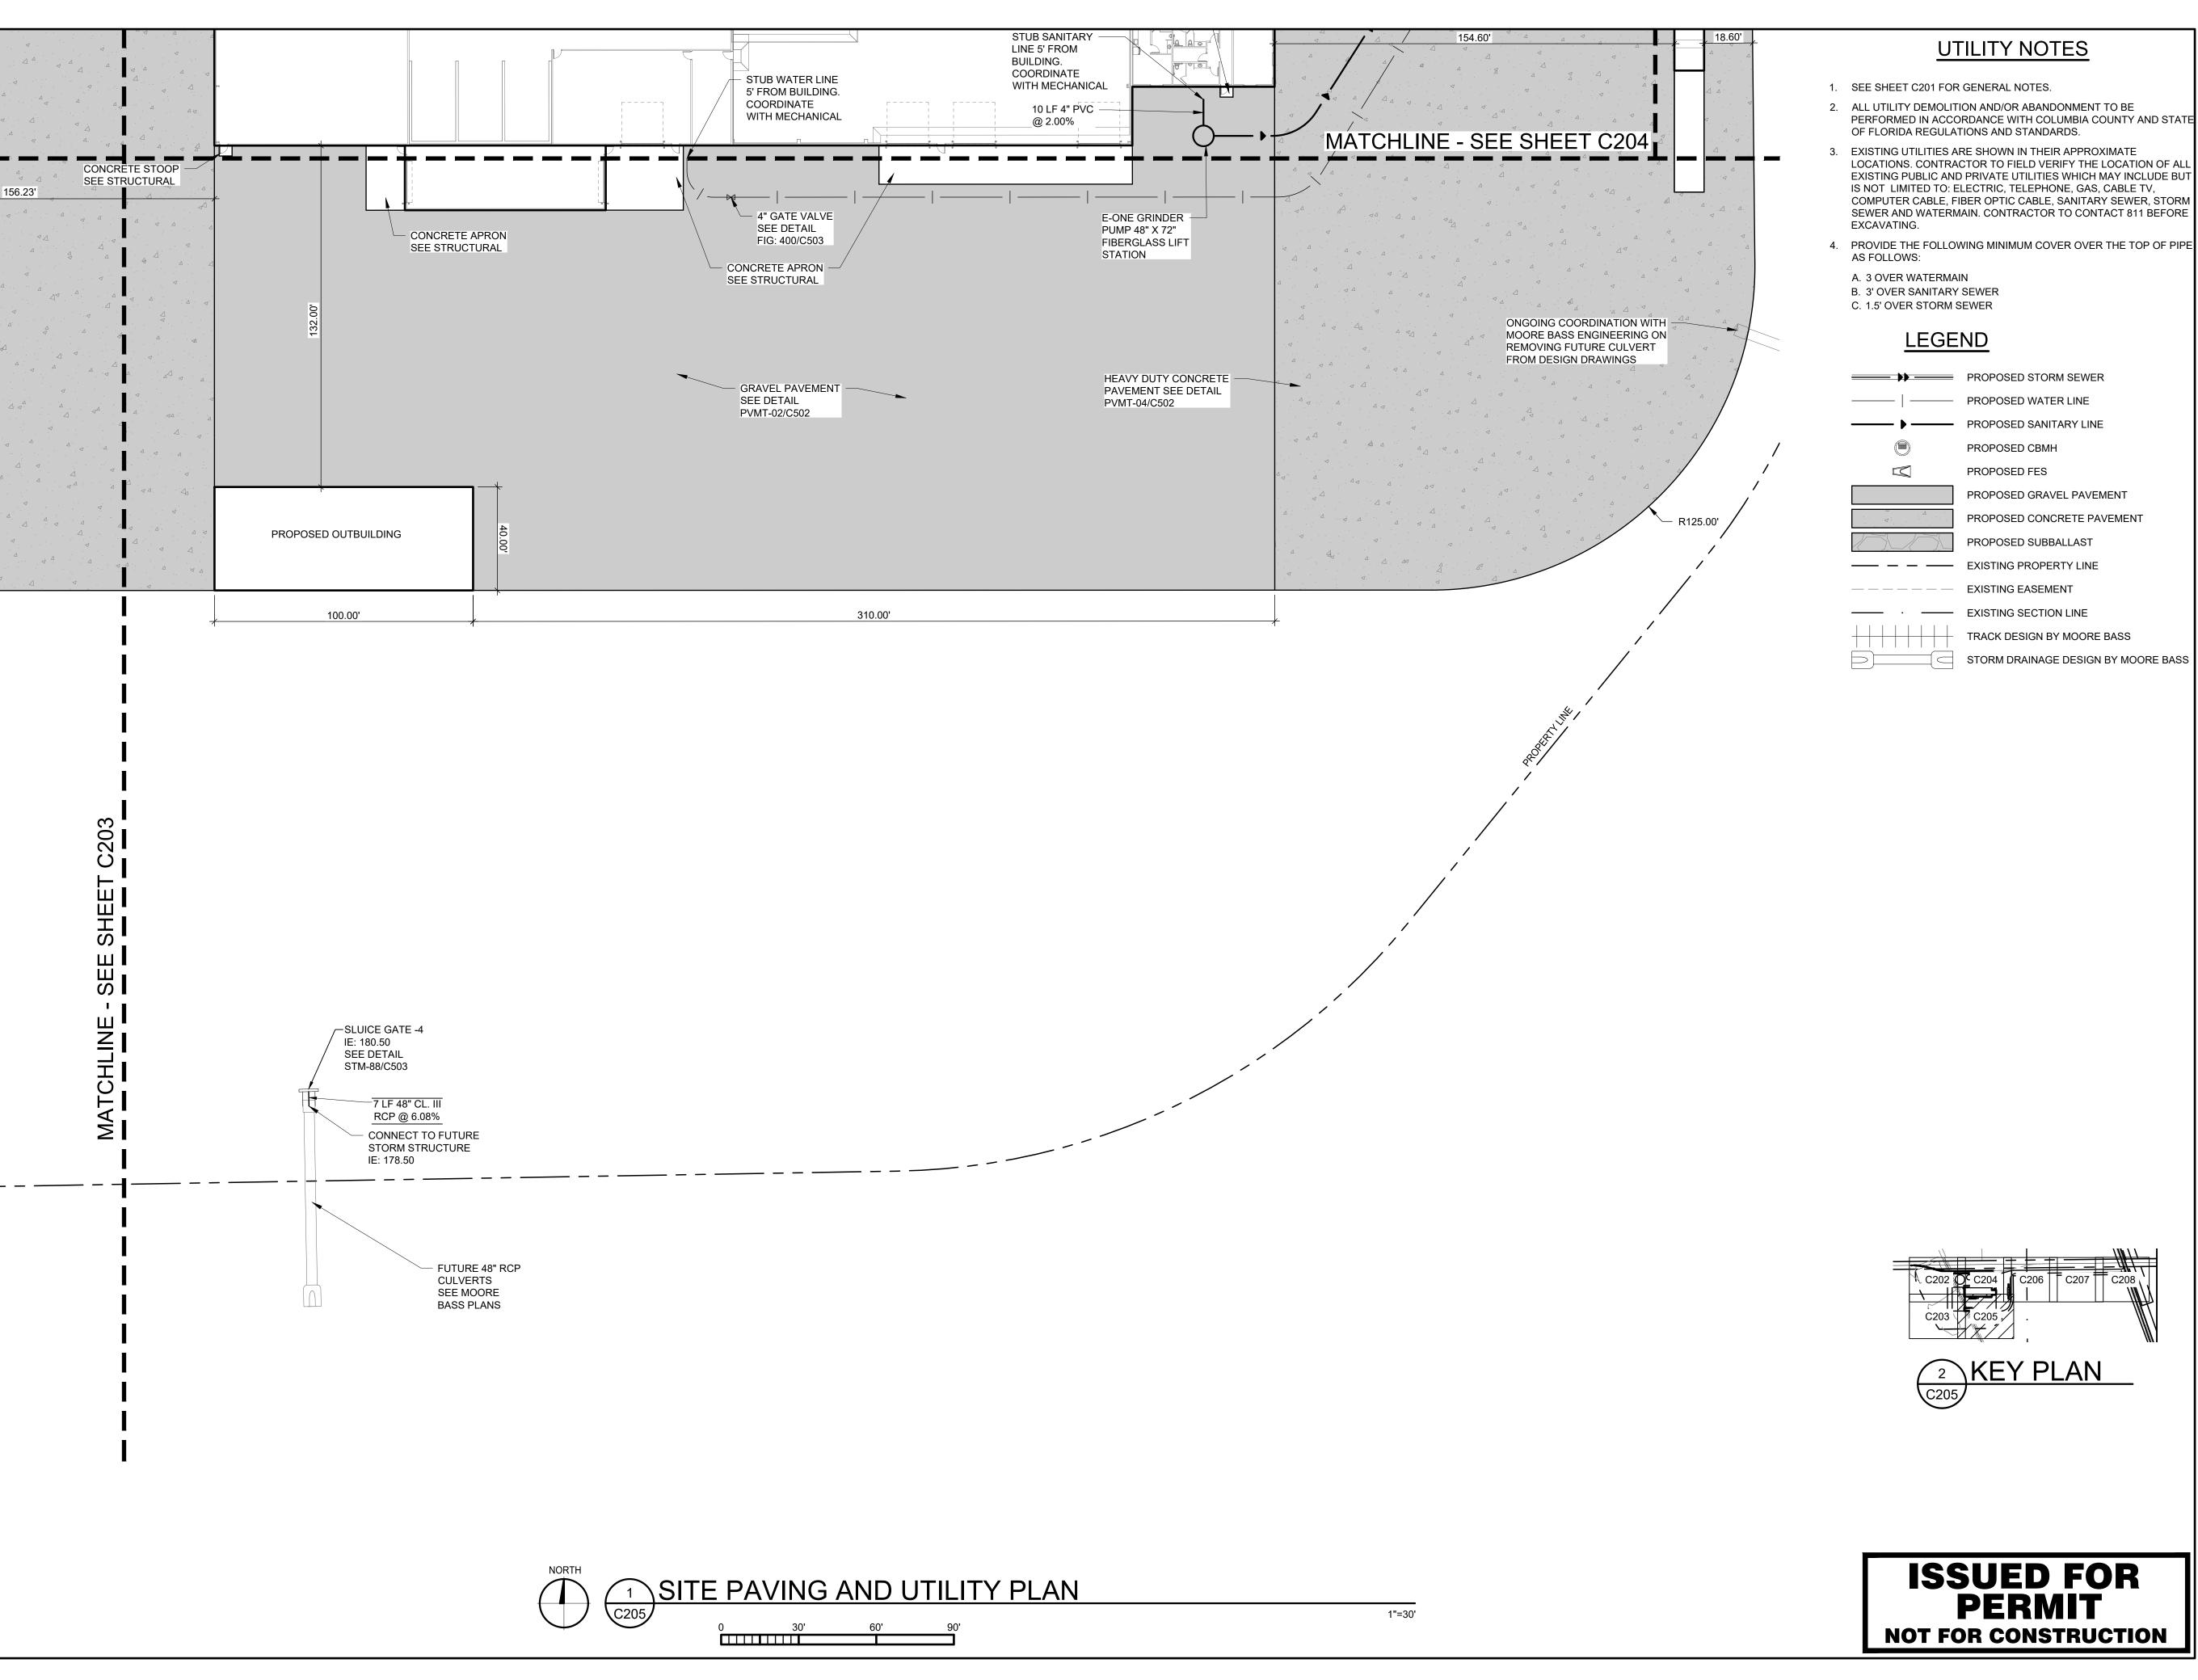
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	DATE: 10/19/2023	DRAWN: RCQ		
	DESIGNED: AJR	CHECKE ARL	ED:	APPROVED: MDM

DRAWING TITLE:

SITE PAVING AND UTILITY PLAN

PROJECT NO:	DRAWING NO:
230384	C204
SCALE:	C204
AS NOTED	



763.559.9100 2300 Berkshire Lane N, Suite 200 www.vaaeng.com

Plymouth, MN 55441 Project # 230384



PROJECT:

NEW LIQUID FERTILIZER FACILITY LAKE CITY, FL

NO	DATE	ISSUE/REVISION	BY			
Α	10/19/2023	DESIGN DEVELOPMENT	RCQ			
В	12/11/2023	ISSUED FOR PERMIT	RCQ			
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CERT	CERTIFICATION:					

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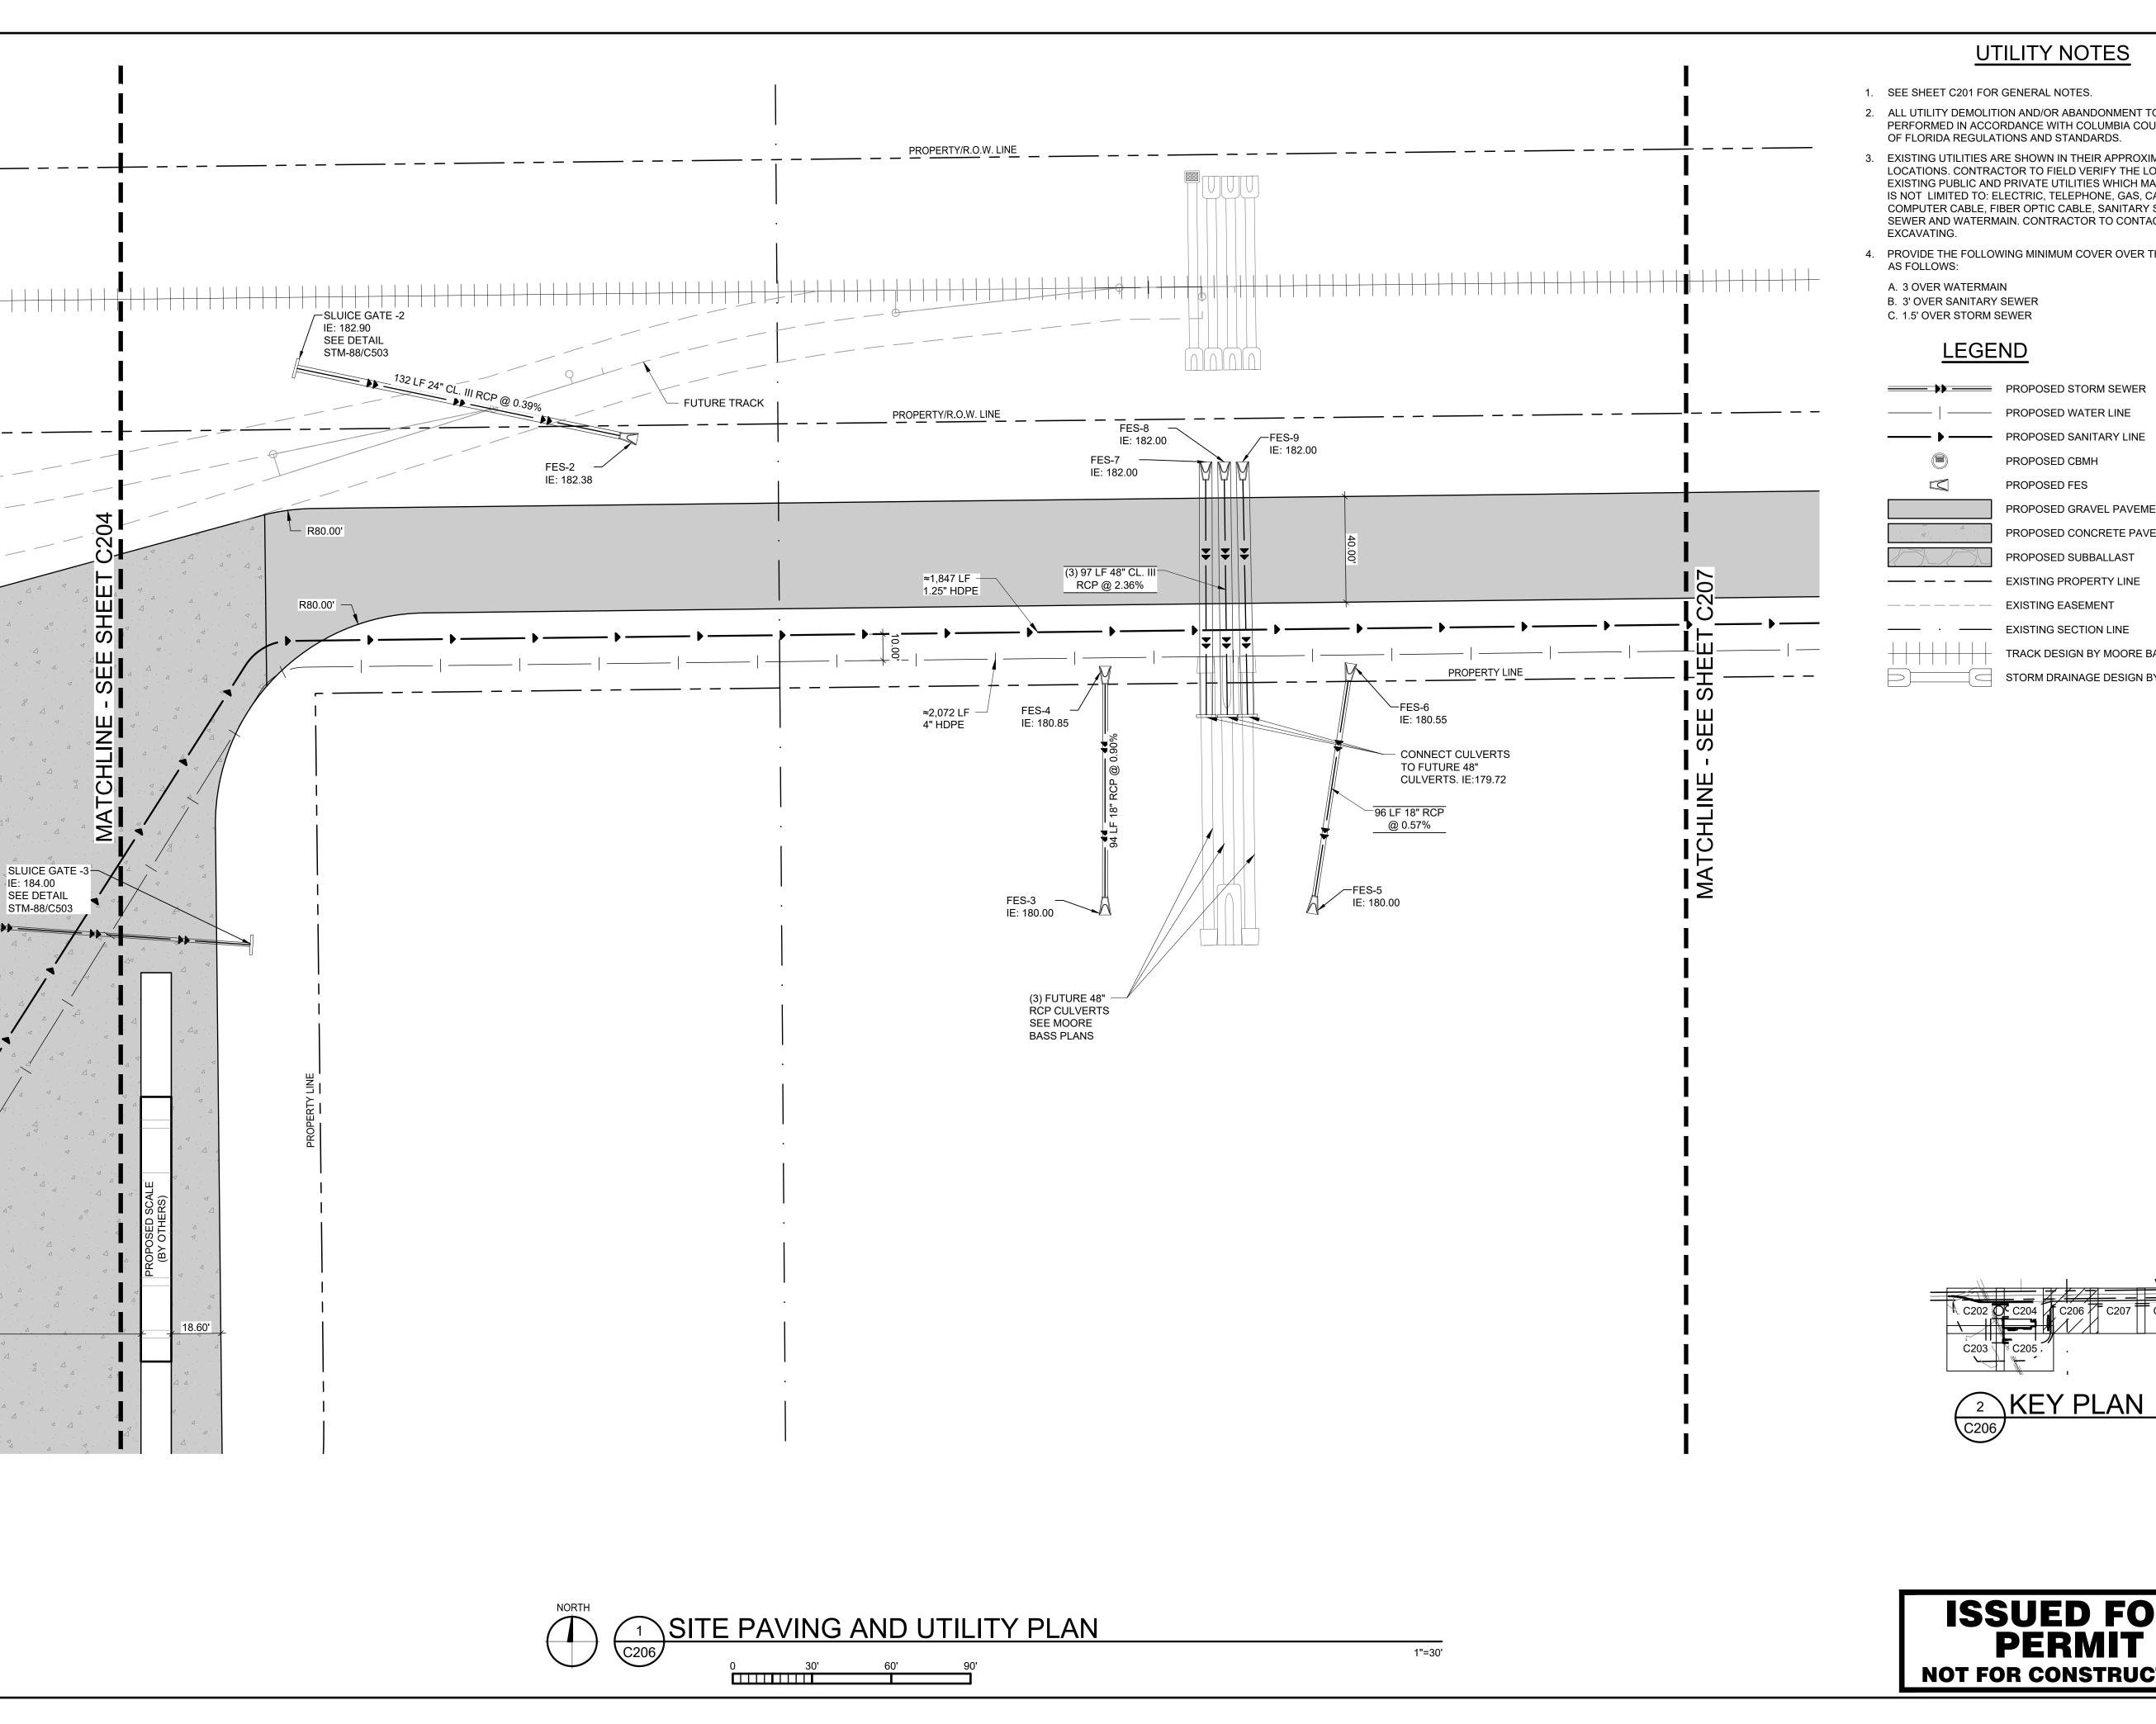
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DATE: 10/19/2023	DRAWN: RCQ		
DESIGNED: AJR	CHECKE ARL	ED:	APPROVED: MDM

DRAWING TITLE:


SITE PAVING AND UTILITY PLAN

PROJECT NO:	DRAWING NO:
230384	COOF
SCALE:	C205
AS NOTED	




- 1. SEE SHEET C201 FOR GENERAL NOTES.
- 2. ALL UTILITY DEMOLITION AND/OR ABANDONMENT TO BE PERFORMED IN ACCORDANCE WITH COLUMBIA COUNTY AND STA OF FLORIDA REGULATIONS AND STANDARDS.
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- 4. PROVIDE THE FOLLOWING MINIMUM COVER OVER THE TOP OF PIPE
- A. 3 OVER WATERMAIN B. 3' OVER SANITARY SEWER

LEGEND

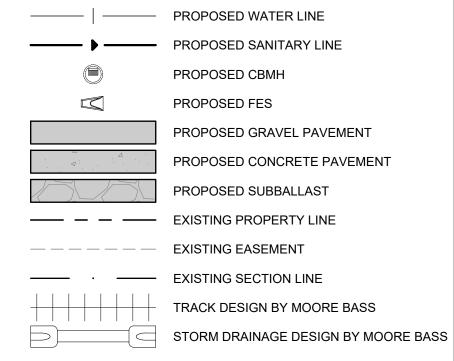



763.559.9100 2300 Berkshire Lane N, Suite 200 www.vaaeng.com Plymouth, MN 55441 Project # 230384

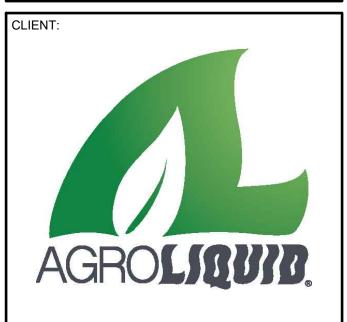

PROJECT:

NEW LIQUID FERTILIZER FACILITY LAKE CITY, FL

NO	DATE	ISSUE/REVISION	BY
Α	10/19/2023	DESIGN DEVELOPMENT	RCQ
В	12/11/2023	ISSUED FOR PERMIT	RCQ

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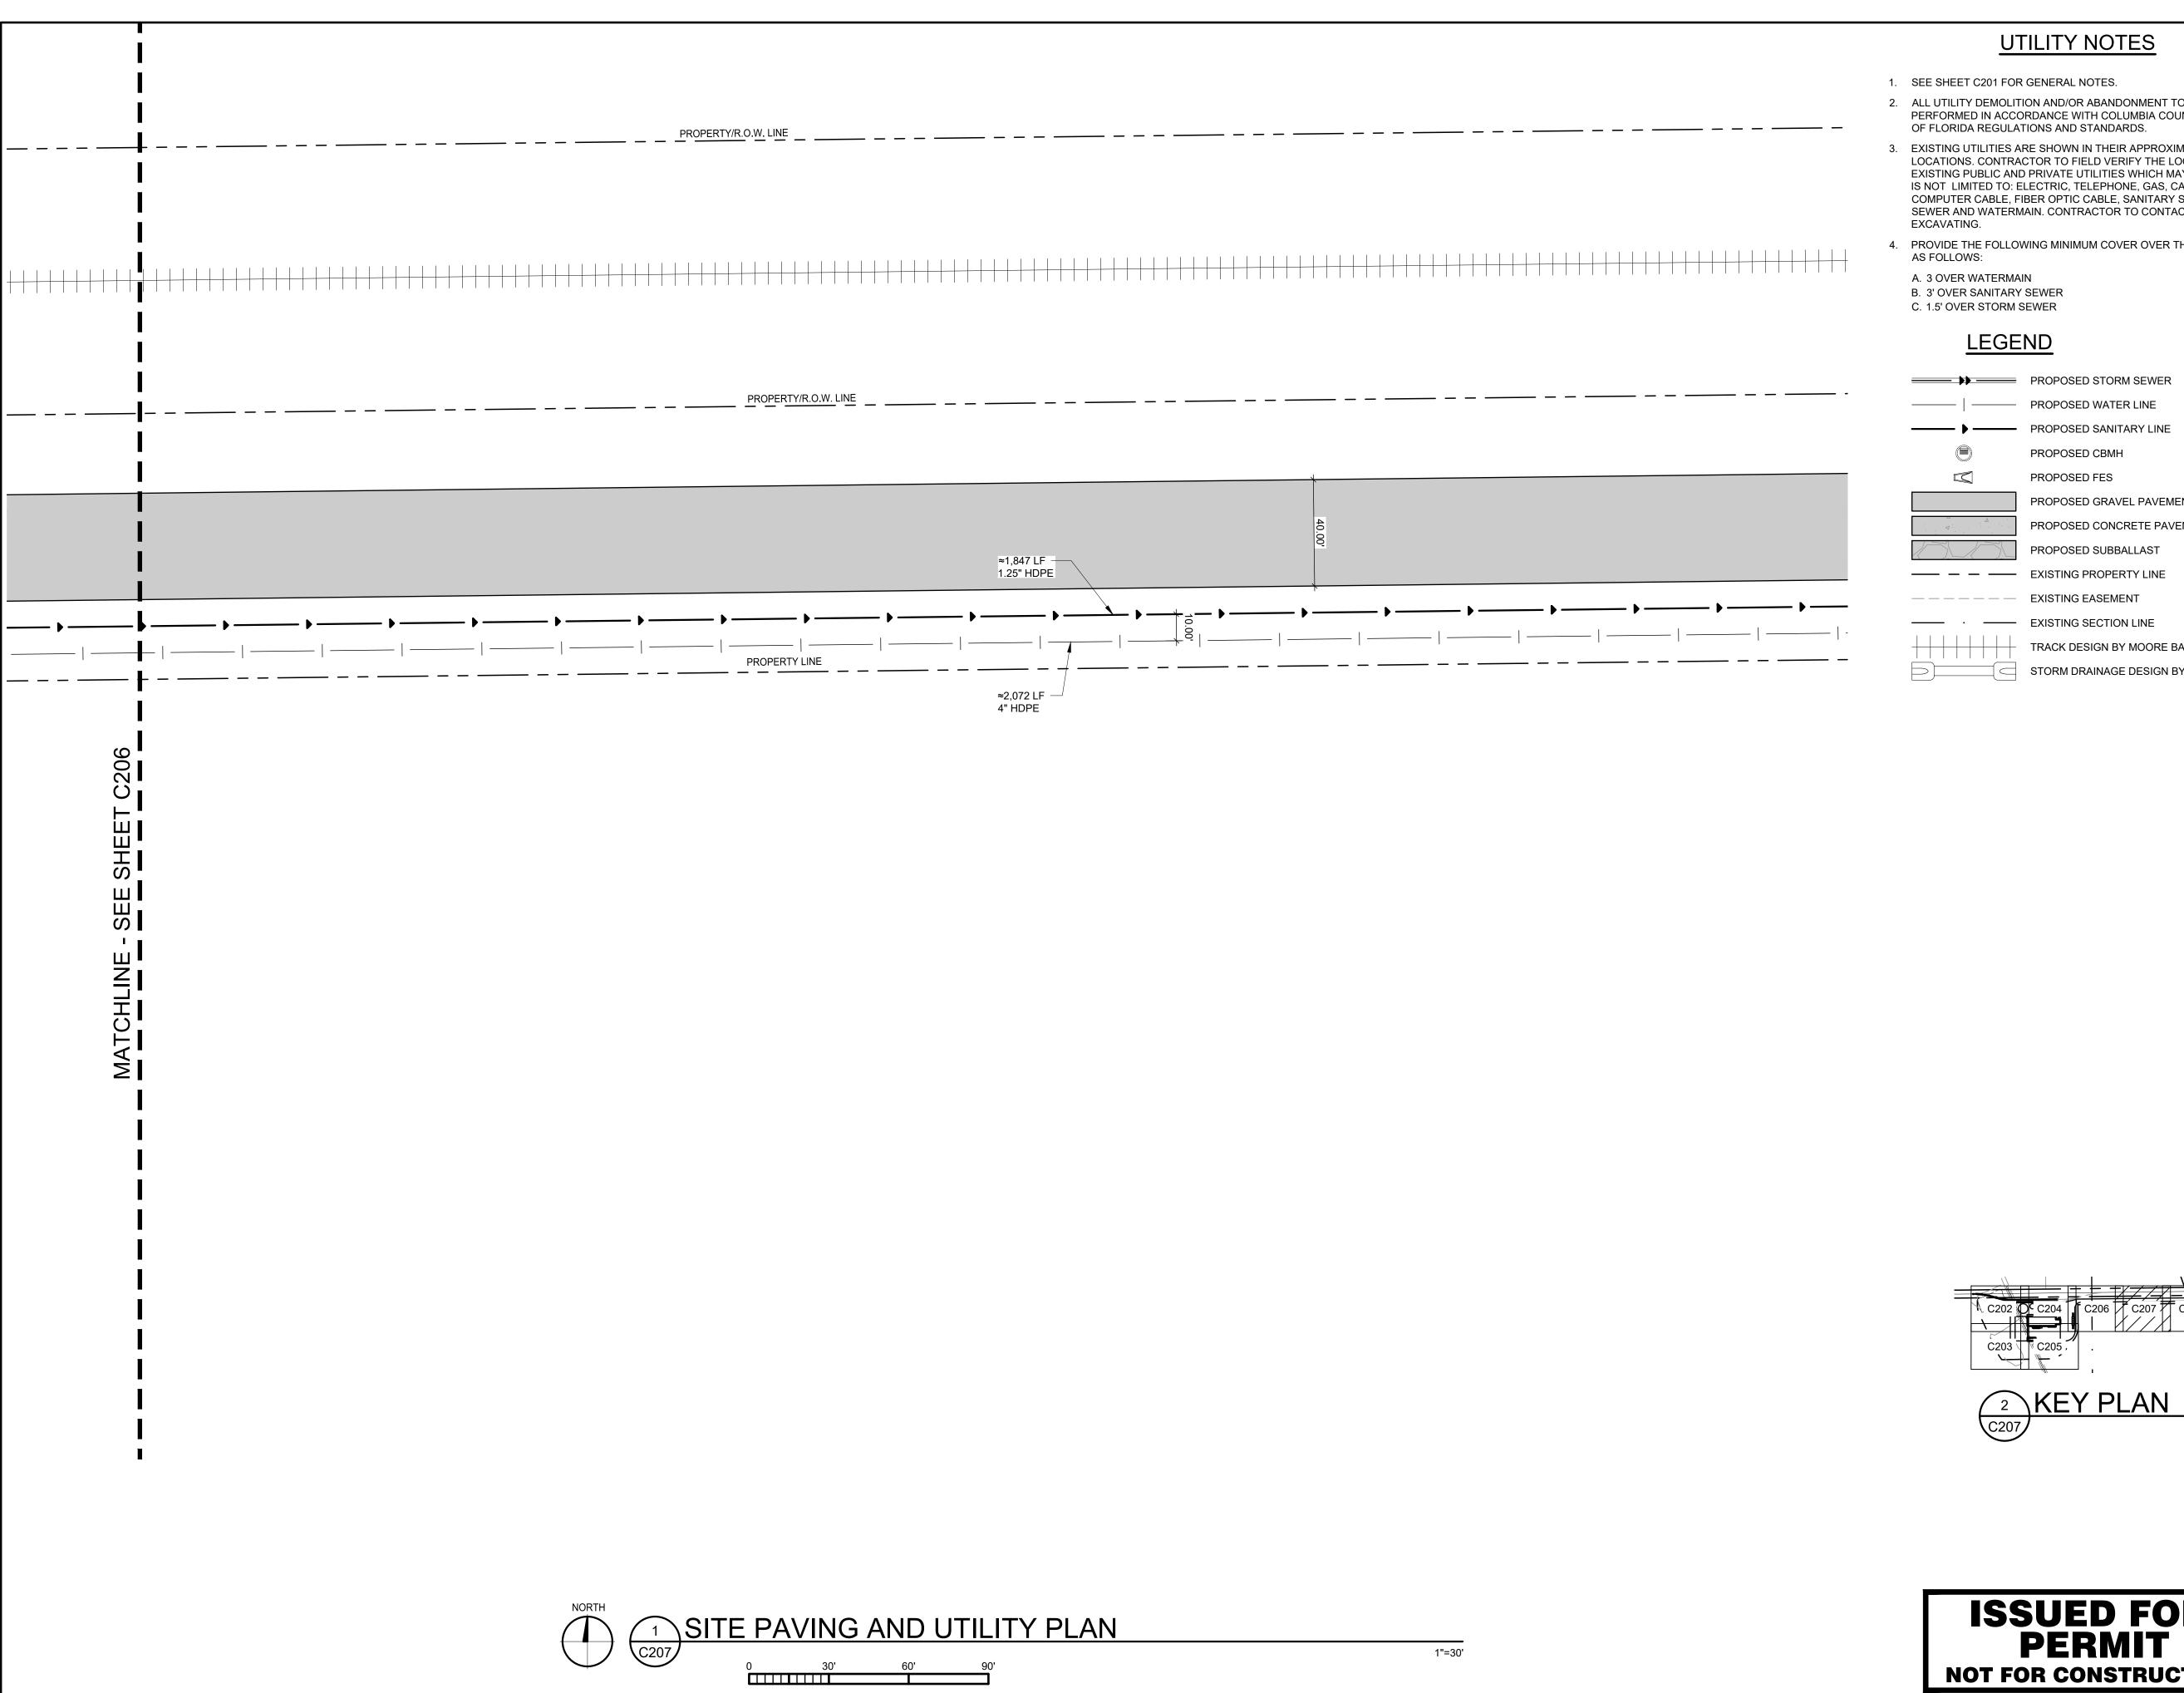
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DATE: 10/19/2023	DRAWN: RCQ	
DESIGNED:	CHECKED:	APPROVED:
AJR	ARL	MDM

DRAWING TITLE:


SITE PAVING AND UTILITY PLAN

П	PROJECT NO:	DRAWING NO:
	230384	C206
	SCALE:	C206
П	AS NOTED	



- 1. SEE SHEET C201 FOR GENERAL NOTES.
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- 4. PROVIDE THE FOLLOWING MINIMUM COVER OVER THE TOP OF PIPE
- A. 3 OVER WATERMAIN B. 3' OVER SANITARY SEWER C. 1.5' OVER STORM SEWER

LEGEND

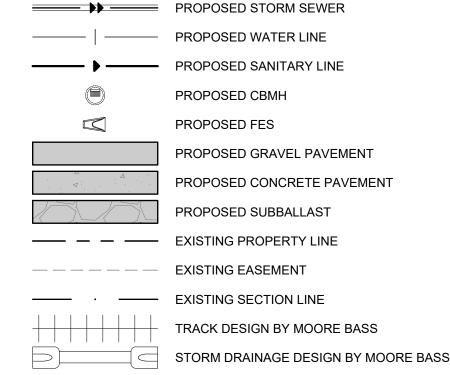



763.559.9100 2300 Berkshire Lane N, Suite 200 www.vaaeng.com Plymouth, MN 55441 Project # 230384



NEW LIQUID FERTILIZER FACILITY LAKE CITY, FL

PROJECT:

NO	DATE	ISSUE/REVISION	BY
Α	10/19/2023	DESIGN DEVELOPMENT	RCQ
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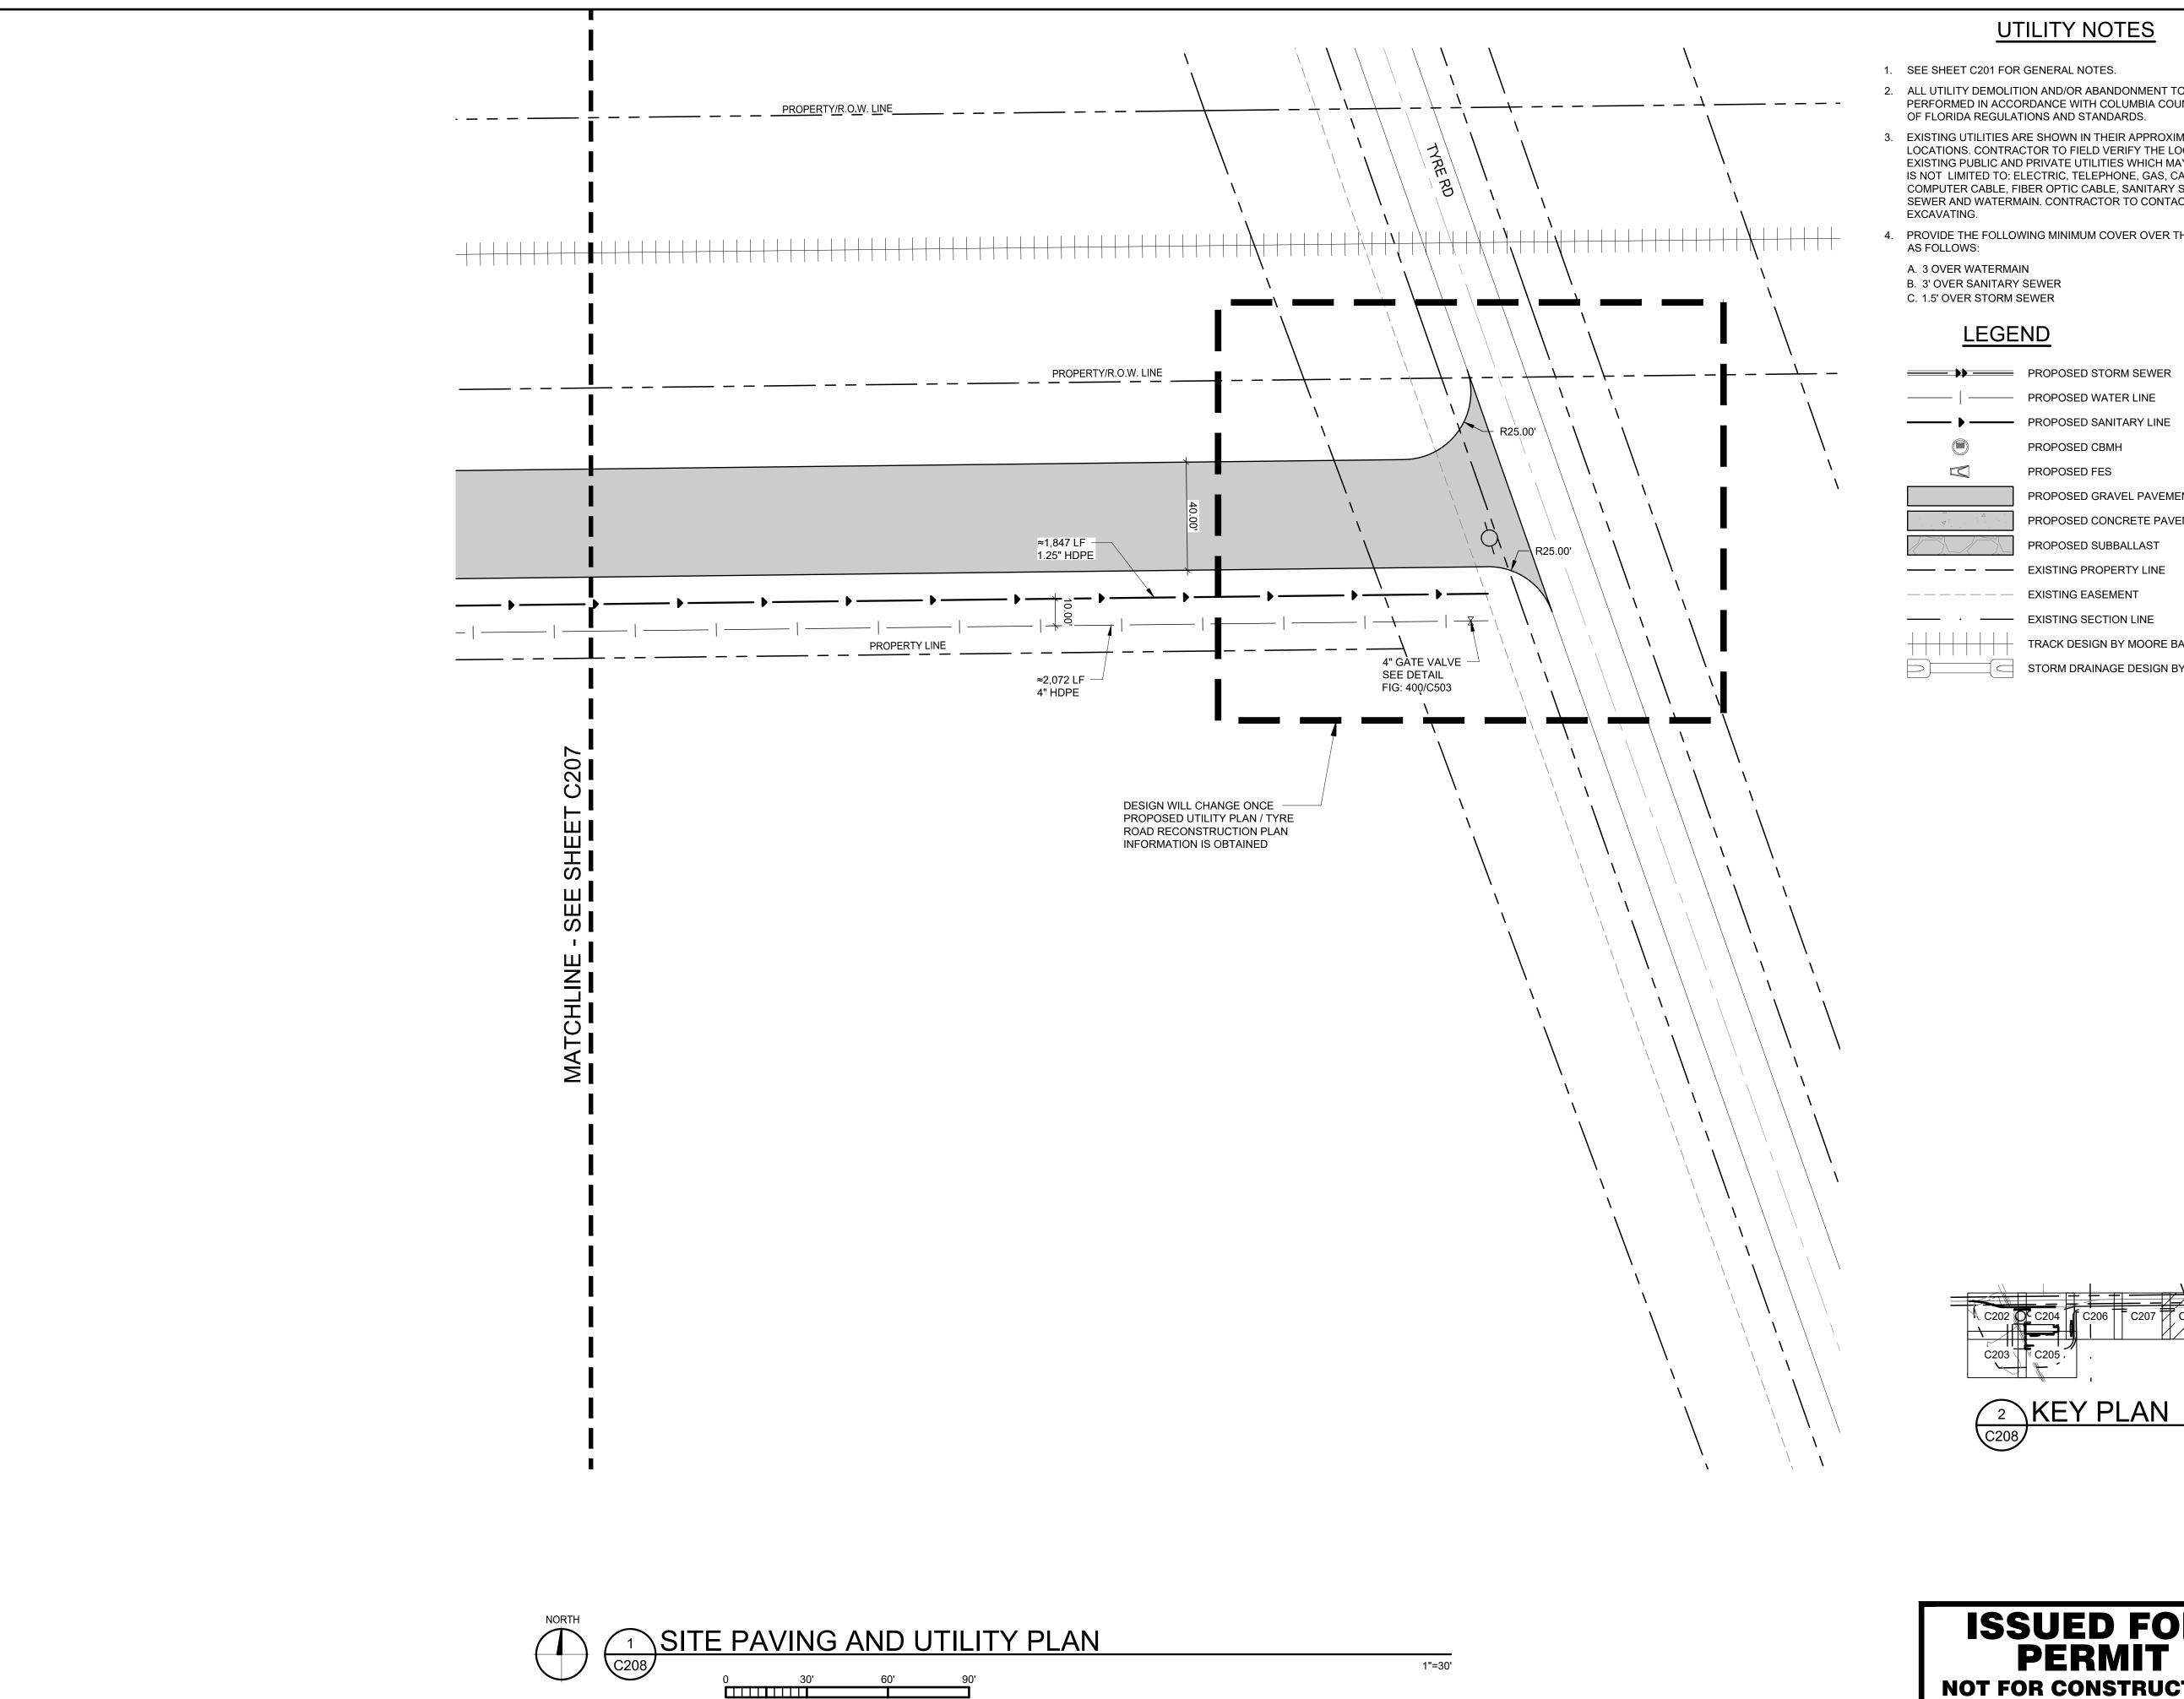
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	DATE: 10/19/2023		DRAWN: RCQ	
	DESIGNED: AJR	CHECKE ARL	ED:	APPROVED: MDM

DRAWING TITLE:


SITE PAVING AND UTILITY PLAN

ROJECT NO:	DRAWING NO:	
230384	C207	
CALE:	C207	
AS NOTED		



- 1. SEE SHEET C201 FOR GENERAL NOTES.
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- 3. EXISTING UTILITIES ARE SHOWN IN THEIR APPROXIMATE LOCATIONS. CONTRACTOR TO FIELD VERIFY THE LOCATION OF AL
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- 4. PROVIDE THE FOLLOWING MINIMUM COVER OVER THE TOP OF PIPE
- A. 3 OVER WATERMAIN B. 3' OVER SANITARY SEWER

LEGEND

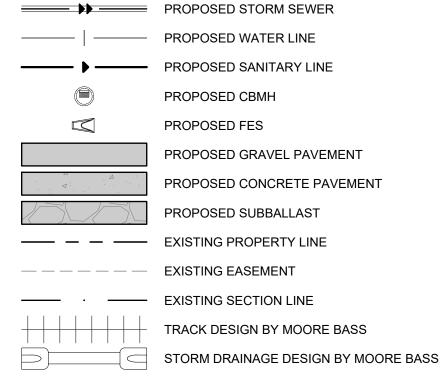



2300 Berkshire Lane N, Suite 200

Plymouth, MN 55441

763.559.9100 www.vaaeng.com Project # 230384



PROJECT:

NEW LIQUID FERTILIZER FACILITY LAKE CITY, FL

NO	DATE	ISSUE/REVISION	B,
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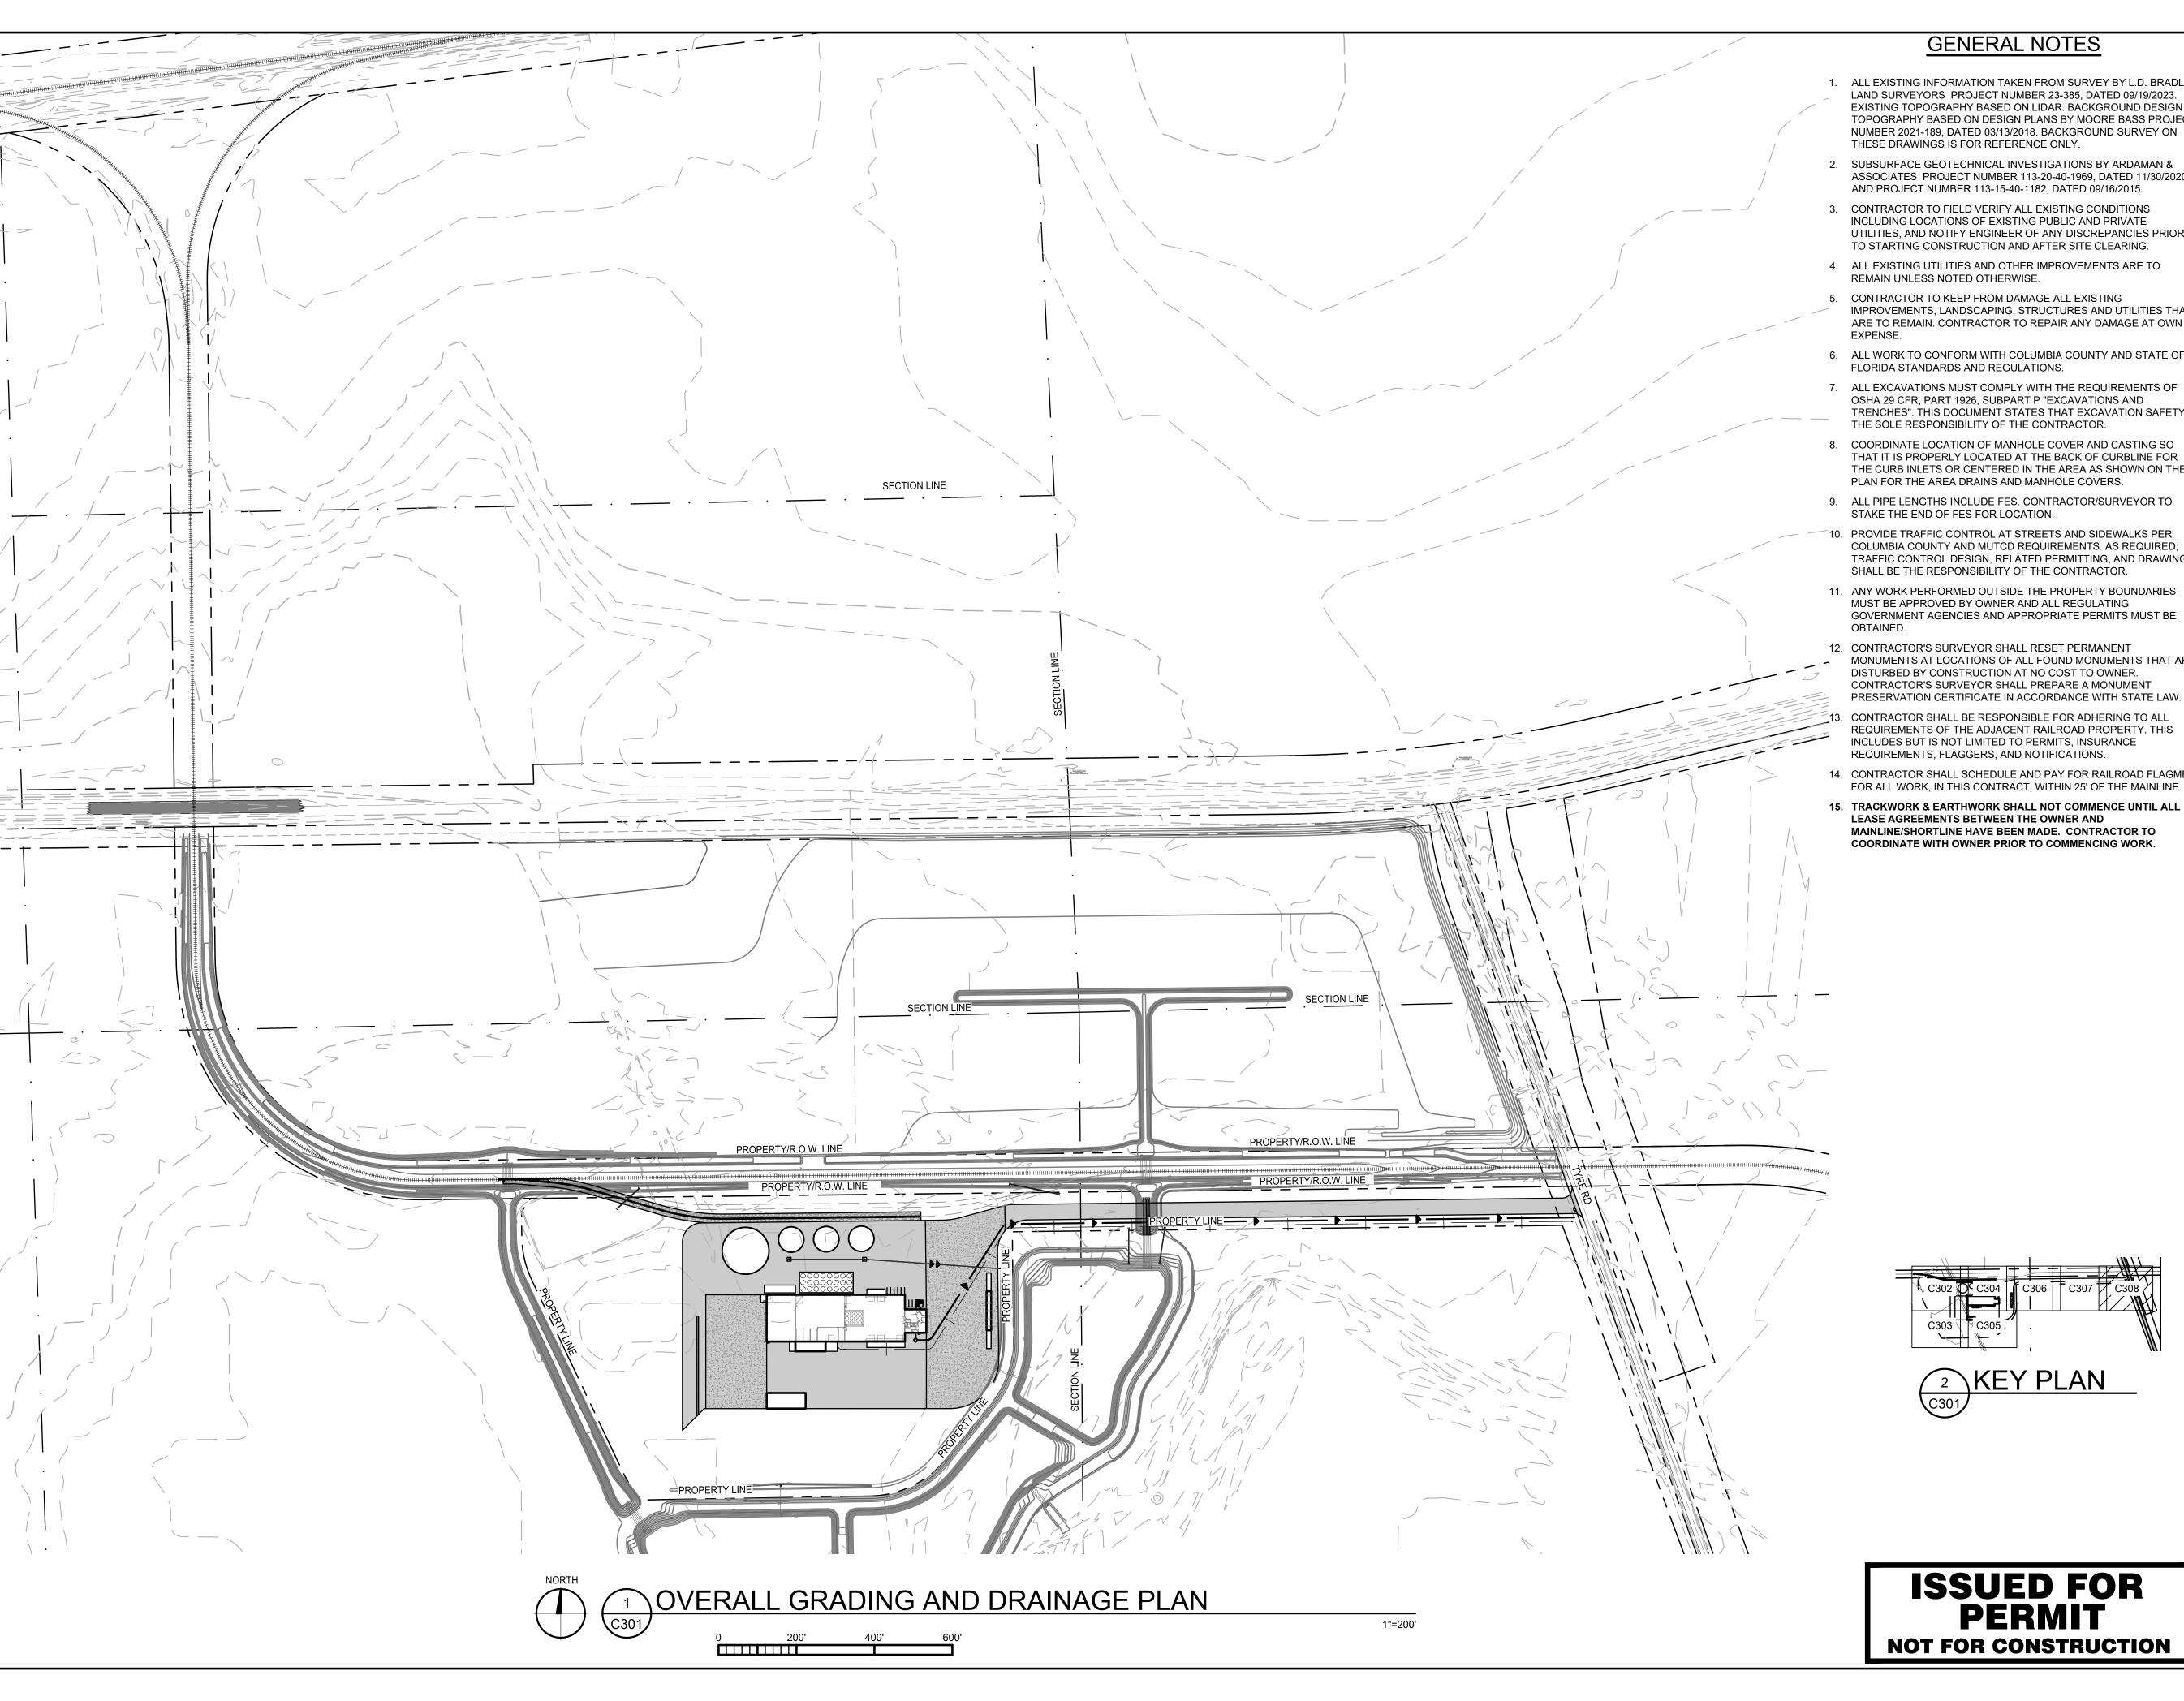
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DATE: 10/19/2023	DRAWN RCC	•
DESIGNED:	CHECKED:	APPROVED:
AJR	ARL	MDM

DRAWING TITLE:

SITE PAVING AND UTILITY PLAN

PROJECT NO:	DRAWING NO:
230384	C200
SCALE:	C208
AS NOTED	



GENERAL NOTES

- 1. ALL EXISTING INFORMATION TAKEN FROM SURVEY BY L.D. BRADLEY LAND SURVEYORS PROJECT NUMBER 23-385, DATED 09/19/2023. EXISTING TOPOGRAPHY BASED ON LIDAR. BACKGROUND DESIGN TOPOGRAPHY BASED ON DESIGN PLANS BY MOORE BASS PROJECT NUMBER 2021-189, DATED 03/13/2018. BACKGROUND SURVEY ON THESE DRAWINGS IS FOR REFERENCE ONLY.
- 2. SUBSURFACE GEOTECHNICAL INVESTIGATIONS BY ARDAMAN & ASSOCIATES PROJECT NUMBER 113-20-40-1969, DATED 11/30/2020, AND PROJECT NUMBER 113-15-40-1182, DATED 09/16/2015.
- 3. CONTRACTOR TO FIELD VERIFY ALL EXISTING CONDITIONS INCLUDING LOCATIONS OF EXISTING PUBLIC AND PRIVATE UTILITIES, AND NOTIFY ENGINEER OF ANY DISCREPANCIES PRIOR TO STARTING CONSTRUCTION AND AFTER SITE CLEARING.
- 4. ALL EXISTING UTILITIES AND OTHER IMPROVEMENTS ARE TO REMAIN UNLESS NOTED OTHERWISE.
- 5. CONTRACTOR TO KEEP FROM DAMAGE ALL EXISTING IMPROVEMENTS, LANDSCAPING, STRUCTURES AND UTILITIES THAT ARE TO REMAIN. CONTRACTOR TO REPAIR ANY DAMAGE AT OWN
- 6. ALL WORK TO CONFORM WITH COLUMBIA COUNTY AND STATE OF FLORIDA STANDARDS AND REGULATIONS.
- 7. ALL EXCAVATIONS MUST COMPLY WITH THE REQUIREMENTS OF OSHA 29 CFR, PART 1926, SUBPART P "EXCAVATIONS AND TRENCHES". THIS DOCUMENT STATES THAT EXCAVATION SAFETY IS THE SOLE RESPONSIBILITY OF THE CONTRACTOR.
- THE CURB INLETS OR CENTERED IN THE AREA AS SHOWN ON THE PLAN FOR THE AREA DRAINS AND MANHOLE COVERS.
- 9. ALL PIPE LENGTHS INCLUDE FES. CONTRACTOR/SURVEYOR TO STAKE THE END OF FES FOR LOCATION.
- 10. PROVIDE TRAFFIC CONTROL AT STREETS AND SIDEWALKS PER COLUMBIA COUNTY AND MUTCD REQUIREMENTS. AS REQUIRED; TRAFFIC CONTROL DESIGN, RELATED PERMITTING, AND DRAWINGS SHALL BE THE RESPONSIBILITY OF THE CONTRACTOR.
- 11. ANY WORK PERFORMED OUTSIDE THE PROPERTY BOUNDARIES MUST BE APPROVED BY OWNER AND ALL REGULATING GOVERNMENT AGENCIES AND APPROPRIATE PERMITS MUST BE
- 12. CONTRACTOR'S SURVEYOR SHALL RESET PERMANENT MONUMENTS AT LOCATIONS OF ALL FOUND MONUMENTS THAT ARE DISTURBED BY CONSTRUCTION AT NO COST TO OWNER. CONTRACTOR'S SURVEYOR SHALL PREPARE A MONUMENT PRESERVATION CERTIFICATE IN ACCORDANCE WITH STATE LAW.
- CONTRACTOR SHALL BE RESPONSIBLE FOR ADHERING TO ALL REQUIREMENTS OF THE ADJACENT RAILROAD PROPERTY. THIS INCLUDES BUT IS NOT LIMITED TO PERMITS, INSURANCE REQUIREMENTS, FLAGGERS, AND NOTIFICATIONS.
- 14. CONTRACTOR SHALL SCHEDULE AND PAY FOR RAILROAD FLAGMEN FOR ALL WORK, IN THIS CONTRACT, WITHIN 25' OF THE MAINLINE.
- 15. TRACKWORK & EARTHWORK SHALL NOT COMMENCE UNTIL ALL LEASE AGREEMENTS BETWEEN THE OWNER AND MAINLINE/SHORTLINE HAVE BEEN MADE. CONTRACTOR TO COORDINATE WITH OWNER PRIOR TO COMMENCING WORK.

PERMIT



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Project # 230384

2300 Berkshire Lane N, Suite 200 Plymouth, MN 55441

AGROLIQUID.

PROJECT:

NEW LIQUID FERTILIZER FACILITY LAKE CITY, FL

_			
NO	DATE	ISSUE/REVISION	BY
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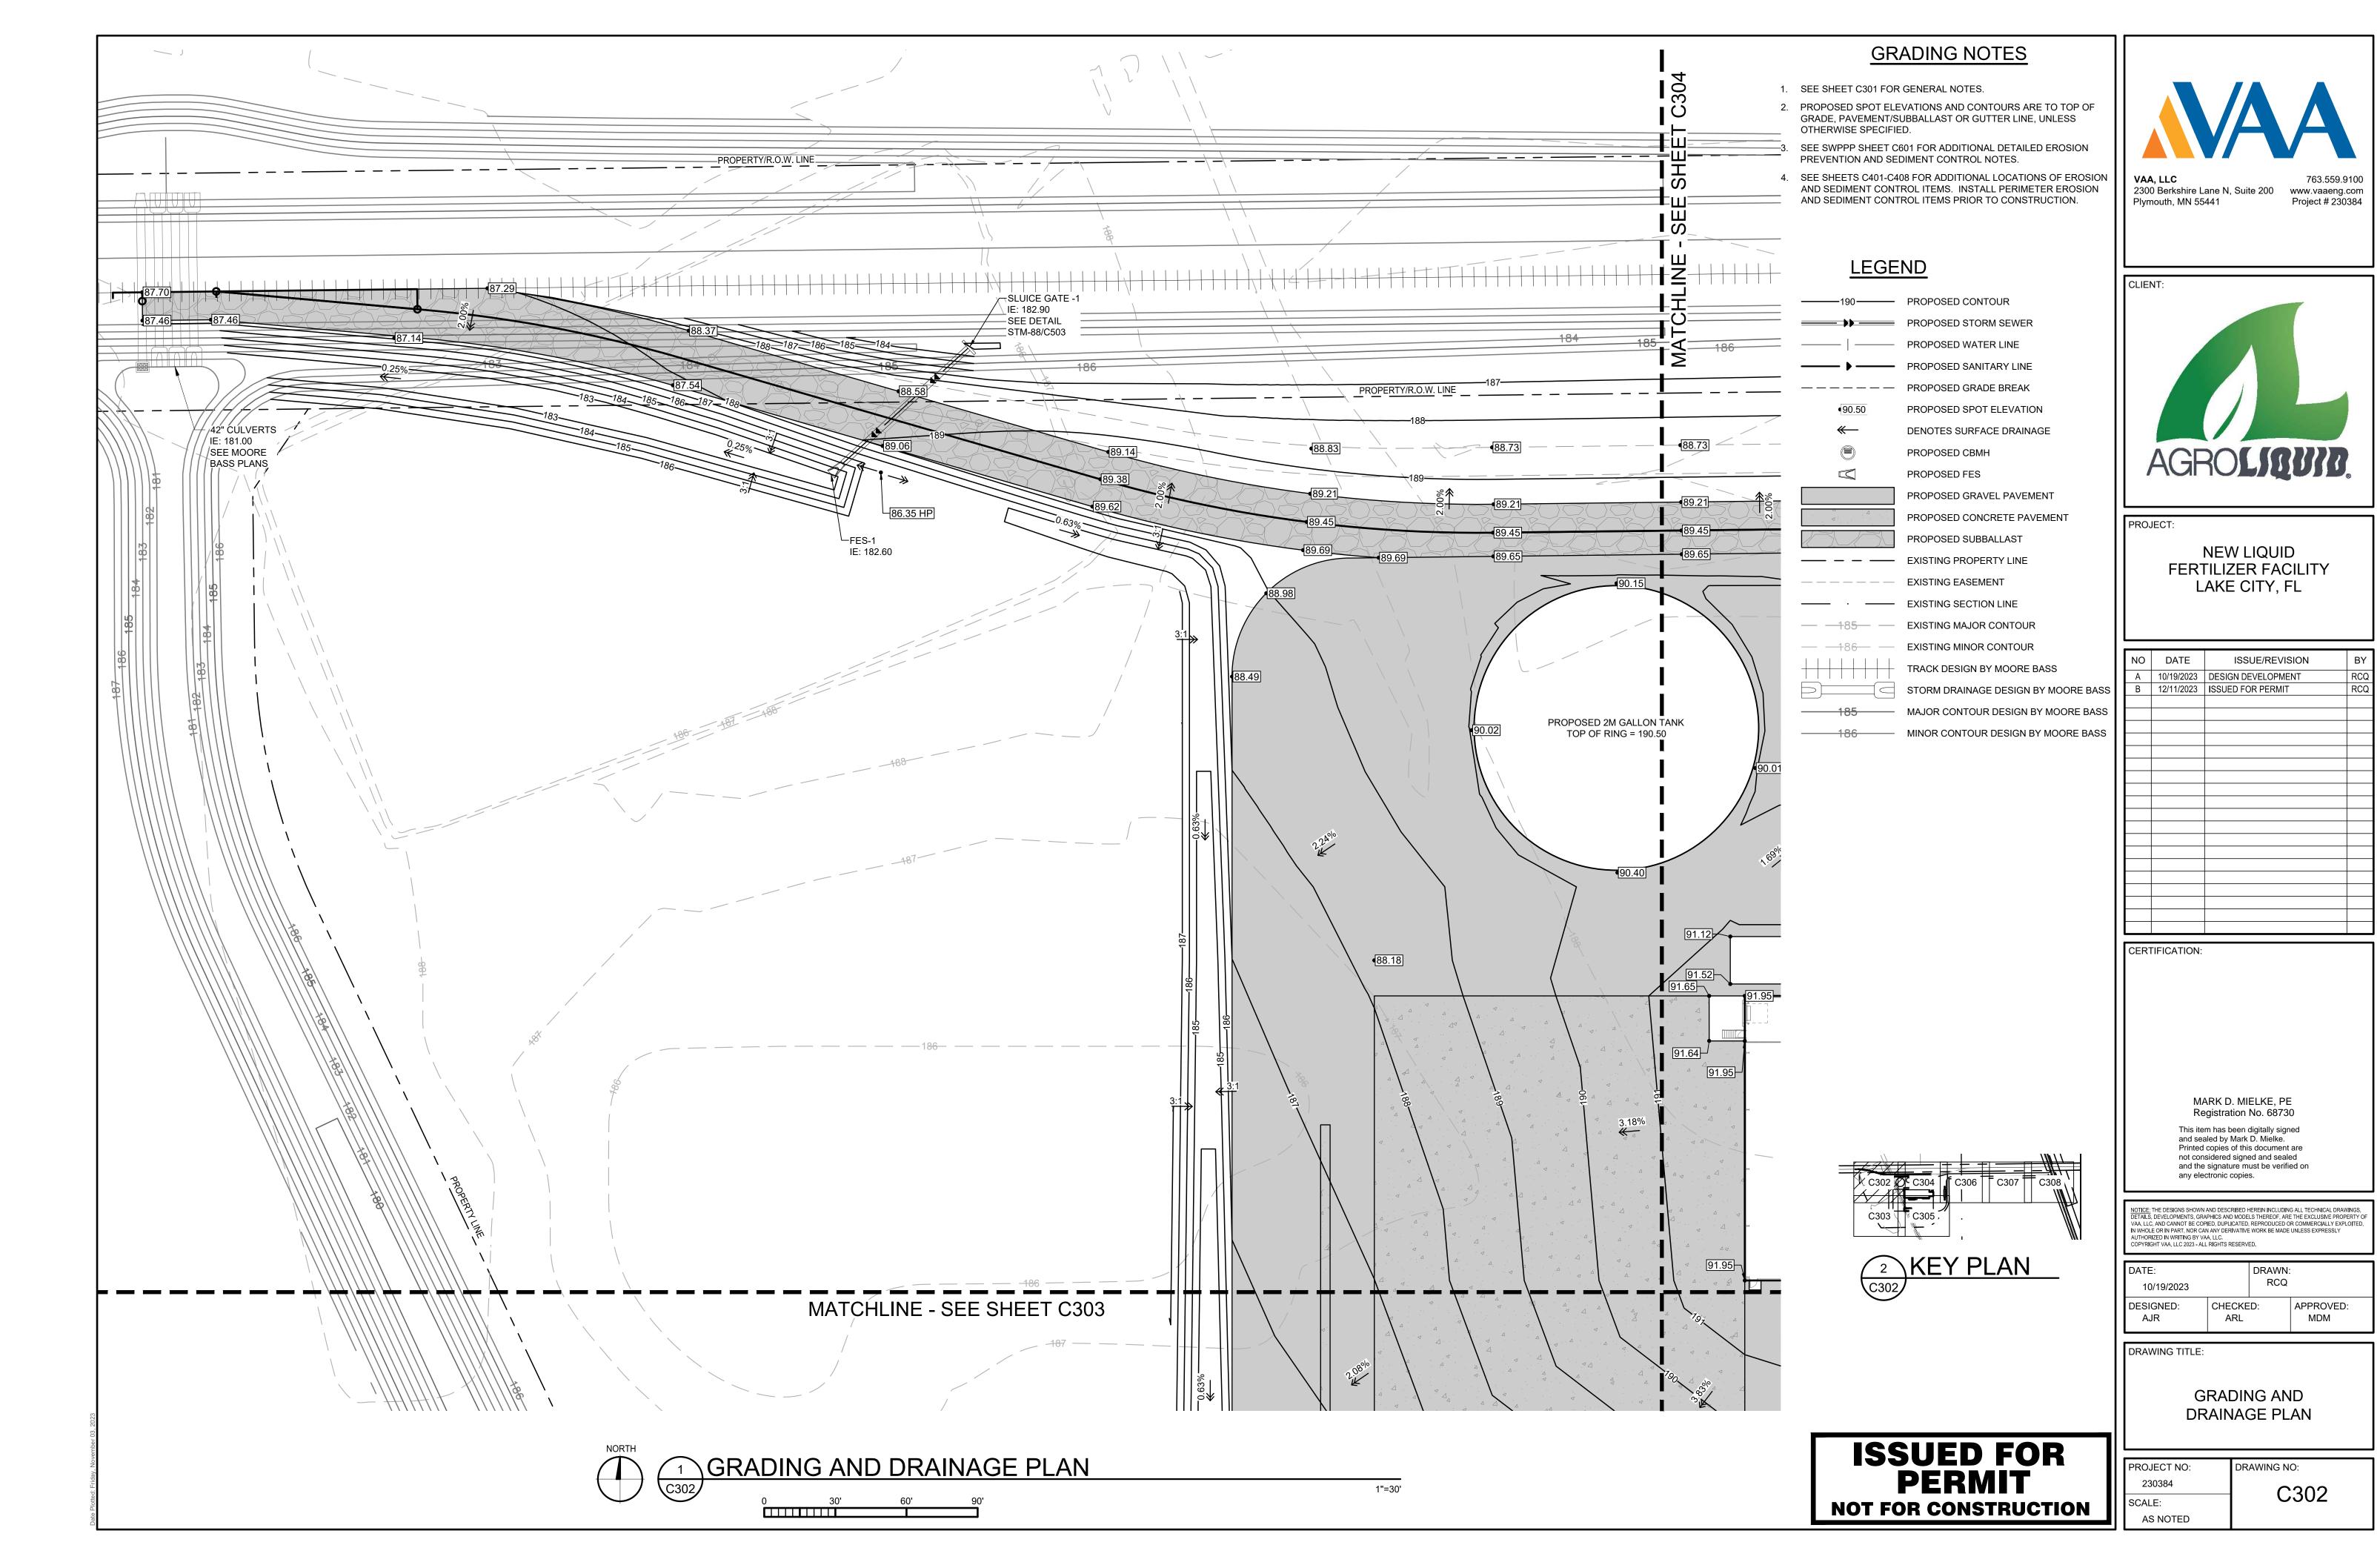
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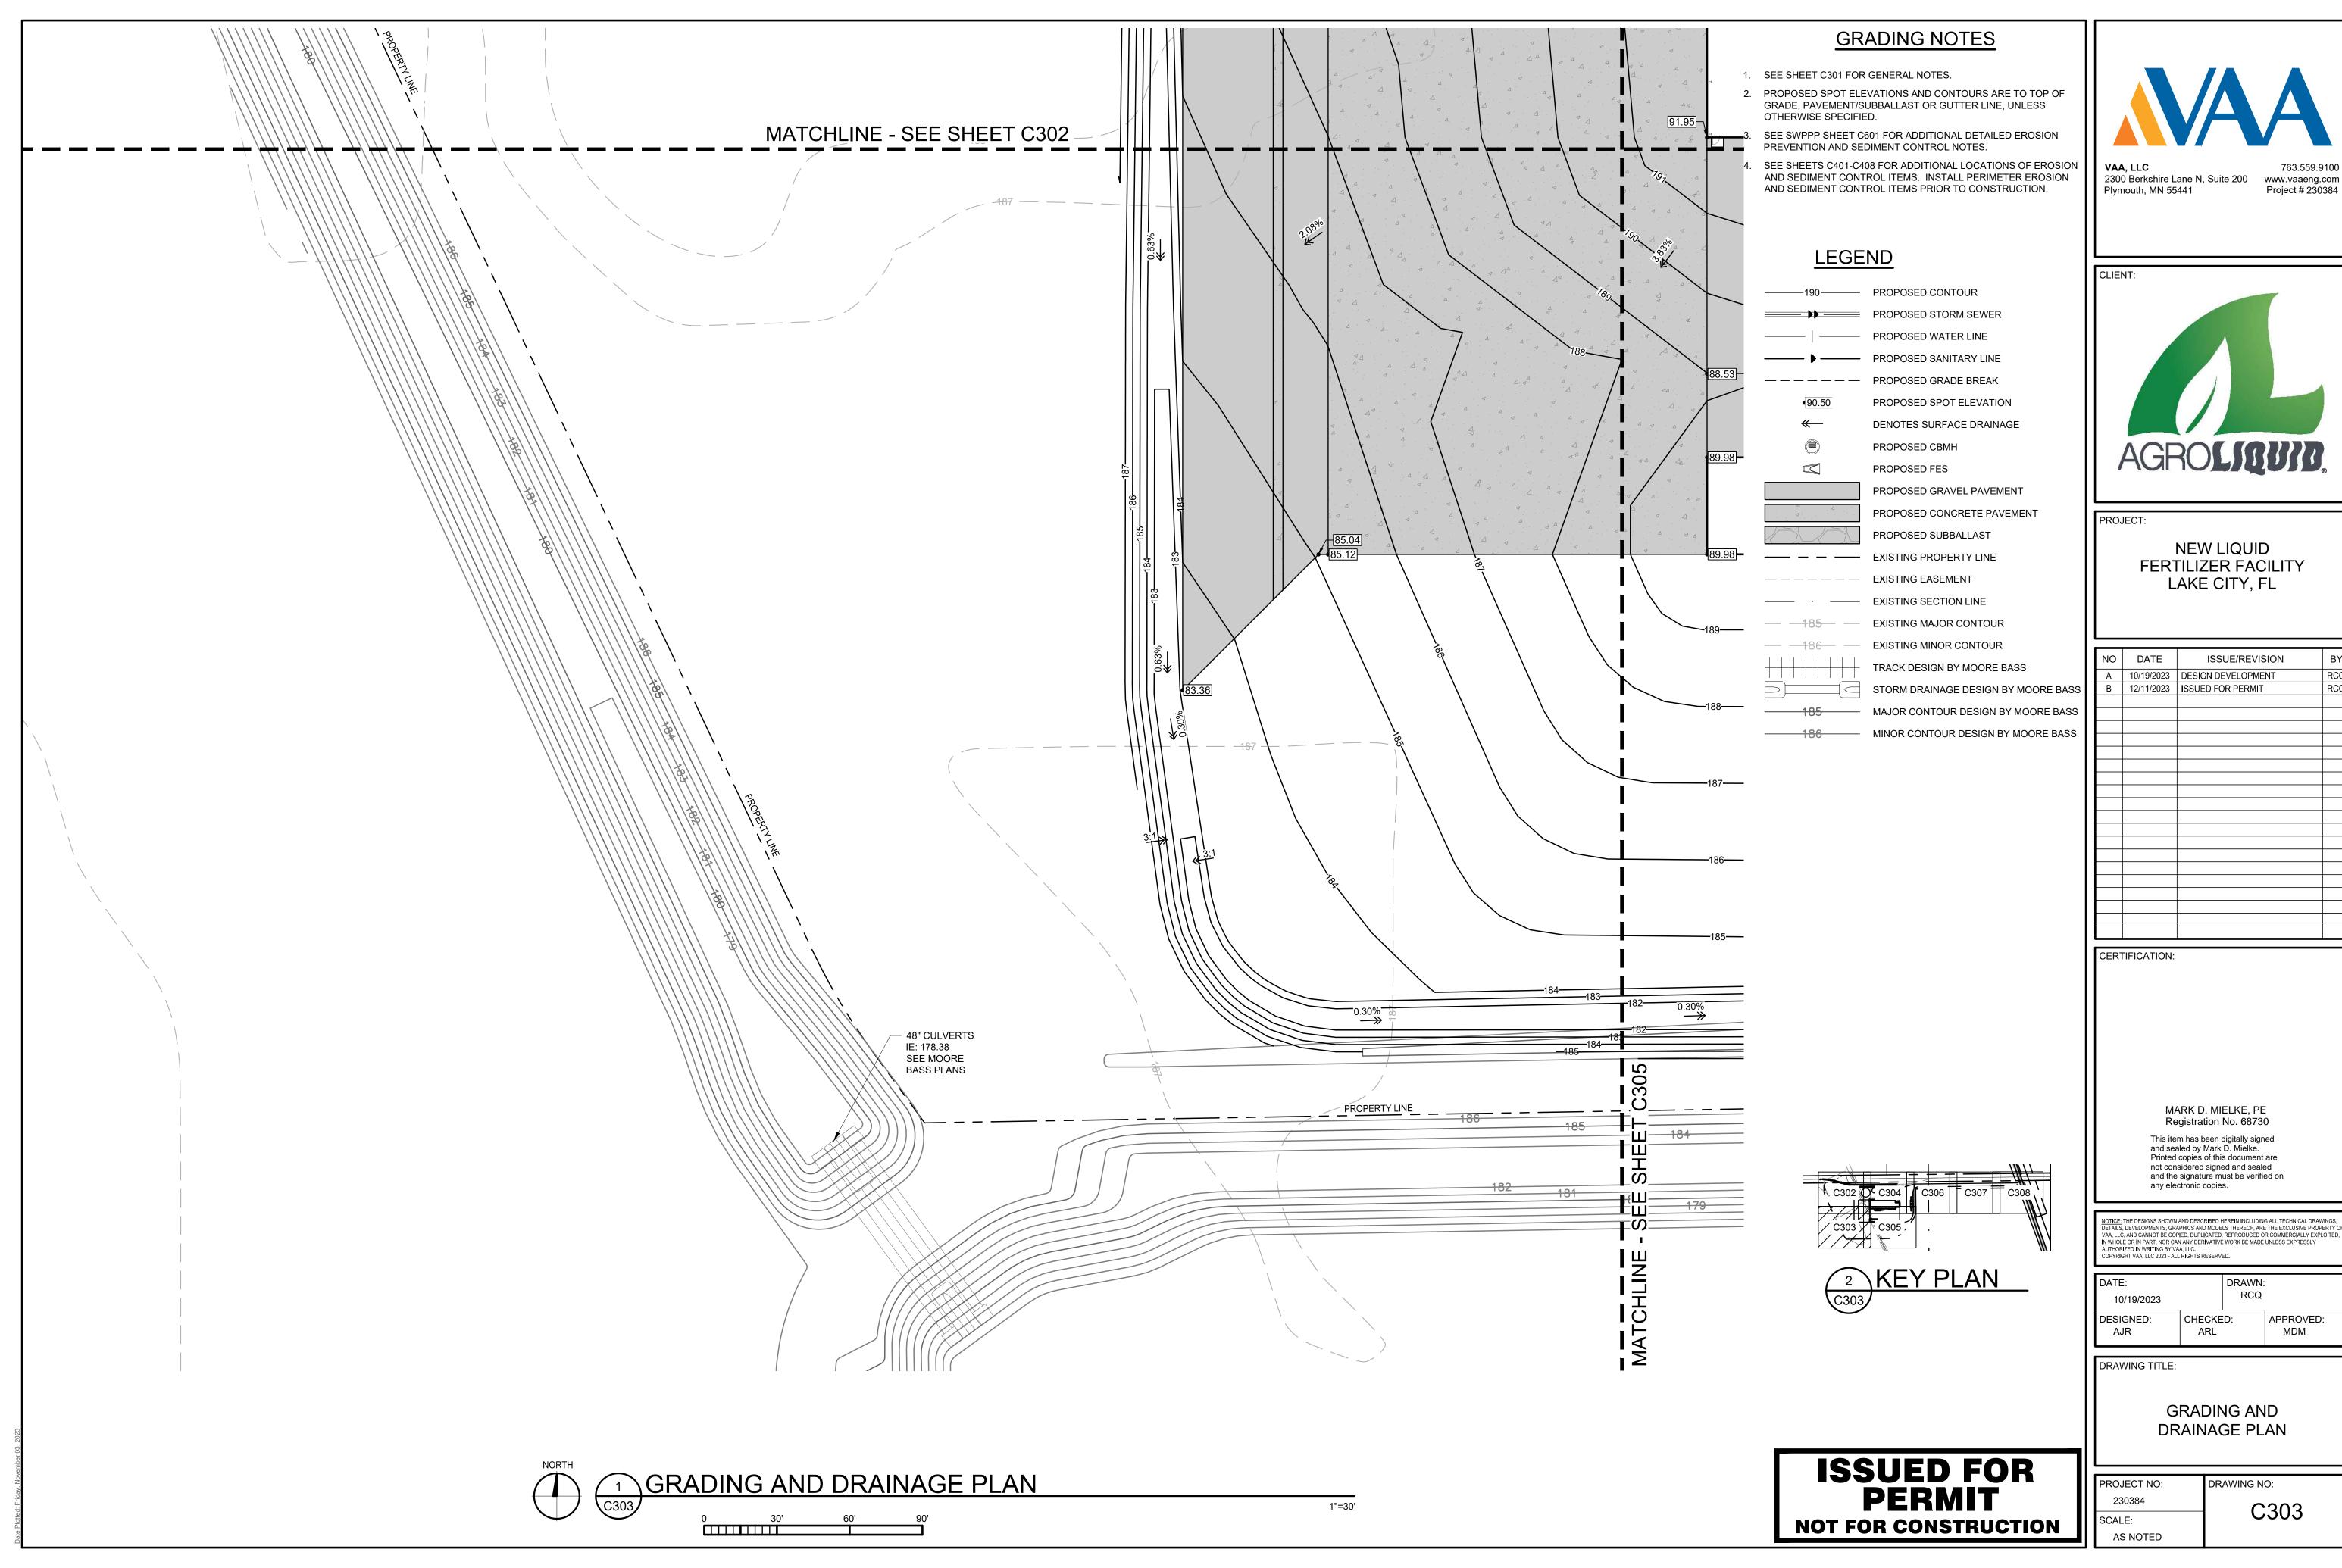
l				
	DATE:		DRAWN:	
	10/19/2023		RCQ	
	DESIGNED:	CHECKE	D:	APPROV
	AJR	ARL		MDM

DRAWING TITLE:

OVERALL GRADING AND DRAINAGE PLAN

PROJECT NO: DRAWING NO: 230384 C301 SCALE: AS NOTED






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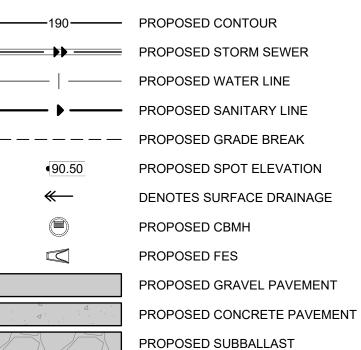
NO	DATE	ISSUE/REVISION	BY
Α	10/19/2023	DESIGN DEVELOPMENT	RCQ
В	12/11/2023	ISSUED FOR PERMIT	RCQ


١	DATE:	DRAWN:		
	10/19/2023		RCQ	
	DESIGNED: AJR	CHECKE ARL	:D:	APPROVED: MDM




- 1. SEE SHEET C301 FOR GENERAL NOTES.
- 2. PROPOSED SPOT ELEVATIONS AND CONTOURS ARE TO TOP OF GRADE, PAVEMENT/SUBBALLAST OR GUTTER LINE, UNLESS
- SEE SWPPP SHEET C601 FOR ADDITIONAL DETAILED EROSION PREVENTION AND SEDIMENT CONTROL NOTES.
- 4. SEE SHEETS C401-C408 FOR ADDITIONAL LOCATIONS OF EROSION AND SEDIMENT CONTROL ITEMS. INSTALL PERIMETER EROSION AND SEDIMENT CONTROL ITEMS PRIOR TO CONSTRUCTION.

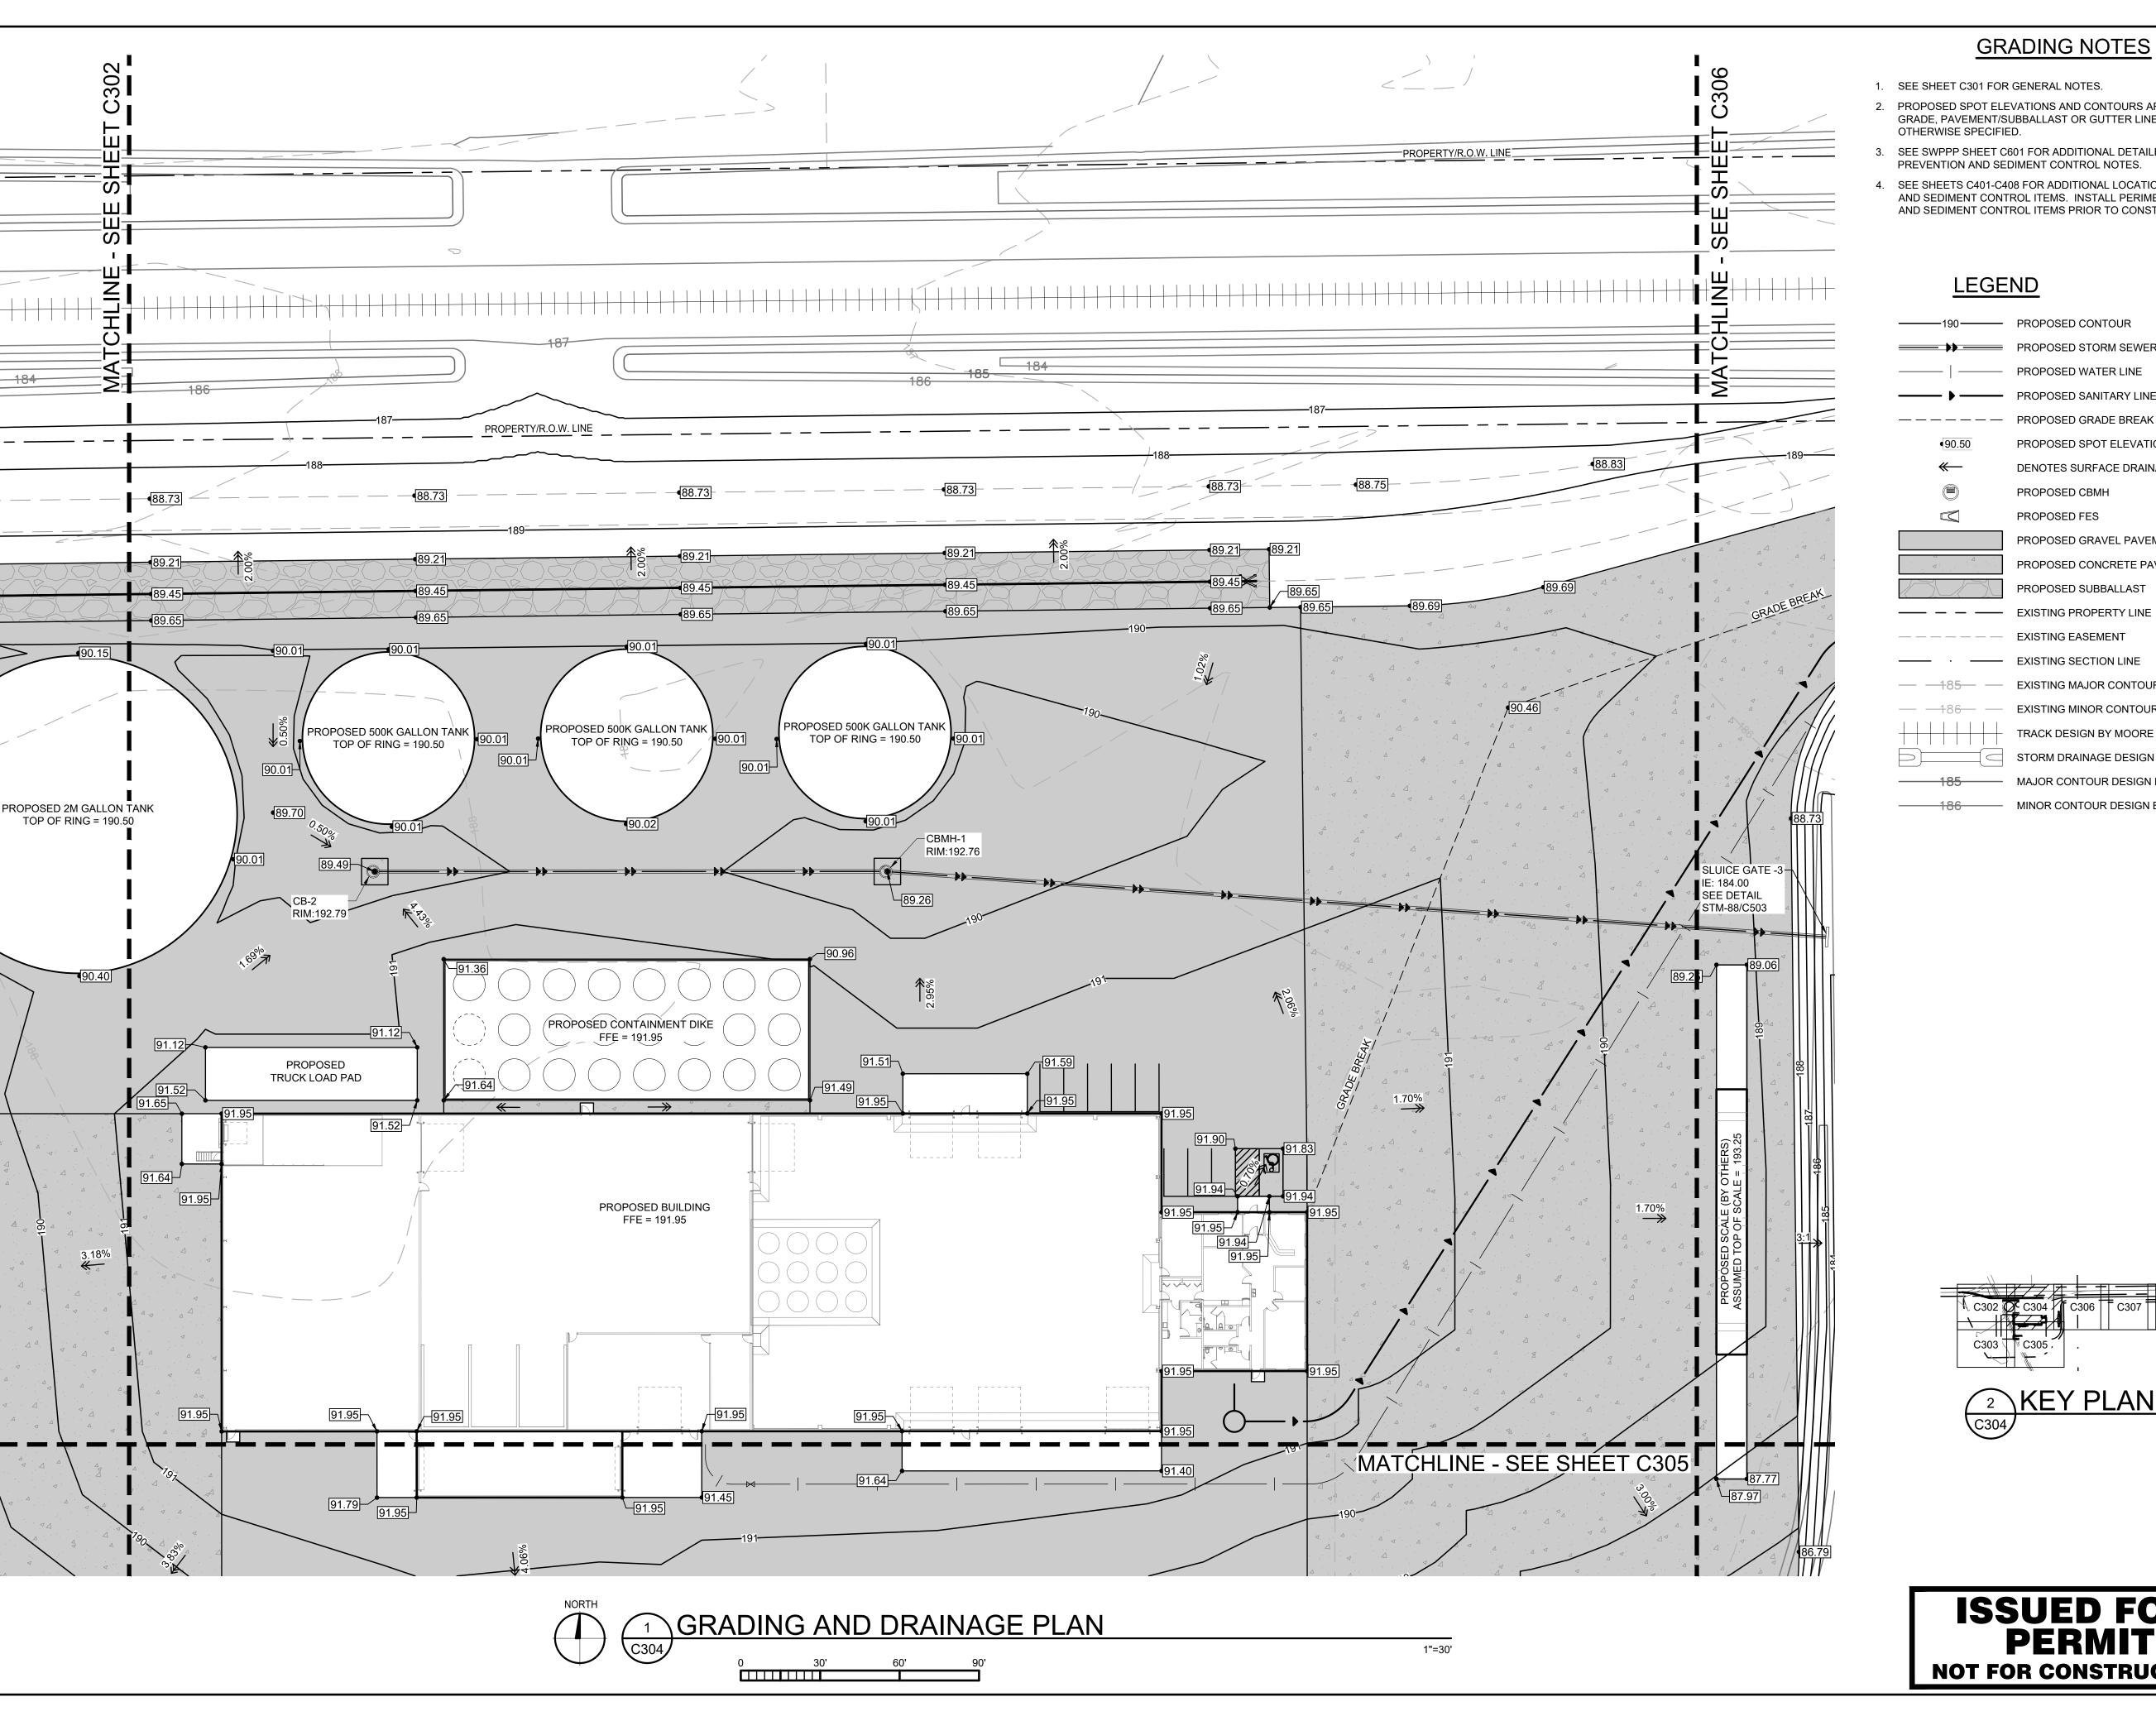LEGEND



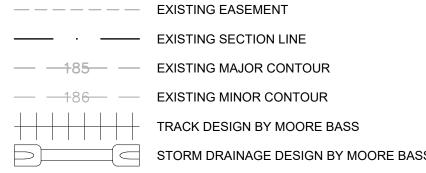

— MAJOR CONTOUR DESIGN BY MOORE BASS — MINOR CONTOUR DESIGN BY MOORE BASS

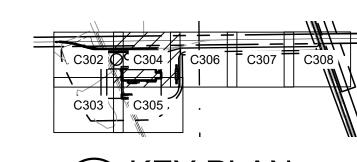



DATE: DRAWN: RCQ 10/19/2023 DESIGNED: APPROVED: CHECKED: AJR MDM

2300 Berkshire Lane N, Suite 200

Plymouth, MN 55441

PROJECT:

NO DATE

CERTIFICATION:

NEW LIQUID

FERTILIZER FACILITY

LAKE CITY, FL

A 10/19/2023 DESIGN DEVELOPMENT

B 12/11/2023 ISSUED FOR PERMIT

ISSUE/REVISION

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Project # 230384

DRAWING TITLE:

GRADING AND DRAINAGE PLAN

MARK D. MIELKE, PE

Registration No. 68730

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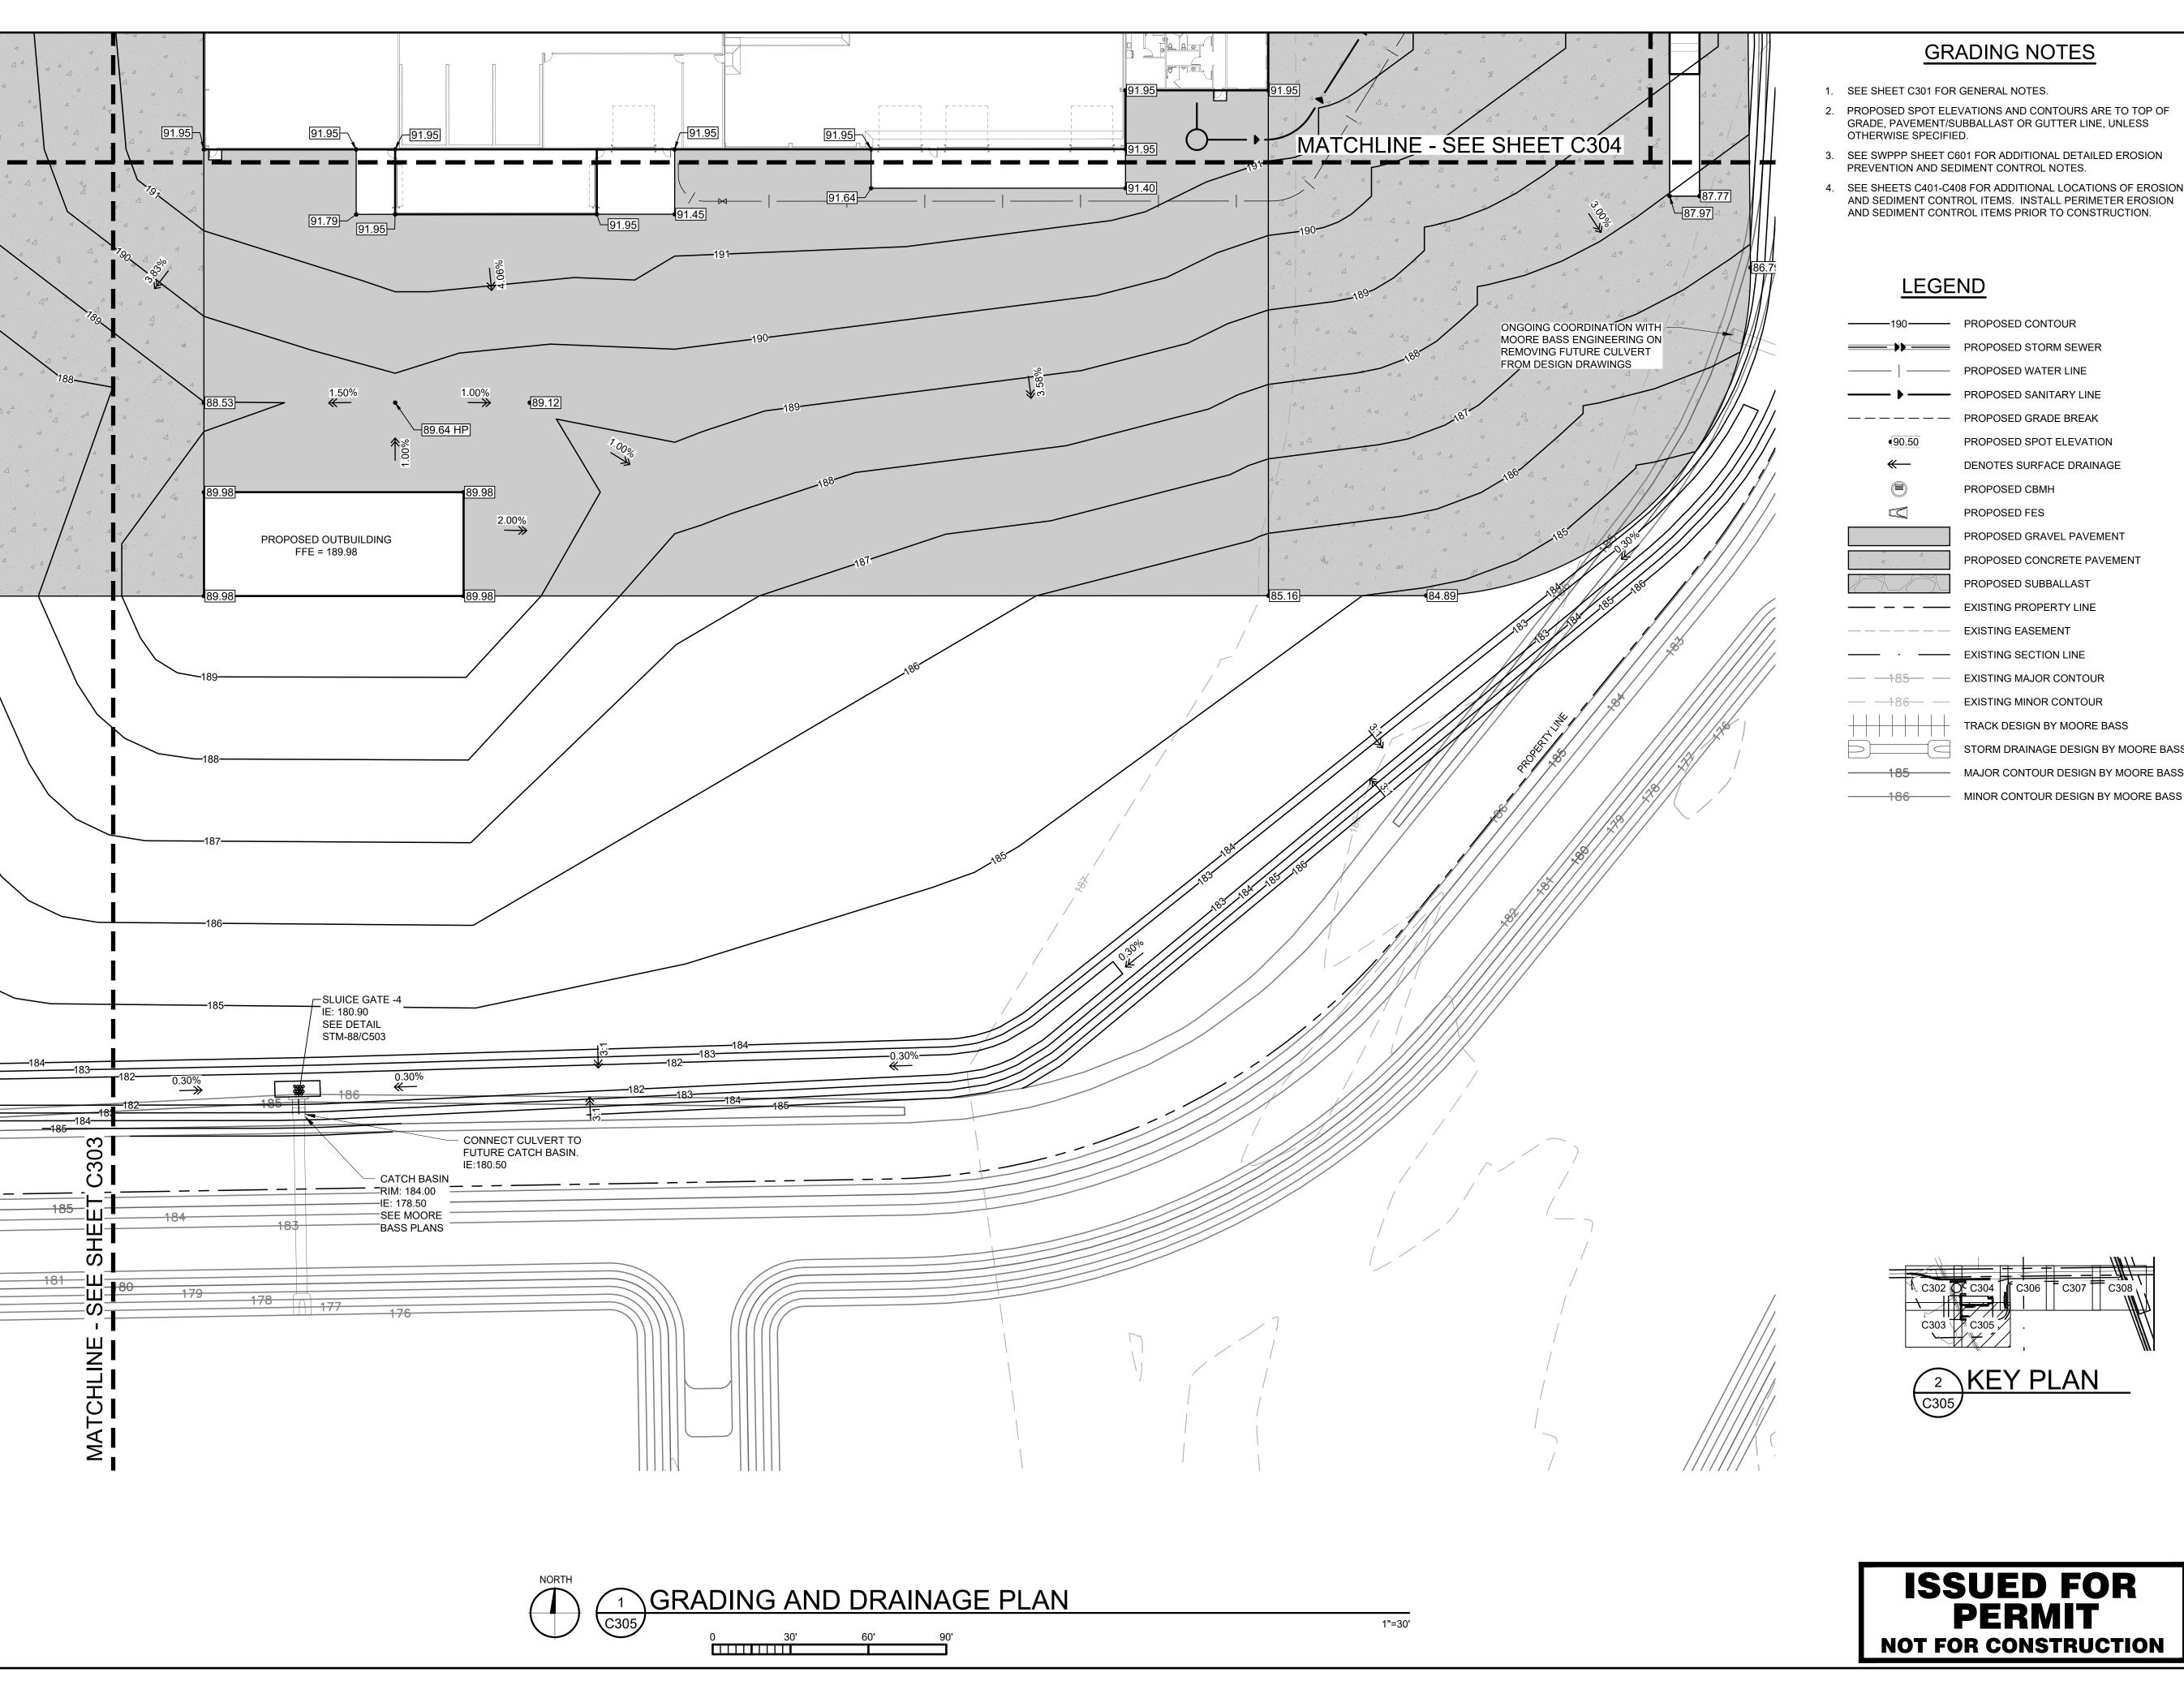
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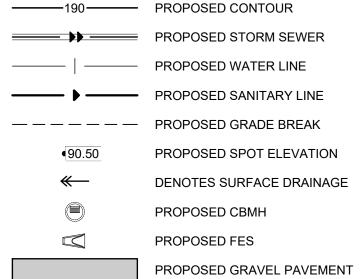
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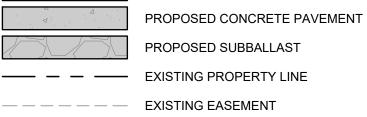
ISSUED FOR PROJECT NO: **PERMIT** 230384 SCALE: **NOT FOR CONSTRUCTION**

DRAWING NO: C304 AS NOTED





- 1. SEE SHEET C301 FOR GENERAL NOTES.
- 2. PROPOSED SPOT ELEVATIONS AND CONTOURS ARE TO TOP OF GRADE, PAVEMENT/SUBBALLAST OR GUTTER LINE, UNLESS OTHERWISE SPECIFIED.
- 3. SEE SWPPP SHEET C601 FOR ADDITIONAL DETAILED EROSION
- 4. SEE SHEETS C401-C408 FOR ADDITIONAL LOCATIONS OF EROSION AND SEDIMENT CONTROL ITEMS. INSTALL PERIMETER EROSION AND SEDIMENT CONTROL ITEMS PRIOR TO CONSTRUCTION.





SS
MOC

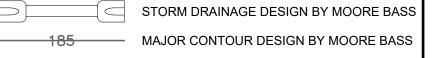

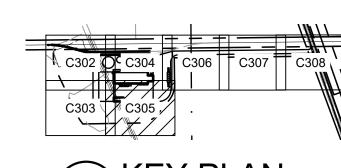

DATE: DRAWN: RCQ 10/19/2023 DESIGNED: CHECKED: APPROVED: AJR ARL MDM

DRAWING TITLE:

GRADING AND DRAINAGE PLAN

PROJECT NO: DRAWING NO: 230384 C305 SCALE: AS NOTED

VAA, LLC 2300 Berkshire Lane N, Suite 200 Plymouth, MN 55441 www.vaaeng.com Project # 230384

AGROLIQUID.

PROJECT:


NEW LIQUID FERTILIZER FACILITY LAKE CITY, FL

NO	DATE	ISSUE/REVISION	B
Α	10/19/2023	DESIGN DEVELOPMENT	RC
В	12/11/2023	ISSUED FOR PERMIT	RC


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- 3. SEE SWPPP SHEET C601 FOR ADDITIONAL DETAILED EROSION PREVENTION AND SEDIMENT CONTROL NOTES.
- SEE SHEETS C401-C408 FOR ADDITIONAL LOCATIONS OF EROSION AND SEDIMENT CONTROL ITEMS. INSTALL PERIMETER EROSION AND SEDIMENT CONTROL ITEMS PRIOR TO CONSTRUCTION.



—— EXISTING SECTION LINE — 185 — EXISTING MAJOR CONTOUR TRACK DESIGN BY MOORE BASS STORM DRAINAGE DESIGN BY MOORE BASS 185 MAJOR CONTOUR DESIGN BY MOORE BASS

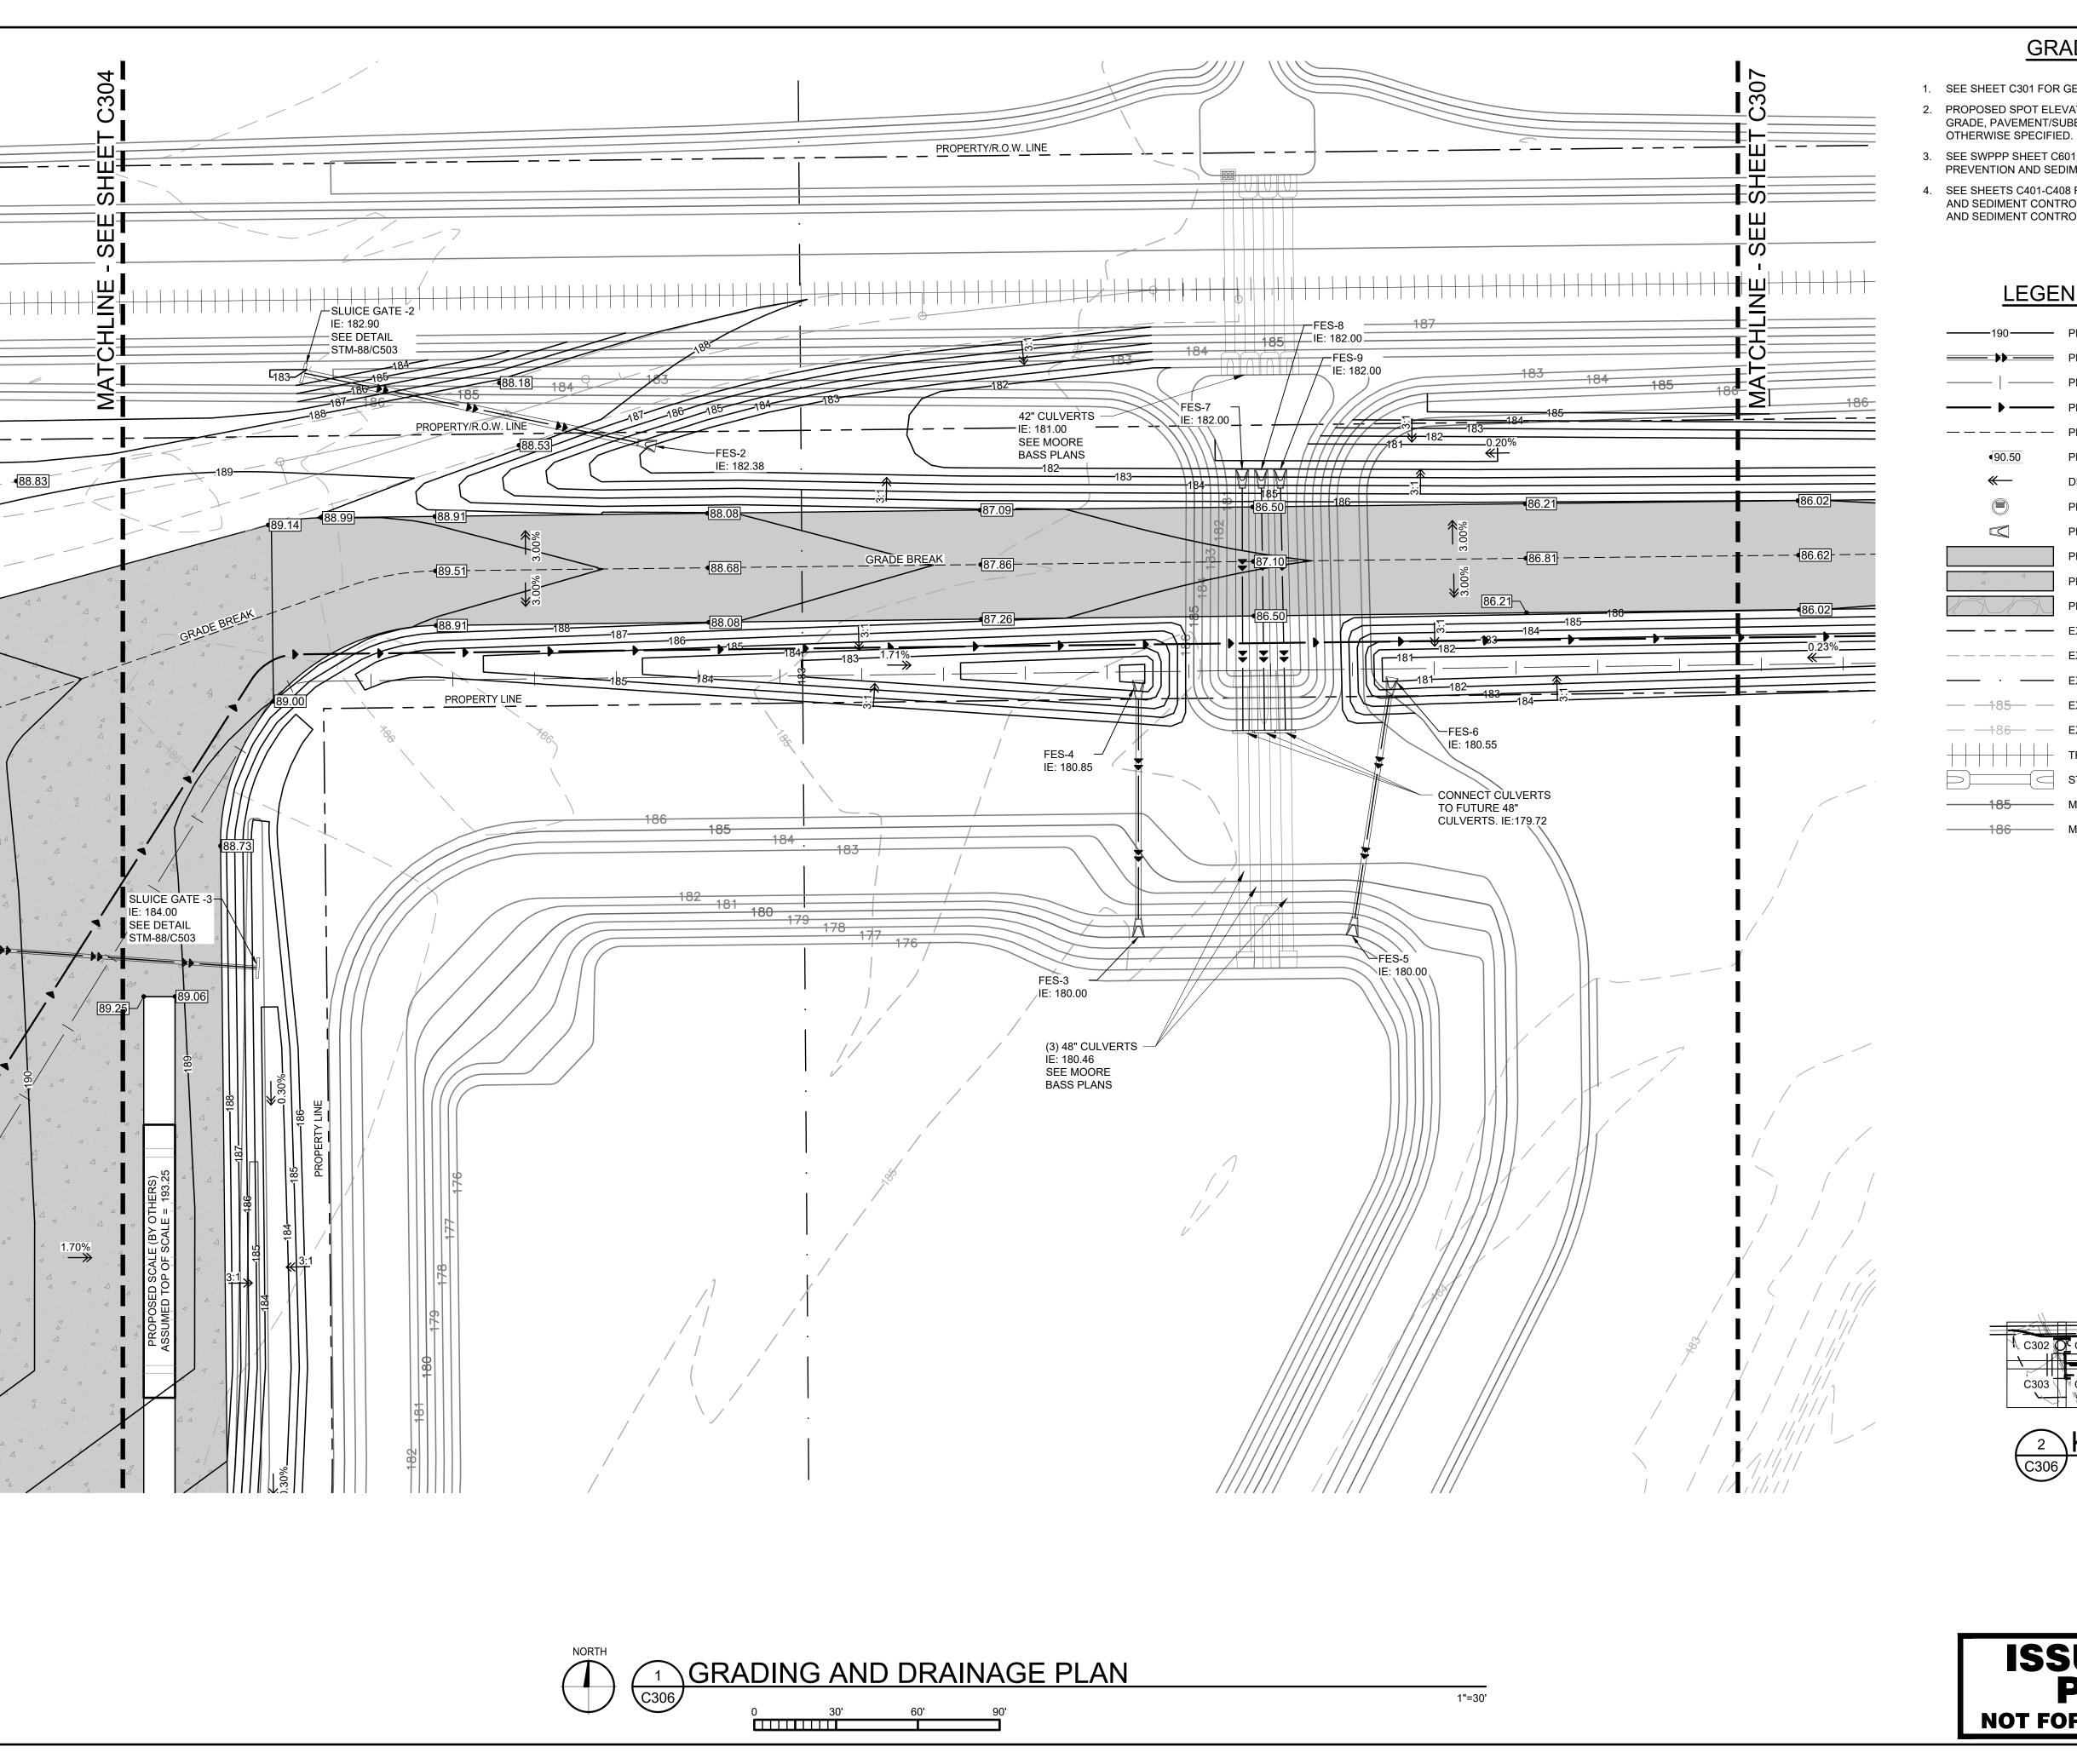NO DATE ISSUE/REVISION A 10/19/2023 DESIGN DEVELOPMENT B 12/11/2023 ISSUED FOR PERMIT

NEW LIQUID

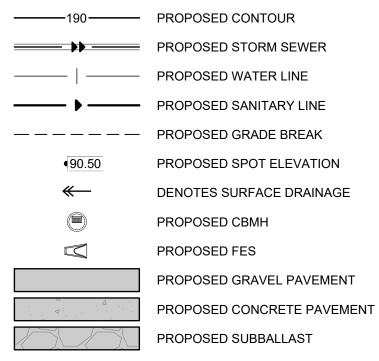FERTILIZER FACILITY

LAKE CITY, FL

CERTIFICATION:

VAA, LLC

PROJECT:

Plymouth, MN 55441

2300 Berkshire Lane N, Suite 200

www.vaaeng.com

Project # 230384

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DATE:		DRAWN:	
10/19/2023		1100	
DESIGNED:	CHECKE	:D:	APPROV
AJR	ARI		MDM

DRAWING TITLE:

GRADING AND DRAINAGE PLAN

ISSUED FOR PERMIT **NOT FOR CONSTRUCTION**


PROJECT NO:	DRAWING NO:
230384	C206
SCALE:	C306
AS NOTED	

LEGEND

—— — — EXISTING PROPERTY LINE EXISTING EASEMENT

— — 186— — EXISTING MINOR CONTOUR

² KEY PLAN

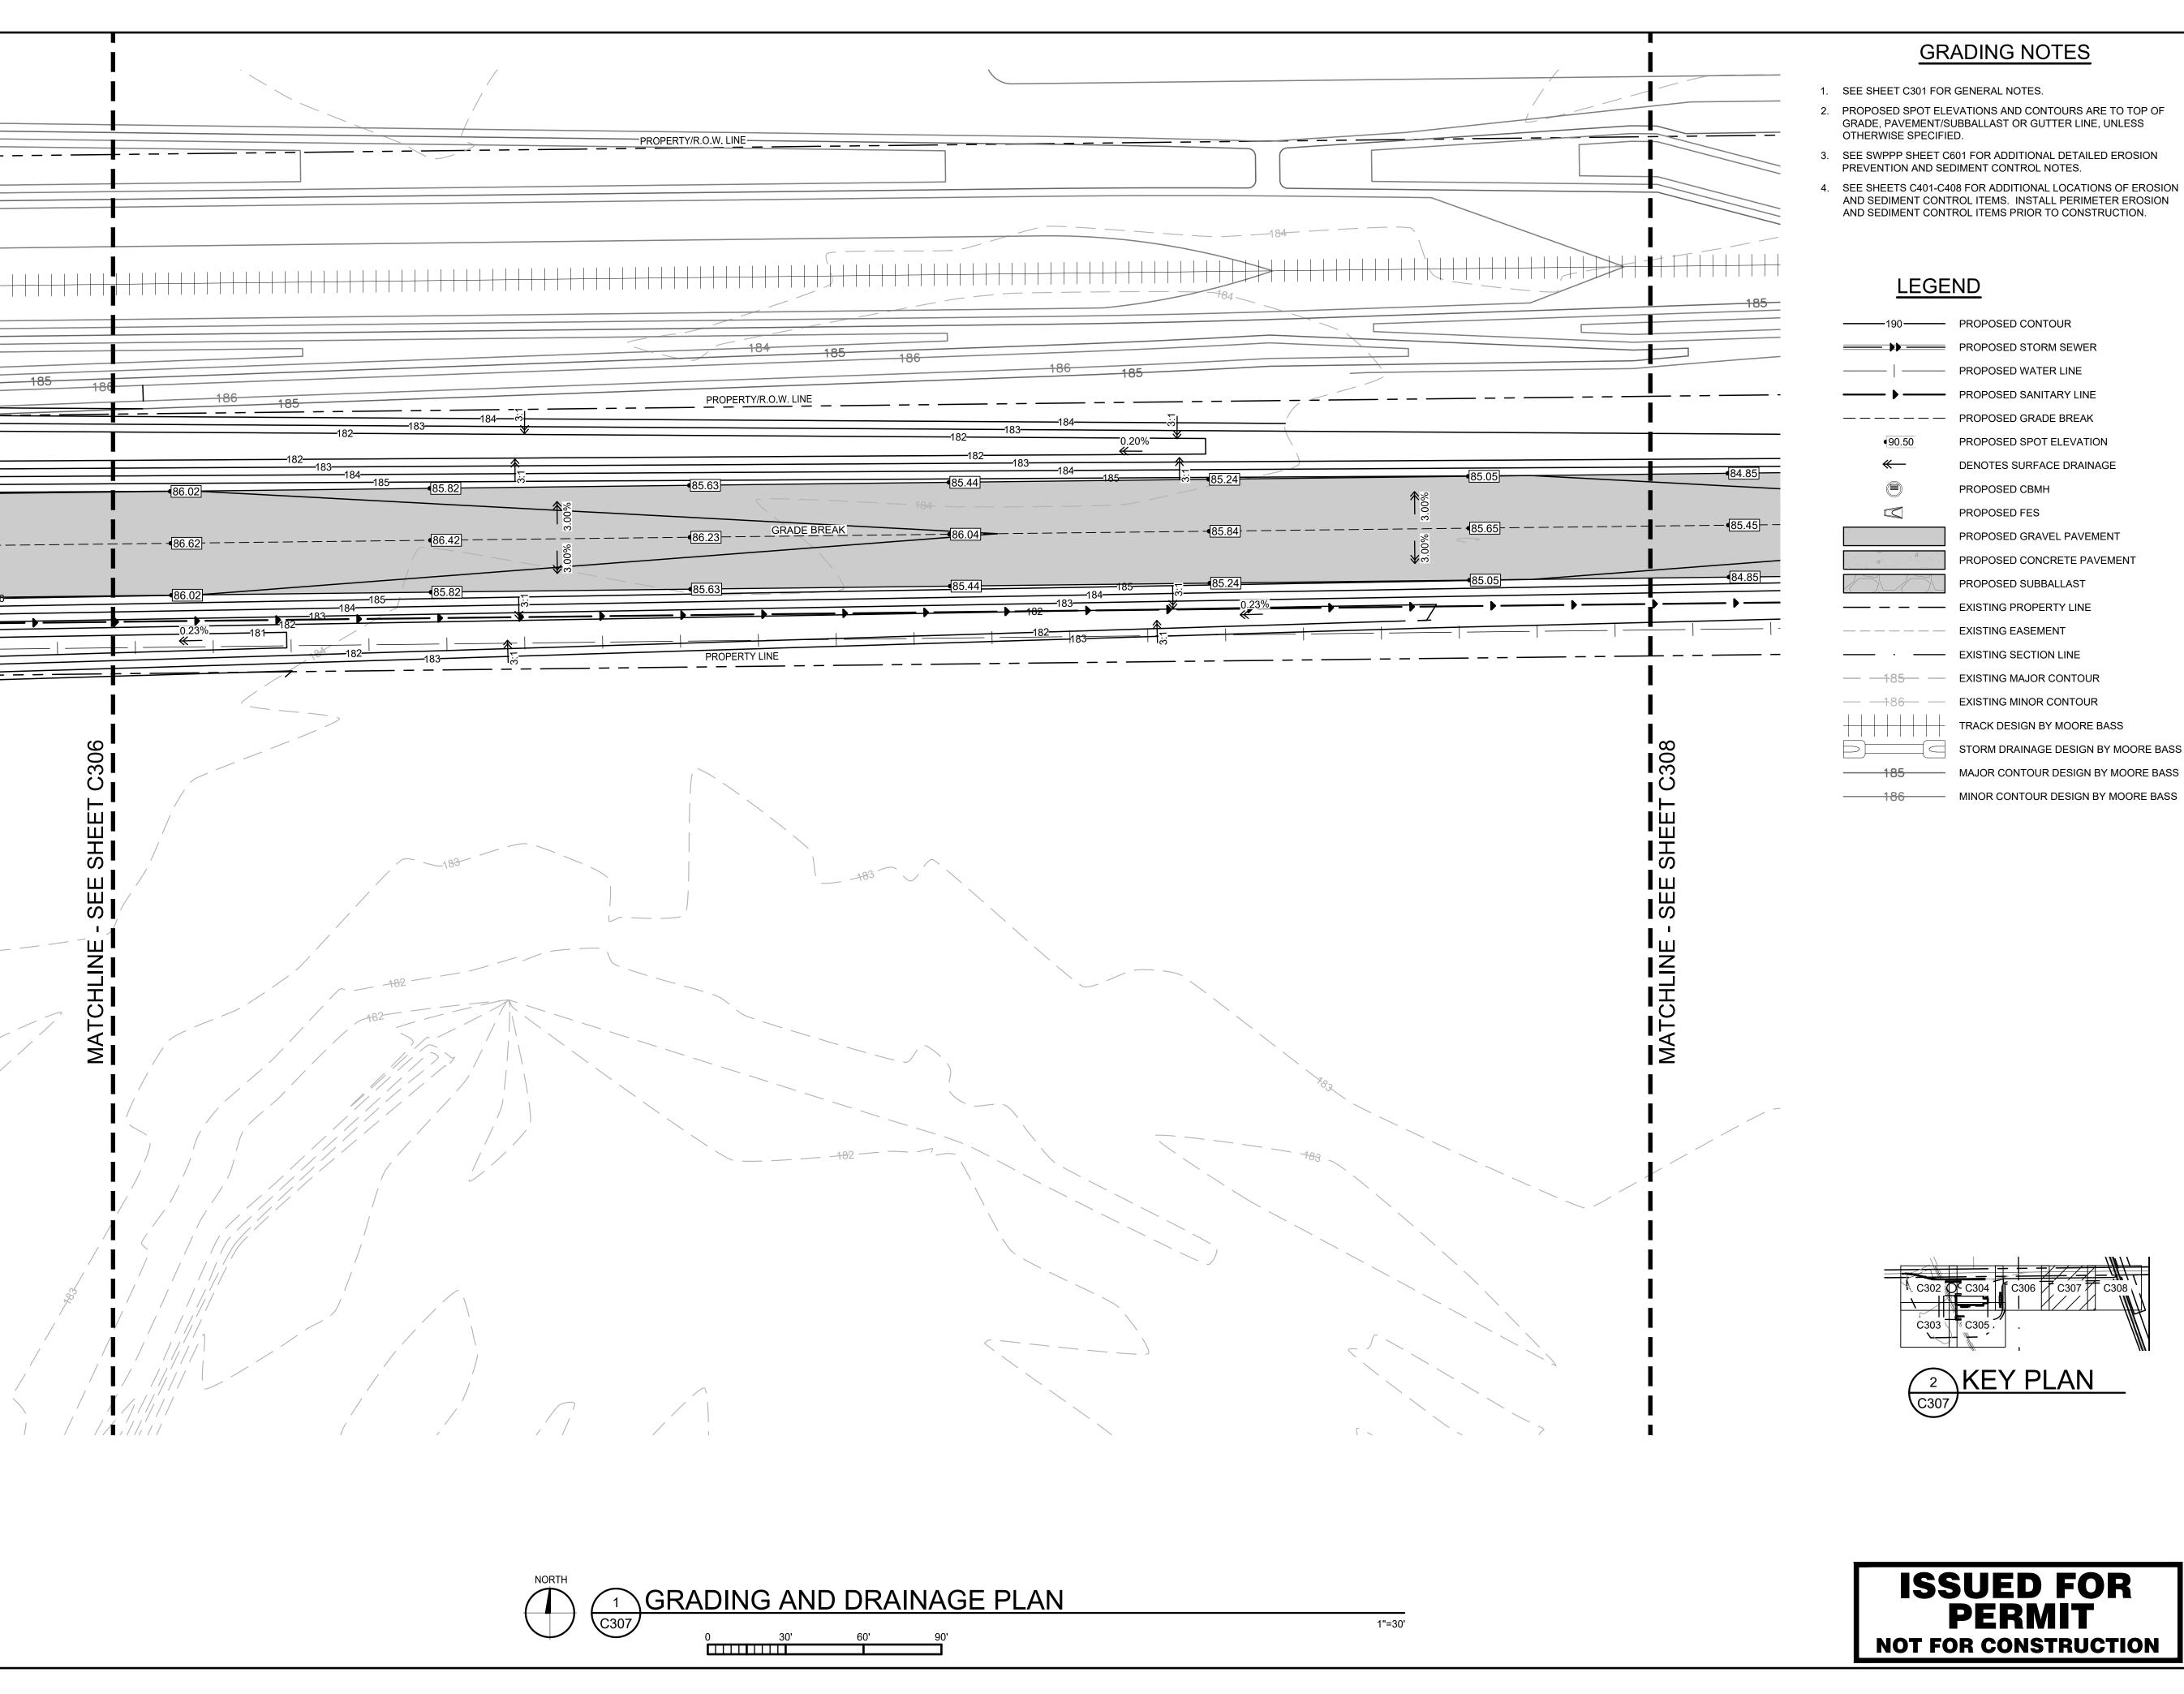


- 1. SEE SHEET C301 FOR GENERAL NOTES.
- 2. PROPOSED SPOT ELEVATIONS AND CONTOURS ARE TO TOP OF GRADE, PAVEMENT/SUBBALLAST OR GUTTER LINE, UNLESS
- SEE SWPPP SHEET C601 FOR ADDITIONAL DETAILED EROSION

PROPOSED SUBBALLAST

4. SEE SHEETS C401-C408 FOR ADDITIONAL LOCATIONS OF EROSION AND SEDIMENT CONTROL ITEMS. INSTALL PERIMETER EROSION AND SEDIMENT CONTROL ITEMS PRIOR TO CONSTRUCTION.

2300 Berkshire Lane N, Suite 200 www.vaaeng.com Plymouth, MN 55441 Project # 230384

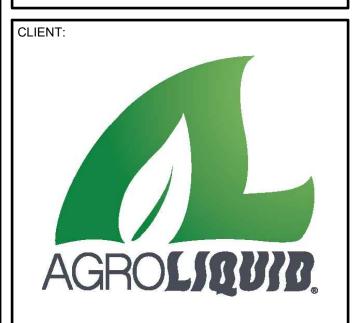

PROJECT:

NEW LIQUID FERTILIZER FACILITY LAKE CITY, FL

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Α	10/19/2023	DESIGN DEVELOPMENT	RCQ	
В	12/11/2023	ISSUED FOR PERMIT	RCQ	
0555	CERTIFICATION.			

CERTIFICATION:

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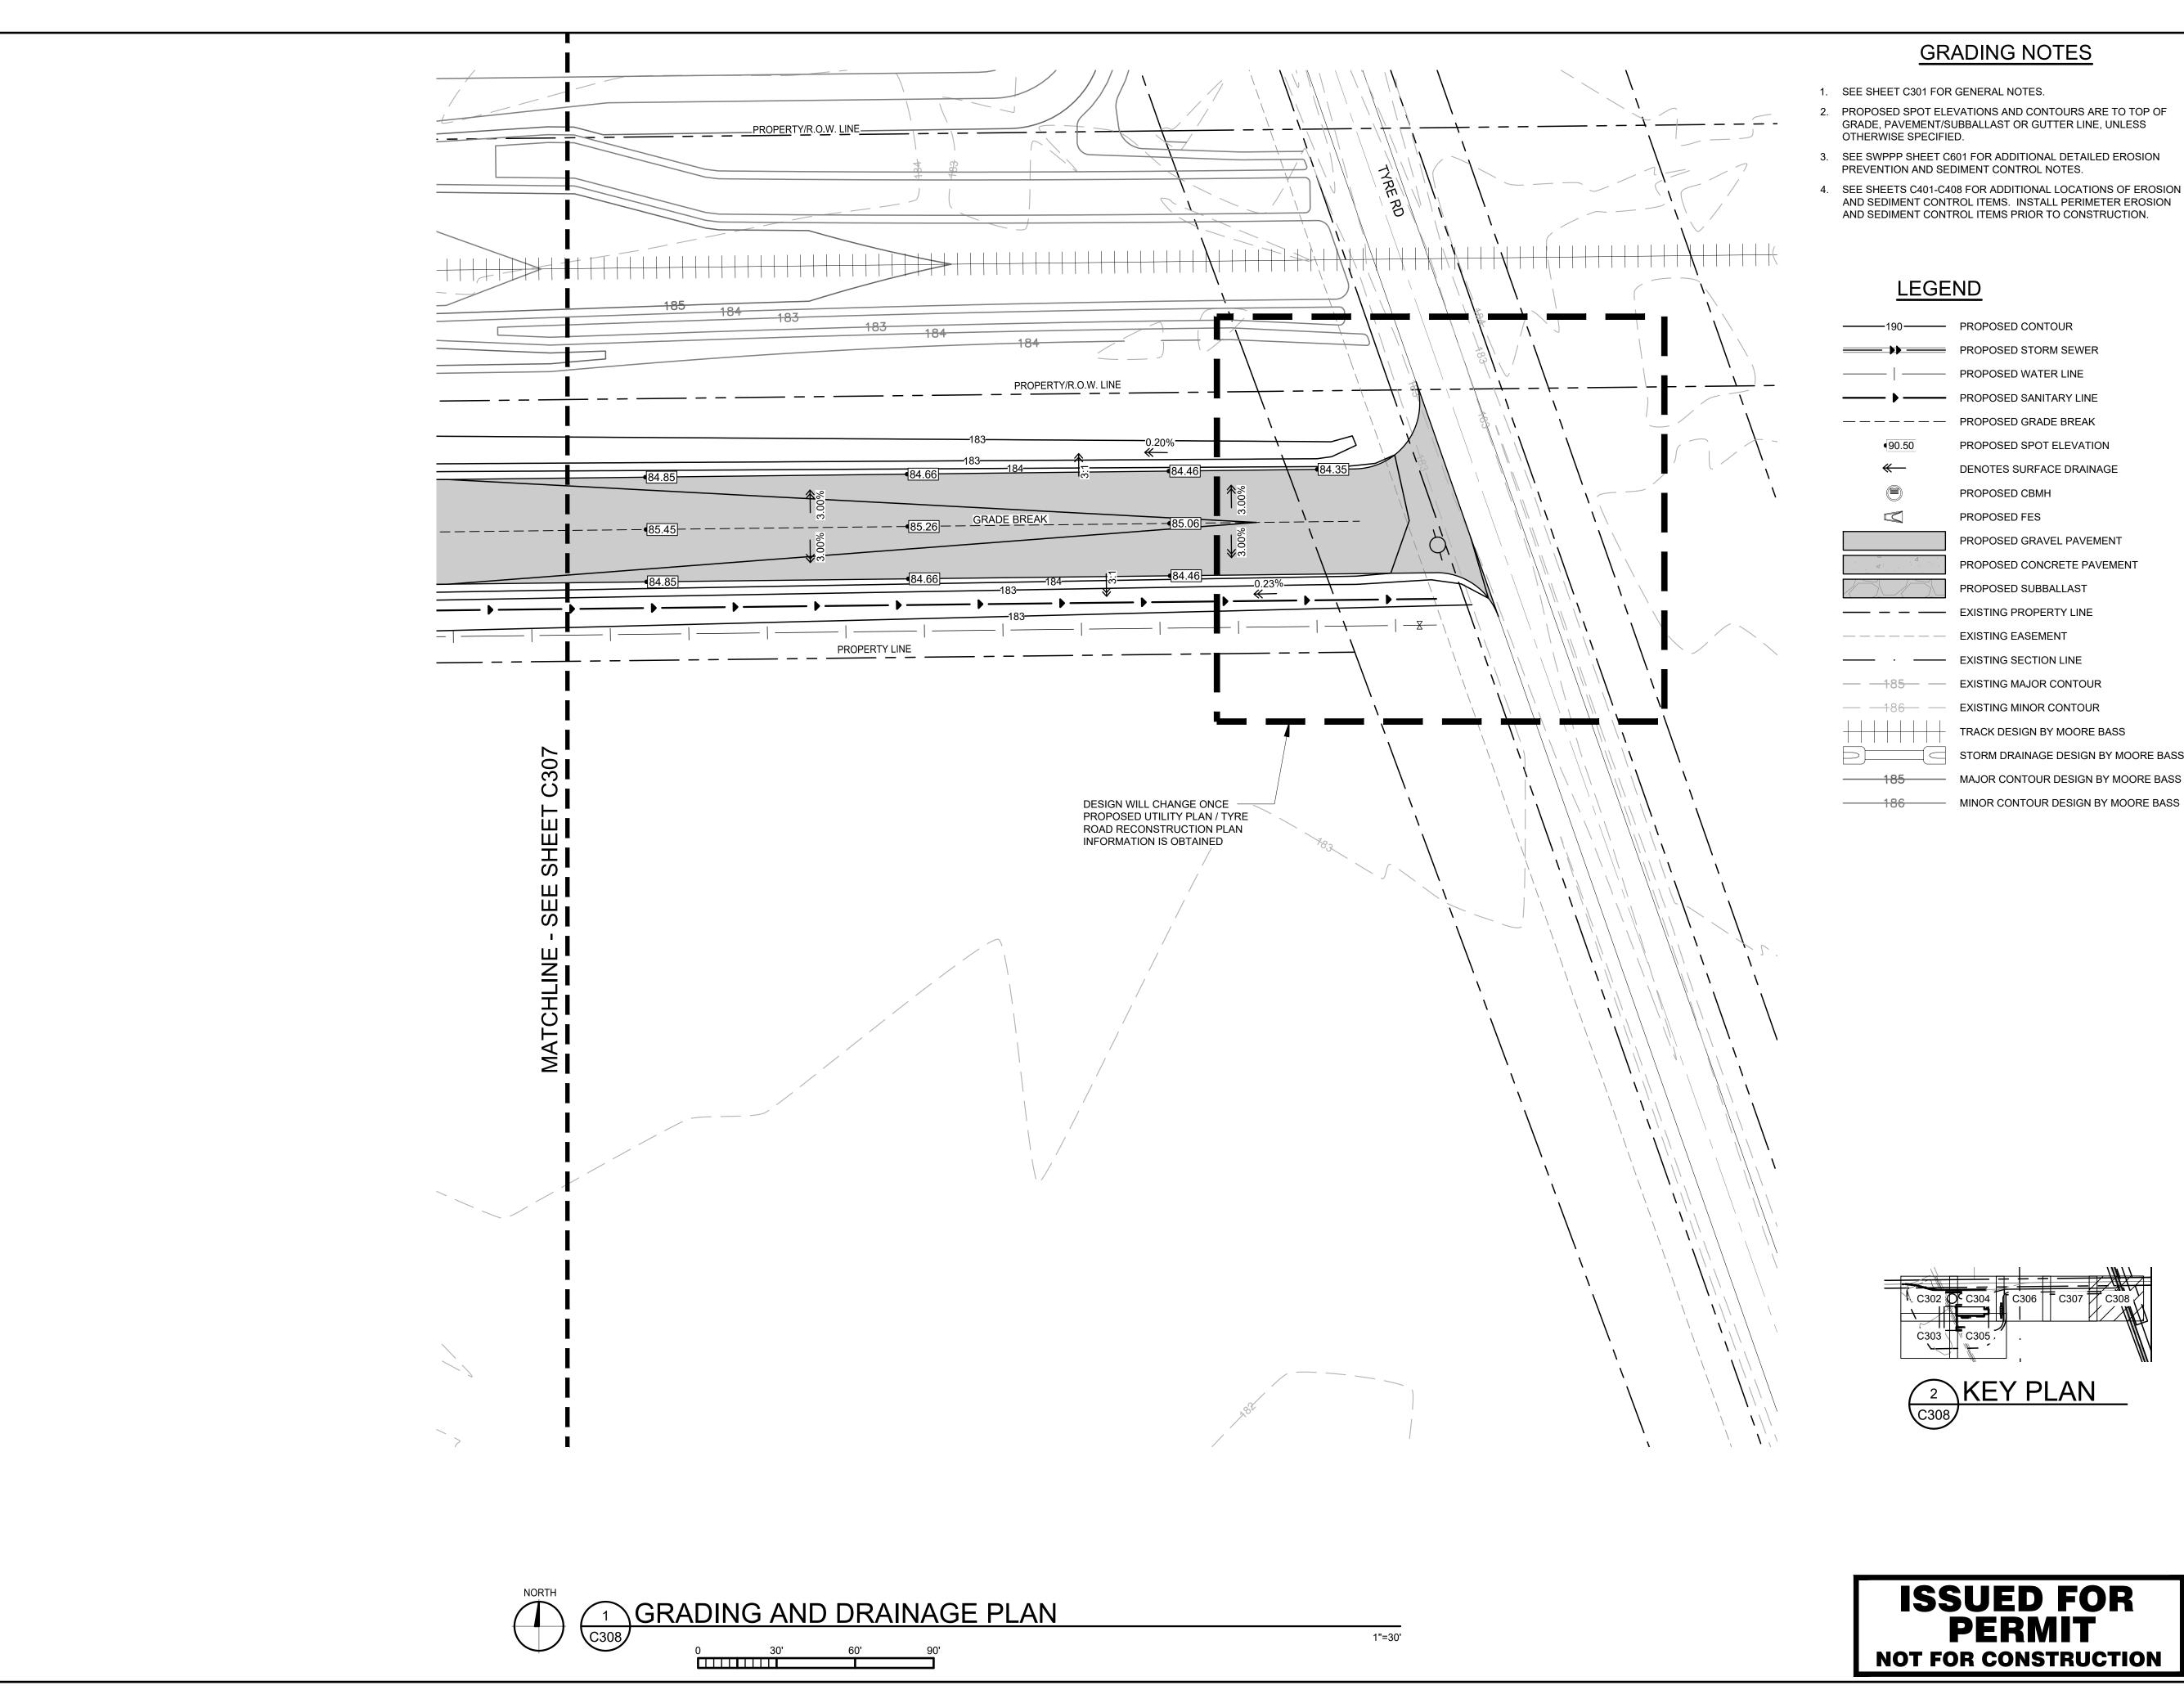
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DATE: 10/19/2023		DRAWN:	
DESIGNED: AJR	CHECKE ARL	ED:	APPROVED MDM

DRAWING TITLE:

GRADING AND DRAINAGE PLAN

DRAWING NO: PROJECT NO: 230384 C307 SCALE: AS NOTED






- 1. SEE SHEET C301 FOR GENERAL NOTES.
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- 3. SEE SWPPP SHEET C601 FOR ADDITIONAL DETAILED EROSION
- 4. SEE SHEETS C401-C408 FOR ADDITIONAL LOCATIONS OF EROSION AND SEDIMENT CONTROL ITEMS. INSTALL PERIMETER EROSION AND SEDIMENT CONTROL ITEMS PRIOR TO CONSTRUCTION.

-190 — PROPOSED CONTOUR PROPOSED STORM SEWER PROPOSED WATER LINE PROPOSED SANITARY LINE — — — — PROPOSED GRADE BREAK PROPOSED SPOT ELEVATION DENOTES SURFACE DRAINAGE PROPOSED CBMH PROPOSED FES

PROPOSED GRAVEL PAVEMENT PROPOSED CONCRETE PAVEMENT PROPOSED SUBBALLAST —— — — EXISTING PROPERTY LINE EXISTING EASEMENT

—— EXISTING SECTION LINE — — 185— EXISTING MAJOR CONTOUR — — 186— — EXISTING MINOR CONTOUR TRACK DESIGN BY MOORE BASS

STORM DRAINAGE DESIGN BY MOORE BASS 185 MAJOR CONTOUR DESIGN BY MOORE BASS

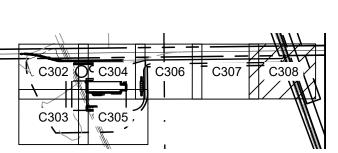



GRADING AND

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VAA, LLC 2300 Berkshire Lane N, Suite 200 www.vaaeng.com Plymouth, MN 55441 Project # 230384



PROJECT:

NEW LIQUID FERTILIZER FACILITY LAKE CITY, FL

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Α	10/19/2023	DESIGN DEVELOPMENT	RCQ
В	12/11/2023	ISSUED FOR PERMIT	RCQ

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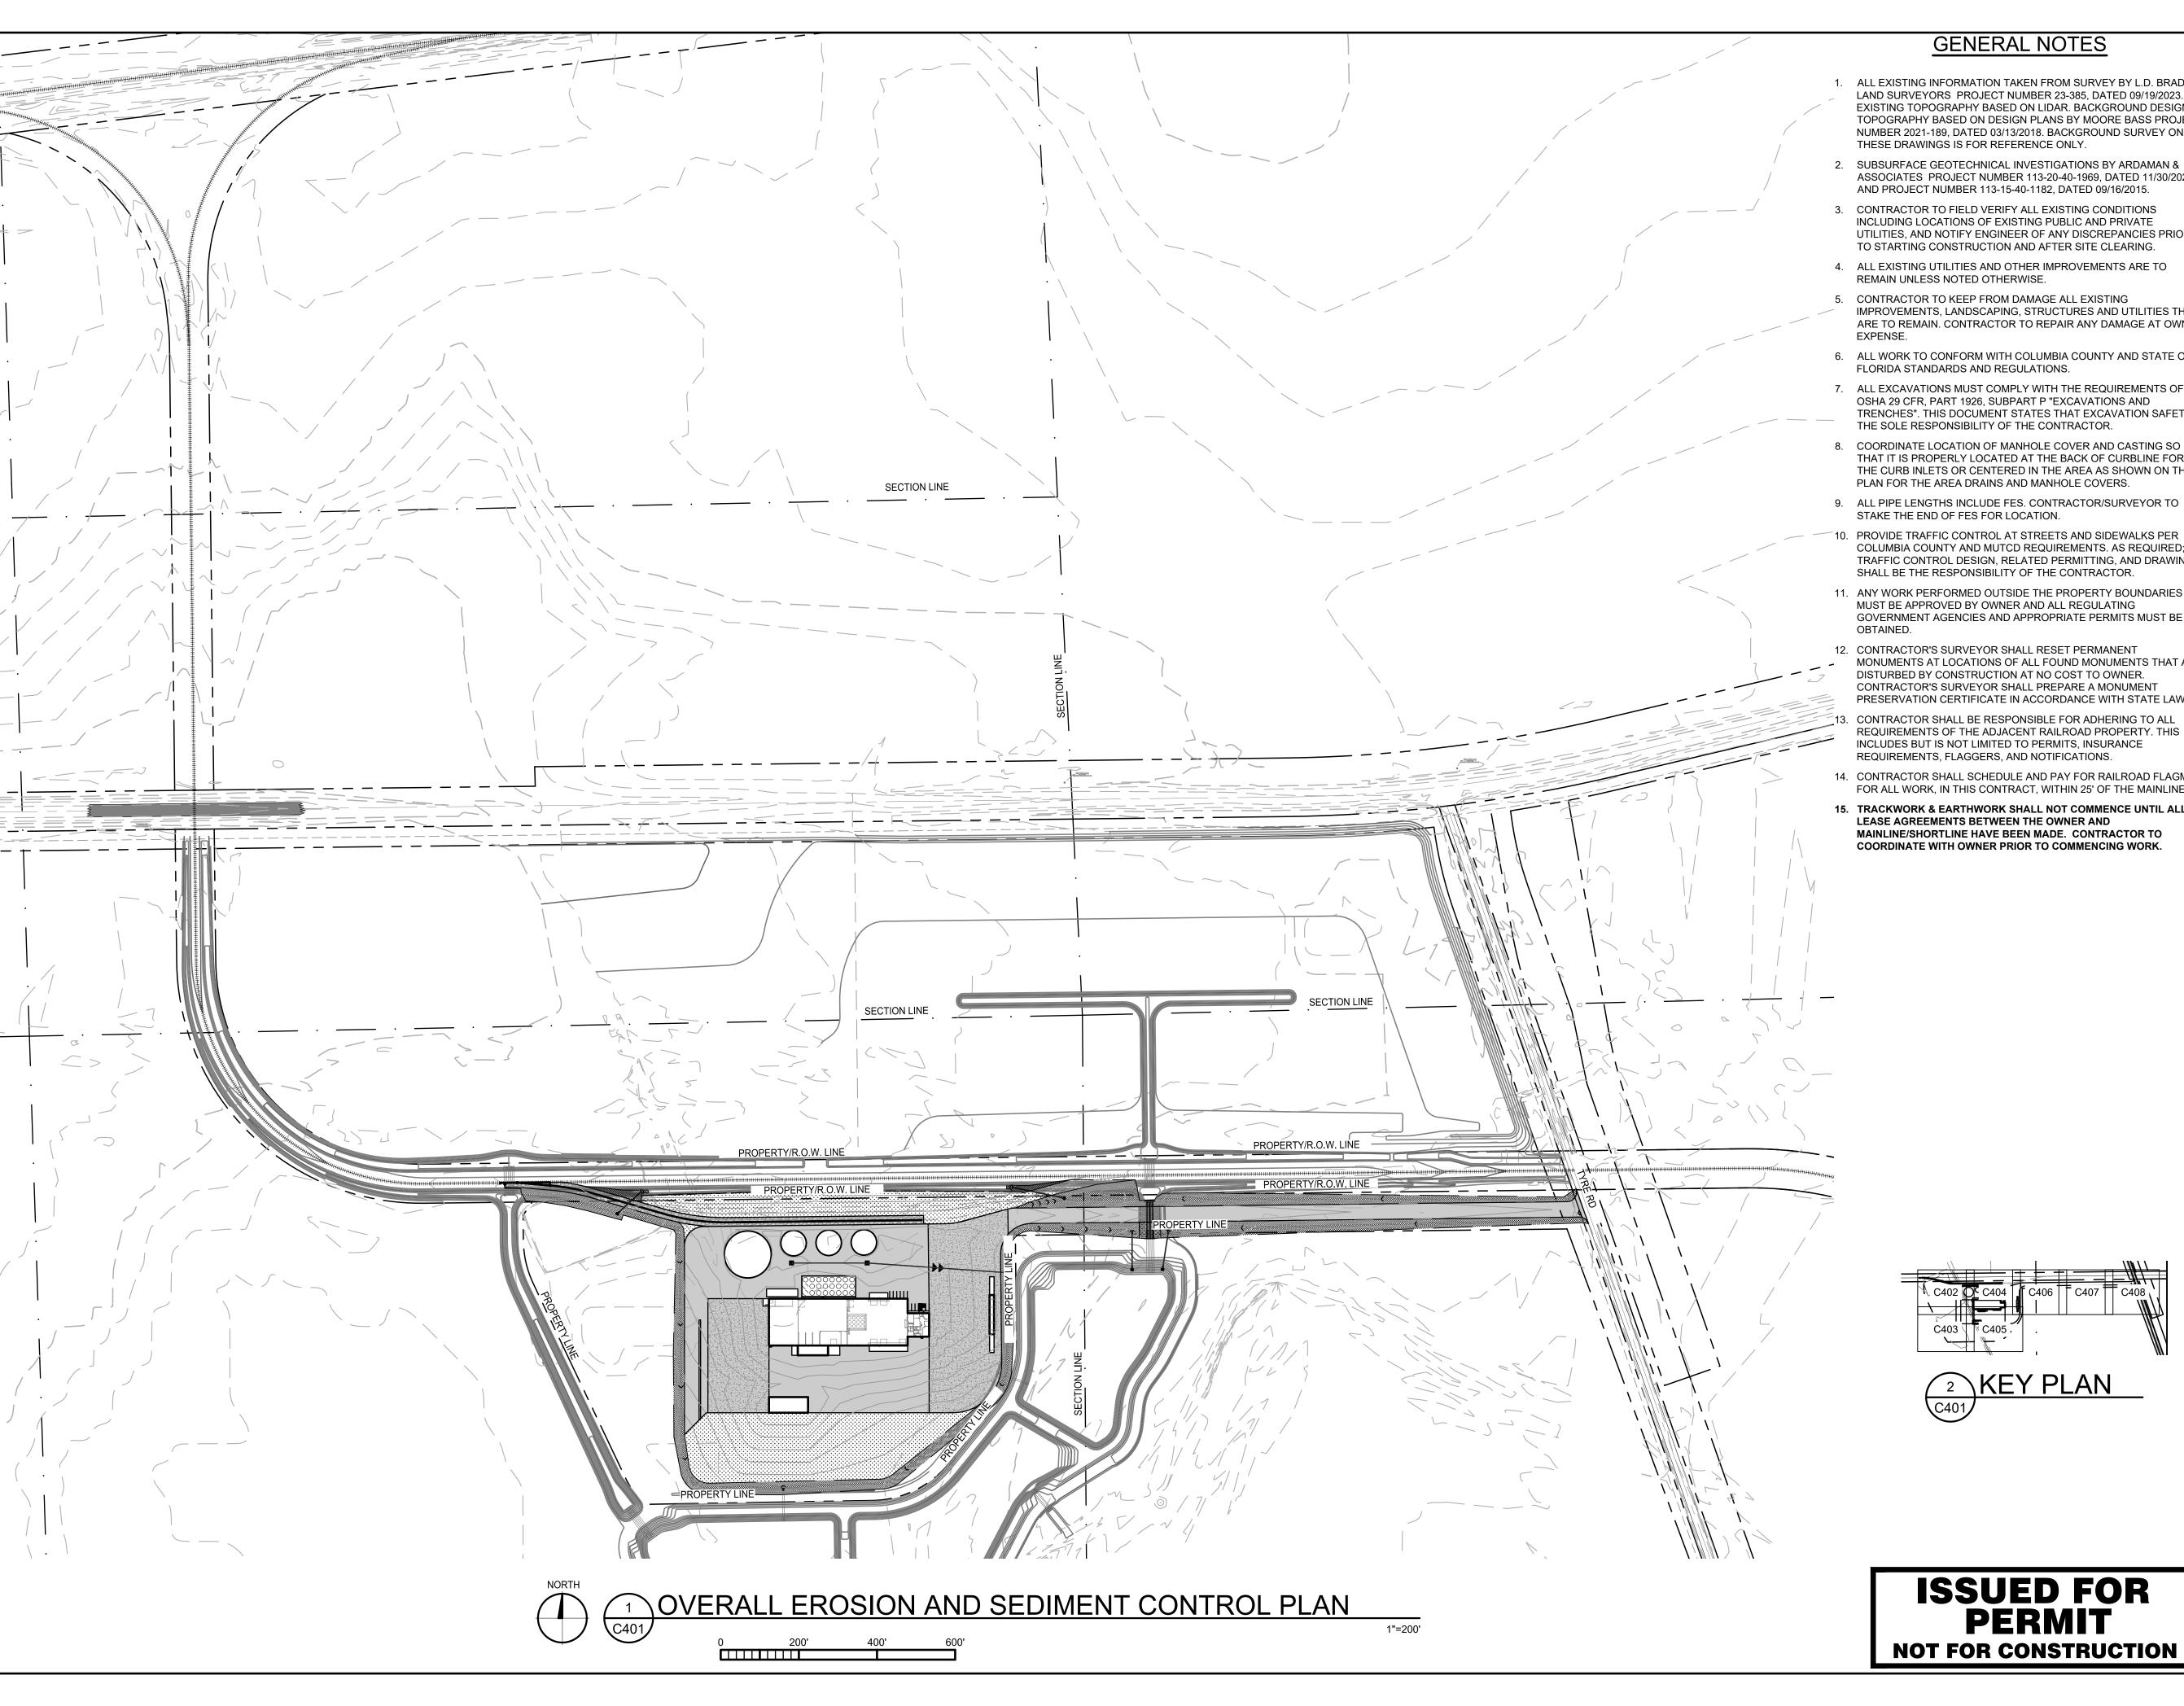
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DATE: 10/19/2023		DRAWN: RCQ	
DESIGNED: AJR	CHECKE ARL	ED:	APPROVED MDM

DRAWING TITLE:

DRAINAGE PLAN

PROJECT NO: DRAWING NO: 230384 C308 SCALE: AS NOTED



GENERAL NOTES

- 1. ALL EXISTING INFORMATION TAKEN FROM SURVEY BY L.D. BRADLEY LAND SURVEYORS PROJECT NUMBER 23-385, DATED 09/19/2023. EXISTING TOPOGRAPHY BASED ON LIDAR. BACKGROUND DESIGN TOPOGRAPHY BASED ON DESIGN PLANS BY MOORE BASS PROJECT NUMBER 2021-189, DATED 03/13/2018. BACKGROUND SURVEY ON THESE DRAWINGS IS FOR REFERENCE ONLY.
- 2. SUBSURFACE GEOTECHNICAL INVESTIGATIONS BY ARDAMAN & ASSOCIATES PROJECT NUMBER 113-20-40-1969, DATED 11/30/2020, AND PROJECT NUMBER 113-15-40-1182, DATED 09/16/2015.
- 3. CONTRACTOR TO FIELD VERIFY ALL EXISTING CONDITIONS INCLUDING LOCATIONS OF EXISTING PUBLIC AND PRIVATE UTILITIES, AND NOTIFY ENGINEER OF ANY DISCREPANCIES PRIOR TO STARTING CONSTRUCTION AND AFTER SITE CLEARING.
- 4. ALL EXISTING UTILITIES AND OTHER IMPROVEMENTS ARE TO REMAIN UNLESS NOTED OTHERWISE.
- 5. CONTRACTOR TO KEEP FROM DAMAGE ALL EXISTING IMPROVEMENTS, LANDSCAPING, STRUCTURES AND UTILITIES THAT ARE TO REMAIN. CONTRACTOR TO REPAIR ANY DAMAGE AT OWN
- 6. ALL WORK TO CONFORM WITH COLUMBIA COUNTY AND STATE OF FLORIDA STANDARDS AND REGULATIONS.
- 7. ALL EXCAVATIONS MUST COMPLY WITH THE REQUIREMENTS OF OSHA 29 CFR, PART 1926, SUBPART P "EXCAVATIONS AND TRENCHES". THIS DOCUMENT STATES THAT EXCAVATION SAFETY IS THE SOLE RESPONSIBILITY OF THE CONTRACTOR.
- THAT IT IS PROPERLY LOCATED AT THE BACK OF CURBLINE FOR THE CURB INLETS OR CENTERED IN THE AREA AS SHOWN ON THE PLAN FOR THE AREA DRAINS AND MANHOLE COVERS.
- 9. ALL PIPE LENGTHS INCLUDE FES. CONTRACTOR/SURVEYOR TO STAKE THE END OF FES FOR LOCATION.
- 10. PROVIDE TRAFFIC CONTROL AT STREETS AND SIDEWALKS PER COLUMBIA COUNTY AND MUTCD REQUIREMENTS. AS REQUIRED; TRAFFIC CONTROL DESIGN, RELATED PERMITTING, AND DRAWINGS SHALL BE THE RESPONSIBILITY OF THE CONTRACTOR.
- 11. ANY WORK PERFORMED OUTSIDE THE PROPERTY BOUNDARIES MUST BE APPROVED BY OWNER AND ALL REGULATING GOVERNMENT AGENCIES AND APPROPRIATE PERMITS MUST BE
- 12. CONTRACTOR'S SURVEYOR SHALL RESET PERMANENT MONUMENTS AT LOCATIONS OF ALL FOUND MONUMENTS THAT ARE DISTURBED BY CONSTRUCTION AT NO COST TO OWNER. CONTRACTOR'S SURVEYOR SHALL PREPARE A MONUMENT PRESERVATION CERTIFICATE IN ACCORDANCE WITH STATE LAW.
- CONTRACTOR SHALL BE RESPONSIBLE FOR ADHERING TO ALL REQUIREMENTS OF THE ADJACENT RAILROAD PROPERTY. THIS INCLUDES BUT IS NOT LIMITED TO PERMITS, INSURANCE REQUIREMENTS, FLAGGERS, AND NOTIFICATIONS.
- 14. CONTRACTOR SHALL SCHEDULE AND PAY FOR RAILROAD FLAGMEN FOR ALL WORK, IN THIS CONTRACT, WITHIN 25' OF THE MAINLINE.

PERMIT

15. TRACKWORK & EARTHWORK SHALL NOT COMMENCE UNTIL ALL LEASE AGREEMENTS BETWEEN THE OWNER AND MAINLINE/SHORTLINE HAVE BEEN MADE. CONTRACTOR TO COORDINATE WITH OWNER PRIOR TO COMMENCING WORK.



2300 Berkshire Lane N, Suite 200 Plymouth, MN 55441

www.vaaeng.com Project # 230384



PROJECT:

NEW LIQUID FERTILIZER FACILITY LAKE CITY, FL

NO	DATE	ISSUE/REVISION	BY
Α	10/19/2023	DESIGN DEVELOPMENT	RCQ
В	12/11/2023	ISSUED FOR PERMIT	RCQ

CERTIFICATION:

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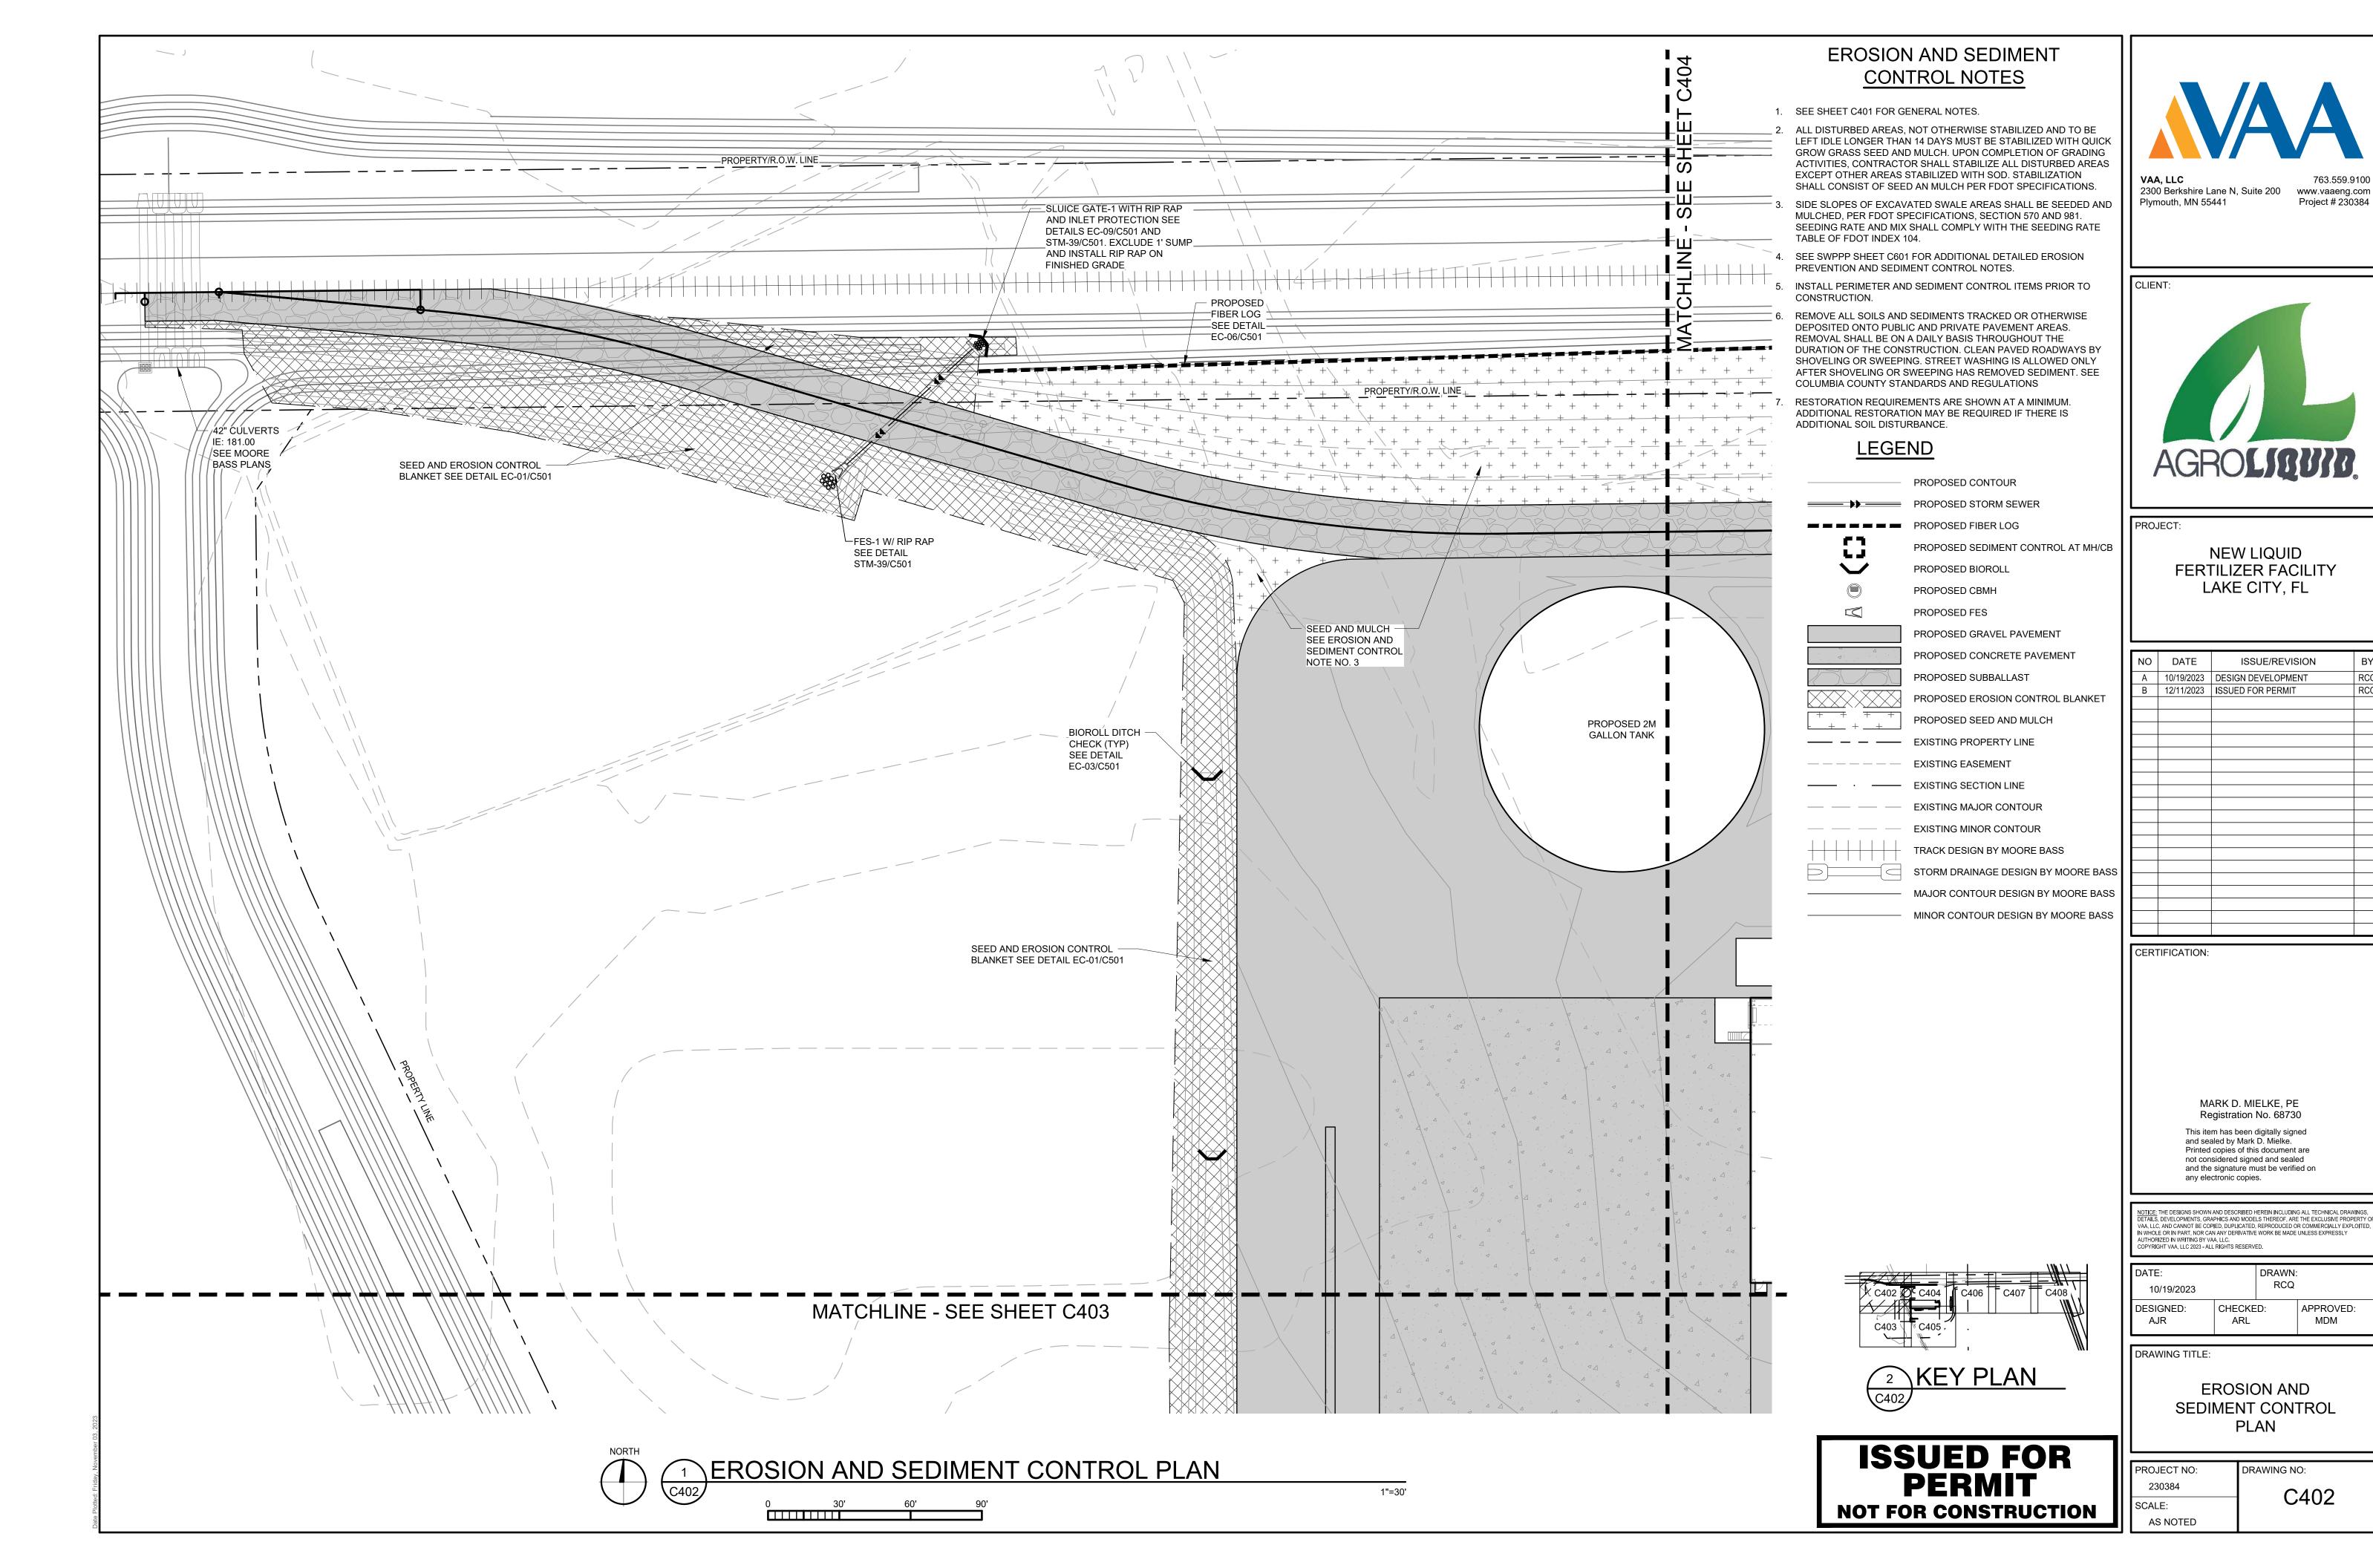
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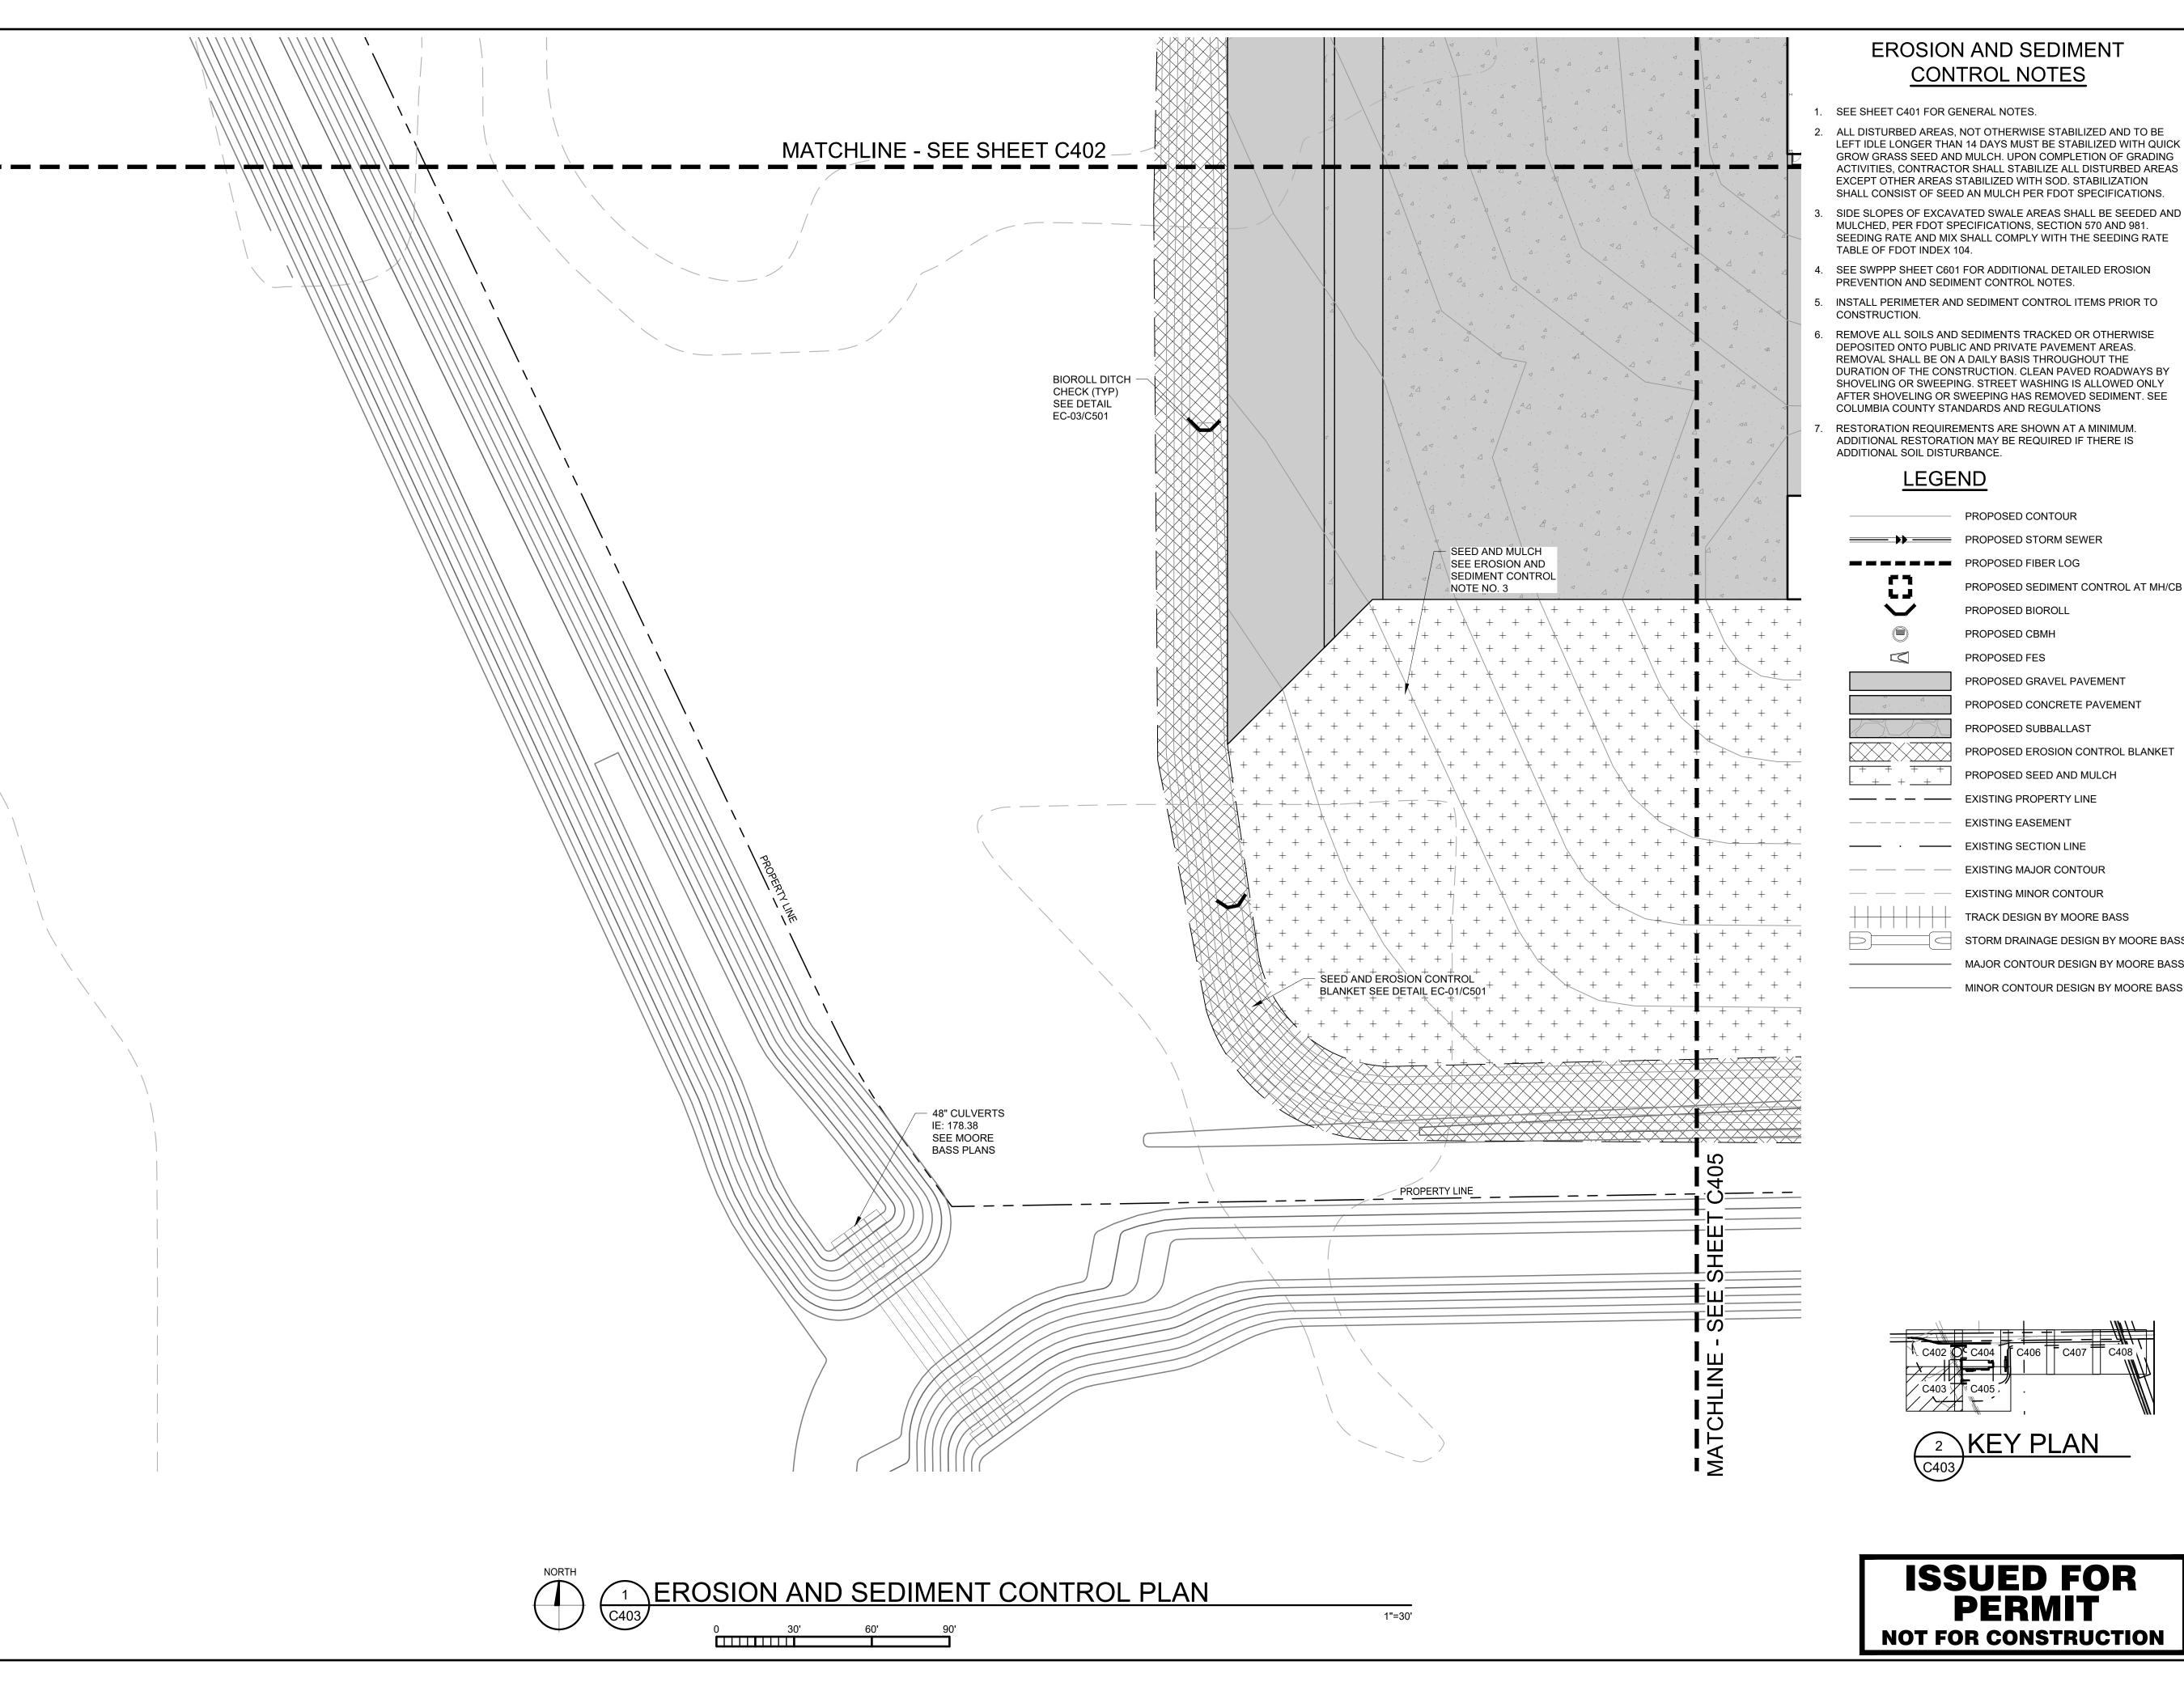
ſ	DATE.		DDAMAL	
Н	DATE:		DRAWN:	
П	10/19/2023		RCQ	
	DESIGNED:	CHECKE	D:	APPROV
	AJR	ARL		MDM

DRAWING TITLE:

OVERALL EROSION AND SEDIMENT **CONTROL PLAN**

PROJECT NO: DRAWING NO: 230384 C401 SCALE: AS NOTED





- 1. SEE SHEET C401 FOR GENERAL NOTES.
- 2. ALL DISTURBED AREAS, NOT OTHERWISE STABILIZED AND TO BE LEFT IDLE LONGER THAN 14 DAYS MUST BE STABILIZED WITH QUICK GROW GRASS SEED AND MULCH. UPON COMPLETION OF GRADING ACTIVITIES, CONTRACTOR SHALL STABILIZE ALL DISTURBED AREAS EXCEPT OTHER AREAS STABILIZED WITH SOD. STABILIZATION SHALL CONSIST OF SEED AN MULCH PER FDOT SPECIFICATIONS.
- MULCHED, PER FDOT SPECIFICATIONS, SECTION 570 AND 981. SEEDING RATE AND MIX SHALL COMPLY WITH THE SEEDING RATE
- 4. SEE SWPPP SHEET C601 FOR ADDITIONAL DETAILED EROSION PREVENTION AND SEDIMENT CONTROL NOTES.
- 5. INSTALL PERIMETER AND SEDIMENT CONTROL ITEMS PRIOR TO
- 6. REMOVE ALL SOILS AND SEDIMENTS TRACKED OR OTHERWISE DEPOSITED ONTO PUBLIC AND PRIVATE PAVEMENT AREAS. REMOVAL SHALL BE ON A DAILY BASIS THROUGHOUT THE DURATION OF THE CONSTRUCTION. CLEAN PAVED ROADWAYS BY SHOVELING OR SWEEPING. STREET WASHING IS ALLOWED ONLY AFTER SHOVELING OR SWEEPING HAS REMOVED SEDIMENT. SEE COLUMBIA COUNTY STANDARDS AND REGULATIONS
- RESTORATION REQUIREMENTS ARE SHOWN AT A MINIMUM. ADDITIONAL RESTORATION MAY BE REQUIRED IF THERE IS ADDITIONAL SOIL DISTURBANCE.

PROPOSED CONTOUR PROPOSED STORM SEWER PROPOSED FIBER LOG PROPOSED SEDIMENT CONTROL AT MH/CB PROPOSED BIOROLL PROPOSED CBMH PROPOSED FES PROPOSED GRAVEL PAVEMENT PROPOSED CONCRETE PAVEMENT PROPOSED SUBBALLAST ROSION CONTROL BLANKET

	PROPOSED EROSION CONTRO
+ + + + + + + + + + + + + + + + + + +	PROPOSED SEED AND MULCH
	EXISTING PROPERTY LINE
	EXISTING EASEMENT
·	EXISTING SECTION LINE
	EXISTING MAJOR CONTOUR
	EXISTING MINOR CONTOUR

OR CONTOUR OR CONTOUR TRACK DESIGN BY MOORE BASS STORM DRAINAGE DESIGN BY MOORE BASS

MAJOR CONTOUR DESIGN BY MOORE BASS

² KEY PLAN

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PROJECT:

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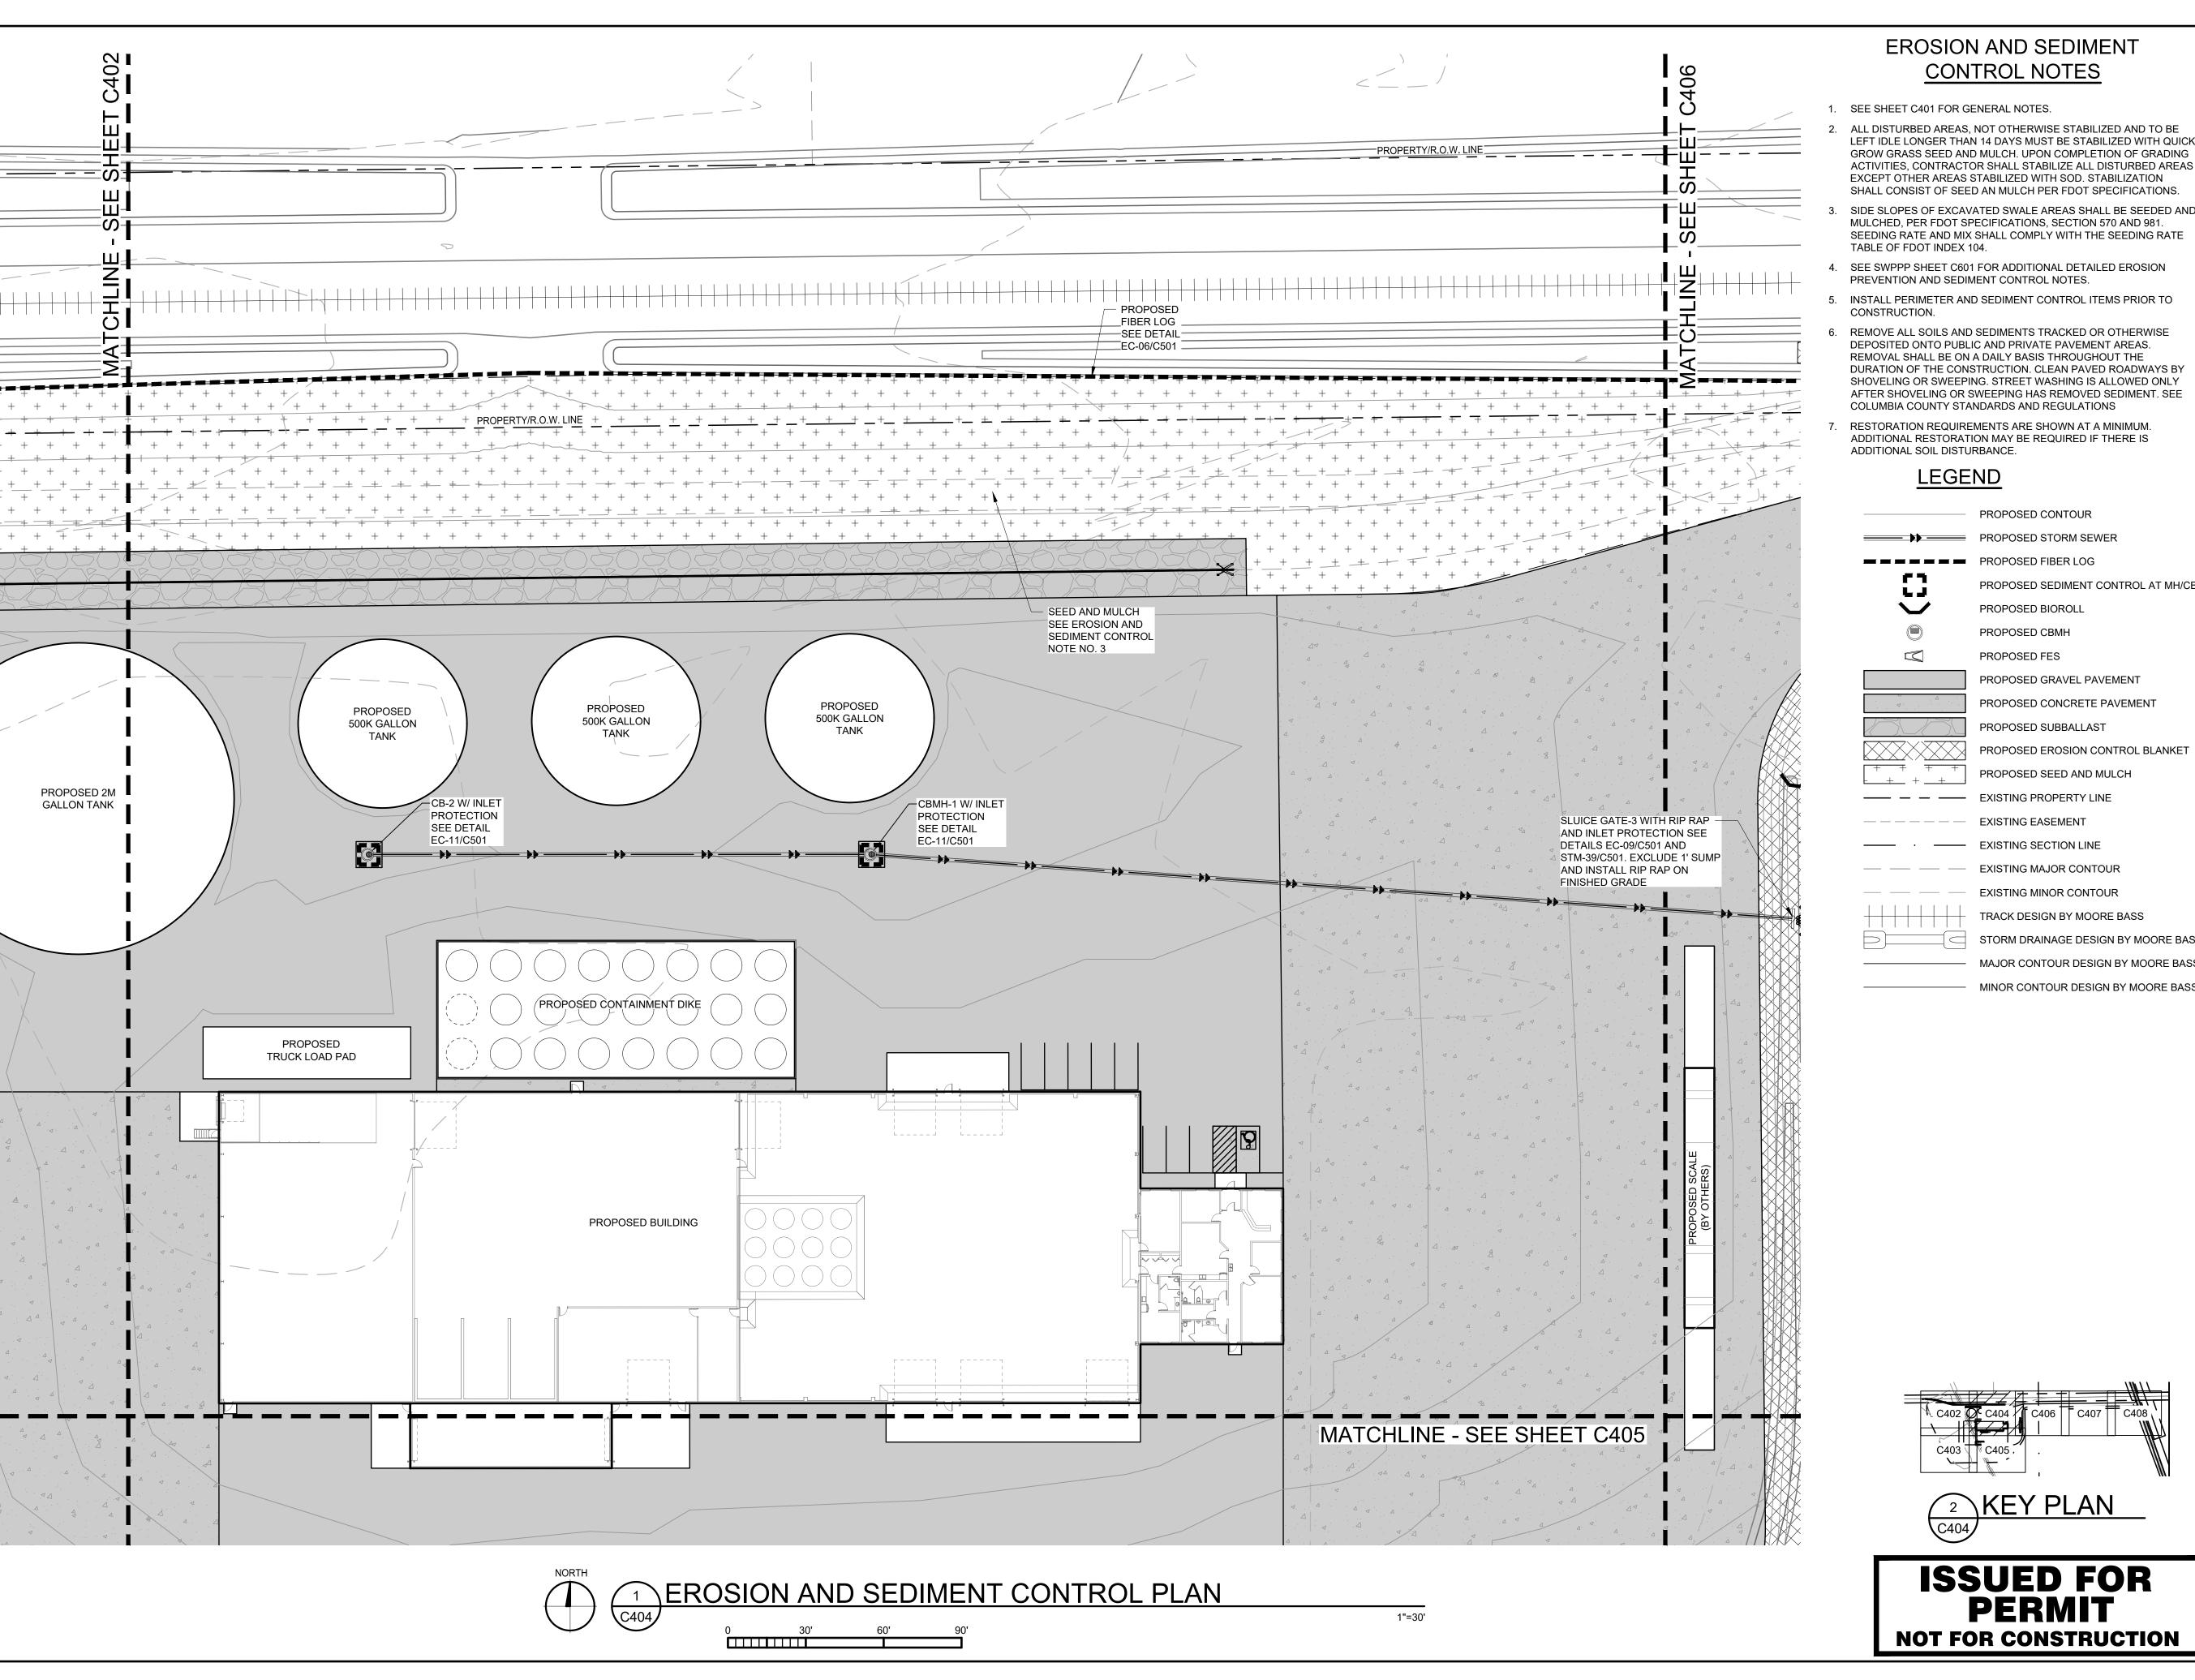
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DATE: DRAWN: RCQ 10/19/2023 APPROVED: DESIGNED: CHECKED: AJR ARL MDM

DRAWING TITLE:


EROSION AND SEDIMENT CONTROL PLAN


PROJECT NO: DRAWING NO: 230384 C403 SCALE: AS NOTED



- 1. SEE SHEET C401 FOR GENERAL NOTES.
- ALL DISTURBED AREAS, NOT OTHERWISE STABILIZED AND TO BE LEFT IDLE LONGER THAN 14 DAYS MUST BE STABILIZED WITH QUICK GROW GRASS SEED AND MULCH. UPON COMPLETION OF GRADING ACTIVITIES, CONTRACTOR SHALL STABILIZE ALL DISTURBED AREAS EXCEPT OTHER AREAS STABILIZED WITH SOD. STABILIZATION SHALL CONSIST OF SEED AN MULCH PER FDOT SPECIFICATIONS.
- MULCHED, PER FDOT SPECIFICATIONS, SECTION 570 AND 981. SEEDING RATE AND MIX SHALL COMPLY WITH THE SEEDING RATE TABLE OF FDOT INDEX 104.
- 4. SEE SWPPP SHEET C601 FOR ADDITIONAL DETAILED EROSION PREVENTION AND SEDIMENT CONTROL NOTES.
- 5. INSTALL PERIMETER AND SEDIMENT CONTROL ITEMS PRIOR TO
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LEGEND



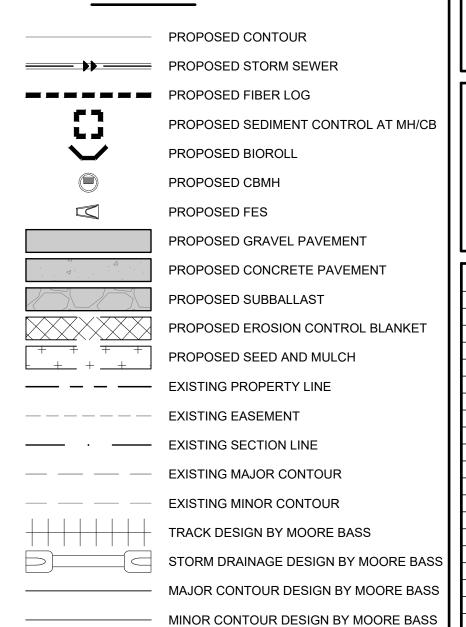

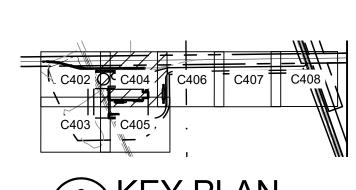

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Project # 230384

Plymouth, MN 55441



PROJECT:

NEW LIQUID FERTILIZER FACILITY LAKE CITY, FL

NO	DATE	ISSUE/REVISION	BY	
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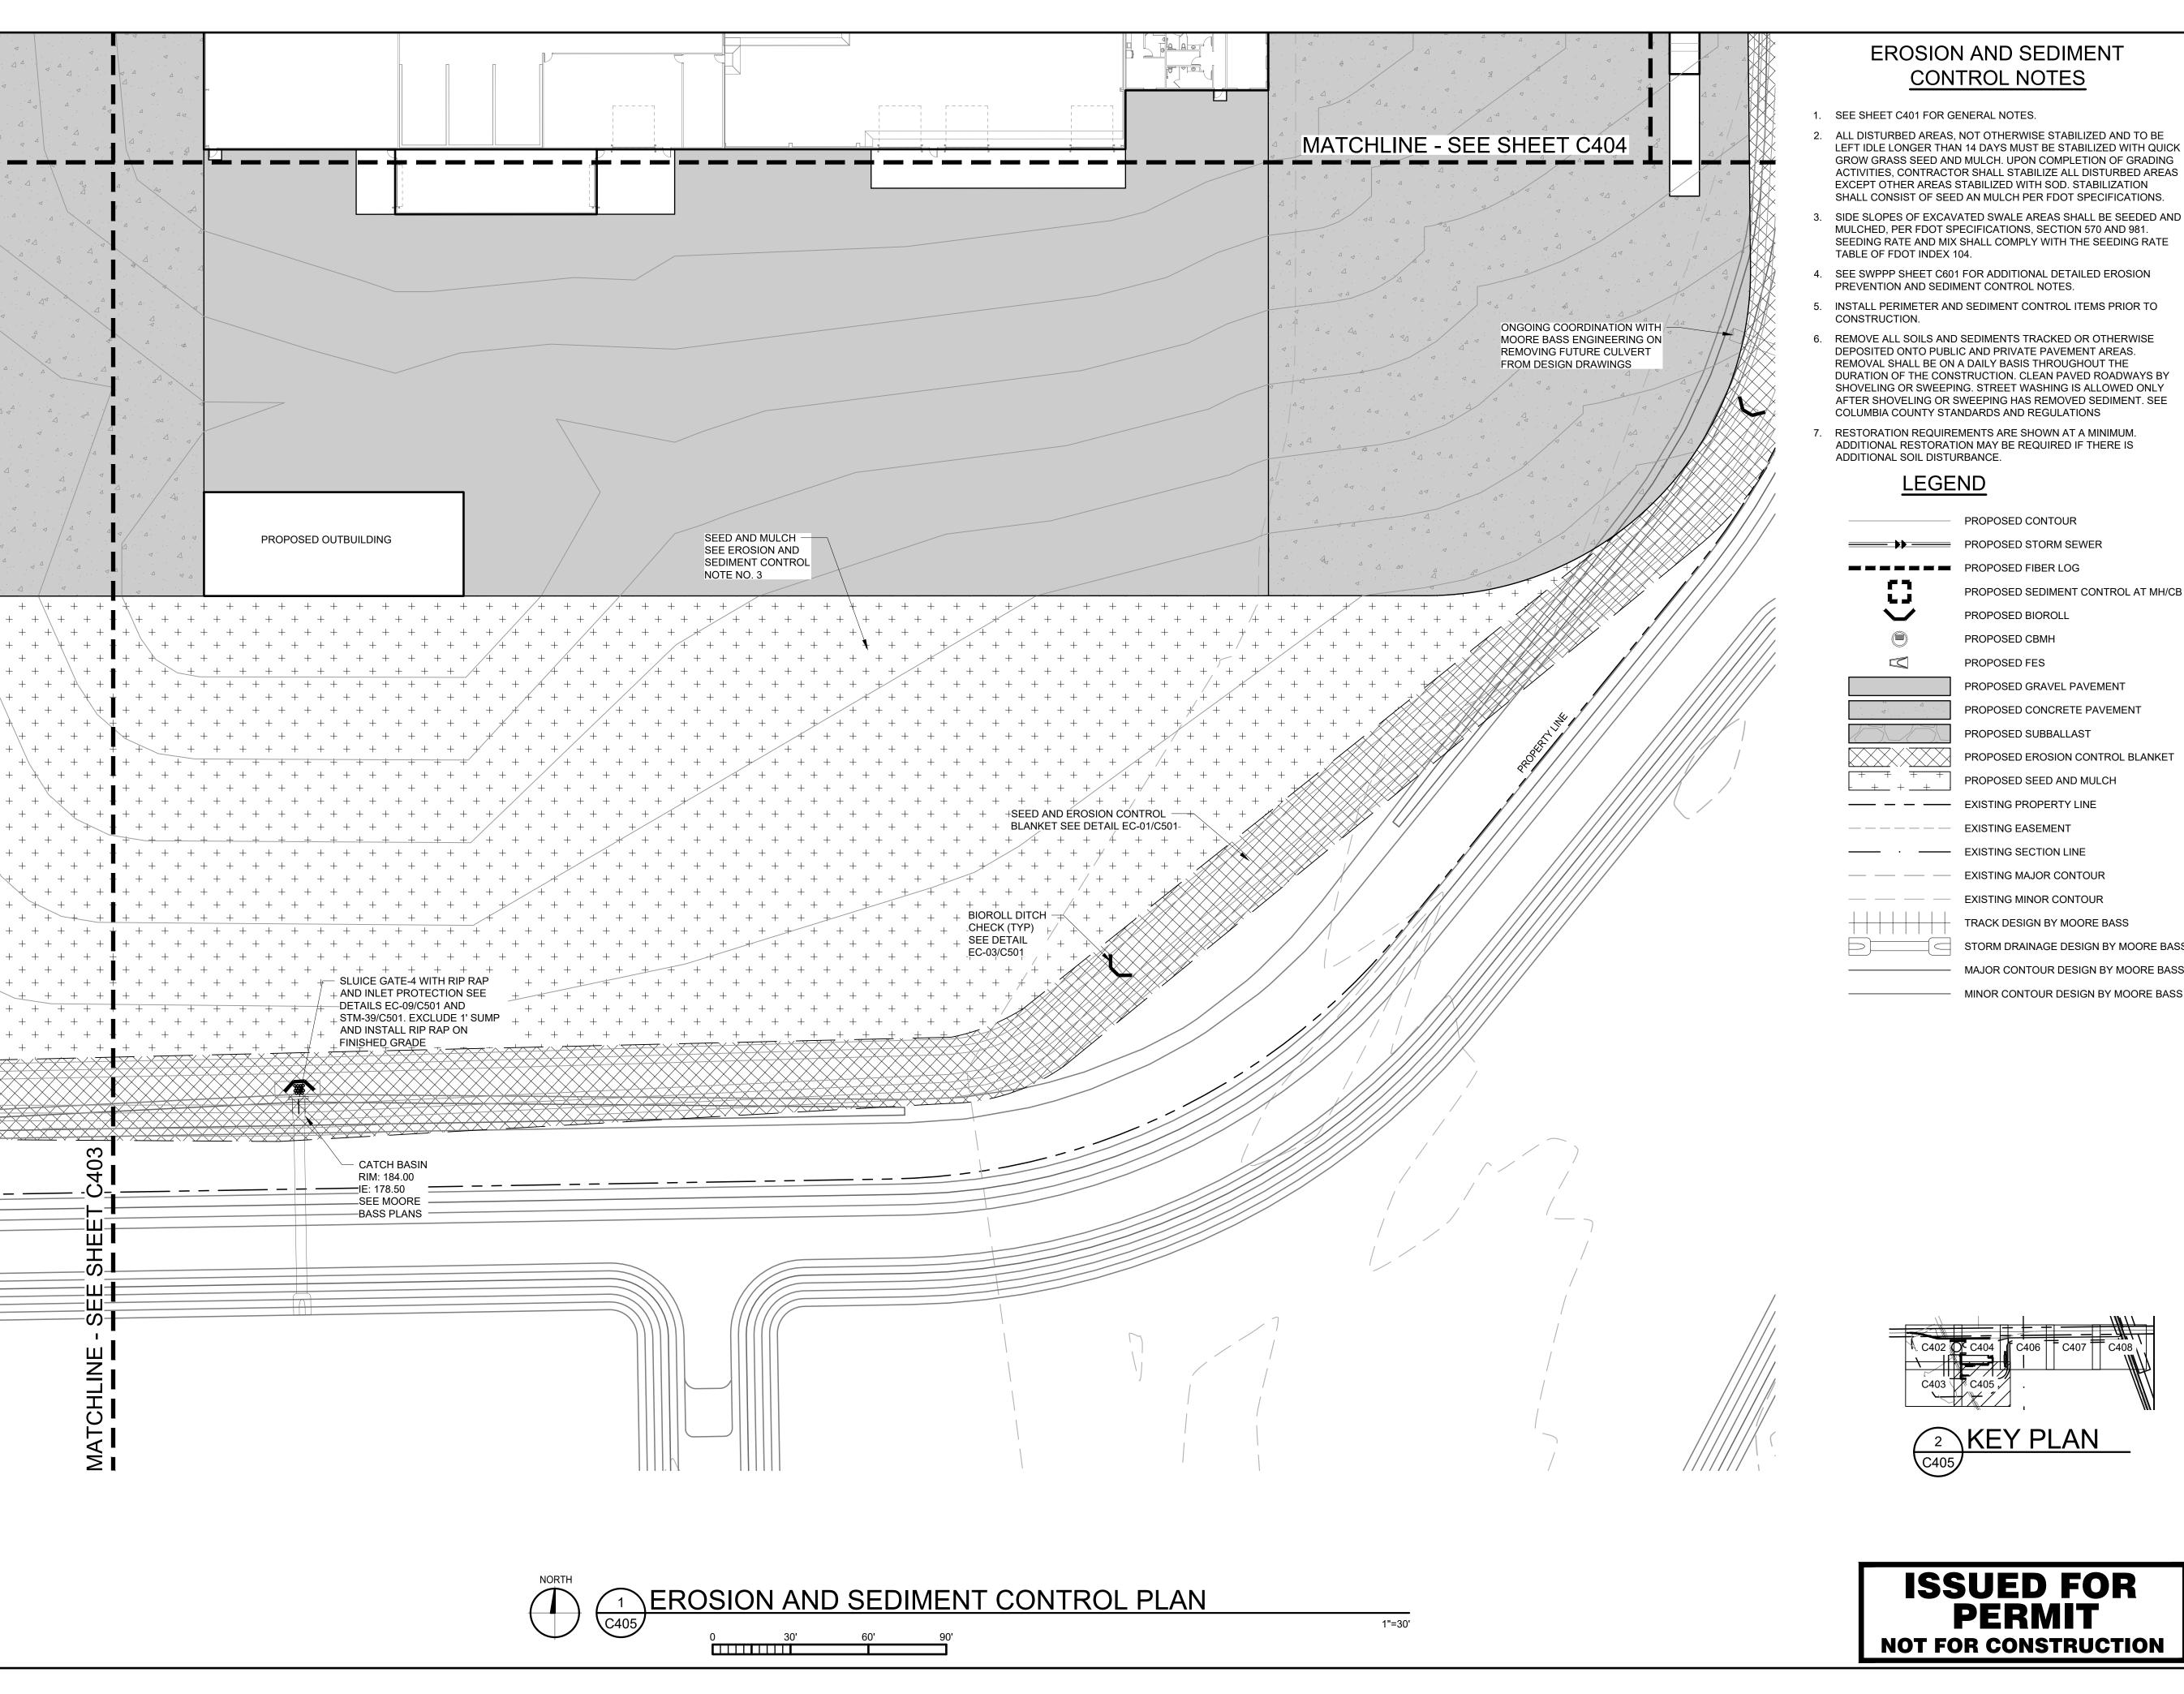
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DATE: 10/19/2023		DRAWN: RCQ	
DESIGNED: AJR	CHECKE ARL	ED:	APPROVED MDM

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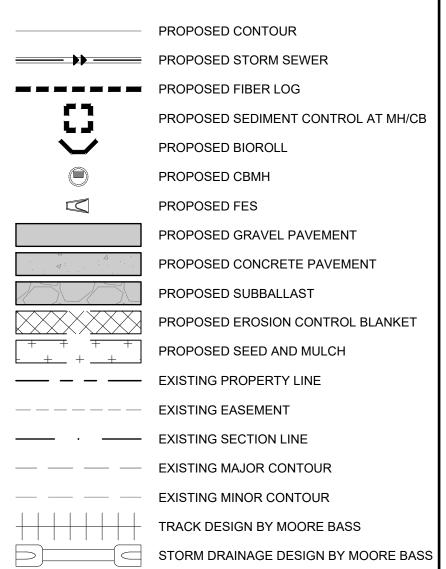
EROSION AND SEDIMENT CONTROL PLAN


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	PROJECT NO:	DRAWING NO:
	230384	C404
	SCALE:	U404
	AS NOTED	



- 1. SEE SHEET C401 FOR GENERAL NOTES.
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- 4. SEE SWPPP SHEET C601 FOR ADDITIONAL DETAILED EROSION PREVENTION AND SEDIMENT CONTROL NOTES.
- 5. INSTALL PERIMETER AND SEDIMENT CONTROL ITEMS PRIOR TO
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NEW LIQUID FERTILIZER FACILITY LAKE CITY, FL

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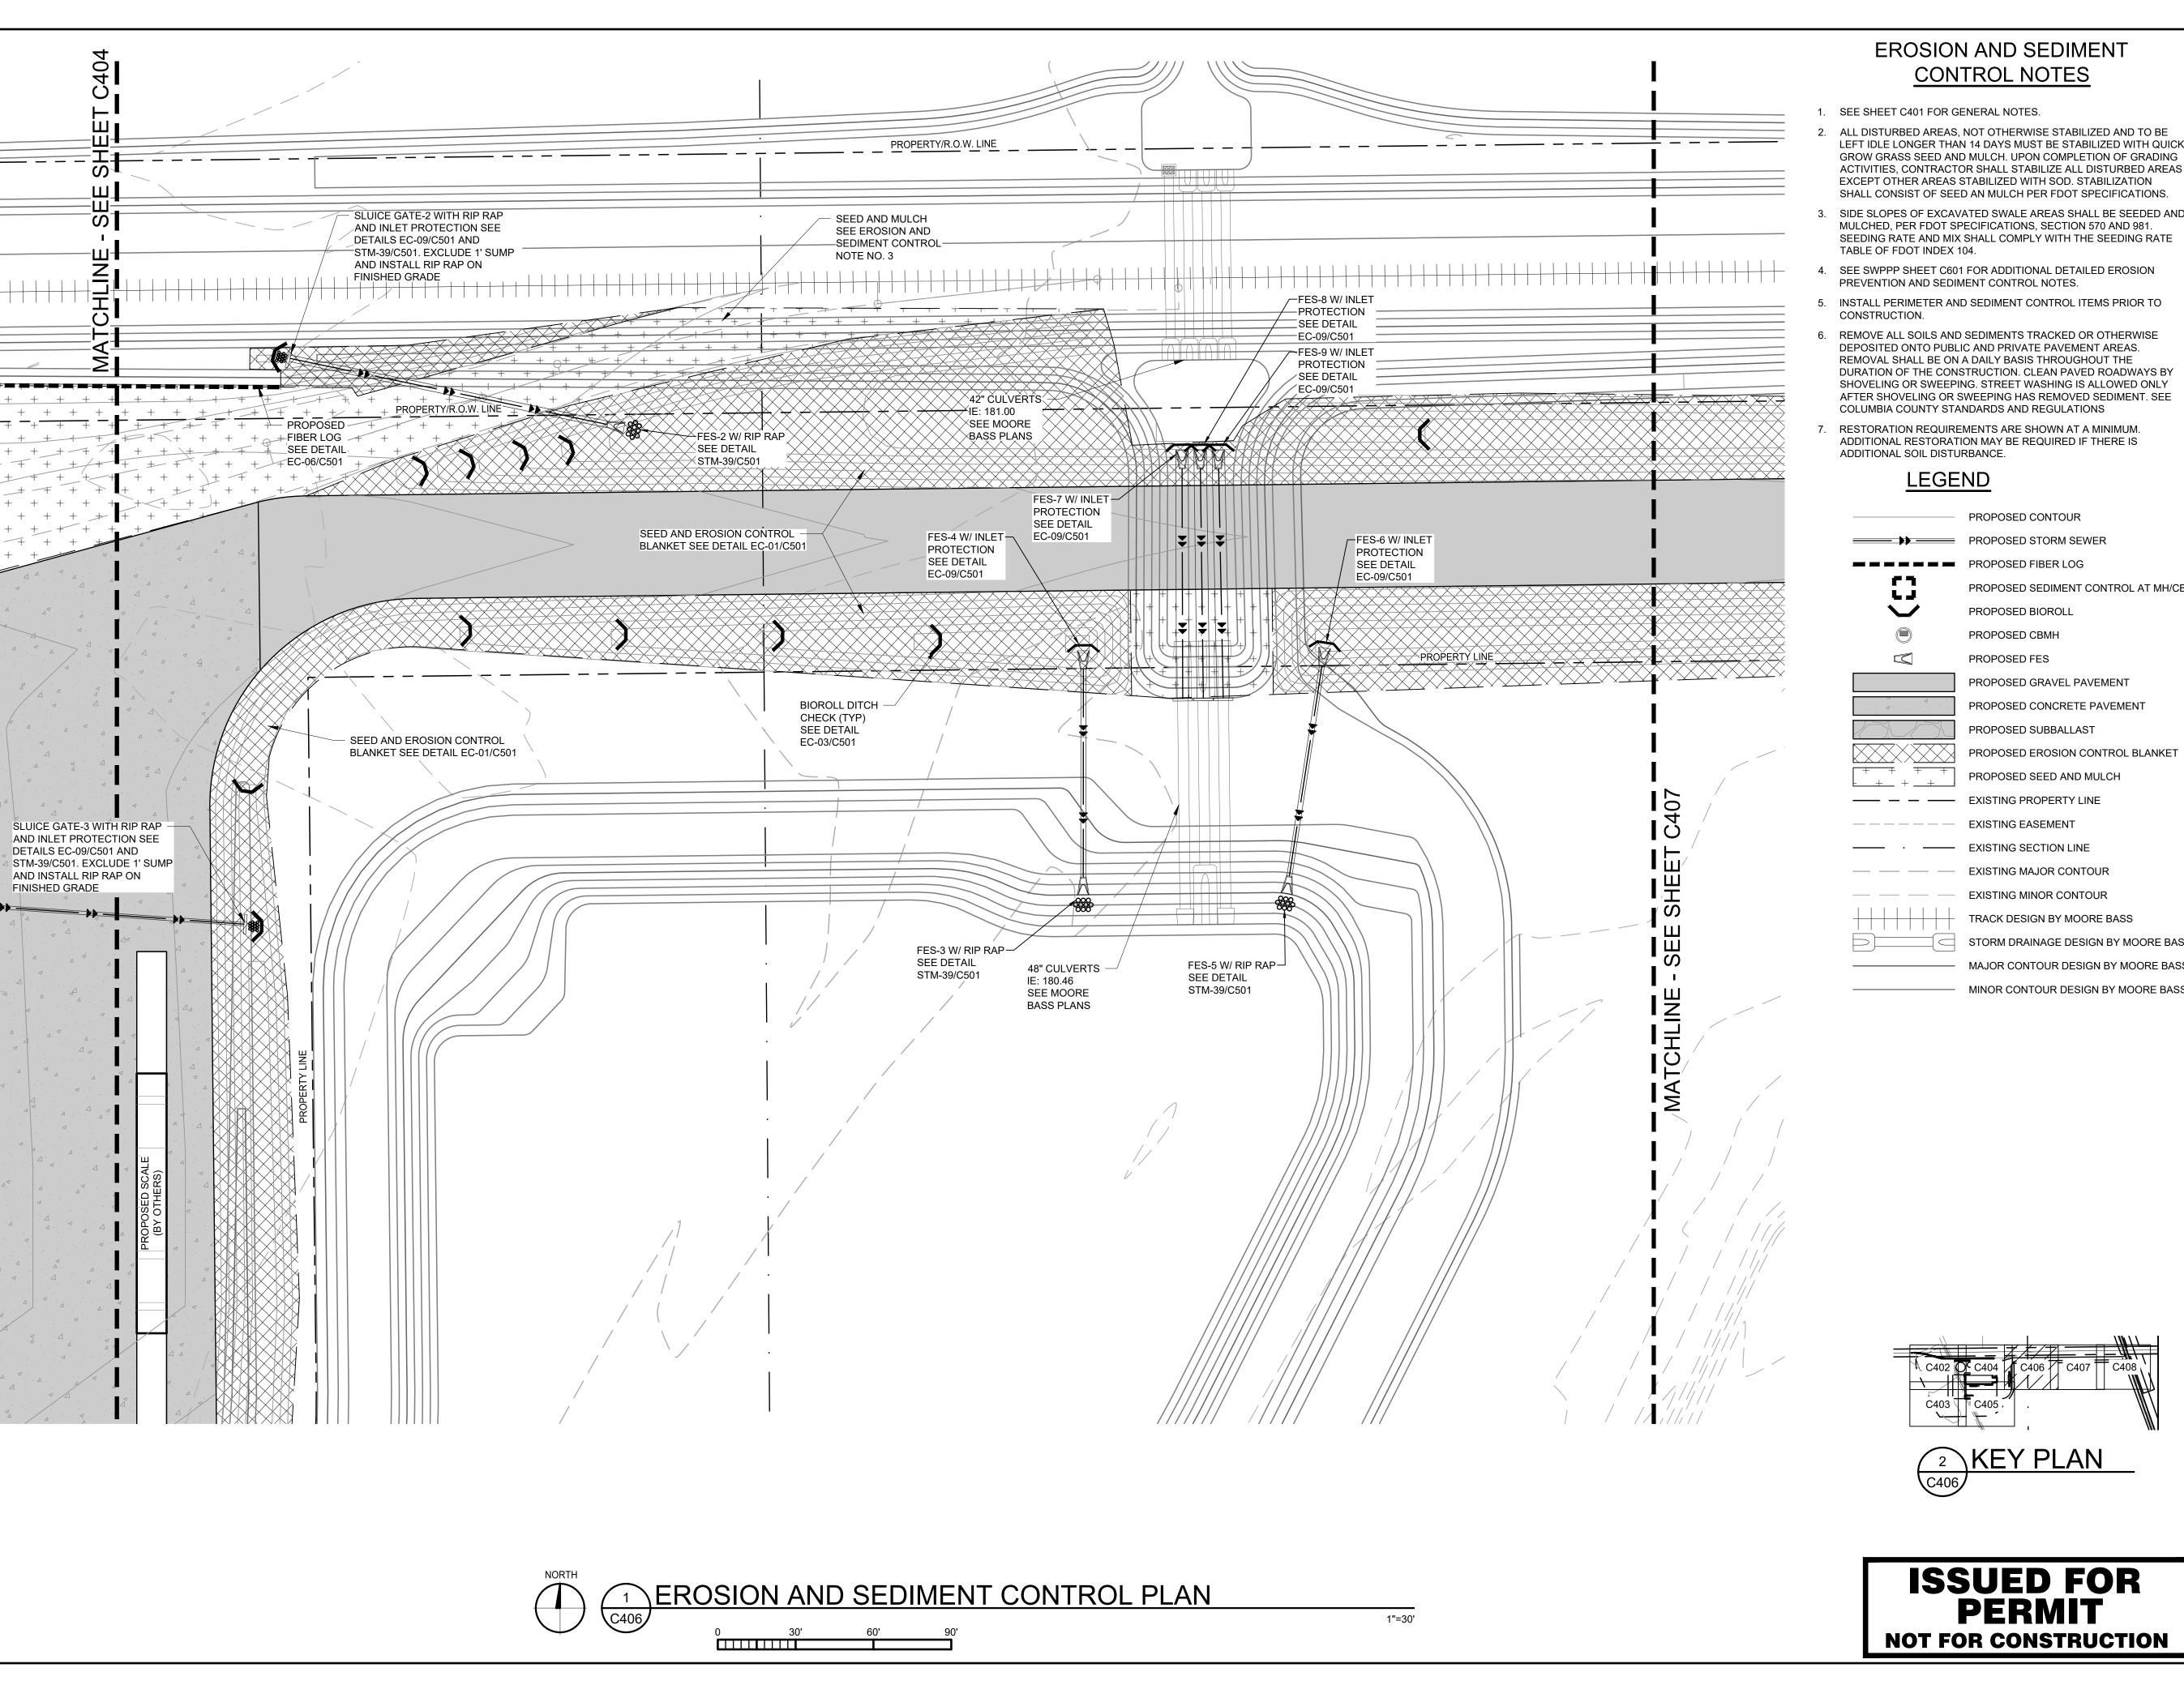
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	DESIGNED: AJR	CHECKE ARL	ED:	APPROV MDM

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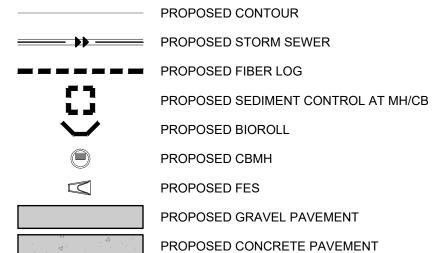
EROSION AND SEDIMENT CONTROL PLAN

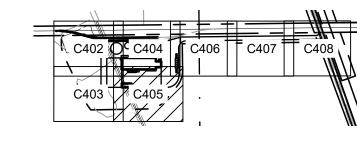PROJECT NO: DRAWING NO: 230384 C405 SCALE: AS NOTED




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LEGEND




	PROPOSED SUBBALLAST
	PROPOSED EROSION CONTROL BLANKE
+ + + + + .	PROPOSED SEED AND MULCH
	EXISTING PROPERTY LINE
	EXISTING EASEMENT

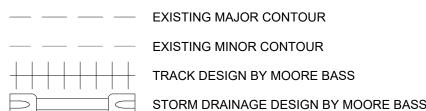

—— EXISTING SECTION LINE

MINOR CONTOUR DESIGN BY MOORE BASS

MAJOR CONTOUR DESIGN BY MOORE BASS

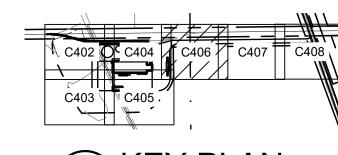



ISSUED FOR PERMIT NOT FOR CONSTRUCTION



Project # 230384

Plymouth, MN 55441

PROJECT:



NEW LIQUID FERTILIZER FACILITY LAKE CITY, FL

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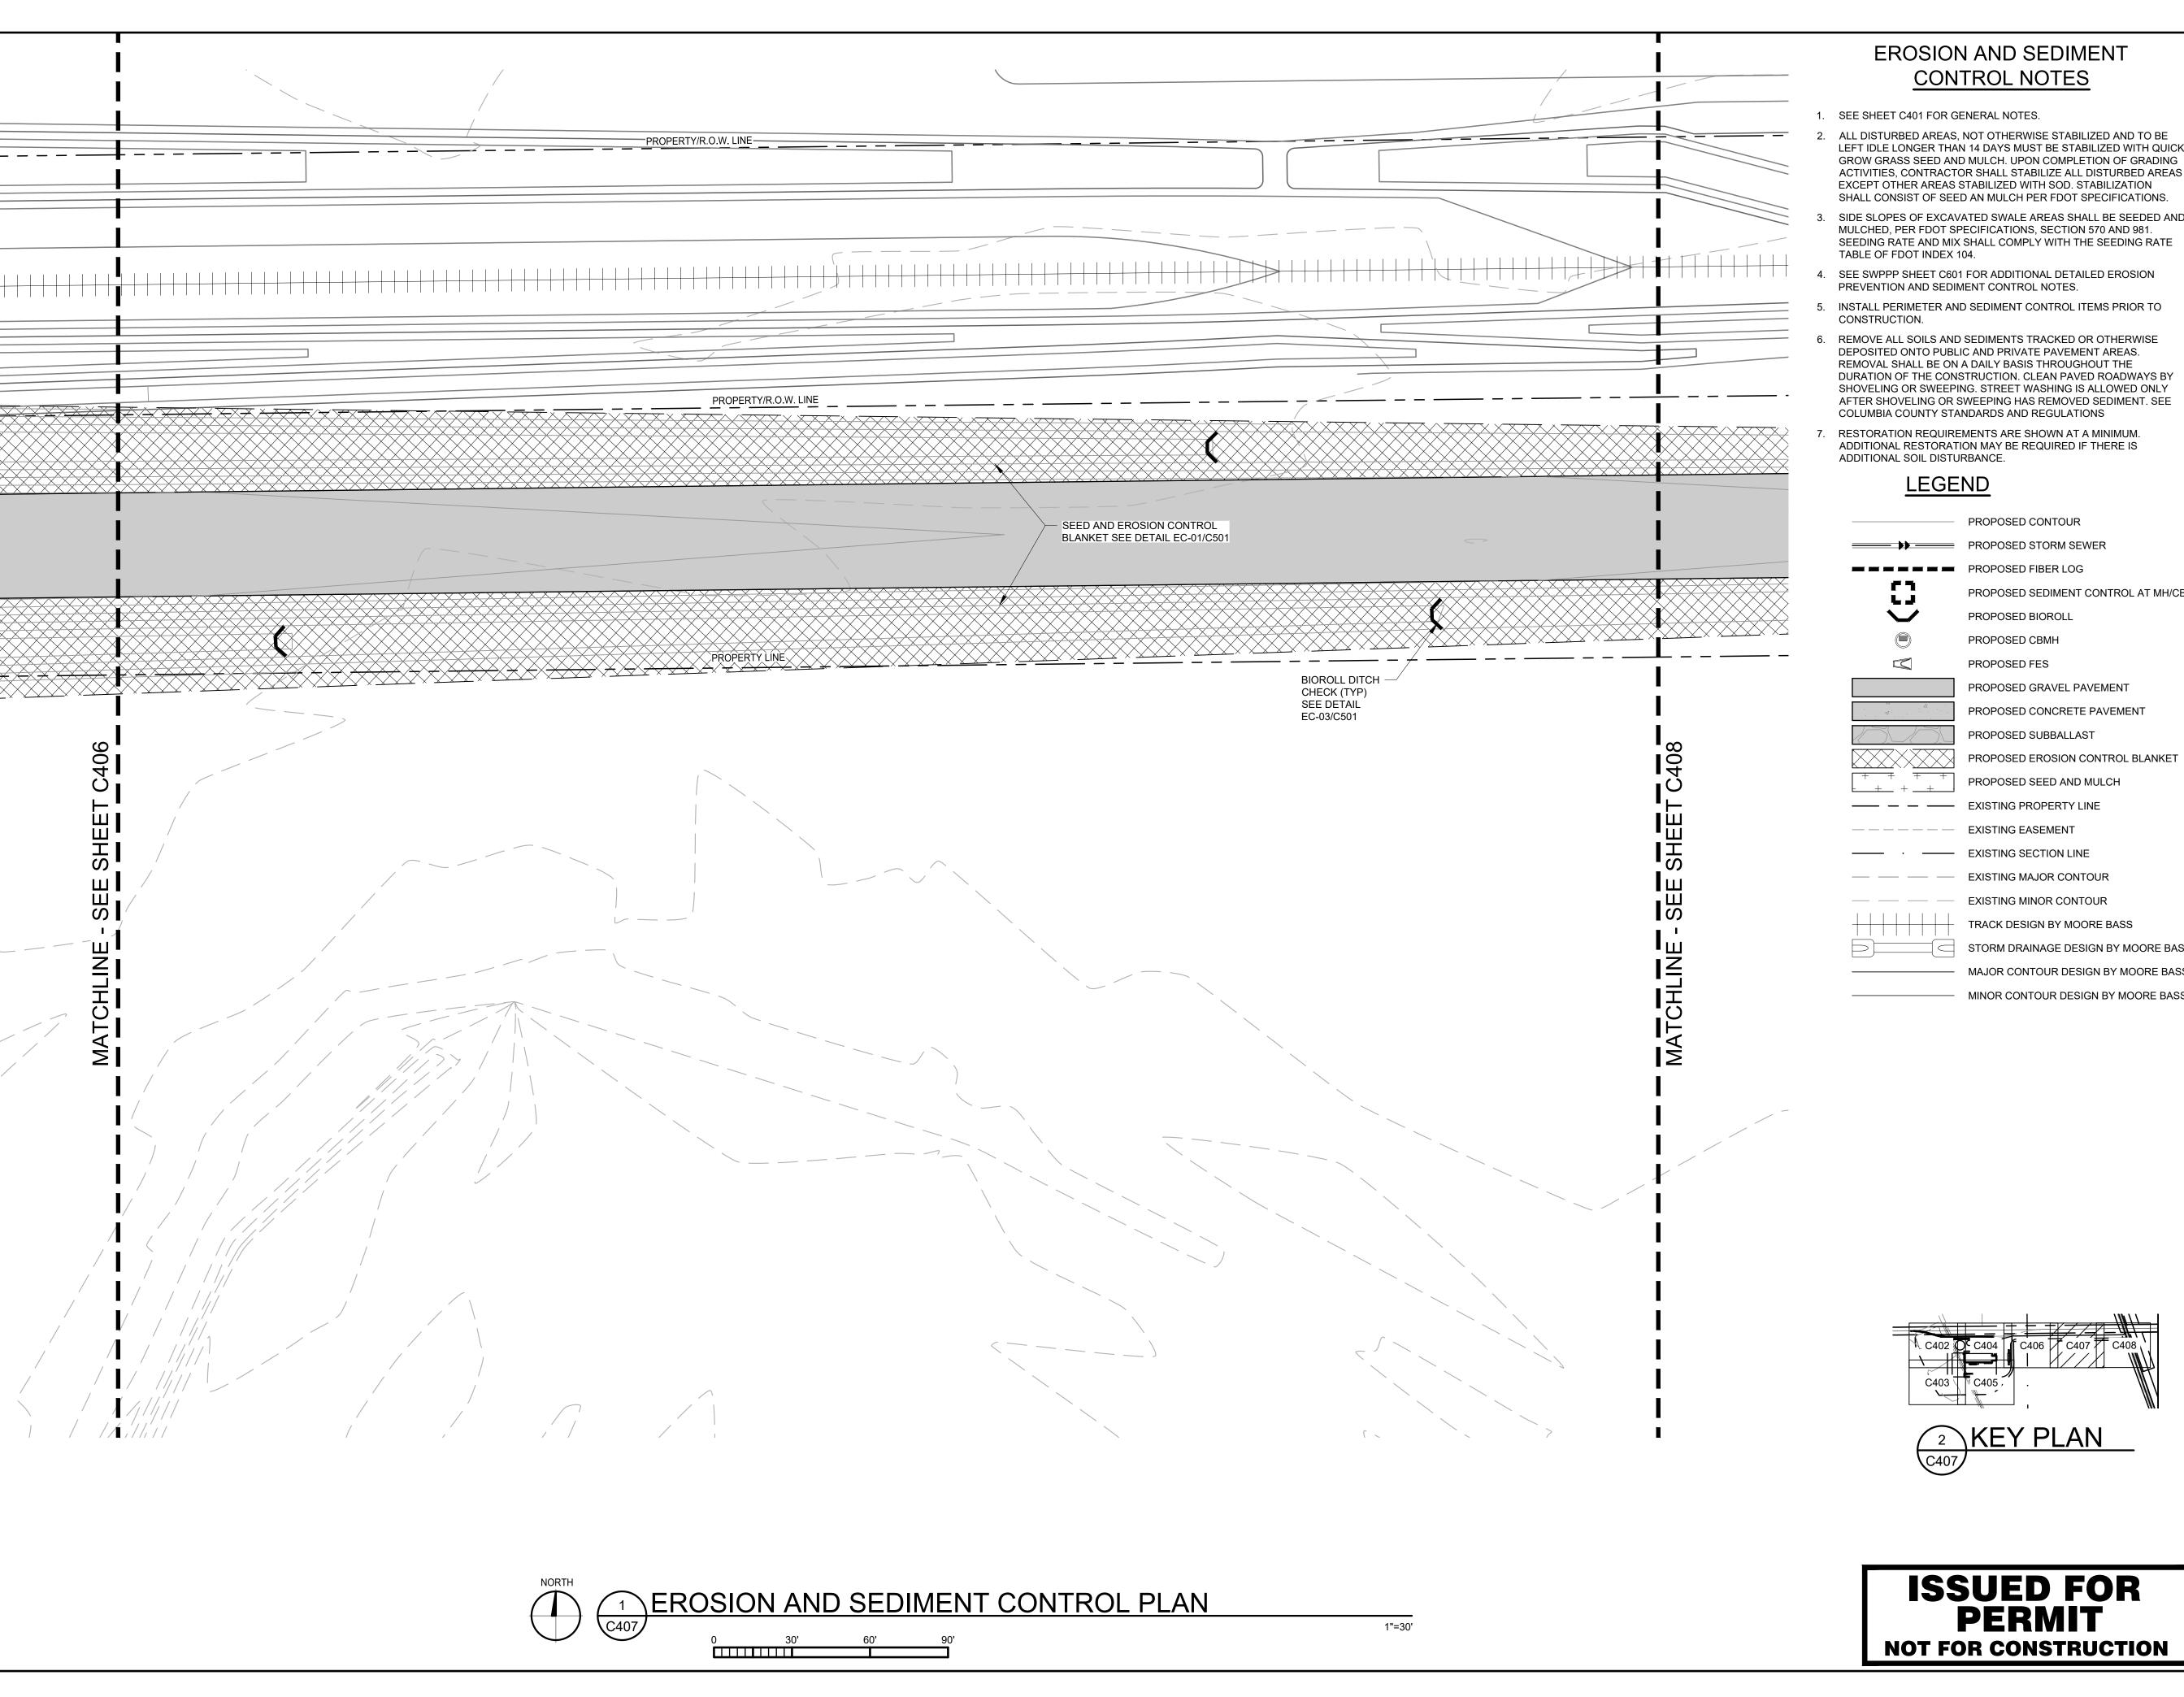
DATE: 10/19/2023	DRAWN: RCQ	
DESIGNED:	CHECKED:	APPROVED:
AJR	ARL	MDM

any electronic copies.

DRAWING TITLE:


EROSION AND SEDIMENT CONTROL PLAN

PROJECT NO:	DRAWING NO:
230384	C406
SCALE:	─ C406
AS NOTED	




- 1. SEE SHEET C401 FOR GENERAL NOTES.
- ALL DISTURBED AREAS, NOT OTHERWISE STABILIZED AND TO BE LEFT IDLE LONGER THAN 14 DAYS MUST BE STABILIZED WITH QUICK GROW GRASS SEED AND MULCH. UPON COMPLETION OF GRADING ACTIVITIES, CONTRACTOR SHALL STABILIZE ALL DISTURBED AREAS EXCEPT OTHER AREAS STABILIZED WITH SOD. STABILIZATION SHALL CONSIST OF SEED AN MULCH PER FDOT SPECIFICATIONS.
- MULCHED, PER FDOT SPECIFICATIONS, SECTION 570 AND 981. SEEDING RATE AND MIX SHALL COMPLY WITH THE SEEDING RATE TABLE OF FDOT INDEX 104.
- 4. SEE SWPPP SHEET C601 FOR ADDITIONAL DETAILED EROSION PREVENTION AND SEDIMENT CONTROL NOTES.
- INSTALL PERIMETER AND SEDIMENT CONTROL ITEMS PRIOR TO
- REMOVE ALL SOILS AND SEDIMENTS TRACKED OR OTHERWISE DEPOSITED ONTO PUBLIC AND PRIVATE PAVEMENT AREAS. REMOVAL SHALL BE ON A DAILY BASIS THROUGHOUT THE DURATION OF THE CONSTRUCTION. CLEAN PAVED ROADWAYS BY SHOVELING OR SWEEPING. STREET WASHING IS ALLOWED ONLY AFTER SHOVELING OR SWEEPING HAS REMOVED SEDIMENT. SEE COLUMBIA COUNTY STANDARDS AND REGULATIONS
- RESTORATION REQUIREMENTS ARE SHOWN AT A MINIMUM. ADDITIONAL RESTORATION MAY BE REQUIRED IF THERE IS ADDITIONAL SOIL DISTURBANCE.

LEGEND

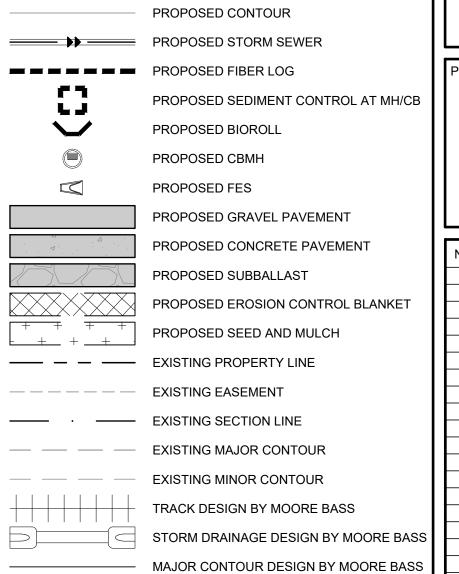

MINOR CONTOUR DESIGN BY MOORE BASS

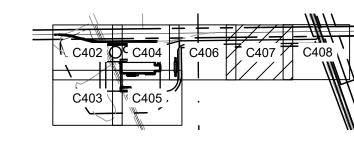



ISSUED FOR PERMIT NOT FOR CONSTRUCTION



2300 Berkshire Lane N, Suite 200 www.vaaeng.com Plymouth, MN 55441 Project # 230384



PROJECT:

CERTIFICATION:

NEW LIQUID FERTILIZER FACILITY LAKE CITY, FL

NO	DATE	ISSUE/REVISION	BY
Α	10/19/2023	DESIGN DEVELOPMENT	RCQ
В	12/11/2023	ISSUED FOR PERMIT	RCQ

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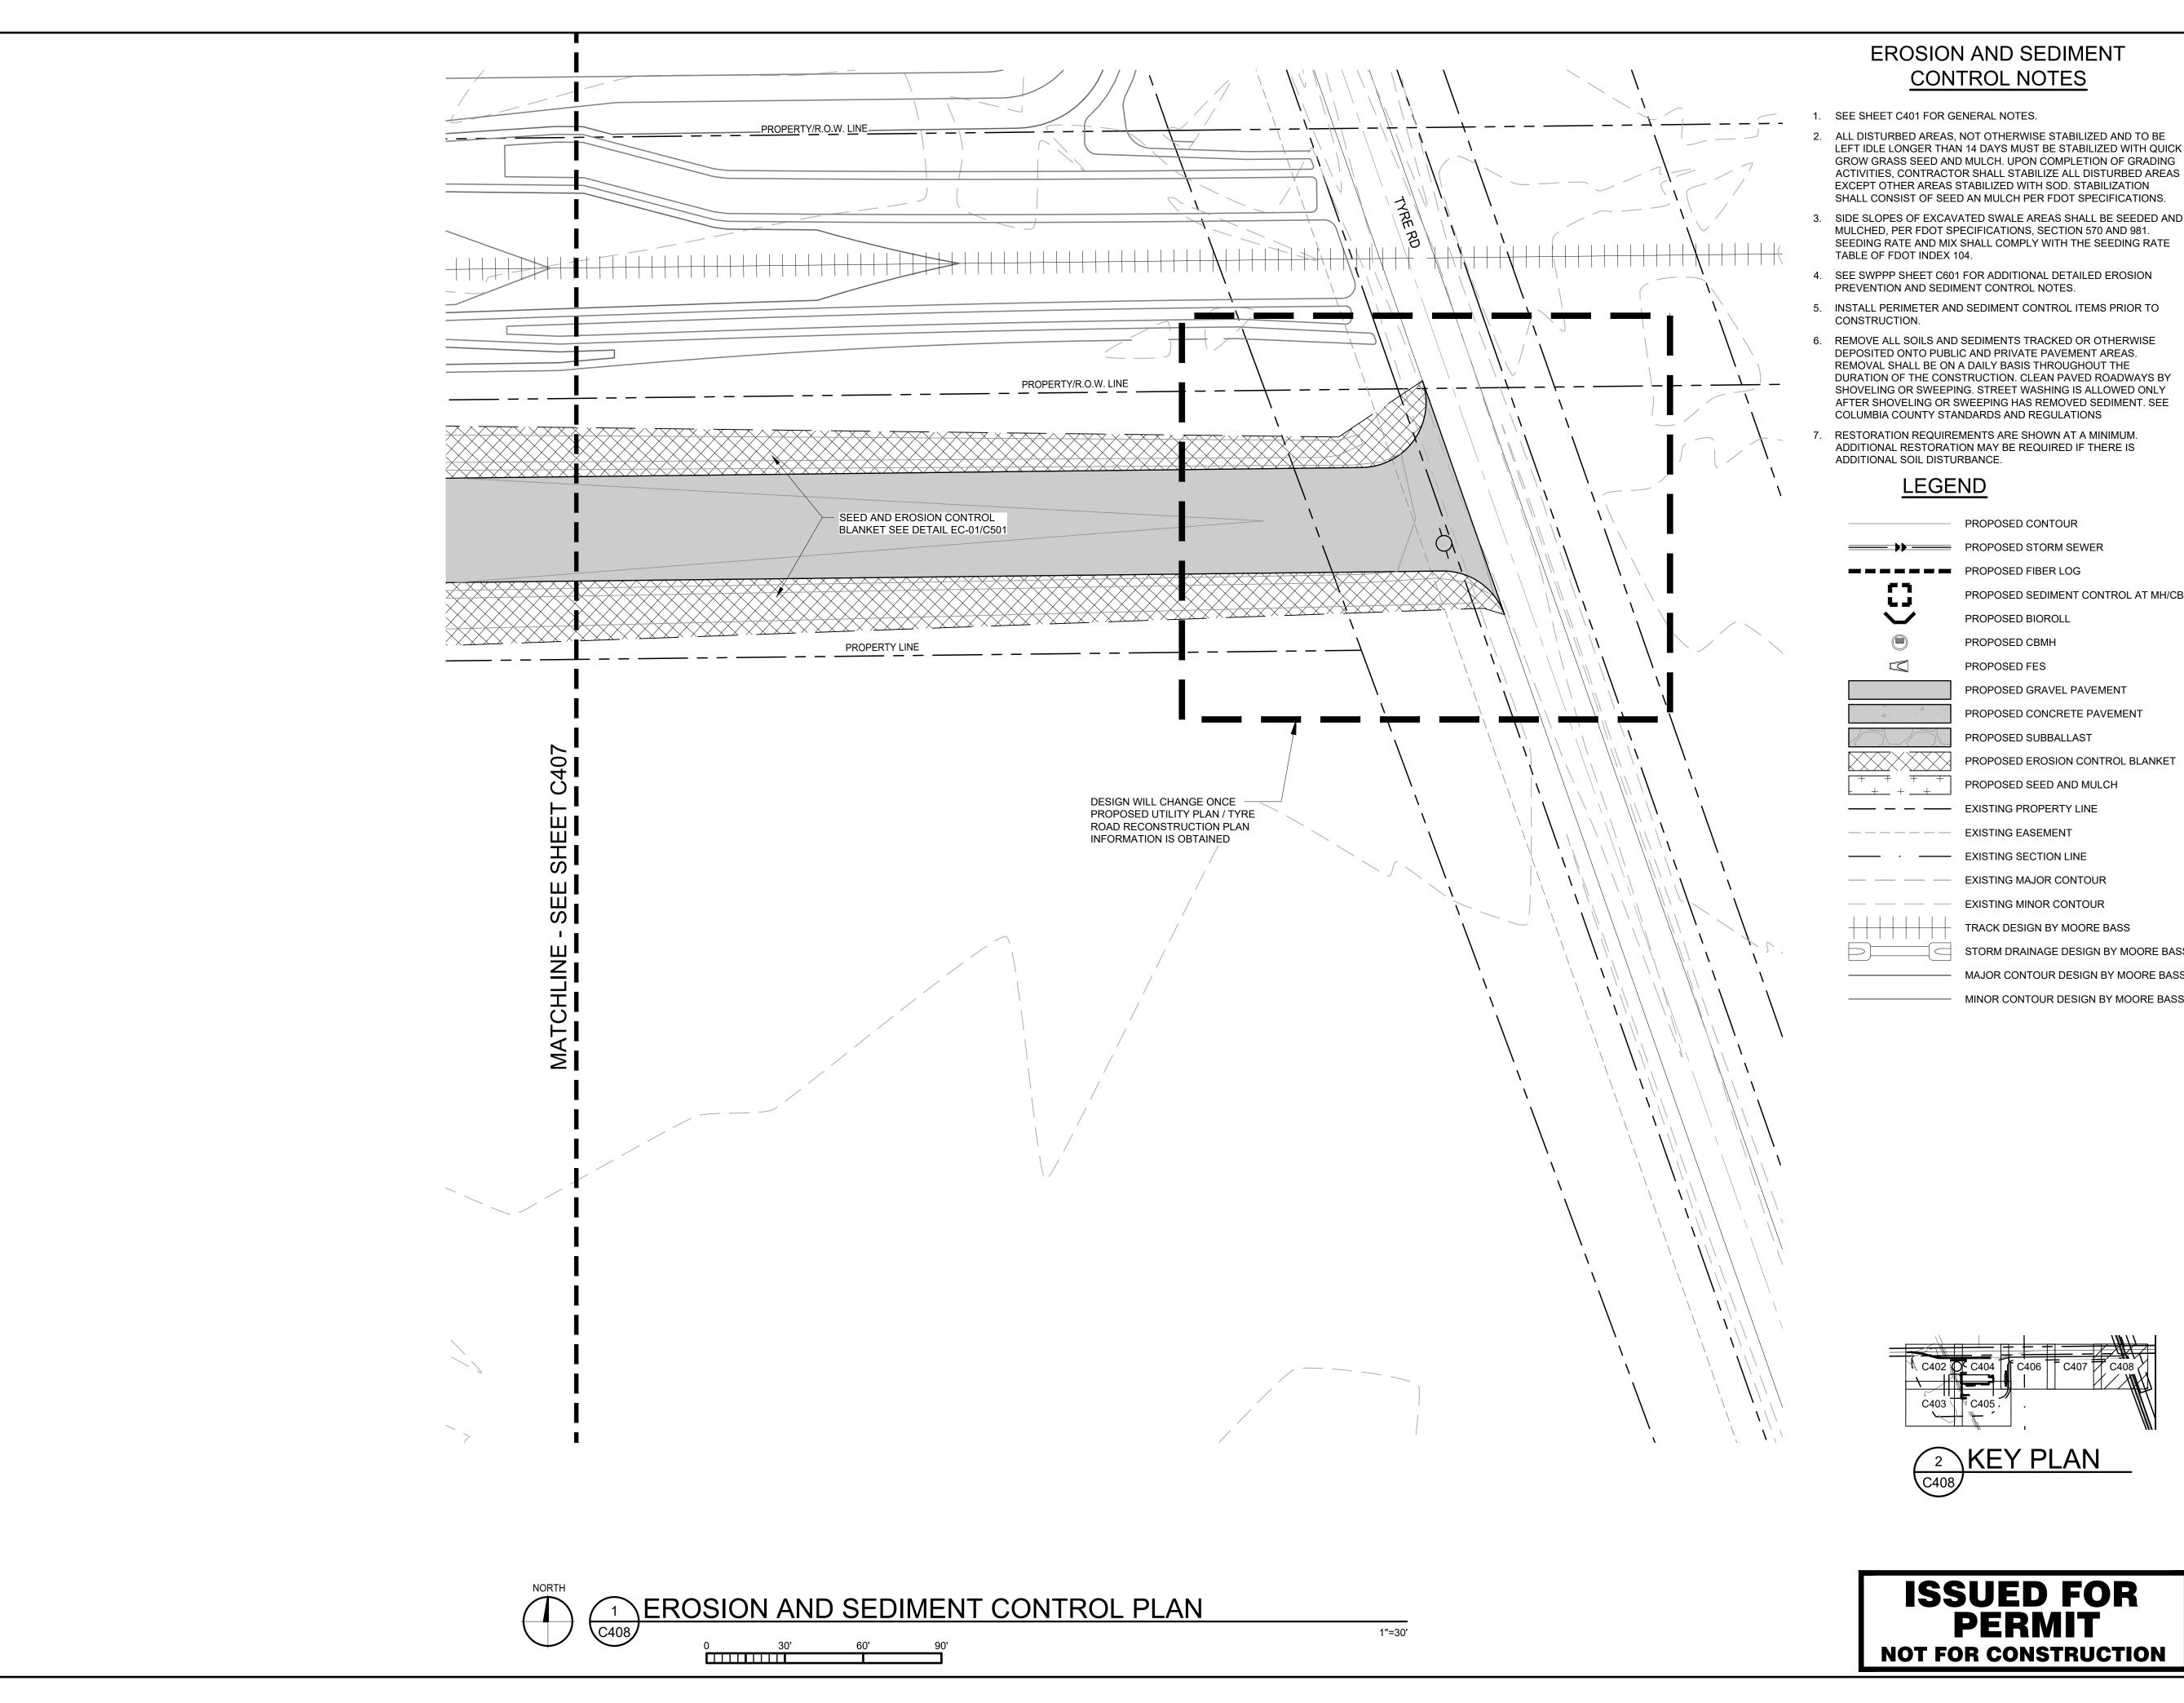
any electronic copies.

DATE: 10/19/2023		DRAWN: RCQ	
DESIGNED:	CHECKE	:D:	APPROVE
AJR	ARL		MDM

DRAWING TITLE:

EROSION AND SEDIMENT CONTROL PLAN

PROJECT NO:	DRAWING NO:
230384	C407
SCALE:	C407
AS NOTED	




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- MULCHED, PER FDOT SPECIFICATIONS, SECTION 570 AND 981. SEEDING RATE AND MIX SHALL COMPLY WITH THE SEEDING RATE TABLE OF FDOT INDEX 104.
- PREVENTION AND SEDIMENT CONTROL NOTES.
- 6. REMOVE ALL SOILS AND SEDIMENTS TRACKED OR OTHERWISE DEPOSITED ONTO PUBLIC AND PRIVATE PAVEMENT AREAS. REMOVAL SHALL BE ON A DAILY BASIS THROUGHOUT THE DURATION OF THE CONSTRUCTION. CLEAN PAVED ROADWAYS BY SHOVELING OR SWEEPING. STREET WASHING IS ALLOWED ONLY AFTER SHOVELING OR SWEEPING HAS REMOVED SEDIMENT. SEE
- RESTORATION REQUIREMENTS ARE SHOWN AT A MINIMUM. ADDITIONAL RESTORATION MAY BE REQUIRED IF THERE IS ADDITIONAL SOIL DISTURBANCE.

LEGEND

PROPOSED CONTOUR PROPOSED STORM SEWER PROPOSED FIBER LOG PROPOSED SEDIMENT CONTROL AT MH/CB PROPOSED BIOROLL PROPOSED CBMH PROPOSED FES PROPOSED GRAVEL PAVEMENT PROPOSED CONCRETE PAVEMENT PROPOSED SUBBALLAST PROPOSED EROSION CONTROL BLANKET PROPOSED SEED AND MULCH

—— EXISTING SECTION LINE EXISTING MAJOR CONTOUR EXISTING MINOR CONTOUR

STORM DRAINAGE DESIGN BY MOORE BASS MAJOR CONTOUR DESIGN BY MOORE BASS

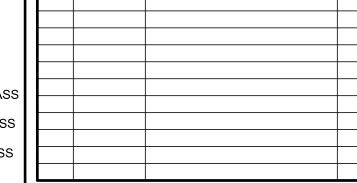

NEW LIQUID FERTILIZER FACILITY

LAKE CITY, FL

A 10/19/2023 DESIGN DEVELOPMENT B 12/11/2023 ISSUED FOR PERMIT

ISSUE/REVISION

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Plymouth, MN 55441

www.vaaeng.com

Project # 230384

CERTIFICATION:

PROJECT:

NO DATE

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DATE: DRAWN: RCQ 10/19/2023 DESIGNED: APPROVED: CHECKED: AJR

DRAWING TITLE:

EROSION AND SEDIMENT CONTROL PLAN

PROJECT NO: DRAWING NO: 230384 C408 SCALE: AS NOTED

2. ALL DISTURBED AREAS, NOT OTHERWISE STABILIZED AND TO BE


- 4. SEE SWPPP SHEET C601 FOR ADDITIONAL DETAILED EROSION
- 5. INSTALL PERIMETER AND SEDIMENT CONTROL ITEMS PRIOR TO
- COLUMBIA COUNTY STANDARDS AND REGULATIONS


—— — — EXISTING PROPERTY LINE — — — — EXISTING EASEMENT


TRACK DESIGN BY MOORE BASS

MINOR CONTOUR DESIGN BY MOORE BASS

² KEY PLAN

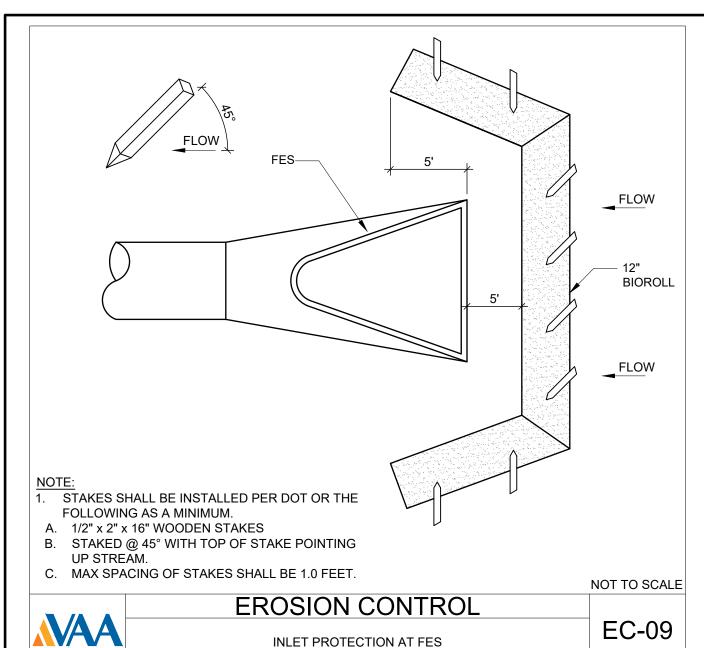

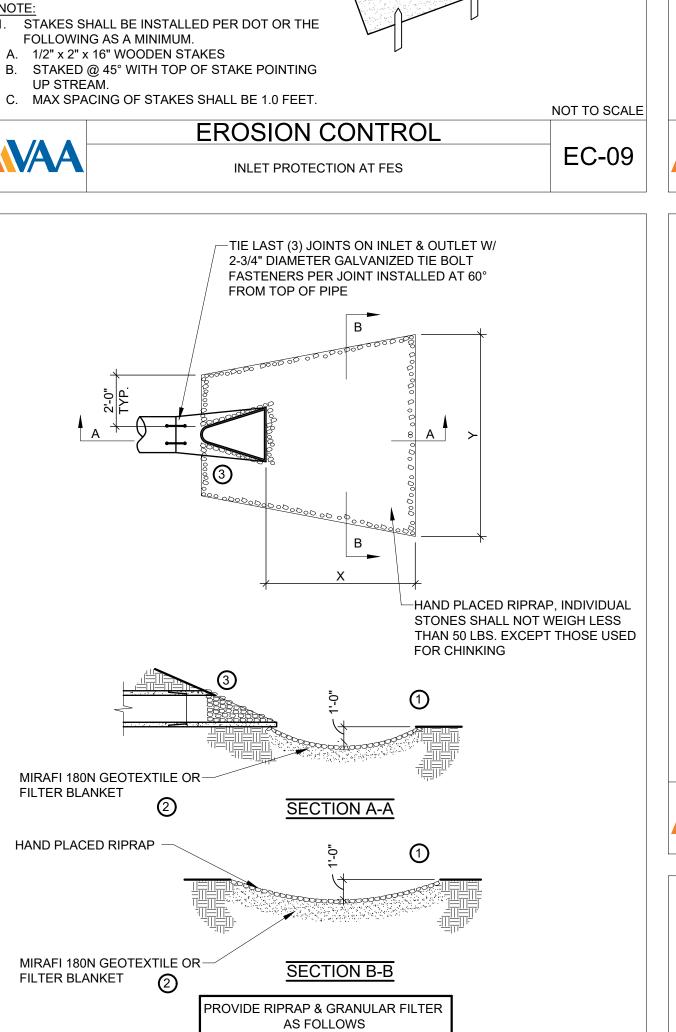

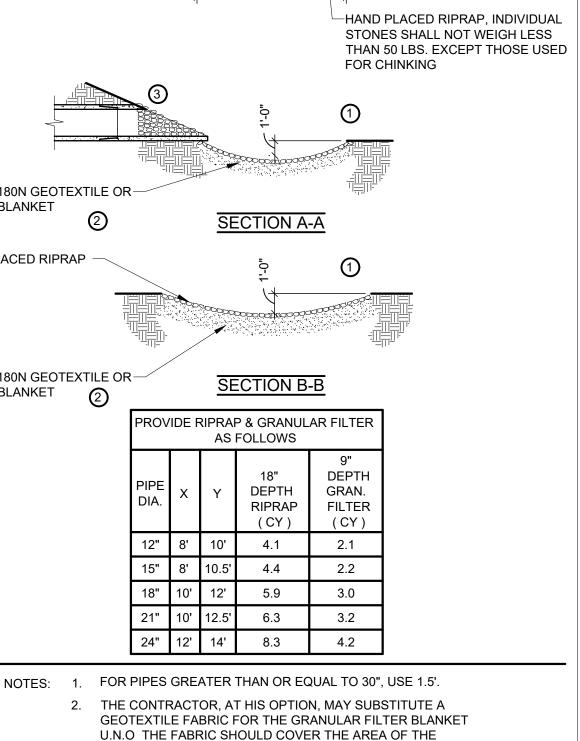

NOT TO SCALE

STM-39

DEPTH

GRAN.

FILTER

2.1

2.2

3.0

3.2

4.2

DEPTH

RIPRAP

(CY)

4.1

4.4

5.9

6.3

8.3


RIPRAP AND EXTEND UNDER THE CULVERT APRON 3 FEET.


3. ENSURE RIP RAP IS PLACED ON THE SLOPE TO THE TOP

STORM

RIPRAP AT RCP OUTLET DETAIL

OF THE FES.

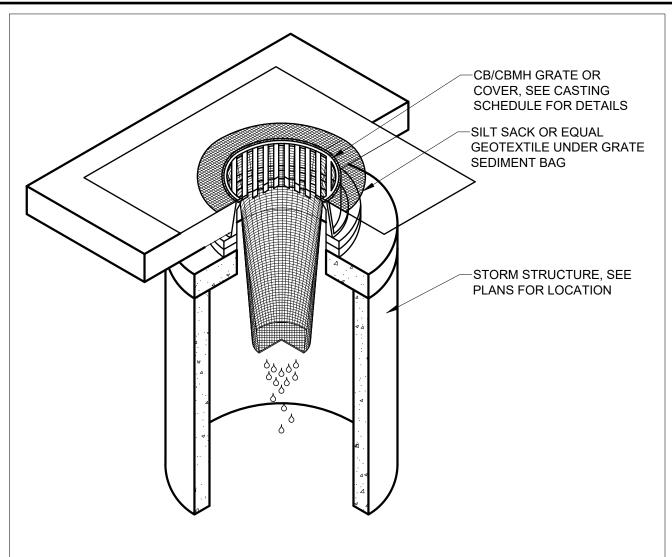

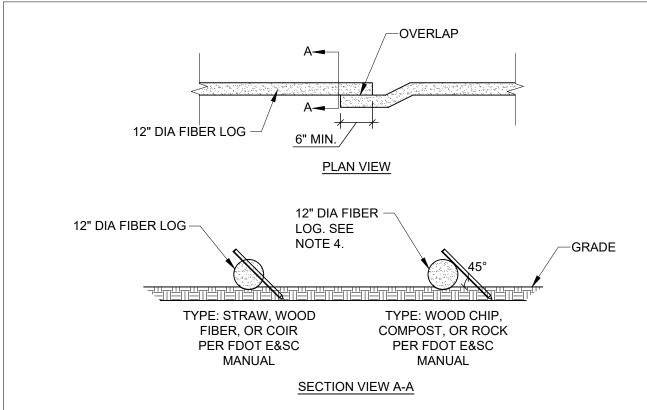

EROSION CONTROL

SEDIMENT CONTROL AT CB/CBMH DETAIL

EC-11

STAPLE PATTERN

DETAIL C

NOTE:


1. WHERE MORE THAN ONE (1) FIBER LOG IS USED, ENDS SHALL BE OVERLAPPED 6" MINIMUM 2. ALL STAKES INSTALLED SHALL BE PER FDOT E&SC MANUAL

STAKES SHALL BE INSTALLED @ 45° WITH TOP OF STAKE POINTING UP STREAM.

MAXIMUM SPACING OF STAKES SHALL BE 1.0 FEET. CONTRACTOR MAY SUBMIT SHOP DRAWING FOR APPROVED EQUAL PRIOR TO CONSTRUCTION. ROCK LOG SHALL BE USED WHEN SEDIMENT CONTROL LOG IS PLACED ON PAVED SURFACES

AND SEDIMENT CONTROL LOGS ARE UNABLE TO BE STAKED NOT TO SCALE **EROSION CONTROL**


FIBER LOG DETAIL

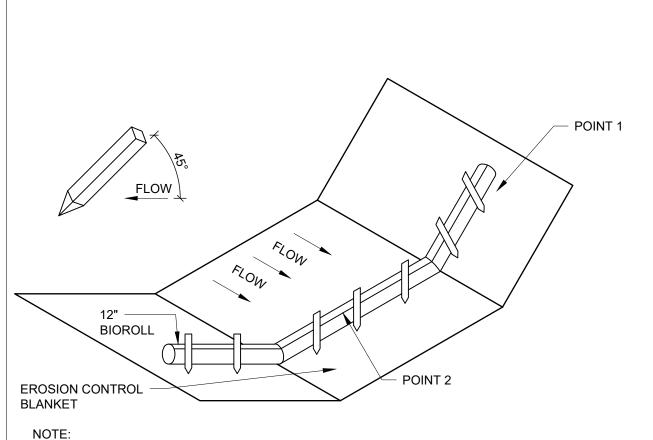

1. POINT 1 MUST BE A MINIMUM OF 12" HIGHER THAN POINT 2 (TOP OF BIOROLL) TO ENSURE THAT WATER FLOWS OVER THE DIKE AND NOT AROUND THE ENDS 2. STAKES SHALL BE INSTALLED PER DOT OR THE FOLLOWING AS A MINIMUM.


A. 1/2" x 2" x 16" WOODEN STAKES B. STAKED @ 45° WITH TOP OF STAKE POINTING UP STREAM. C. MAX SPACING OF STAKES SHALL BE 1.0 FEET.

NOT TO SCALE **EROSION CONTROL** BIOROLL DITCH CHECK DETAIL

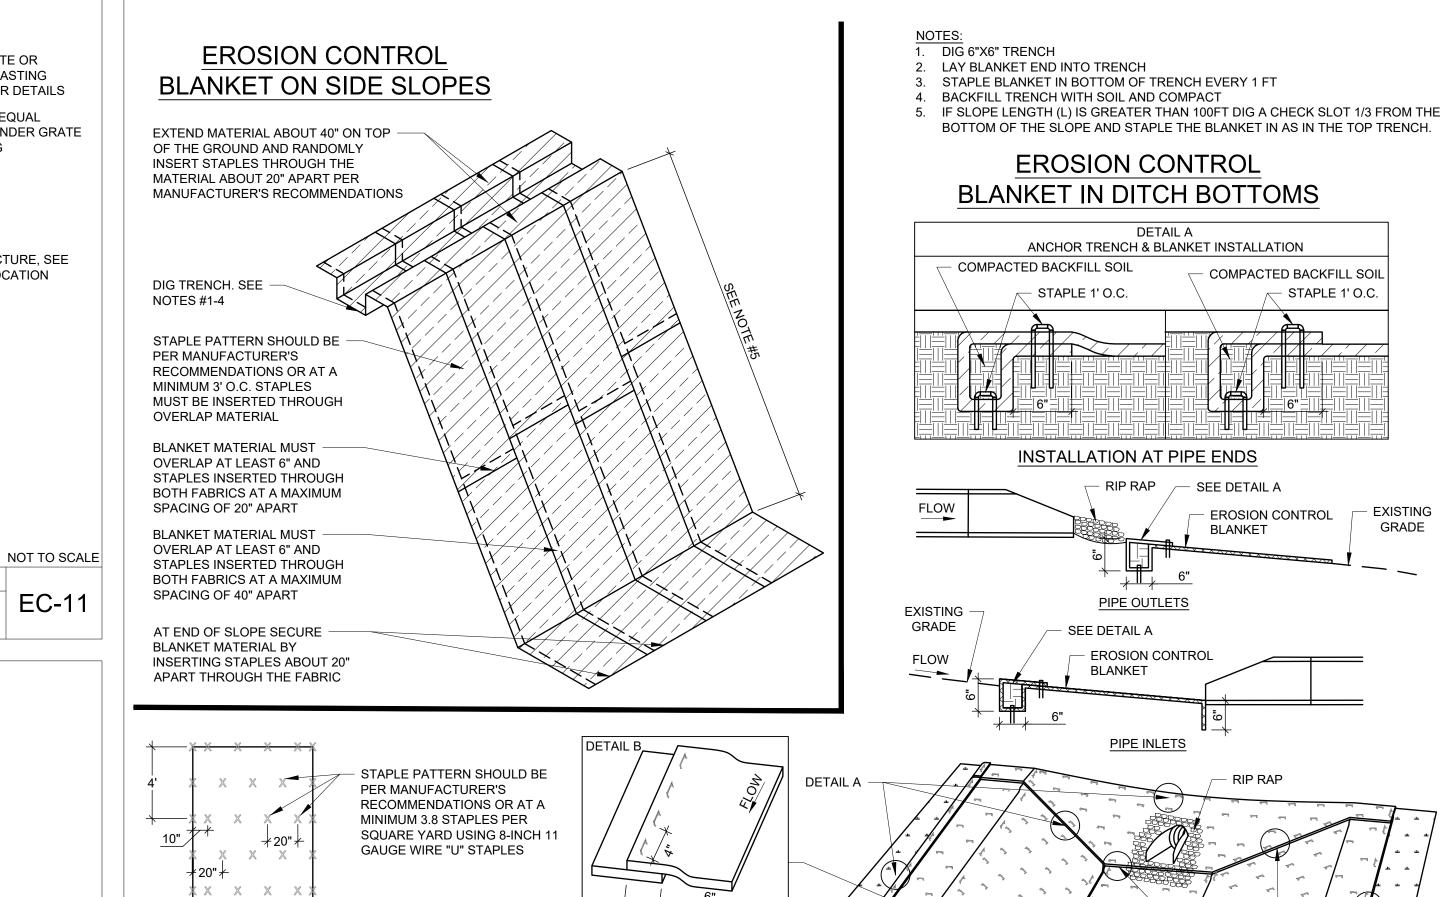

OVERLAP



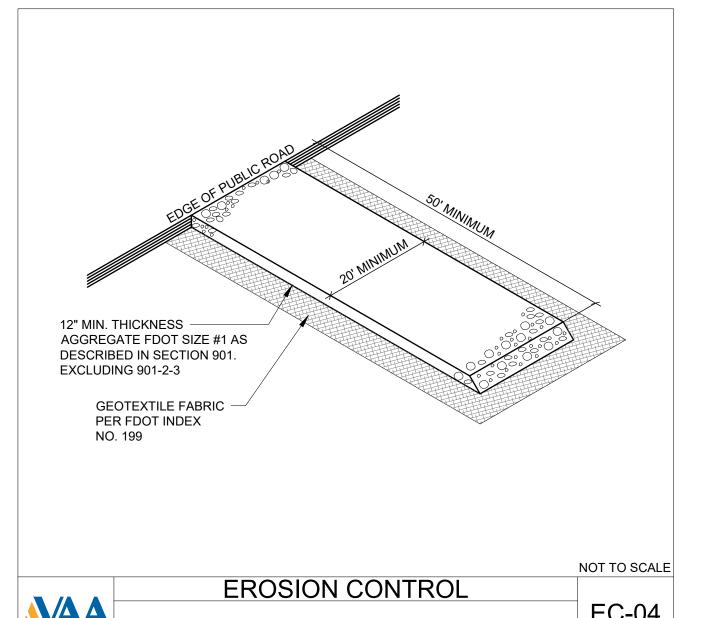

BLANKET INSTALLATION

CHANNEL OR SLOPE INSTALLATION

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STAPLE 1' O.C.

EROSION CONTROL

EXISTING

GRADE

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NEW LIQUID FERTILIZER FACILITY LAKE CITY, FL

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В	12/11/2023	ISSUED FOR PERMIT	RCQ	
AED:	CEDIFICATION.			

CERTIFICATION:

PROJECT:

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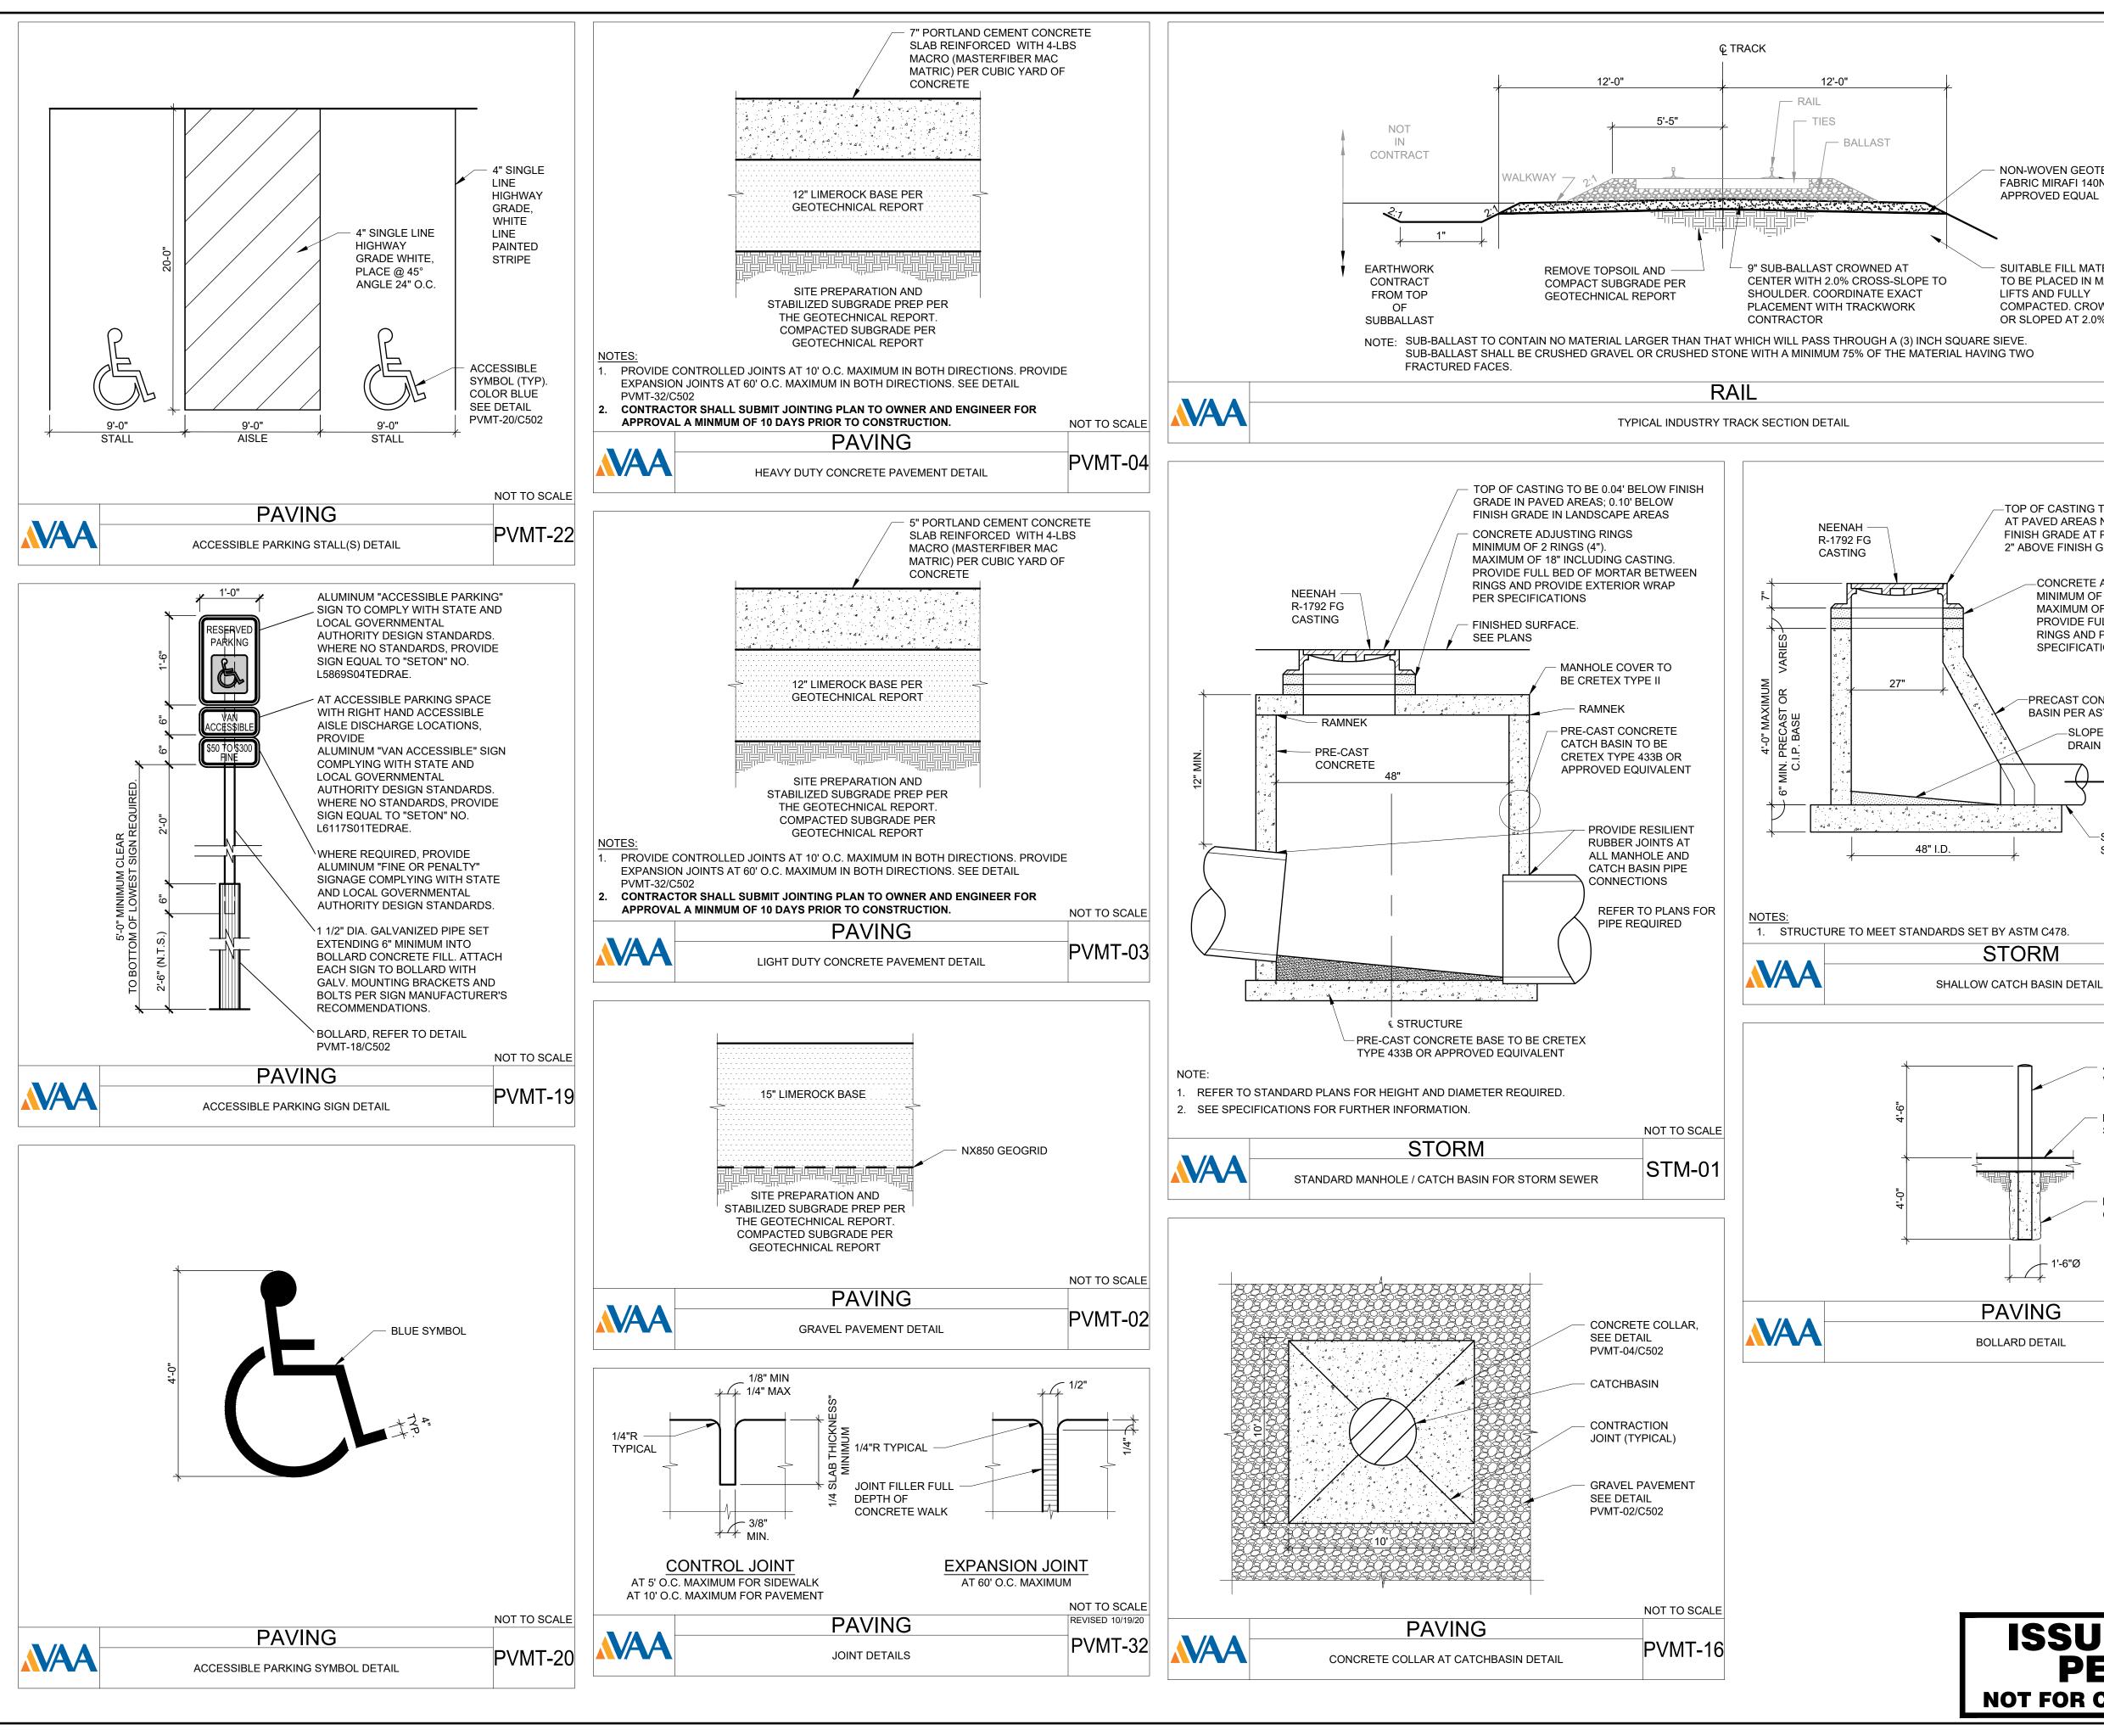
CIVIL DETAILS


PROJECT NO: DRAWING NO: 230384 C501 SCALE: AS NOTED

NAA

ROCK CONSTRUCTION ENTRANCE DETAIL


EC-04




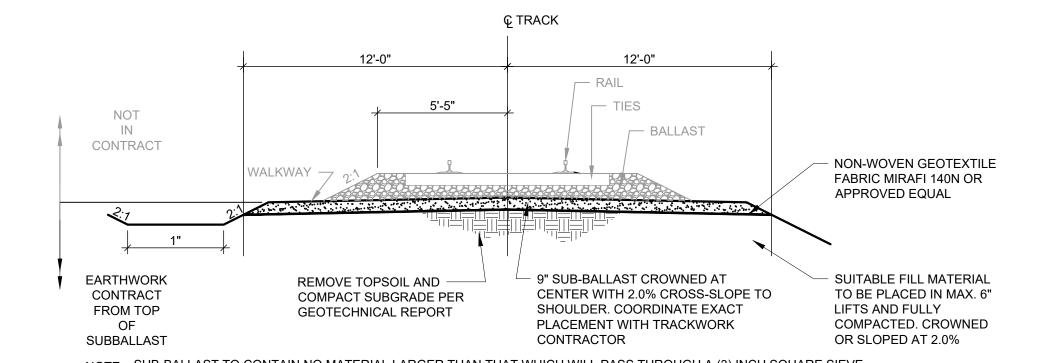

NOTE: SUB-BALLAST TO CONTAIN NO MATERIAL LARGER THAN THAT WHICH WILL PASS THROUGH A (3) INCH SQUARE SIEVE. SUB-BALLAST SHALL BE CRUSHED GRAVEL OR CRUSHED STONE WITH A MINIMUM 75% OF THE MATERIAL HAVING TWO

NOT TO SCALE **RR-14**

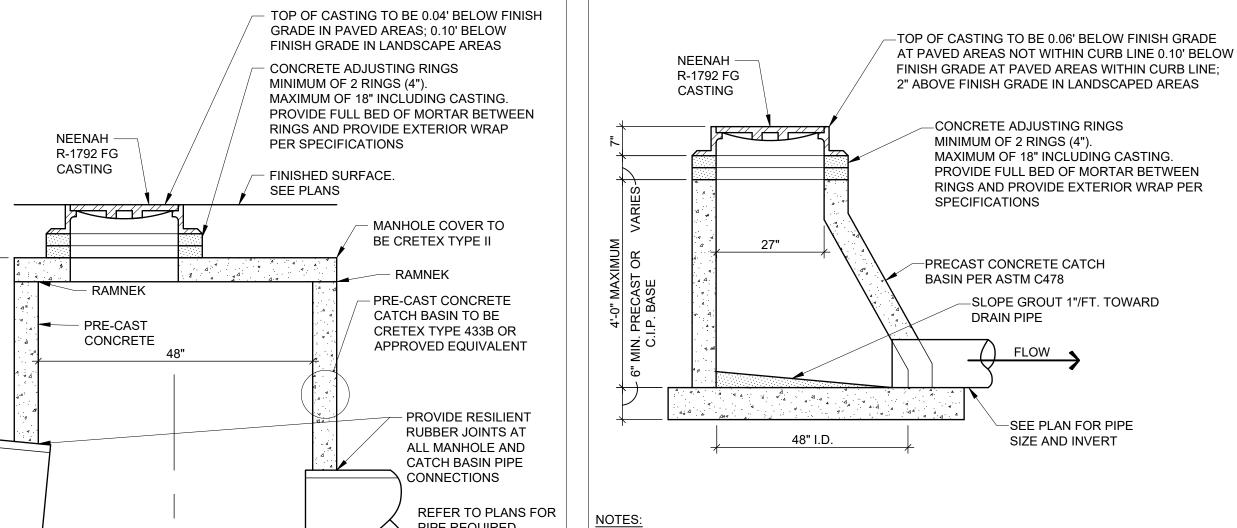

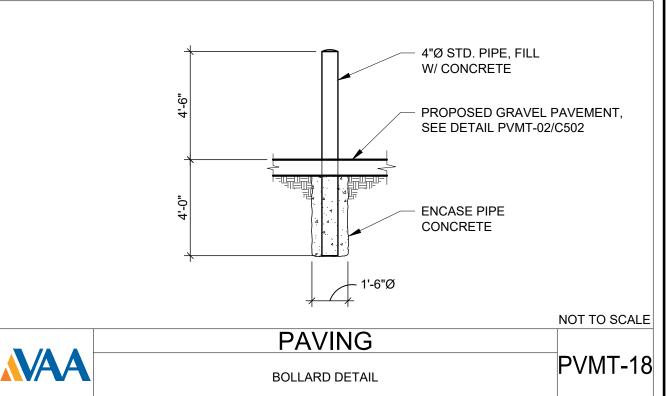

STORM

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PROJECT:

NOT TO SCALE

STM-03

NEW LIQUID FERTILIZER FACILITY LAKE CITY, FL

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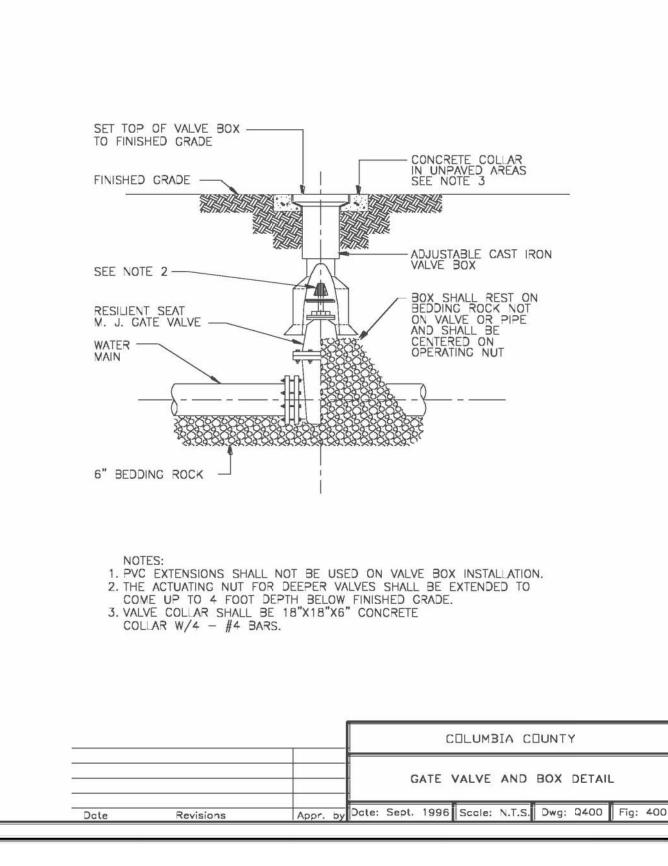
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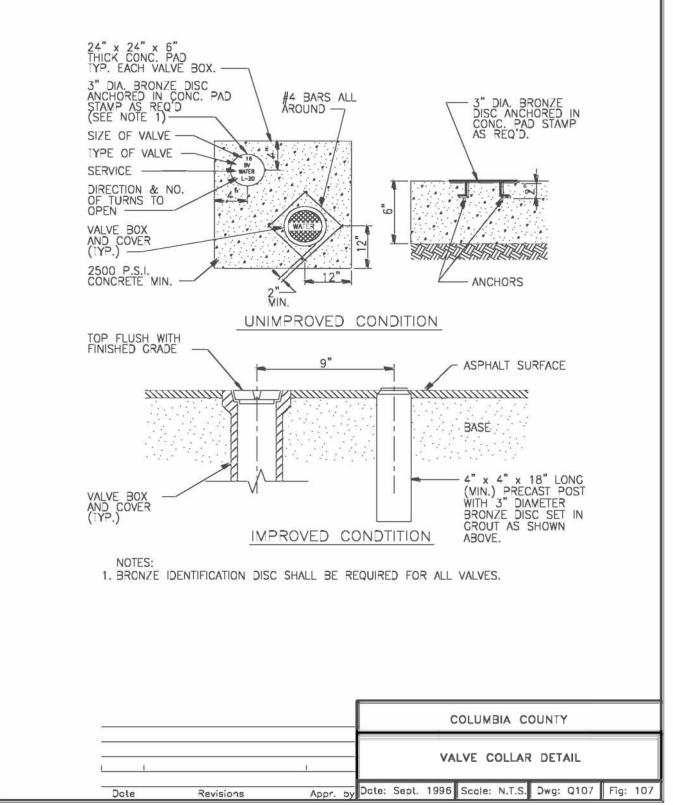
DATE:			
10/19/2023		RCQ	
DESIGNED: AJR	CHECKE ARL	D:	APPROVED: MDM
	10/19/2023 DESIGNED:	10/19/2023 DESIGNED: CHECKE	10/19/2023 RCQ DESIGNED: CHECKED:


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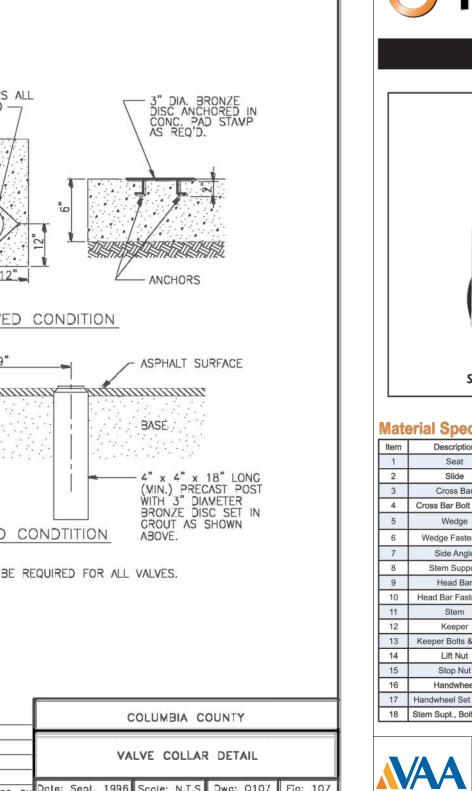
CIVIL DETAILS


PROJECT NO: DRAWING NO: 230384 C502 SCALE: AS NOTED







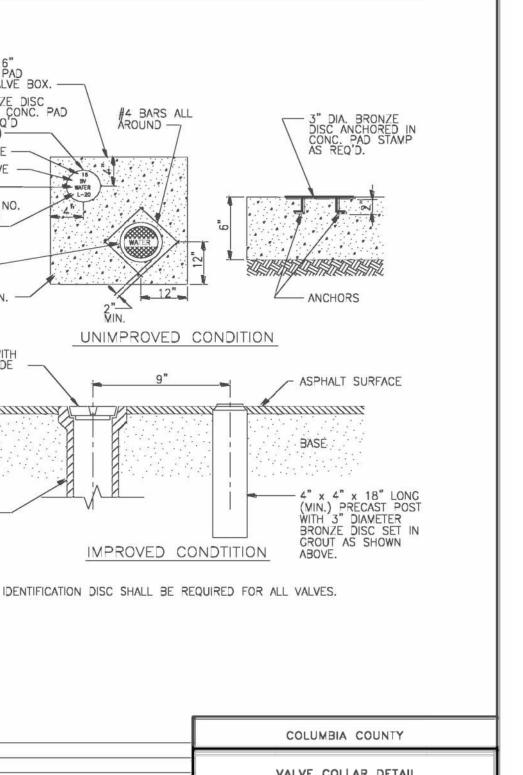

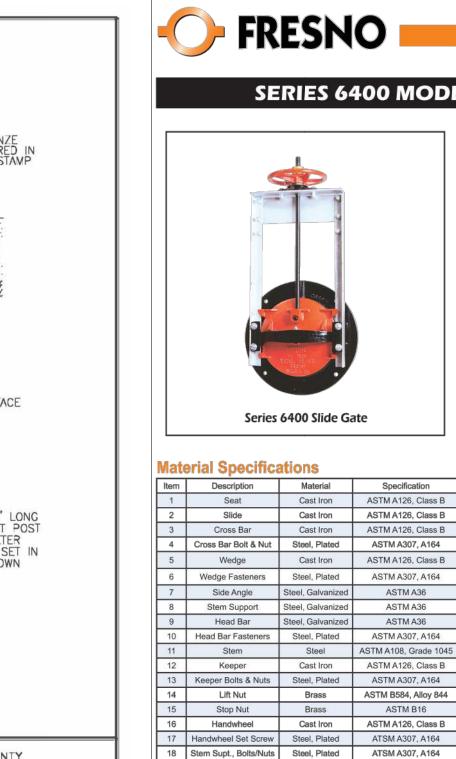

Cast Iron ASTM A126, Class B

Cast Iron ASTM A126, Class B

Cast Iron ASTM A126, Class B

ASTM A126, Class B

ASTM A307, A164


ASTM A307, A164


ASTM B16

ASTM A36

ASTM A36

Cast Iron

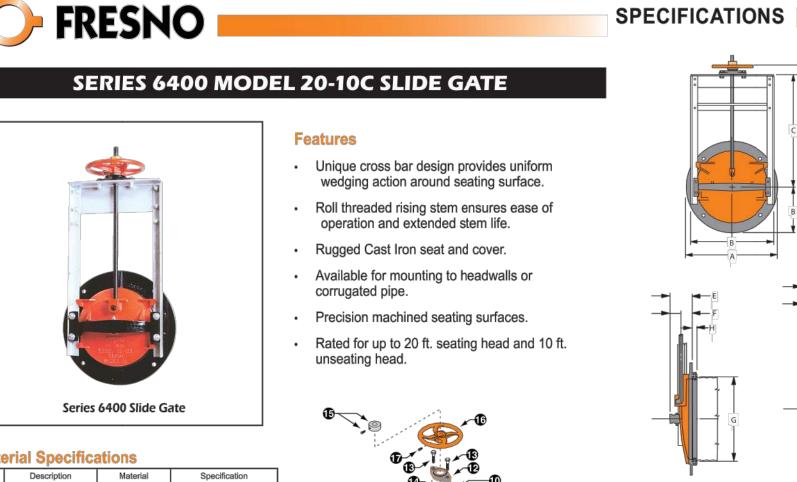

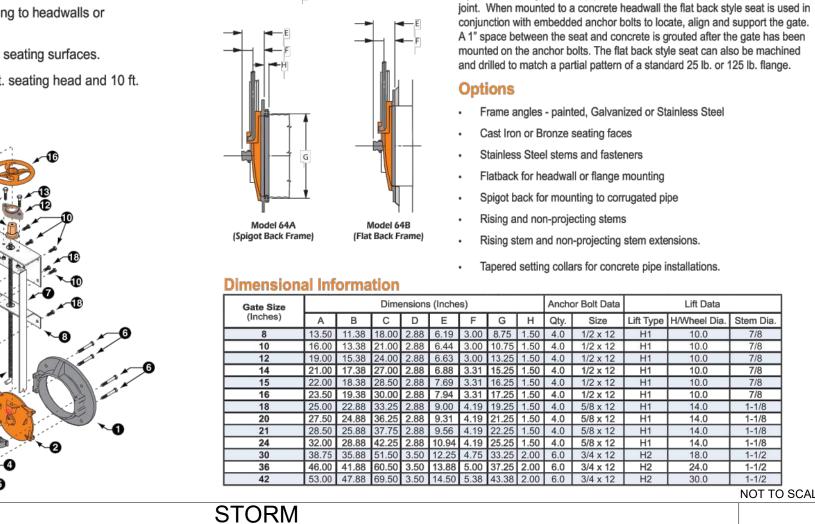

SLUICE (CANAL) GATE

Pressure Rating

Gate Size:

8"-12"

20"-24".

30"-42"..

PROJECT:

The Series 6400 Slide Gate is normally installed on corrugated steel pipe or

bolted to a concrete head wall or steel flange. When attached to corrugated

steel pipe, the spigot back style seat is used. This style seat allows for a simple bolted connection to the pipe or the use of a rod and lug harness assem-

bly to mount the gate to the pipe. In either case, a mastic is used to seal the

..32 ft.

..26 ft.

..20 ft.

STM-88 NO DATE ISSUE/REVISION A 10/19/2023 DESIGN DEVELOPMENT B 12/11/2023 ISSUED FOR PERMIT

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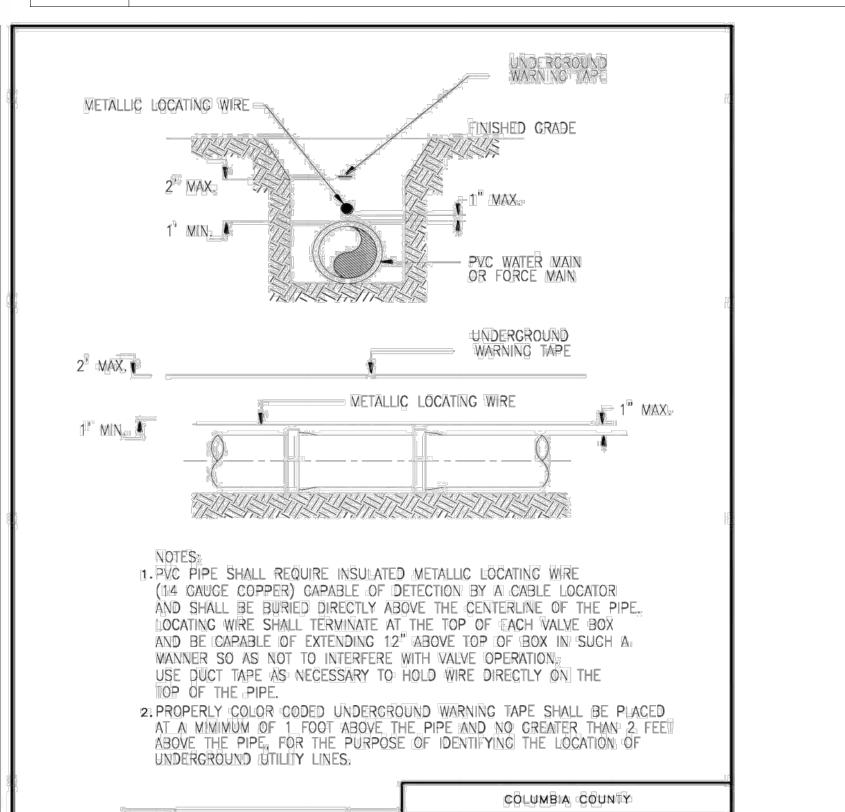
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DESIGNED: AJR	CHECKE ARL	ED:	APPROVEI MDM

DRAWING TITLE:


CIVIL DETAILS

ISSUED FOR PERMIT NOT FOR CONSTRUCTION




PVC PIPE LOCATING WIRE DETAIL

Dete: FEB. 2010 Scole: N. S. Dwg: Q108 10g: 108

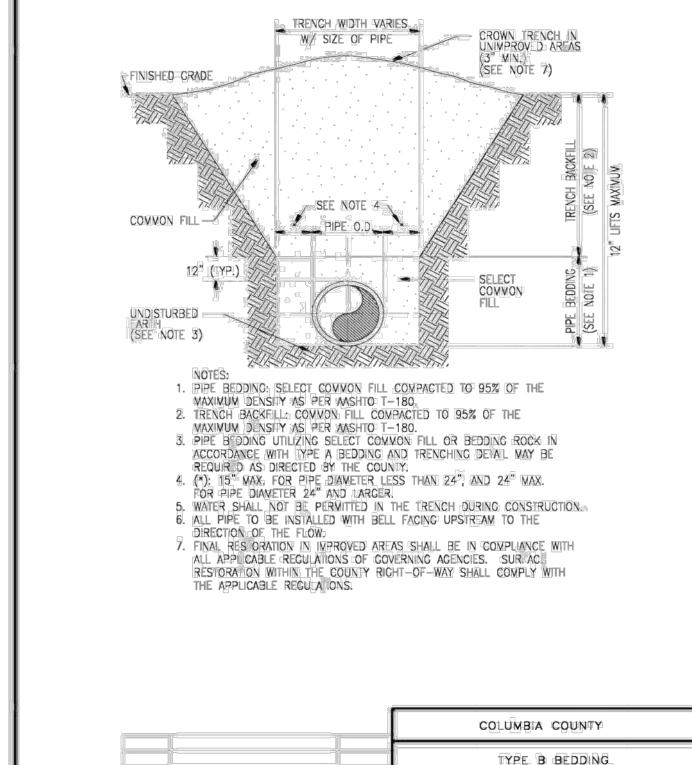

AND TRENCHING DETAIL

Date: Sept. 1996 Scale: N.T.S. Dwg: Q100

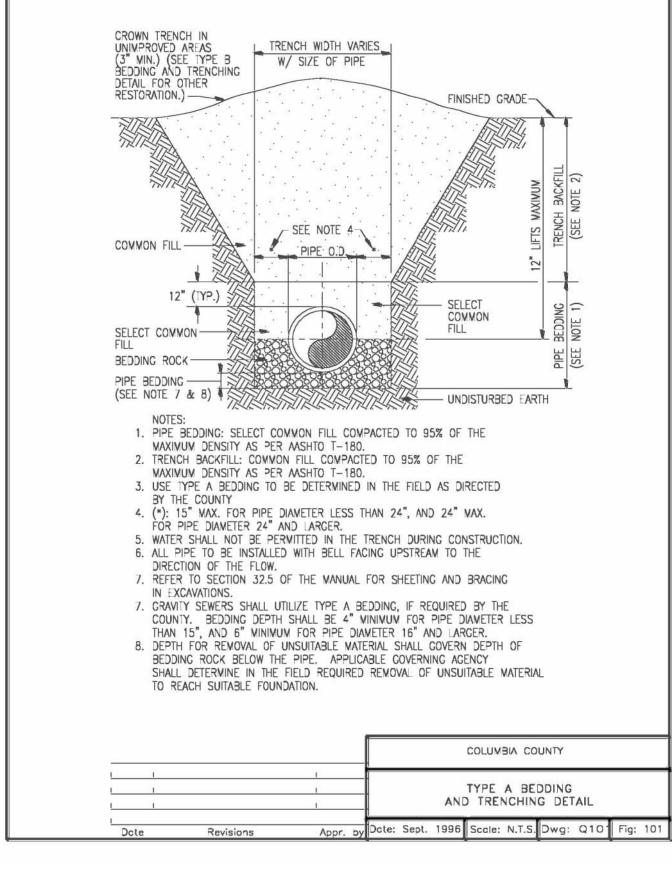



www.vaaeng.com Plymouth, MN 55441 Project # 230384

AGROLIQUID.

NEW LIQUID FERTILIZER FACILITY LAKE CITY, FL

MARK D. MIELKE, PE Registration No. 68730	
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1	DATE	DDAMM		
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DESIGNED: AJR	CHECKE ARL	ED:	APPROVED: MDM

PROJECT NO: DRAWING NO: 230384 SCALE: AS NOTED

CONSTRUCTION ACTIVITY REQUIREMENTS

THE GENERAL STORMWATER NATIONAL POLLUTION DISCHARGE ELIMINATION SYSTEM (NPDES) PERMIT IS REQUIRED FOR STORM WATER DISCHARGES ASSOCIATED WITH CONSTRUCTION ACTIVITY. THE PERMITEE(S) AS INDICATED IN THE PERMIT, MUST IMPLEMENT THE STORMWATER POLLUTION PREVENTION PLAN (SWPPP) AS DEMONSTRATED HEREIN AND WITHIN THE SWPPP NARRATIVE. THE BEST MANAGEMENT PRACTICES (BMP's) IDENTIFIED MUST BE INSTALLED IN AN APPROPRIATE AND FUNCTIONAL WAY TO PREVENT DIRT AND/OR DEBRIS FROM ENTERING THE STORM SEWER OR BEING TRANSPORTED OFF SITE IN AN UNCONTROLLED MANNER.

FOR REQUIREMENTS ASSOCIATED WITH FISH/WILDLIFE/RIVERS AND OTHER BODIES OF WATER, SEE FLORIDA DEP.

EROSION PREVENTION PRACTICES

1. ALL EXPOSED SOIL MUST BE STABILIZED AS SOON AS POSSIBLE AND NO LATER THAN 14 DAYS AFTER THE CONSTRUCTION ACTIVITY IN THAT PORTION OF THE SITE WHERE WORK HAS TEMPORARILY OR PERMANENTLY CEASED.

THESE AREAS INCLUDE, BUT ARE NOT LIMITED TO, CONSTRUCTED STORMWATER MANAGEMENT POND, SIDE SLOPES, AND ANY EXPOSED SOIL AREAS WITH A POSITIVE SLOPE TO STORMWATER CONVEYANCE SYSTEM, SUCH AS A CURB AND GUTTER SYSTEM, STORM SEWER INLET, TEMPORARY OR PERMANENT DRAINAGE DITCH OR OTHER NATURAL OR MANMADE SYSTEMS THAT DISCHARGE TO A SURFACE WATER.

- 2. THE NORMAL WETTED PERIMETER OF ANY TEMPORARY OR PERMANENT DRAINAGE DITCH THAT DRAINS WATER FROM A CONSTRUCTION SITE, OR DIVERTS WATER AROUND A SITE, MUST BE STABILIZED WITHIN 200 LINEAL FEET FROM THE PROPERTY EDGE, OR FROM THE POINT OF DISCHARGE TO ANY SURFACE WATER. STABILIZATION MUST BE COMPLETED WITHIN 24 HOURS OF CONNECTING TO A SURFACE WATER.
- 3. PIPE OUTLETS MUST BE PROVIDED WITH TEMPORARY OR PERMANENT ENERGY DISSIPATION WITHIN 24 HOURS OF CONNECTION TO A SURFACE WATER. CONTRACTOR TO PREVENT DIRT AND/OR DEBRIS FROM ENTERING STORM SEWER OR BEING TRANSPORTED OFF-SITE IN AN UNCONTROLLED MANNER. CONTRACTOR TO VERIFY AT PROJECT CLOSE-OUT THAT STORM SEWER SYSTEM IS CLEAR OF SEDIMENT AND/OR DEBRIS AND IS FULLY FUNCTIONAL. CONTRACTOR TO FOLLOW BEST MANAGEMENT PRACTICES (BMP'S).
- 4. ALL DISTURBED AREAS, EXCEPT ROADWAYS, BUILDING AREAS, PARKING AREAS, ISLANDS AND SIDEWALKS, SHALL BE RESTORED WITH MINIMUM 6 INCHES TOPSOIL, SEEDED AND MULCHED AS SOON AS POSSIBLE AND NO LATER THAN 14 DAYS OF COMPLETION OF SITE GRADING.
- 5. IN ORDER TO MAINTAIN SHEET FLOW AND MINIMIZE HILLS AND/OR GULLIES, THERE SHALL BE NO UNBROKEN SLOPE LENGTH OF GREATER THAN 75 FEET FOR SLOPES WITH A GRADE OF 3:1 OR STEEPER.
- EROSION CONTROL BLANKET SHALL BE INSTALLED ON ALL 3:1 SLOPES AND STEEPER, DITCH BOTTOMS AND OTHER "HARD TO HOLD" AREAS AS SHOWN.

SEDIMENT CONTROL PRACTICES

- 1. CONTRACTOR TO INSTALL SEDIMENT CONTROL ELEMENTS PRIOR TO START OF LAND DISTURBING ACTIVITIES. MAINTAIN IN GOOD CONDITION DURING CONSTRUCTION AND REMOVE FROM THE SITE UPON COMPLETION OF FINAL PAVING AND TURF ESTABLISHMENT. REMOVE FROM SITE UPON COMPLETION OF FINAL STABILIZATION. ALL SEDIMENT CONTROL ELEMENTS ARE TEMPORARY.
- 2. TEMPORARY ROCK CONSTRUCTION ENTRANCE SHALL BE LOCATED AT ALL CONSTRUCTION ACCESS LOCATIONS. SEE DETAIL EC-04/C501.
- 3. REMOVE ALL SOILS AND SEDIMENTS TRACKED OR OTHERWISE DEPOSITED ONTO PUBLIC AND PRIVATE PAVEMENT AREAS. REMOVAL SHALL BE ON A DAILY BASIS THROUGHOUT THE DURATION OF THE CONSTRUCTION. CLEAN PAVED ROADWAYS BY SHOVELING OR SWEEPING. STREET WASHING IS ALLOWED ONLY AFTER SHOVELING OR SWEEPING HAS REMOVED SEDIMENT.
- 4. SEDIMENT CONTROL PRACTICES MUST DETER SEDIMENT FROM ENTERING SURFACE WATERS, INCLUDING CURB AND GUTTER SYSTEMS AND STORM SEWER INLETS SEE DETAIL EC-11/C501.
- TEMPORARY OR PERMANENT DRAINAGE DITCHES AND SEDIMENT BASINS THAT ARE DESIGNED AS PART OF A TREATMENT SYSTEM (E.G., DITCHES WITH ROCK CHECK DAMS) REQUIRE SEDIMENT CONTROL PRACTICES ONLY AS APPROPRIATE FOR SITE CONDITIONS.
- 6. SEDIMENT CONTROL PRACTICES MUST BE ESTABLISHED ON ALL DOWN GRADIENT PERIMETERS BEFORE ANY UPGRADIENT LAND DISTURBING ACTIVITIES BEGIN. THESE PRACTICES SHALL REMAIN IN PLACE UNTIL FINAL STABILIZATION HAS BEEN ESTABLISHED.

SEDIMENT CONTROL PRACTICES CONTINUED

- 7. IF THE DOWN GRADIENT TREATMENT SYSTEM IS OVERLOADED, ADDITIONAL UPGRADIENT SEDIMENT CONTROL PRACTICES MUST BE INSTALLED TO ELIMINATE THE OVERLOADING, AND THE SWPPP MUST BE AMENDED TO IDENTIFY THESE ADDITIONAL PRACTICES.
- 8. THE TIMING OF THE INSTALLATION OF SEDIMENT CONTROL PRACTICES MAY BE ADJUSTED TO ACCOMMODATE SHORT-TERM ACTIVITIES SUCH AS CLEARING OR GRUBBING, OR PASSAGE OF VEHICLES. ANY SHORT-TERM ACTIVITY MUST BE COMPLETED AS QUICKLY AS POSSIBLE AND THE SEDIMENT CONTROL PRACTICES MUST BE INSTALLED IMMEDIATELY AFTER THE ACTIVITY IS COMPLETED. HOWEVER, SEDIMENT CONTROL PRACTICES MUST BE INSTALLED BEFORE THE NEXT PRECIPITATION EVENT EVEN IF THE ACTIVITY IS NOT COMPLETE.
- CONTRACTOR TO INSTALL AND MAINTAIN INLET PROTECTION AROUND ALL EXISTING CATCHBASINS, CATCHBASIN MANHOLES, AND FLARED END SECTIONS PRIOR TO THE START OF LAND DISTURBING ACTIVITIES AND AROUND ALL NEW CATCHBASINS, CATCHBASIN MANHOLES, AND FLARED END SECTIONS AFTER THEY ARE INSTALLED, UNTIL ALL SOURCES WITH POTENTIAL FOR DISCHARGING TO THE INLET HAVE BEEN STABILIZED. SEE DETAILS EC-11/C501, EC-09/C501.
- 10. TEMPORARY SOIL STOCKPILES MUST HAVE SILT FENCE OR OTHER EFFECTIVE SEDIMENT CONTROLS, AND CANNOT BE PLACED IN SURFACE WATERS, INCLUDING STORM WATER CONVEYANCES SUCH AS CURB AND GUTTER SYSTEMS, OR CONDUITS AND DITCHES.
- 11. STOCKPILE AREAS WHICH REMAIN INACTIVE FOR MORE THAN 14 DAYS SHALL BE SEEDED, MULCHED, AND SURROUNDED BY SILT FENCE.
- 12. THE PERMITEE(S) MUST INSTALL TEMPORARY SEDIMENTATION BASINS AS REQUIRED PER THE AUTHORITY HAVING JURISDICTION. IT IS RECOMMENDED THAT THE TEMPORARY BASIN BE INSTALLED IN THE LOCATION OF THE PERMANENT BASIN. CONTRACTOR TO CLEAN OUT ALL SEDIMENT AND RETURN BASIN TO DESIGN CAPACITY PRIOR TO FINAL STABILIZATION.

DEWATERING AND BASIN DRAINING

- DEWATERING OR BASIN DRAINING (E.G. PUMPED DISCHARGES, TRENCH/DITCH CUTS FOR DRAINAGE) RELATED TO THE CONSTRUCTION ACTIVITY THAT MAY HAVE TURBID OR SEDIMENT LADEN DISCHARGE WATER MUST BE DISCHARGED TO A TEMPORARY OR PERMANENT SEDIMENTATION BASIN ON THE PROJECT SITE WHENEVER POSSIBLE. IF THE WATER CANNOT BE DISCHARGED TO A SEDIMENTATION BASIN PRIOR TO ENTERING THE SURFACE WATER, IT MUST BE TREATED WITH THE APPROPRIATE BMP's, SUCH THAT THE DISCHARGE DOES NOT ADVERSELY AFFECT THE RECEIVING WATER OR DOWNSTREAM LANDOWNERS. THE PERMITEE(S) MUST ENSURE THAT DISCHARGE POINTS ARE ADEQUATELY PROTECTED FROM EROSION AND SCOUR. THE DISCHARGE MUST BE DISPERSED OVER NATURAL ROCK RIPRAP, SAND BAGS, PLASTIC SHEETING OR OTHER ACCEPTED ENERGY DISSIPATION MEASURES. ADEQUATE SEDIMENTATION CONTROL MEASURES ARE REQUIRED FOR DISCHARGE WATER THAT CONTAINS SUSPENDED SOLIDS.
- 2. ALL WATER FROM DEWATERING OR BASIN DRAINING ACTIVITIES MUST BE DISCHARGED IN A MANNER THAT DOES NOT CAUSE NUISANCE CONDITIONS, EROSION IN RECEIVING CHANNELS OR ON DOWNSLOPE PROPERTIES, OR INUNDATION IN WETLANDS CAUSING SIGNIFICANT ADVERSE IMPACT TO THE WETLAND.
- ANY DEWATERING ACTIVITY SHALL BE APPROVED BY THE ENGINEER AND THE APPROPRIATE GOVERNING AGENCIES PRIOR TO CONSTRUCTION.

INSPECTIONS AND MAINTENANCE

INSPECTIONS AND MAINTENANCE ARE CONDUCTED BY THE SUPERVISOR/CONTRACTOR AND MUST CONFORM TO THE SWPPP NARRATIVE.

IMPLEMENTATION SCHEDULE

THE IMPLEMENTATION SCHEDULE MUST CONFORM TO THE SWPPP NARRATIVE.

TEMPORARY EROSION CONTROL PLAN

INSTALL SEDIMENT PONDS AT RATE OF 1800 CF OF DEAD STORAGE PER ACRE OF DISTURBED LAND. TEMPORARY SEDIMENT BASINS SHALL BE OPERATIONAL UNTIL PERMANENT COVER IS ESTABLISHED FOR THE ENTIRE DRAINAGE AREA OF THE TEMPORARY BASIN. TEMPORARY SEDIMENT BASINS MUST BE CONSTRUCTED AND MADE OPERATIONAL CONCURRENTLY WITH THE START OF SOIL DISTURBANCE THAT IS UPGRADIENT OF THE AREA AND CONTRIBUTES RUNOFF TO THE POND.

	BEFORE	AFTER
	CONSTRUCTION	CONSTRUCTION
TOTAL PROJECT AREA	X	X
DISTURBED AREA	X	X
TOTAL ESTIMATED IMPERVIOUS	X	X
TOTAL ESTIMATED PERVIOUS	X	X
RUNOFF COEFFICIENT OR CN VALUE	X	X

ВМР	ESTIMATED QUANTITIES OF BMP'S	UNITS
SILT FENCE	X	LF
OUTLET PROTECTION WITH RIP RAP	Х	CY
FES INLET PROTECTION	X	LF
BIO-ROLLS	X	LF
SEED	X	ACRES
FERTILIZER	X	ACRES
MULCH	X	ACRES
CONSTRUCTION ENTRANCE	X	EA
EROSION CONTROL BLANKET	X	SY
CHECK DAM	X	SY
SOD	X	EA

SWPPP CONTACT INFORMATION:

OWNER:

TODD CRESSMSAN **AGROLIQUID** 3055 W M-21 SAINT JOHNS, MI 48879

PROJECT SITE MANAGER: T.B.D.

CONTRACTOR:

GREYSTONE CONSTRUCTION 2995 WINNERS CIRCLE DRIVE, SUITE 200 SHAKOPEE, MN 55379

THE SITE CONTRACTOR IS THE PARTY RESPONSIBLE TO OVERSEE THE IMPLEMENTATION OF THE SWPPP AND INSTALLATION, INSPECTION, AND MAINTENANCE OF THE EROSION PREVENTION AND SEDIMENT CONTROL BMP's BEFORE, DURING, AND AFTER CONSTRUCTION UNTIL FINAL STABILIZATION HAS BEEN ESTABLISHED AND THE "NOTICE OF TERMINATION" IS SUBMITTED. SEE THE GENERAL STORMWATER PERMIT FROM THE AUTHORITY HAVING JURISDICTION FOR REGULATIONS.

CONSTRUCTION DATES:

ESTIMATED PROJECT START DATE: XX/XX/XXXX ESTIMATED PROJECT COMPLETION DATE: XX/XX/XXXX

ALL INFORMATION WITHIN THE PLAN SET AND SPECIFICATIONS IS TO BE USED IN ACCORDANCE WITH THE SWPPP NARRATIVE AND THE LATEST CONSTRUCTION DOCUMENTS.





PROJECT:

NEW LIQUID FERTILIZER FACILITY LAKE CITY, FL

NO	DATE	ISSUE/REVISION	BY
Α	10/19/2023	DESIGN DEVELOPMENT	RCQ
В	12/11/2023	ISSUED FOR PERMIT	RCQ

CERTIFICATION:

MARK D. MIELKE, PE Registration No. 68730

This item has been digitally signed and sealed by Mark D. Mielke. Printed copies of this document are not considered signed and sealed and the signature must be verified on any electronic copies.

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	DATE:		DRAWN:	
	10/19/2023		RCQ	
	DESIGNED:	CHECKE	D:	APPROVED:
	AJR	ARL		MDM

DRAWING TITLE:

STORMWATER POLLUTION PREVENTION PLAN (SWPPP)

C601

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Ι.		
П	PROJECT NO:	DRAWING NO:
Ш	230384	CG
Ш	SCALE:	
П	AS NOTED	