
REVISIONS

SOFTPIXN ARCHITECTURAL DESIGN SOFTWARE



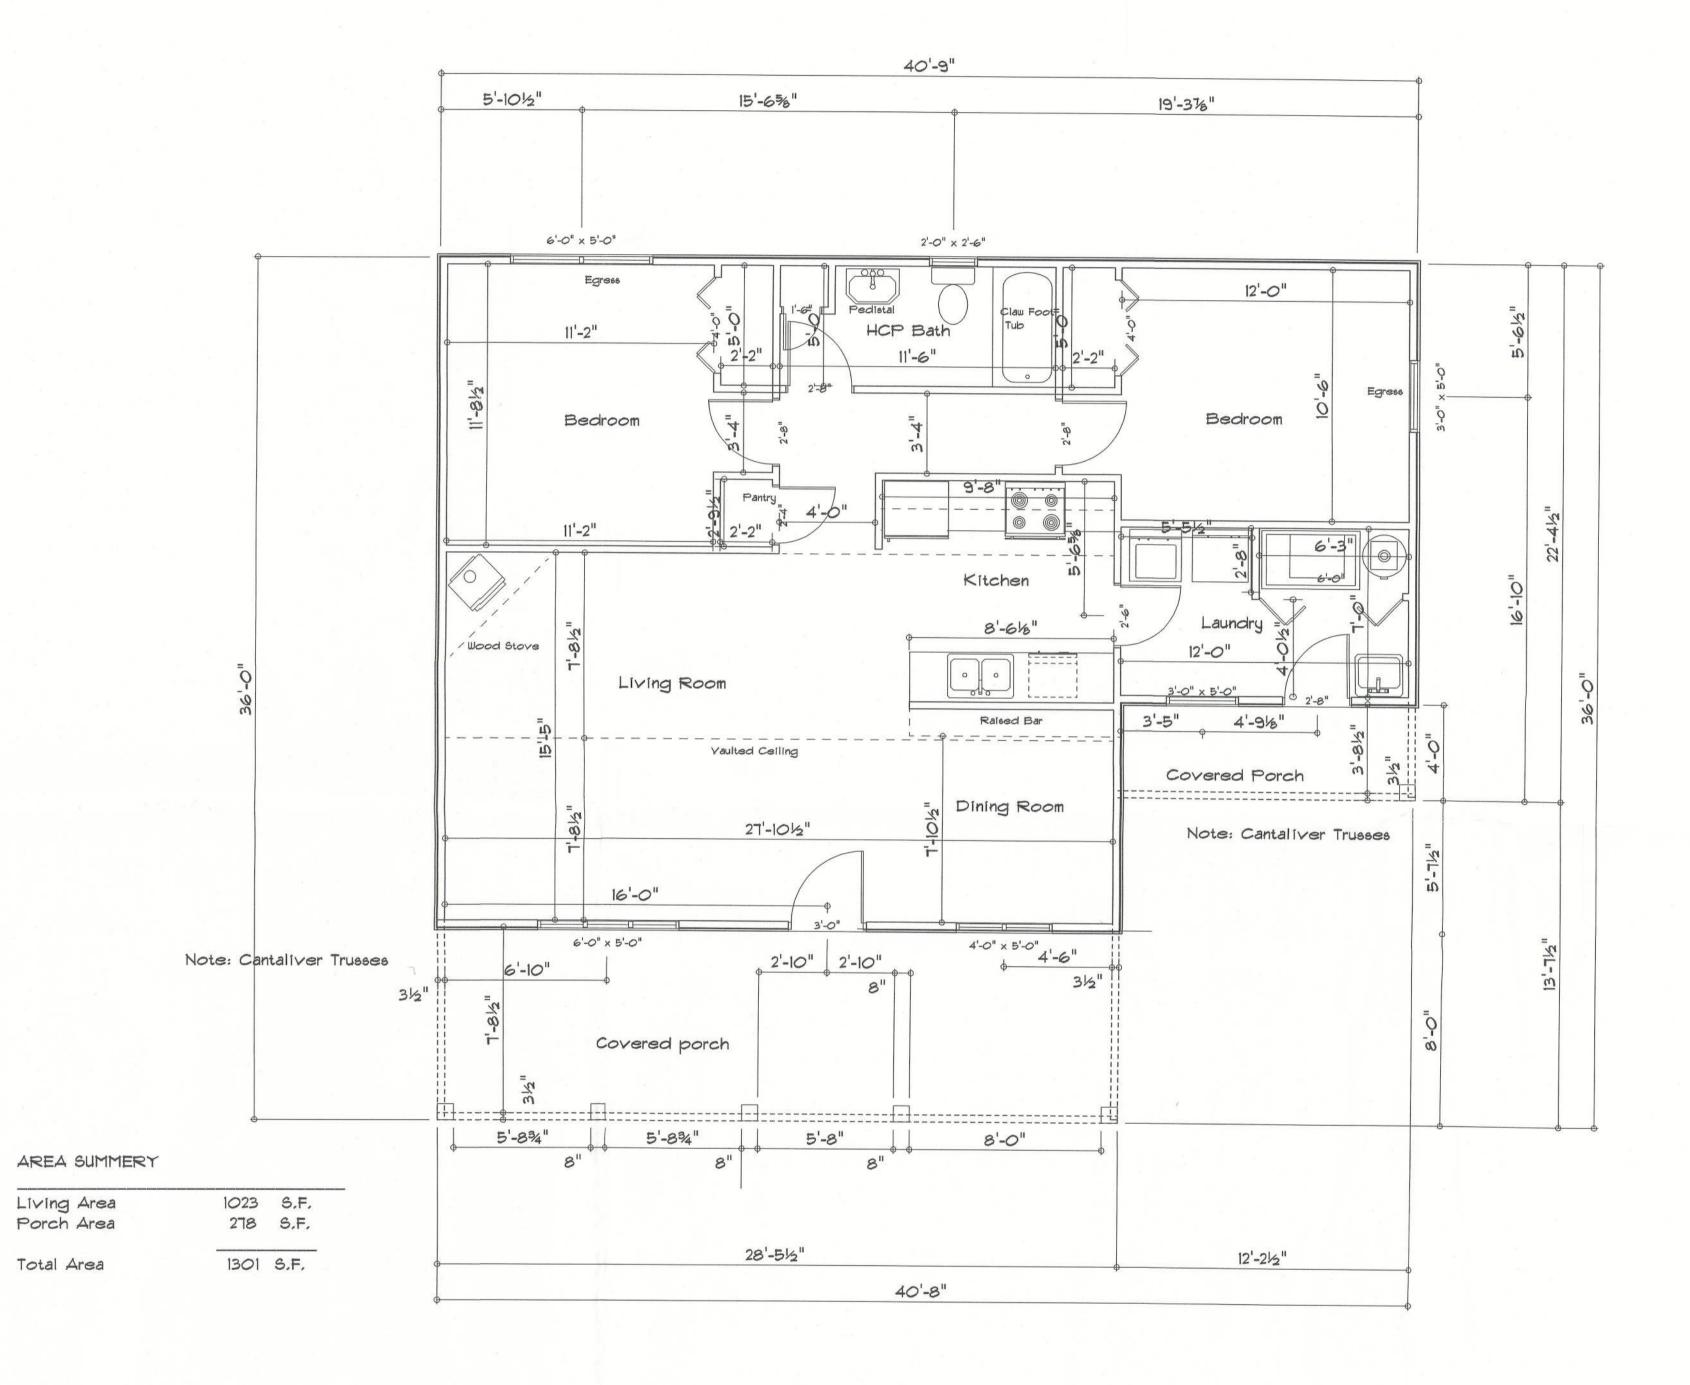

RESIDENCE

Mark Marroletti

ADDRESS: Columbia County, Florida

oodman Park Builders

Woodman Park Builders, Inc. Lake City, Florida Phone: (386) 755 - 2411 Fax: (386) 755-8684 Email:

PRINTED DATE:

DESIGNED BY:

DESIGNED BY:

Haddo

FINALS DATE:


JOB NUMBER:

DRAWING NUMBER

A-1



ELECTRICAL	SYMBOL		
ceiling fan globe 1			
ceiling globe light	0		
chandelier	900		
double spotlight	QD		
fluorescent fixture			
vanity bar light	<u> </u>		
wall sconce	<u>©</u>		
electrical panel	17		
AC Disconnect	DISCONNECT ON O		
Outlet WP GFI	Ø [₩] B		
cable ty outlet	TV		
fan	⊕		
light	-		
outlet	Ф		
outlet 220v	Ф		
smoke detector	•		
switch	\$		

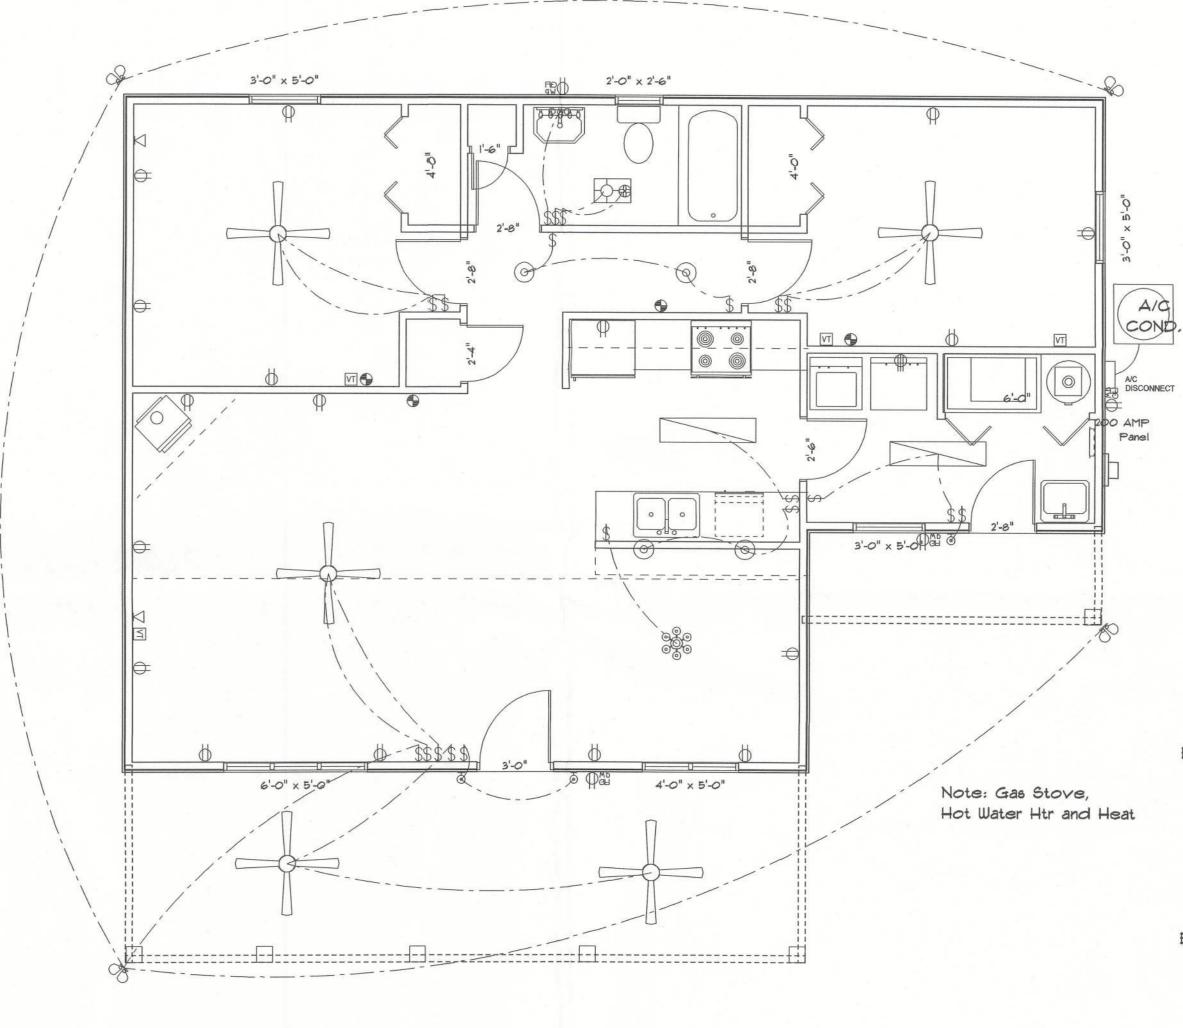

Electrical Plan

Electrical Plan Notes:

- E-1 Wire all appliances, HVAC units and other equiptment per manufactures specifications.
 - E-2 Consult the owner for the number or seperate telephone lines to be installed. Owner is responsible for all overages not noted on plan.
- E-3 All installations shall be per national code 2008.
- E-4 All smoke detectors shall be 120v with battery back-up of the photoelectric type, and shall be interlocked together. Install inside and near all bedrooms.
- E-5 Telephone, television and other low voltage devices or outlets shall be as per the owners directions and in accordance with applicable sections of the National Electric Codes latest edition. Owner is responsible for all overages not noted on plan.
- E-6 Electrical contractor shall be responssible for the design and sizing of electrical service and circuits.
- E-7 Entry of service (underground or overhead) to to be determined by contractor agreement.
 - E-8 All outlets located in residential to be tamper-resistant per NEC.
- E-9 All outlets to be located above base flood elevation.

E-10 All exterior GFI outlets shall be weatherproof.

- E-11 Overcurrent Protection device shall be installed on the exterior of structures on the load side of the meter to serve as a disconnecting means. Conductors used from the exterior disconnecting means to a panel or sub panel shall have four-wire conductors, of which one conductor shall be used as an equiptment ground.
- E-12 All 120-YOLT, single phase, 15 and 20 ampere branch circuits supplying outlets installed in dwelling unit family rooms, dining rooms, living rooms, parlors, libraries, dens, bedrooms, sun rooms, recreation rooms, closets, hallways, or similar rooms or areas shall be protected by a listed arc-fault circuit interrupter, combination-type installed to provide protection of the branch circuit.
- E-13 Carbon Monoxide alarms shall be required within 10' of all rooms for sleeping purposes in buildings having a fossil-fuel burning heater or appliance, a fireplace or attached garage.

RESIDENCE

Mark Marroletti

ADDRESS: Columbia County, Florida

Woodman Park Builders, Inc Lake City, Florida Phone: (386) 755 - 2411 Fax: (386) 755-8684 Email:

PRINTED DATE:

DRAWN BY:

FINALS DATE:

DESIGNED BY:

Mark Haddo:

CHECKED BY:

JOB NUMBER:

DRAWING NUMBER


A-2

REVISIONS


SOFTPIAN ARCHITECTURAL DESIGN SOFTWARE

Notes:

- R-1 All roof pitches shall be 6/12 unless otherwise noted.
- R-2 All overhangs shall be 20" except on gables 14".
- R-3 Provide attic ventilation in accordance with code requirements (1/300th insulated attic).

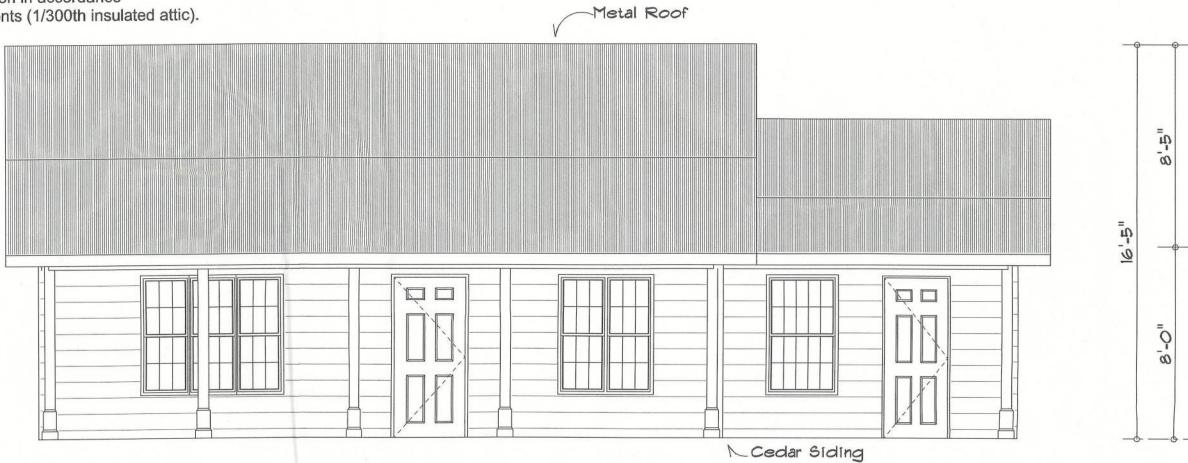


Front Elevation

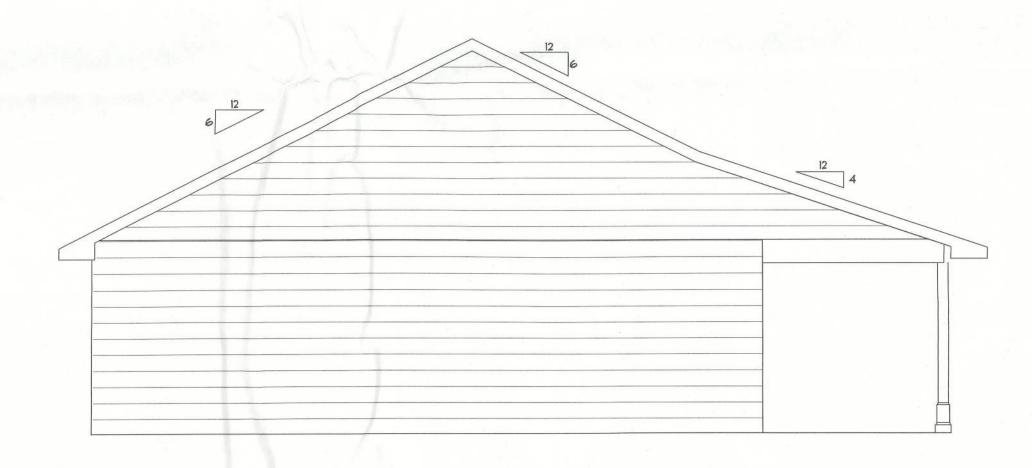

Left Elevation

Rear Elevation

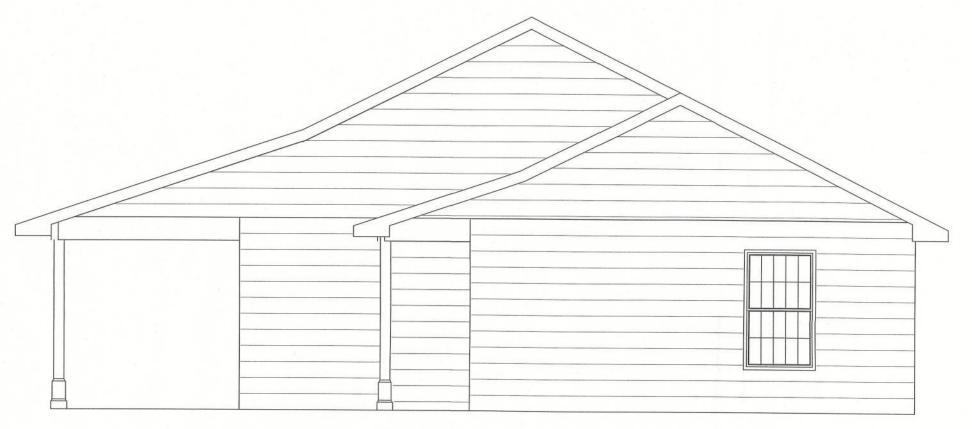

Right Elevation

RESIDENCE Mark Marroletti

> ADDRESS: Columbia County, Florida

Woodman Park Builders, Inc. Lake City, Florida Phone: (386) 755 - 2411 Fax: (386) 755-8684 Email:

PRINTED DATE:


DESIGNED BY:


Mark Haddox

JOB NUMBER:

DRAWING NUMBER

A-3

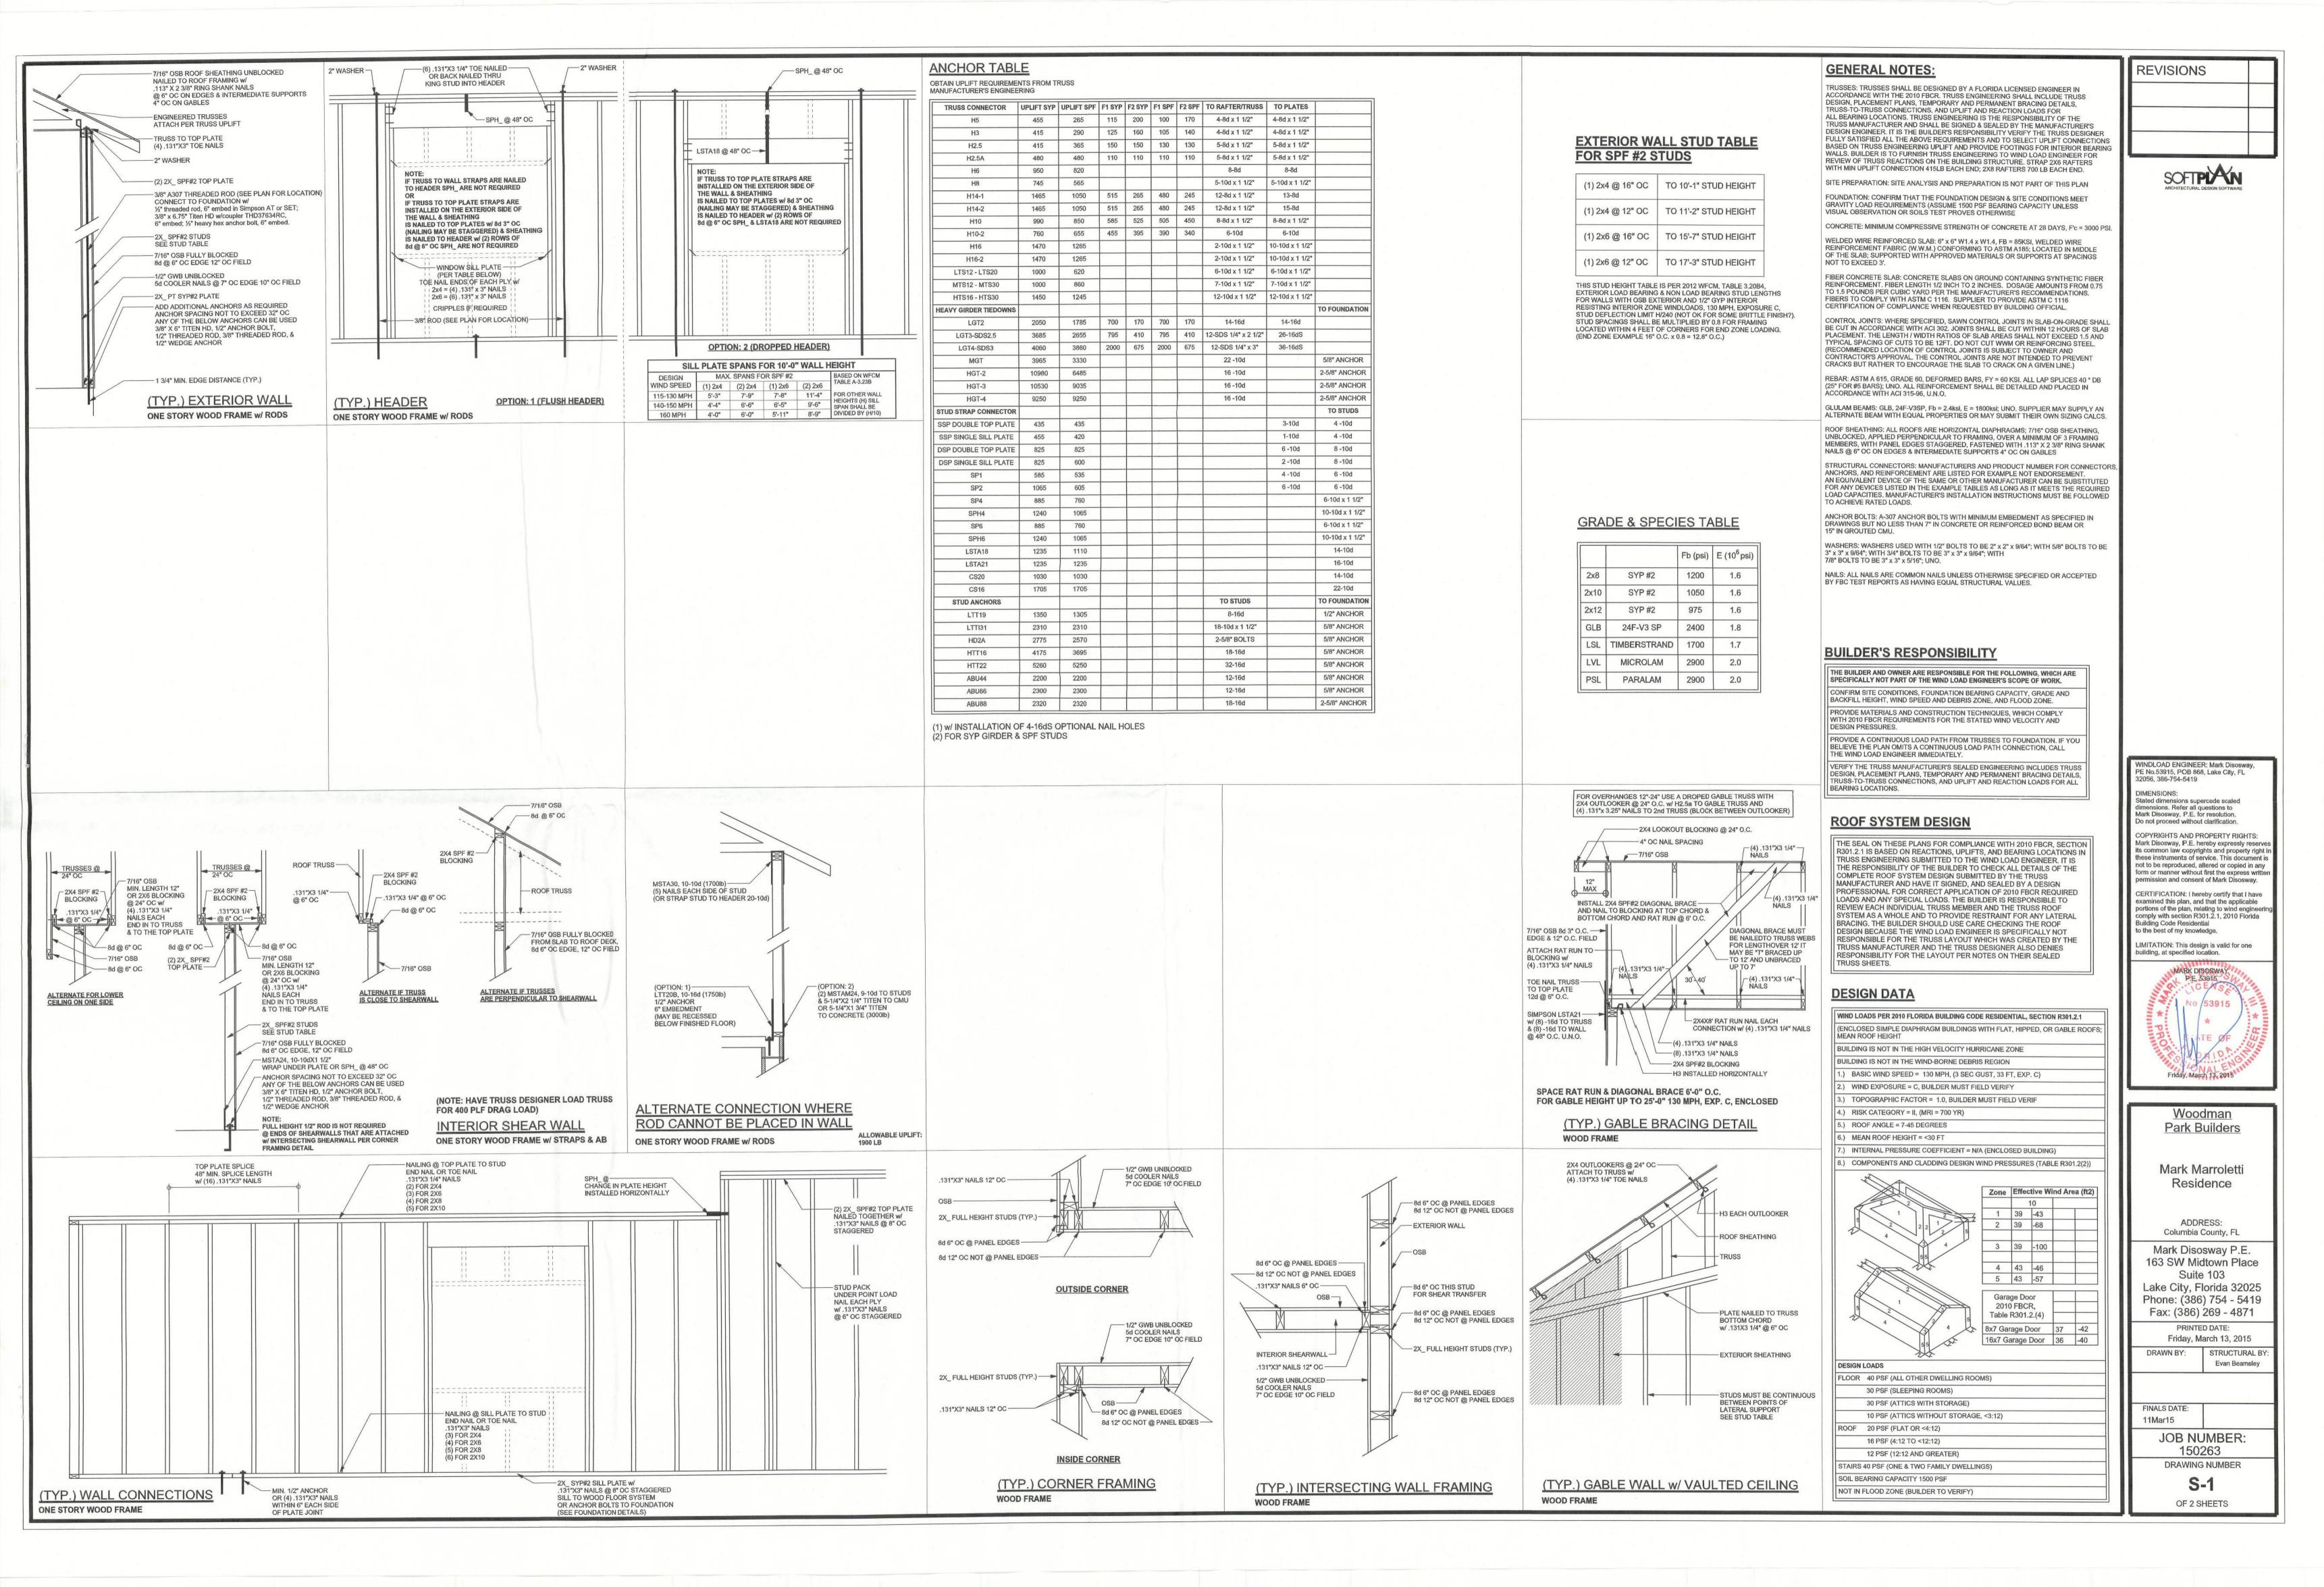

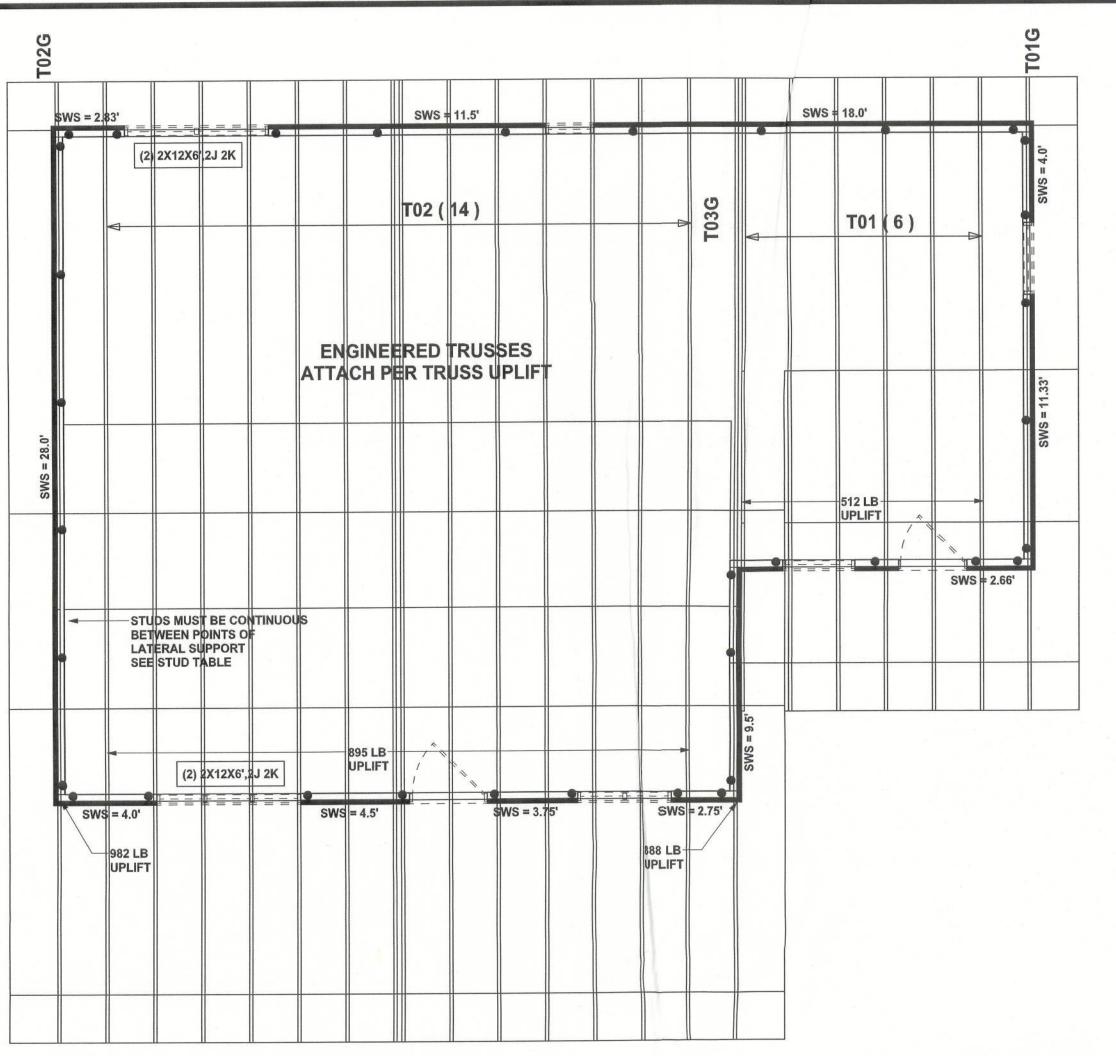

STRUCTURAL PLAN SCALE: 1/4" = 1'-0"

STRUCTURAL PLAN NOTES

ALL LOAD BEARING FRAME WALL & PORCH HEADERS SHALL BE A MINIMUM OF (2) 2X8 SYP#2 (U.N.O.)

ALL LOAD BEARING FRAME WALL HEADERS SHALL HAVE (1) JACK STUD & (1) KING STUD EACH SIDE (U.N.O.)

DIMENSIONS ON STRUCTURAL SHEETS ARE NOT EXACT. REFER TO ARCHITECTURAL FLOOR PLAN FOR ACTUAL DIMENSIONS


PERMANENT TRUSS BRACING IS TO BE INSTALLED AT LOCATIONS AS SHOWN ON THE SEALED TRUSS DRAWINGS. LATERAL BRACING IS TO BE RESTRAINED PER BCSI1-03, BCSI-B1, BCSI-B2, & BCSI-B3. BCSI-B1, BCSI-B2, & BCSI-B3 ARE FURNISHED BY THE TRUSS SUPPLIER, WITH THE SEALED

WALL LEGEND

TRUSS PACKAGE

· ·
EXTERIOR WALL
INTERIOR NON-LOAD BEARING WALL
INTERIOR LOAD BEARING WALL w/ NO UPLIFT
INTERIOR LOAD BEARING WALL w/ UPLIFT

HEADER LEGEND

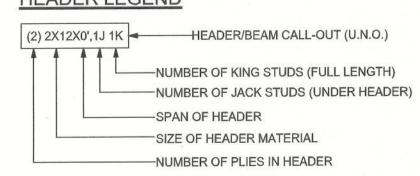

THREADED ROD LEGEND

	INDICATES LOCATION OF:
_	1ST FLOOR 3/8" A307 ALL THREADED ROD


TOTAL SHEAR WALL SEGMENTS

INDICATES SHEAR WALL SEGMENTS REQUIRED ACTUAL

TRANSVERSE 55.8' 57.9' LONGITUDINAL 30.2'

SPH4/6 STRAPING CAN BE USED IN PLACE OF ROD SPH4/6 STRAPS @ TOP & BOTTOM OF STUD EACH SIDE OF OPENING AND CORNERS & @ 32" OC

CONNECTIONS, WALL, & HEADER DESIGN IS BASED ON REACTIONS & UPLIFTS FROM TRUSS ENGINEERING FURNISHED BY BUILDER. BUILDERS FIRST SOURCE #650436

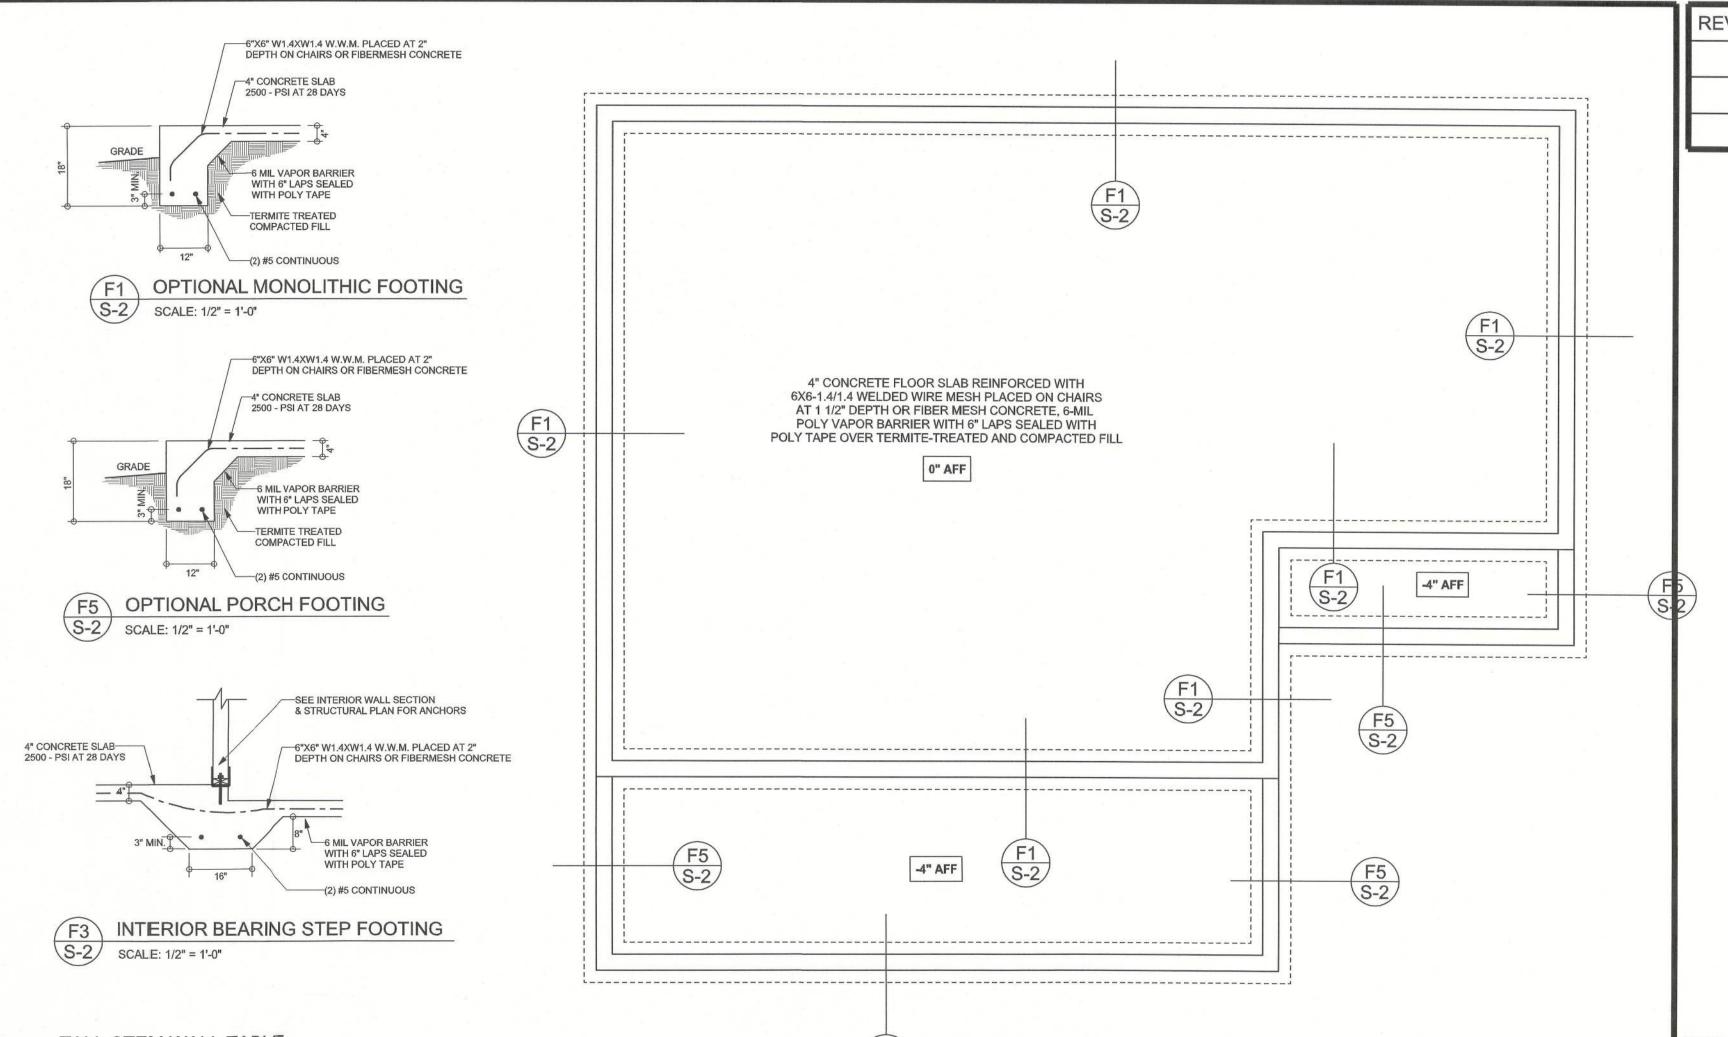

FOUNDATION PLAN

DIMENSIONS ON STRUCTURAL SHEETS ARE NOT EXACT. REFER TO ARCHITECTURAL

FLOOR PLAN FOR ACTUAL DIMENSIONS

SCALE: 1/4" = 1'-0"

SEE WALL SECTION & STRUCTURAL

PLAN FOR CAST IN PLACE ANCHORS

#5 STEEL DOWEL WITH 24" HOOK BENT

INTO SLAB AND 6" HOOK IN FOOTING AT EACH CORNER AND AT 96" O.C.

-8X8X16, RUNNING BOND,

-(2) #5 REBAR CONTINUOUS

STEM WALL FOOTING

SCALE: 1/2" = 1'-0"

CONCRETE STRIP FOOTING (MINIMUM 3000-PSI AT 28 DAYS)

CMU STEM WALL, MIN 2, MAX 5 COURSES

(SEE SPECIAL REINFORCEMENT

TABLE FOR MOR THAN 5 COURSES)

(1) #5 CONT., IN HDR. BLOCK BOND BEAM @ SLAB EDGE INTERSECTION W/ STEMWALL

TALL STEM WALL TABLE

RECESS AT DOORS-AS REQUIRED

4" (CONCRETE SLAB-

25(00 - PSI AT 28 DAYS

6"X6" W1.4XW1.4 W.W.M. PLACED AT 2" -

6 MIL VAPOR BARRIER— WITH 6" LAPS SEALED

WITH POLY TAPE


TERMITE TREATED FILL, -

EACH LIFT COMPACTED TO MIN. 95% MOD. PROCTOR

DEPTH ON CHAIRS OR FIBERMESH

The table assumes 60 ksi reinforcing bars with 6" hook in the footing and bent 24" into the reinforced slab at the top. The vertical steel is to be placed toward the tension side of the CMU wall (away from the soil pressure, within 2" of the exterior side of the wall). If the wall is over 8' high, add Durowall ladder reinforcement at 16"OC vertically or a horizontal bond beam with 1#5 continuous at mid height. For higher parts of the wall 12" CMU may be used

STEMWALL UNBALANCED HEIGHT BACKFILL (FEET) HEIGHT	BACKFILL	D VERTICAL REINFORCEMENT FOR 8" CMU STEMWALL (INCHES O.C.)			VERTICAL REINFORCEMENT FOR 12" CMU STEMWALL (INCHES O.C.)		
	#5	#7	#8	#5	#7	#8	
3.3	3.0	96	96	96	96	96	96
4.0	3.7	96	96	96	96	96	96
4.7	4.3	88	96	96	96	96	96
5.3	5.0	56	96	96	96	96	96
6.0	5.7	40	80	96	80	96	96
6.7	6.3	32	56	80	56	96	96
7.3	7.0	24	40	56	40	80	96
8.0	7.7	16	32	48	32	64	80
8.7	8.3	8	24	32	24	48	64
9.3	9.0	8	16	24	16	40	48

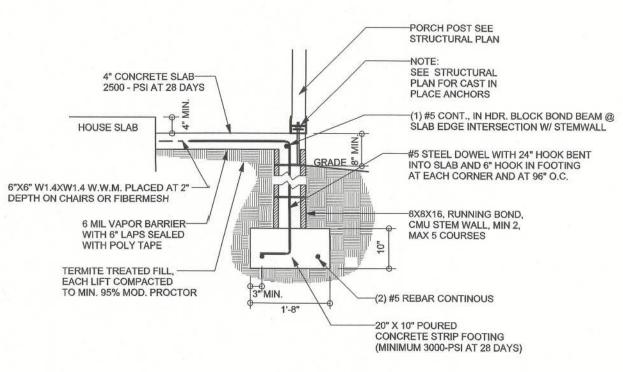

STEM WALL PORCH FOOTING SCALE: 1/2" = 1'-0"

PE No.53915, POB 868, Lake City, FL 32056, 386-754-5419 DIMENSIONS: Stated dimensions supercede scaled

SOFTPIAN

dimensions. Refer all questions to Mark Disosway, P.E. for resolution. Do not proceed without clarification. COPYRIGHTS AND PROPERTY RIGHTS: Mark Disosway, P.E. hereby expressly reserves its common law copyrights and property right in these instruments of service. This document is not to be reproduced, altered or copied in any form or manner without first the express writte

CERTIFICATION: I hereby certify that I have examined this plan, and that the applicable portions of the plan, relating to wind engineering comply with section R301.2.1, 2010 Florida Building Code Residential to the best of my knowledge.

permission and consent of Mark Disosway.

LIMITATION: This design is valid for one building, at specified location.



<u>Woodman</u> Park Builders

Mark Marroletti Residence

ADDRESS:

Columbia County, FL Mark Disosway P.E. 163 SW Midtown Place

Suite 103 Lake City, Florida 32025 Phone: (386) 754 - 5419 Fax: (386) 269 - 4871

Friday, March 13, 2015 STRUCTURAL BY: DRAWN BY: Evan Beamsley

FINALS DATE: 11Mar15

> JOB NUMBER: 150263 DRAWING NUMBER

> > OF 2 SHEETS