





| MARK | SIZE | | REINFORCING |
|---------------------|---------------|----------|--------------|
| | WIDTH, W | DEPTH, D | |
| SPREAD FOOTINGS | | | |
| F2.5 | 2'-6" x 2'-6" | 1'-0" | (3) #5 E.W. |
| F2.5A | 2'-6" x 2'-6" | 1'-8" | (3) #5 E.W. |
| CONTINUOUS FOOTINGS | | | |
| CF1 | 1'-4" | 1'-0" | (3) #5 CONT. |
| CF2 | 1'-4" | 1'-8" | (3) #5 CONT. |
| CF3 | 2'-0" | 1'-0" | (3) #5 CONT. |


| BAR SIZE | STANDARD LAP LENGTH | | STANDARD HOOKS | |
|----------|---------------------|---------|----------------|--------|
| | CONCRETE | MASONRY | DIAMETER | LENGTH |
| #3 | 15" | 18" | 2 1/4" | 6" |
| #4 | 20" | 24" | 3" | 8" |
| #5 | 25" | 30" | 3 3/4" | 10" |

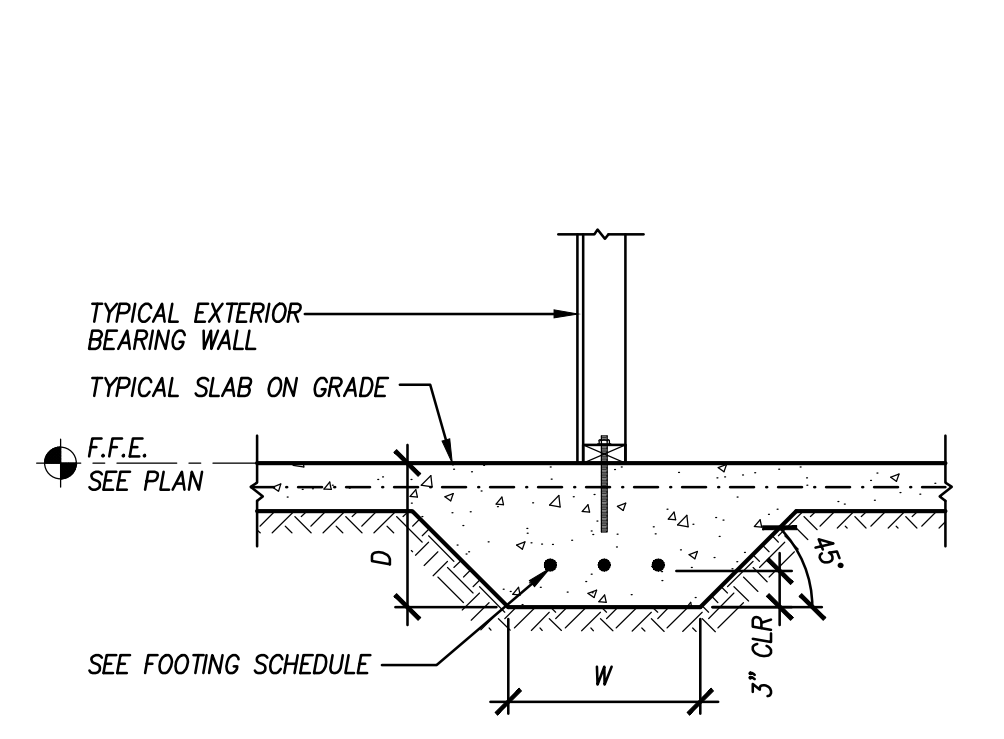


F11 Typical Wall Footing
3/4" = 1'-0" MONO3

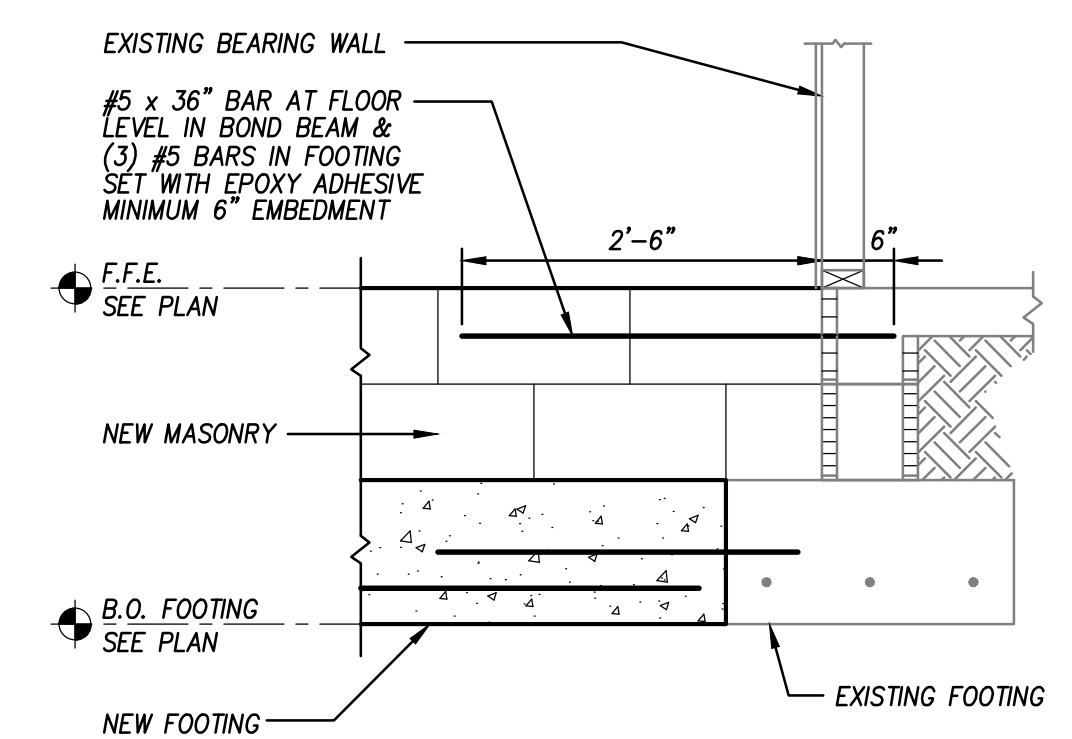


F7 Typical Tie To Existing Wall
3/4" = 1'-0" MAS-W411F

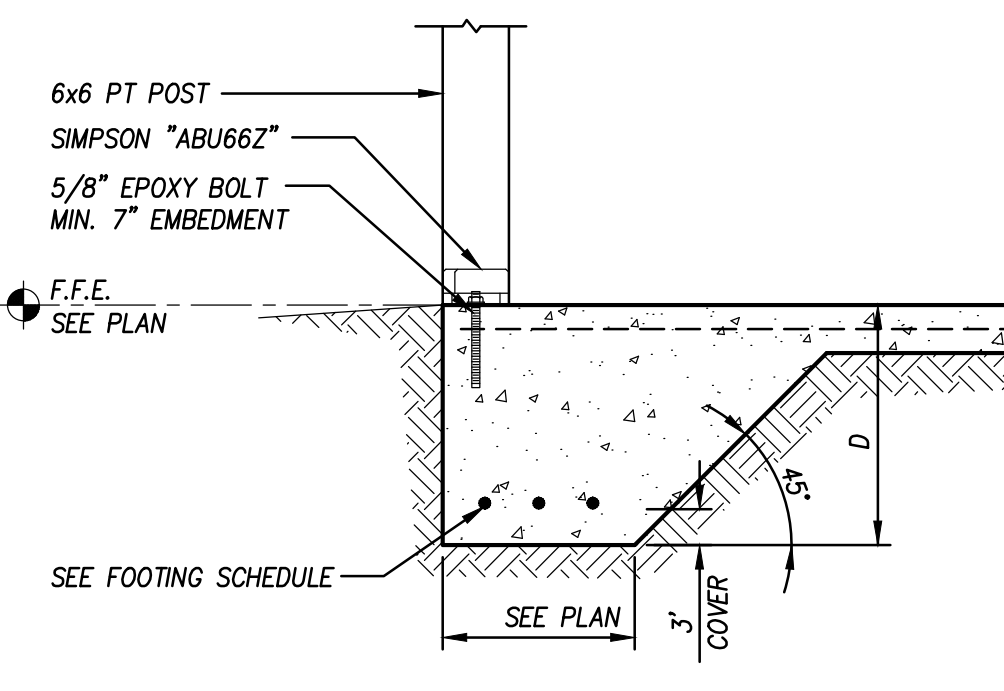


F12 Typical Porch Footing
3/4" = 1'-0" MONO1J

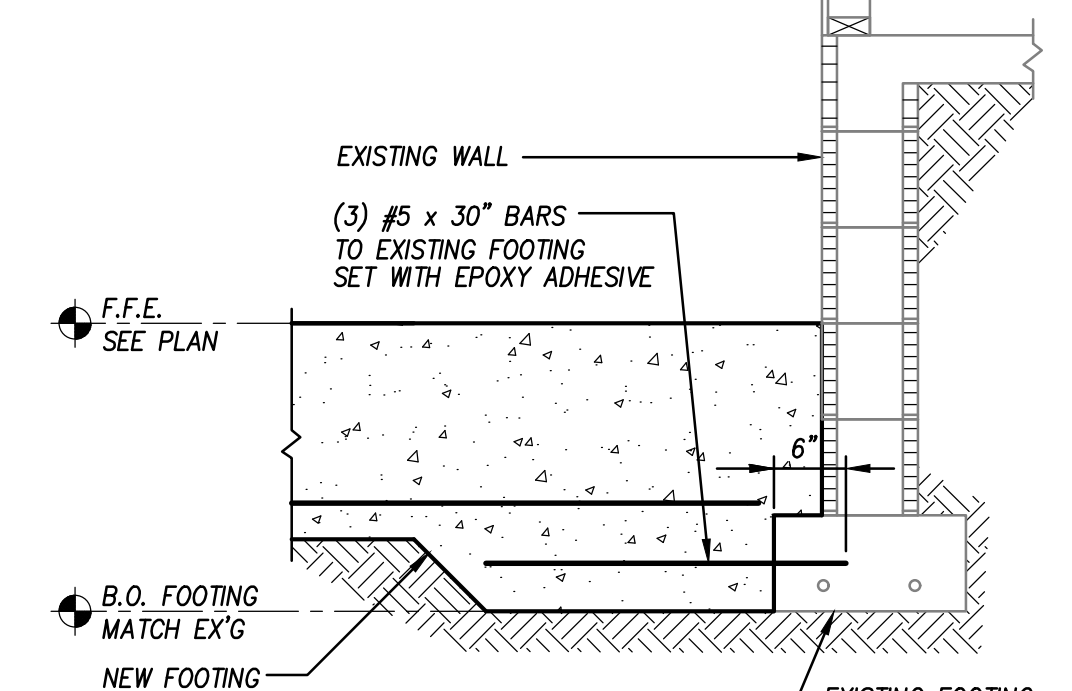


F8 Typical Tie To Existing Wall
3/4" = 1'-0" MAS-W411J

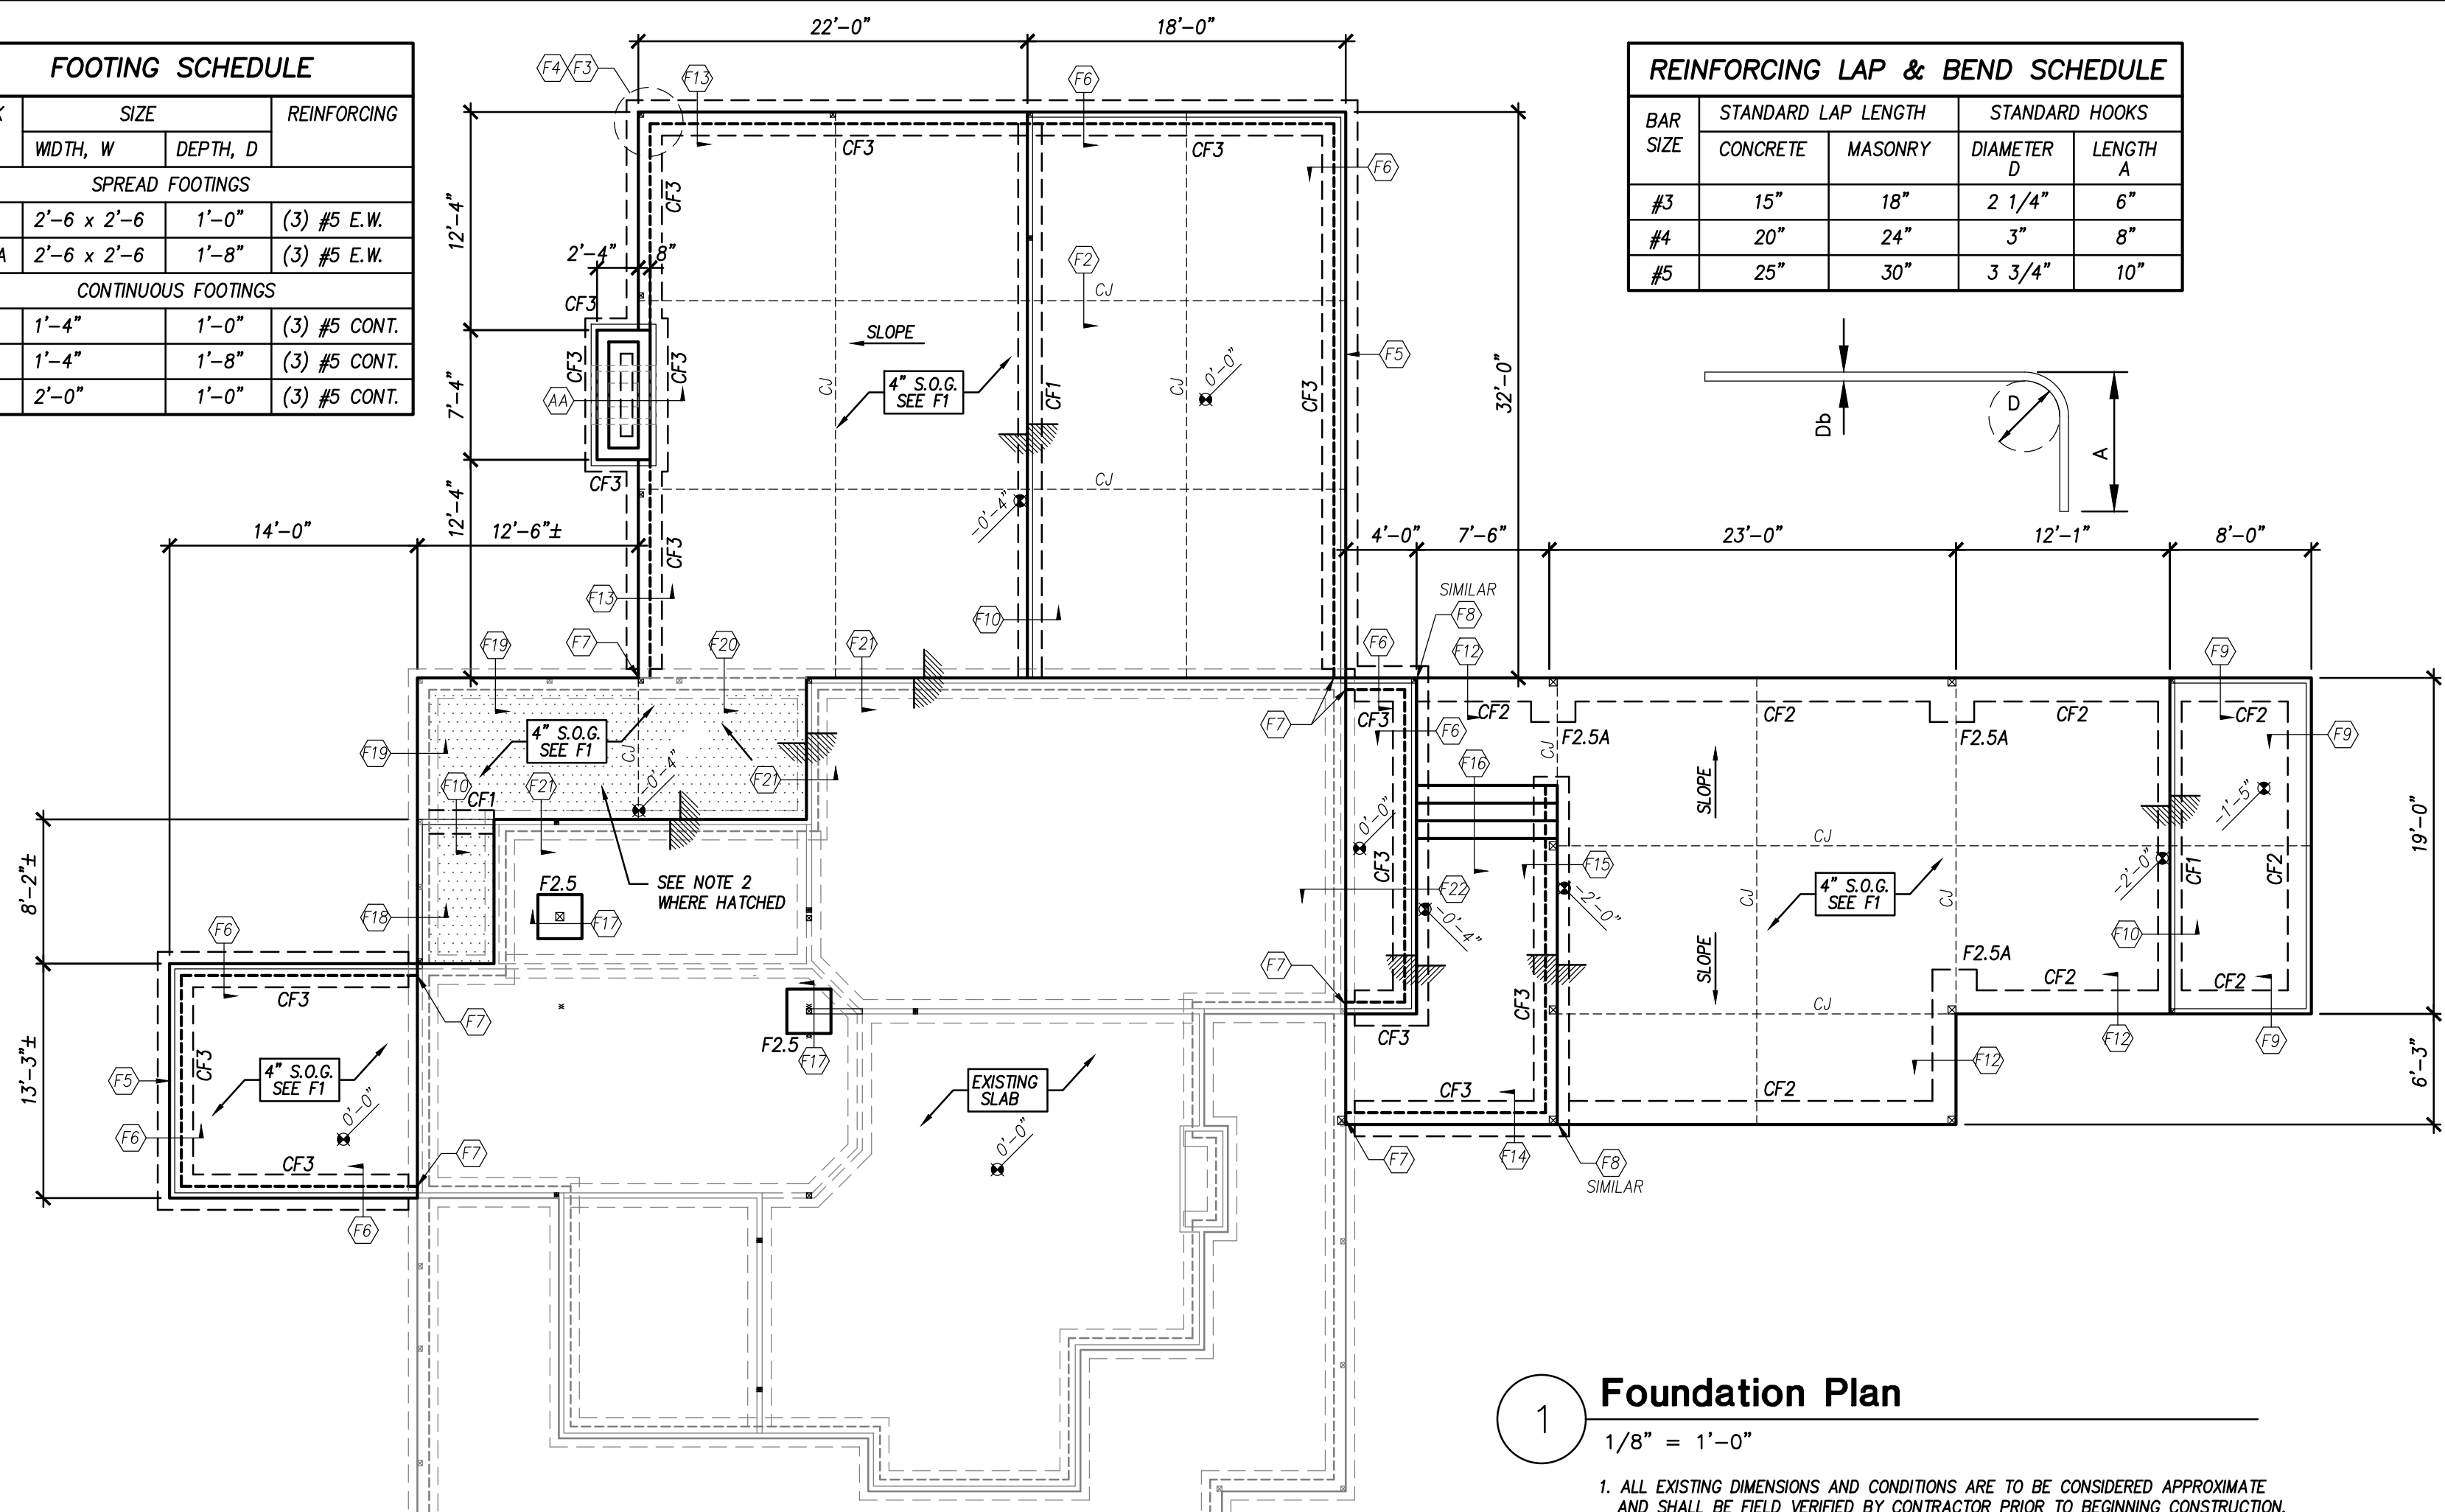


1 Foundation Plan
1/8" = 1'-0"
1. ALL EXISTING DIMENSIONS AND CONDITIONS ARE TO BE CONSIDERED APPROXIMATE AND SHALL BE FIELD VERIFIED BY CONTRACTOR PRIOR TO BEGINNING CONSTRUCTION.
2. REMOVE EXISTING WOOD FLOOR FRAMING ENTIRELY, REMOVE TOP OF MASONRY WALL AS REQUIRED, INSTALL COMPACTED STRUCTURAL FILL & NEW SLAB ON GRADE.
3. REFER TO DRAWING S101 FOR STRUCTURAL NOTES.

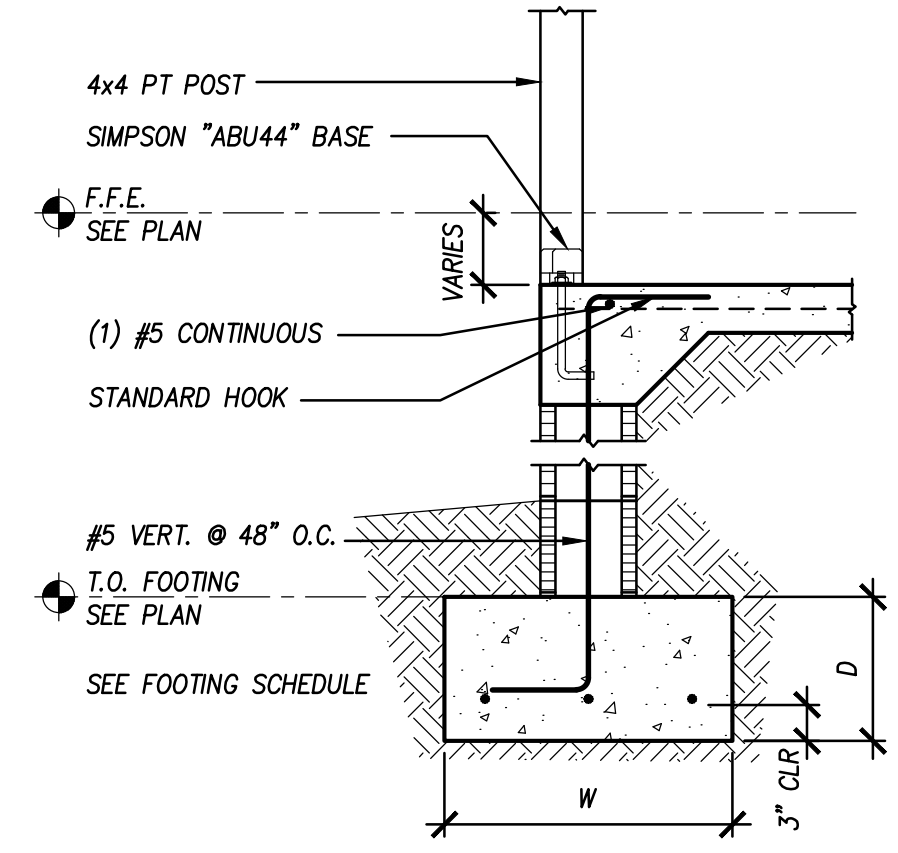


F13 Typical Foundation Section
3/4" = 1'-0" MAS-W504A

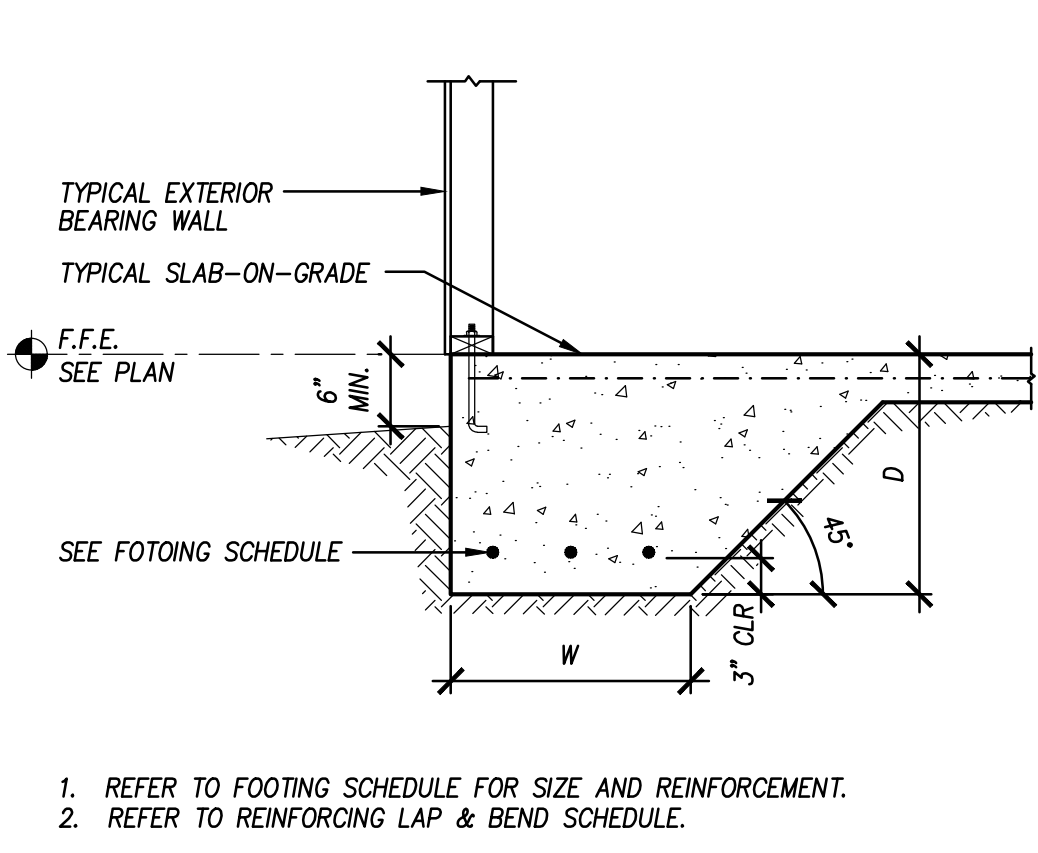


F9 Typical Wall Footing
3/4" = 1'-0" MONO1

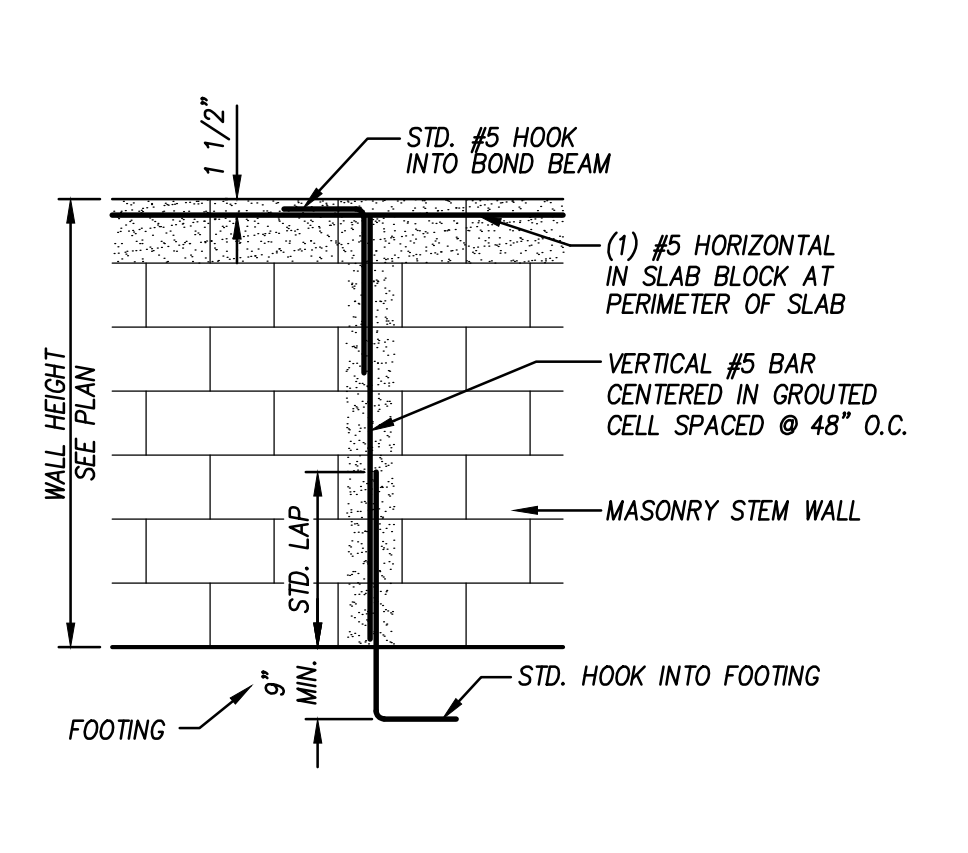


F5 Typical Stem Wall Reinforcing
1/2" = 1'-0" MAS-W001A

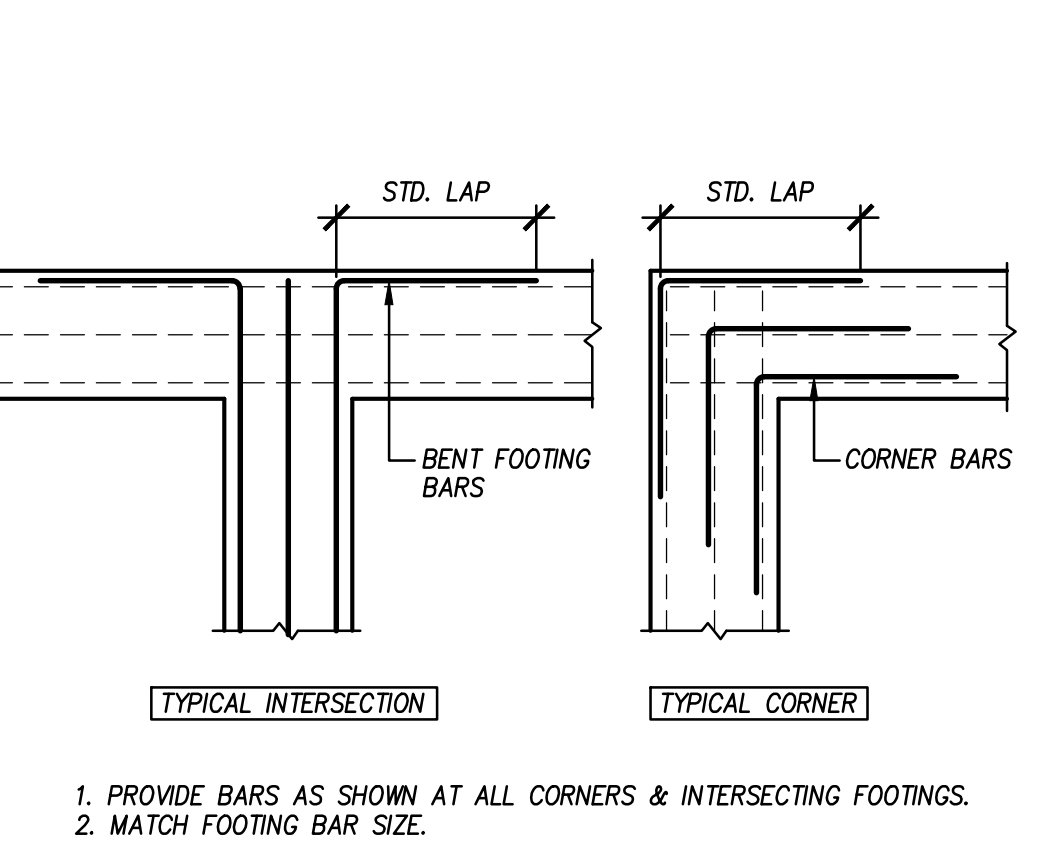


F3 Typical Intersecting Footings
1/2" = 1'-0" CONC 001

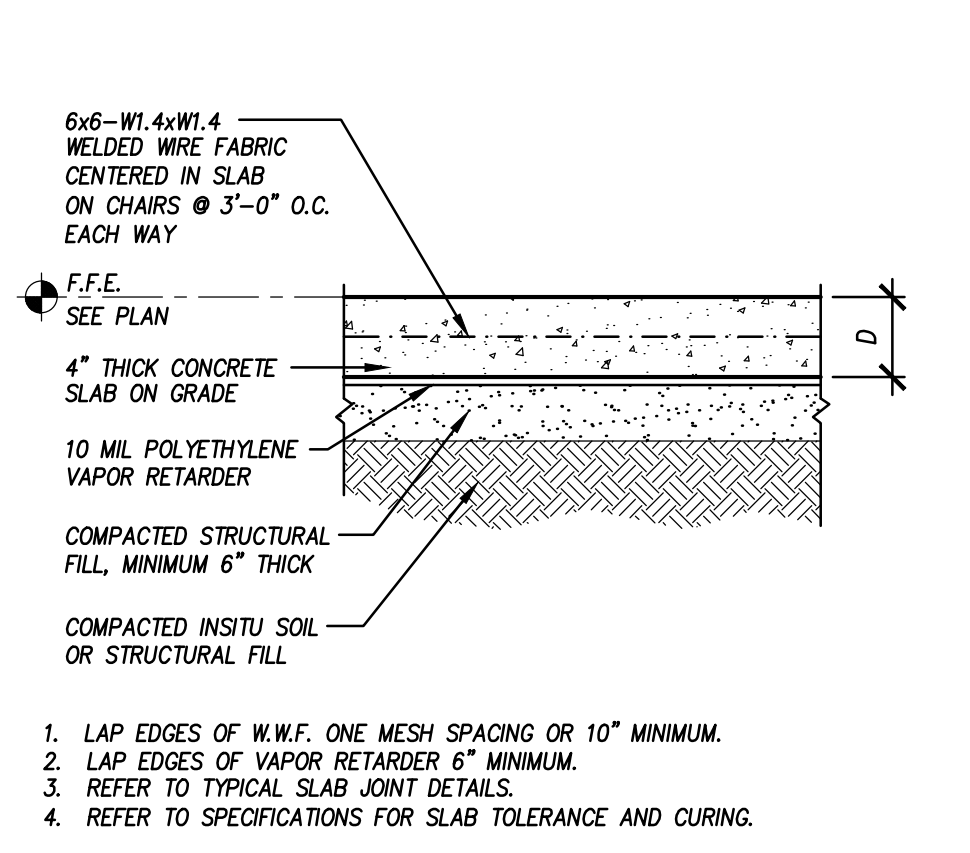


F1 Typical Slab on Grade
1" = 1'-0" SLAB 002

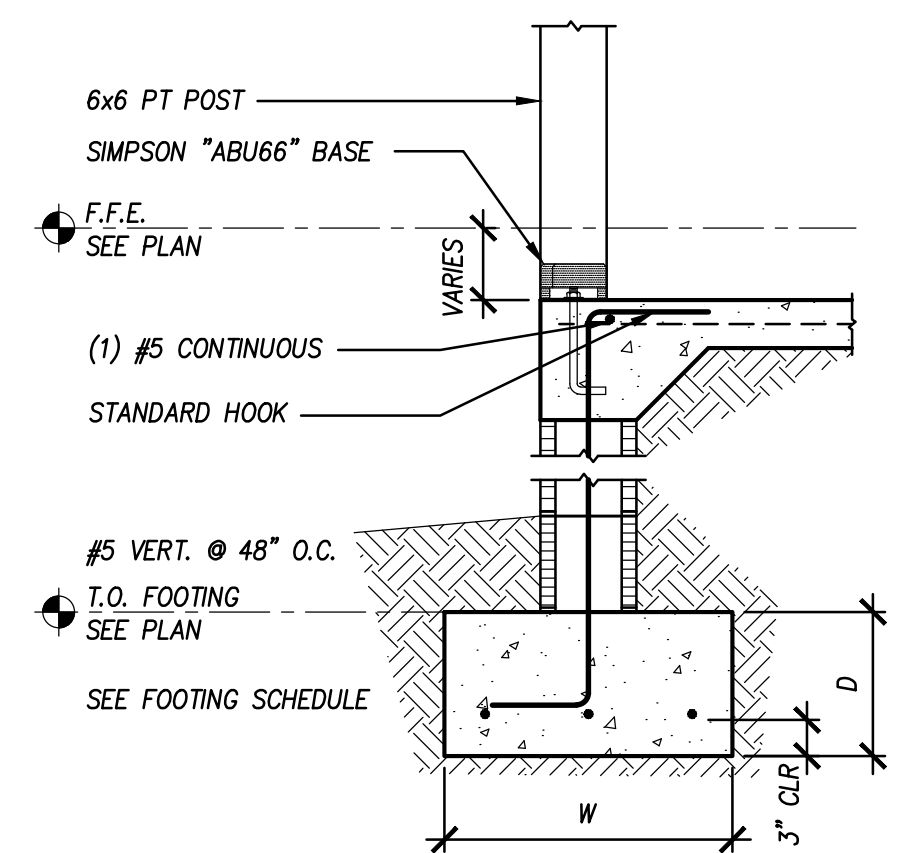


F14 Typical Foundation Section
3/4" = 1'-0" MAS-W504

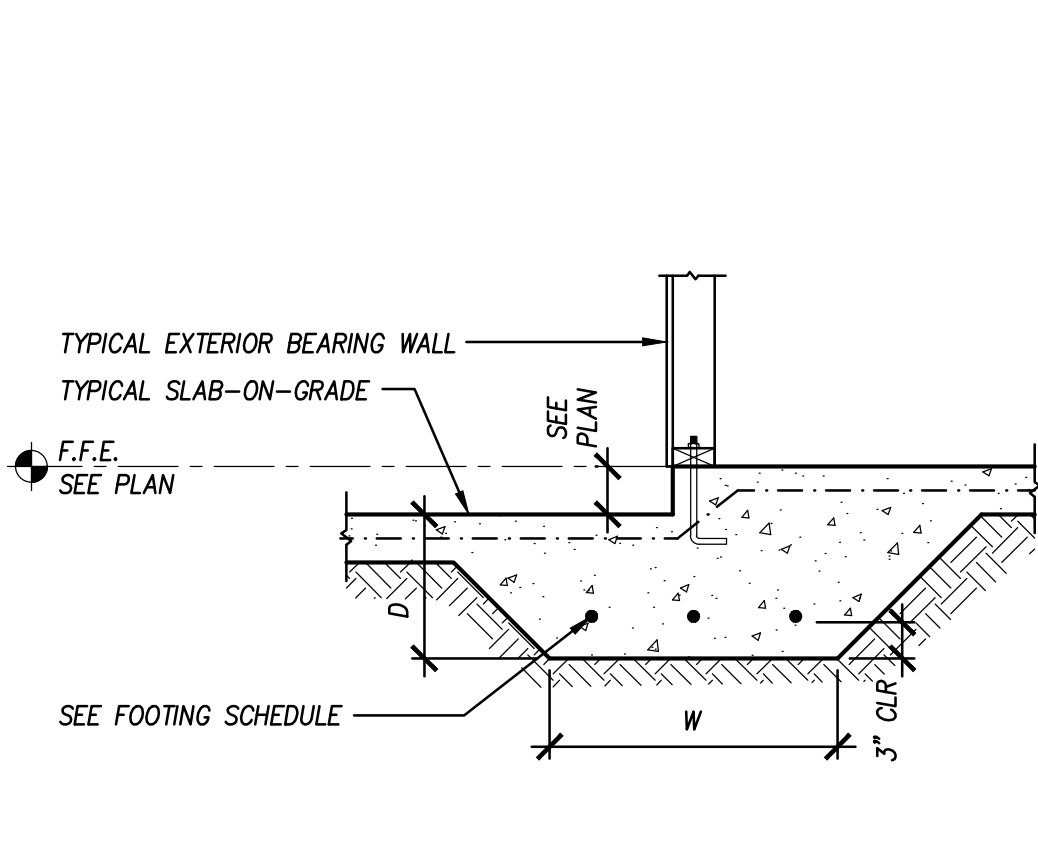


F10 Typical Footing Section
3/4" = 1'-0" MONO4

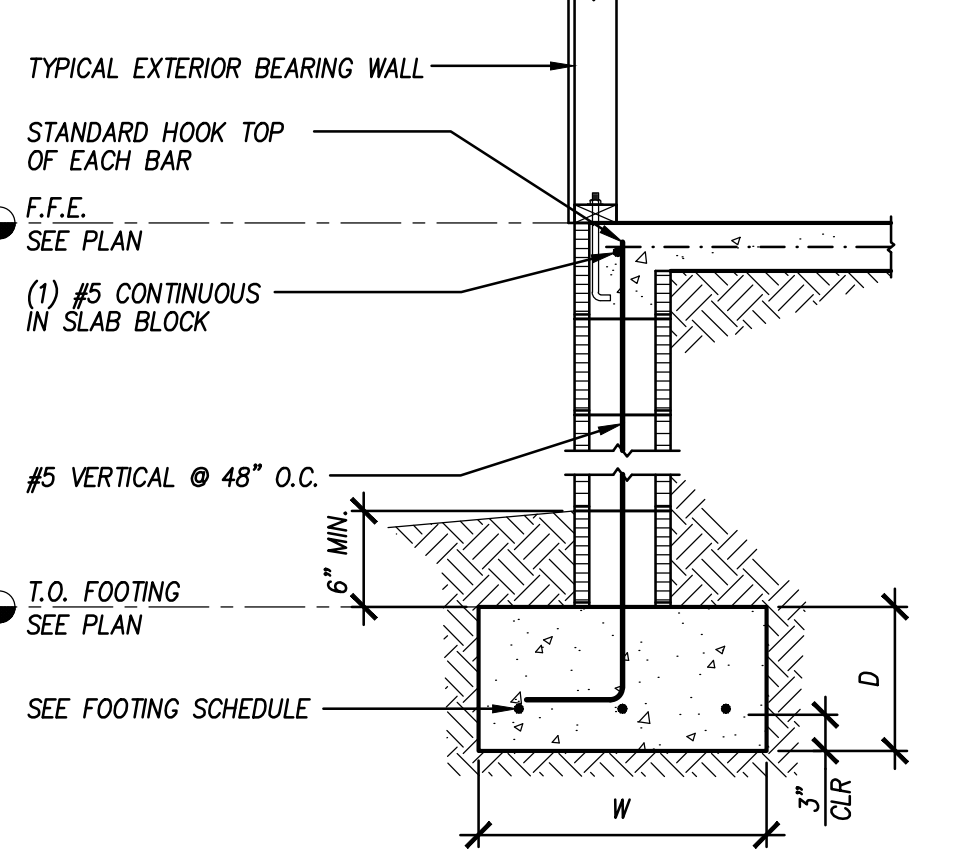

F6 Typical Foundation Section
3/4" = 1'-0" MAS-W400

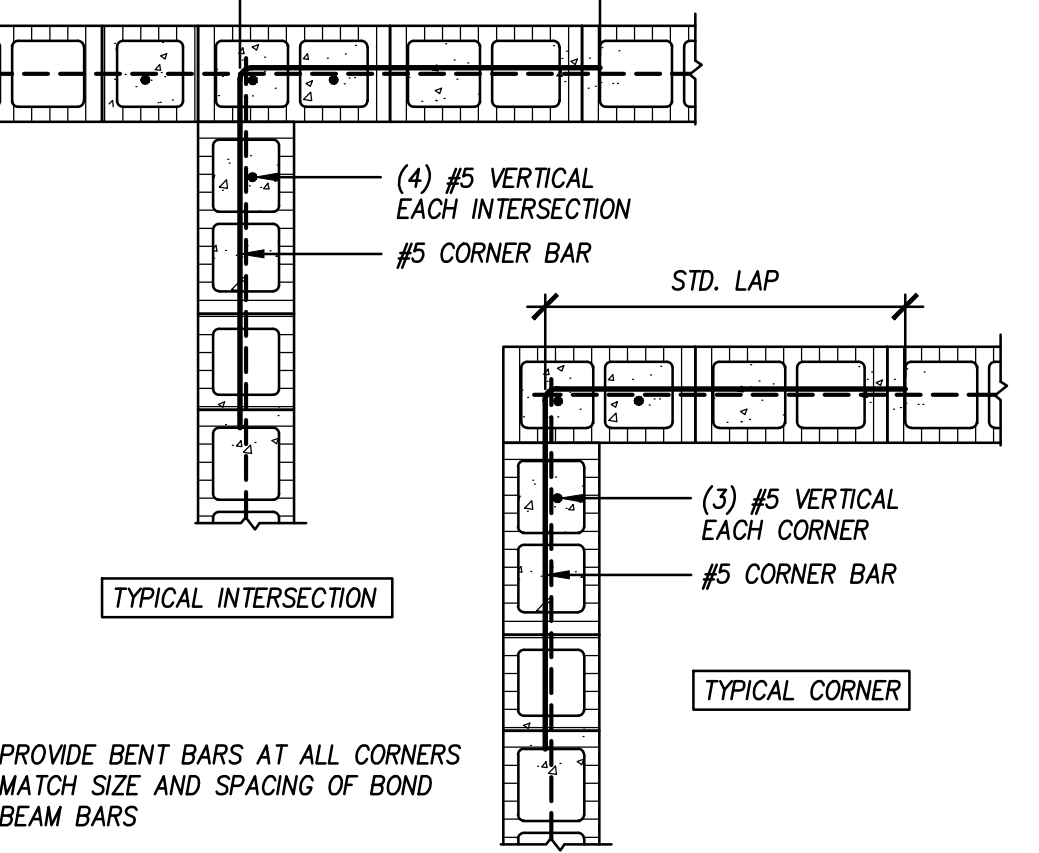


F4 Typical Intersecting CMU Walls
3/4" = 1'-0" MAS-100

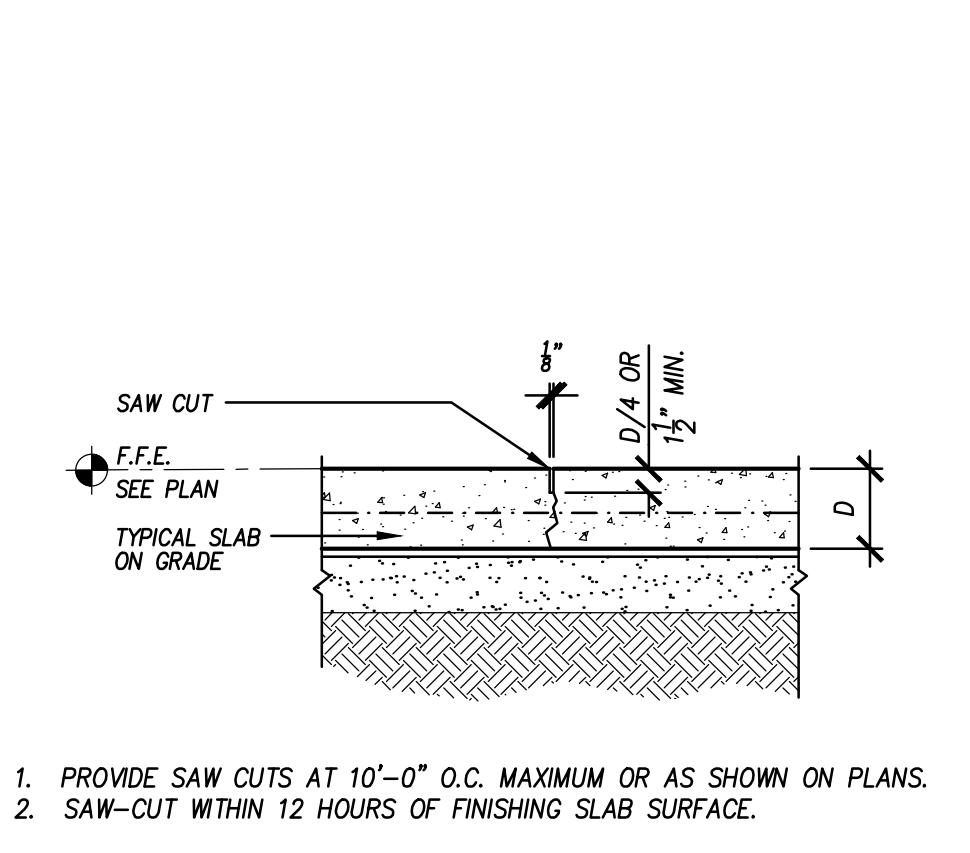

F2 Typical Saw-cut Contraction Joint
1" = 1'-0" JOINT 001

Drawing Status: **For Permit & Construction**
Rev. No.: | Date: | Description:

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Gregory S Wayland
2025.03.31
08:51:37-04'00"
This seal is signed and sealed using Digital Signature. Printed copies of this document are not considered signed and sealed and the authentication code must be verified on any electronic copies.

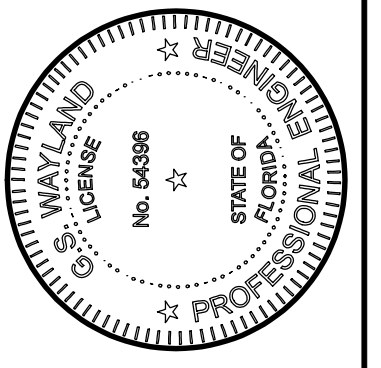Client: **Goodson Residence Addition & Renovations**
337 SW Tompkins Street Lake City, FL 32024
Project Name: **Foundation Plan & Details**
Drawn by: **GS WAYLAND**
Date: **MARCH 31, 2025**
WSE Project No.: **23010**
Drawing No. **S201**